
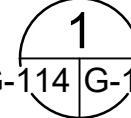





LEGEND:

-  DRAIN INLET PROTECTION  G-114 G-117
-  -45.0- EXISTING CONTOURS
-  EXISTING DITCH FLOW DIRECTION


NOTES:

1. PERFORM ALL EROSION CONTROL WORK IN ACCORDANCE WITH BEST MANAGEMENT PRACTICES OUTLINED IN G-117
2. EROSION CONTROL MEASURES, AS SHOWN, OR AS APPROVED BY THE RPR SHALL BE PLACED PRIOR TO THE COMMENCEMENT OF CONSTRUCTION BASED ON THE PHASES OF WORK SHOWN.
3. CONTRACTOR SHALL SUBMIT THEIR EROSION CONTROL PLANS FOR APPROVAL, SHOWING EACH PHASE OF WORK, AS OUTLINED ON THESE PLANS, PRIOR TO COMMENCING CONSTRUCTION ACTIVITIES.


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SCALE: 1" = 100'-0"

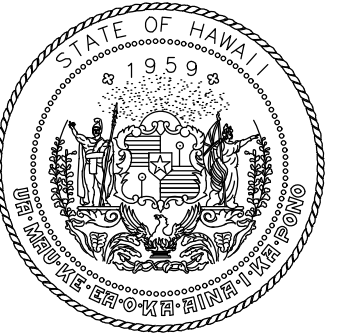

Airports Division
DEPARTMENT OF TRANSPORTATION
STATE OF HAWAII

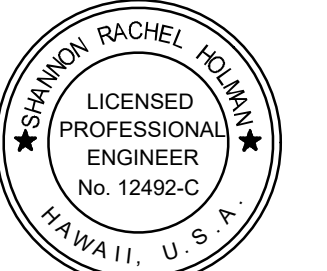


I HEREBY CERTIFY THAT THIS WORK WAS PREPARED BY ME OR UNDER MY SUPERVISION

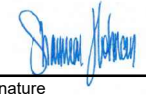Signature:  4/30/24
Expiration Date

DSGN.	DRWN.	CHKD.	APPD.
TR	NM	AC	SH

KEY PLAN / NOTES:

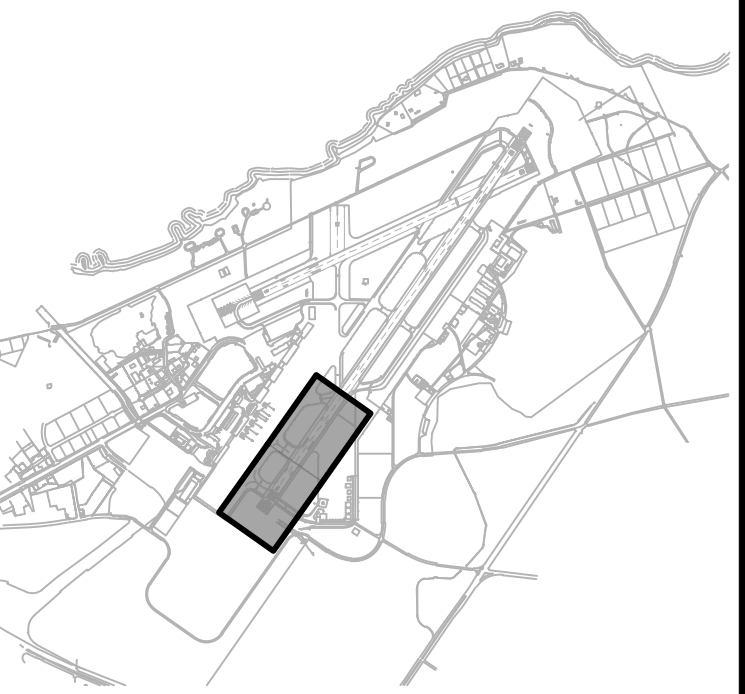

NO.	DATE	REVISIONS
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CONSTRUCTION DOCUMENTS

NOVEMBER 2022
DATE

PROJECT TITLE :

RESURFACE RUNWAY 2-20

AT
KAHULUI AIRPORT
KAHULUI, MAUI, HAWAII

PROJECT NO.:

AM1022-21R


SHEET TITLE:

EROSION CONTROL PLAN 1

DATE :	DWG. NO.
11/2022	G-114
SHEET :	
14 OF 46 SHEETS	




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MATCHLINE, SEE DWG NO G-114

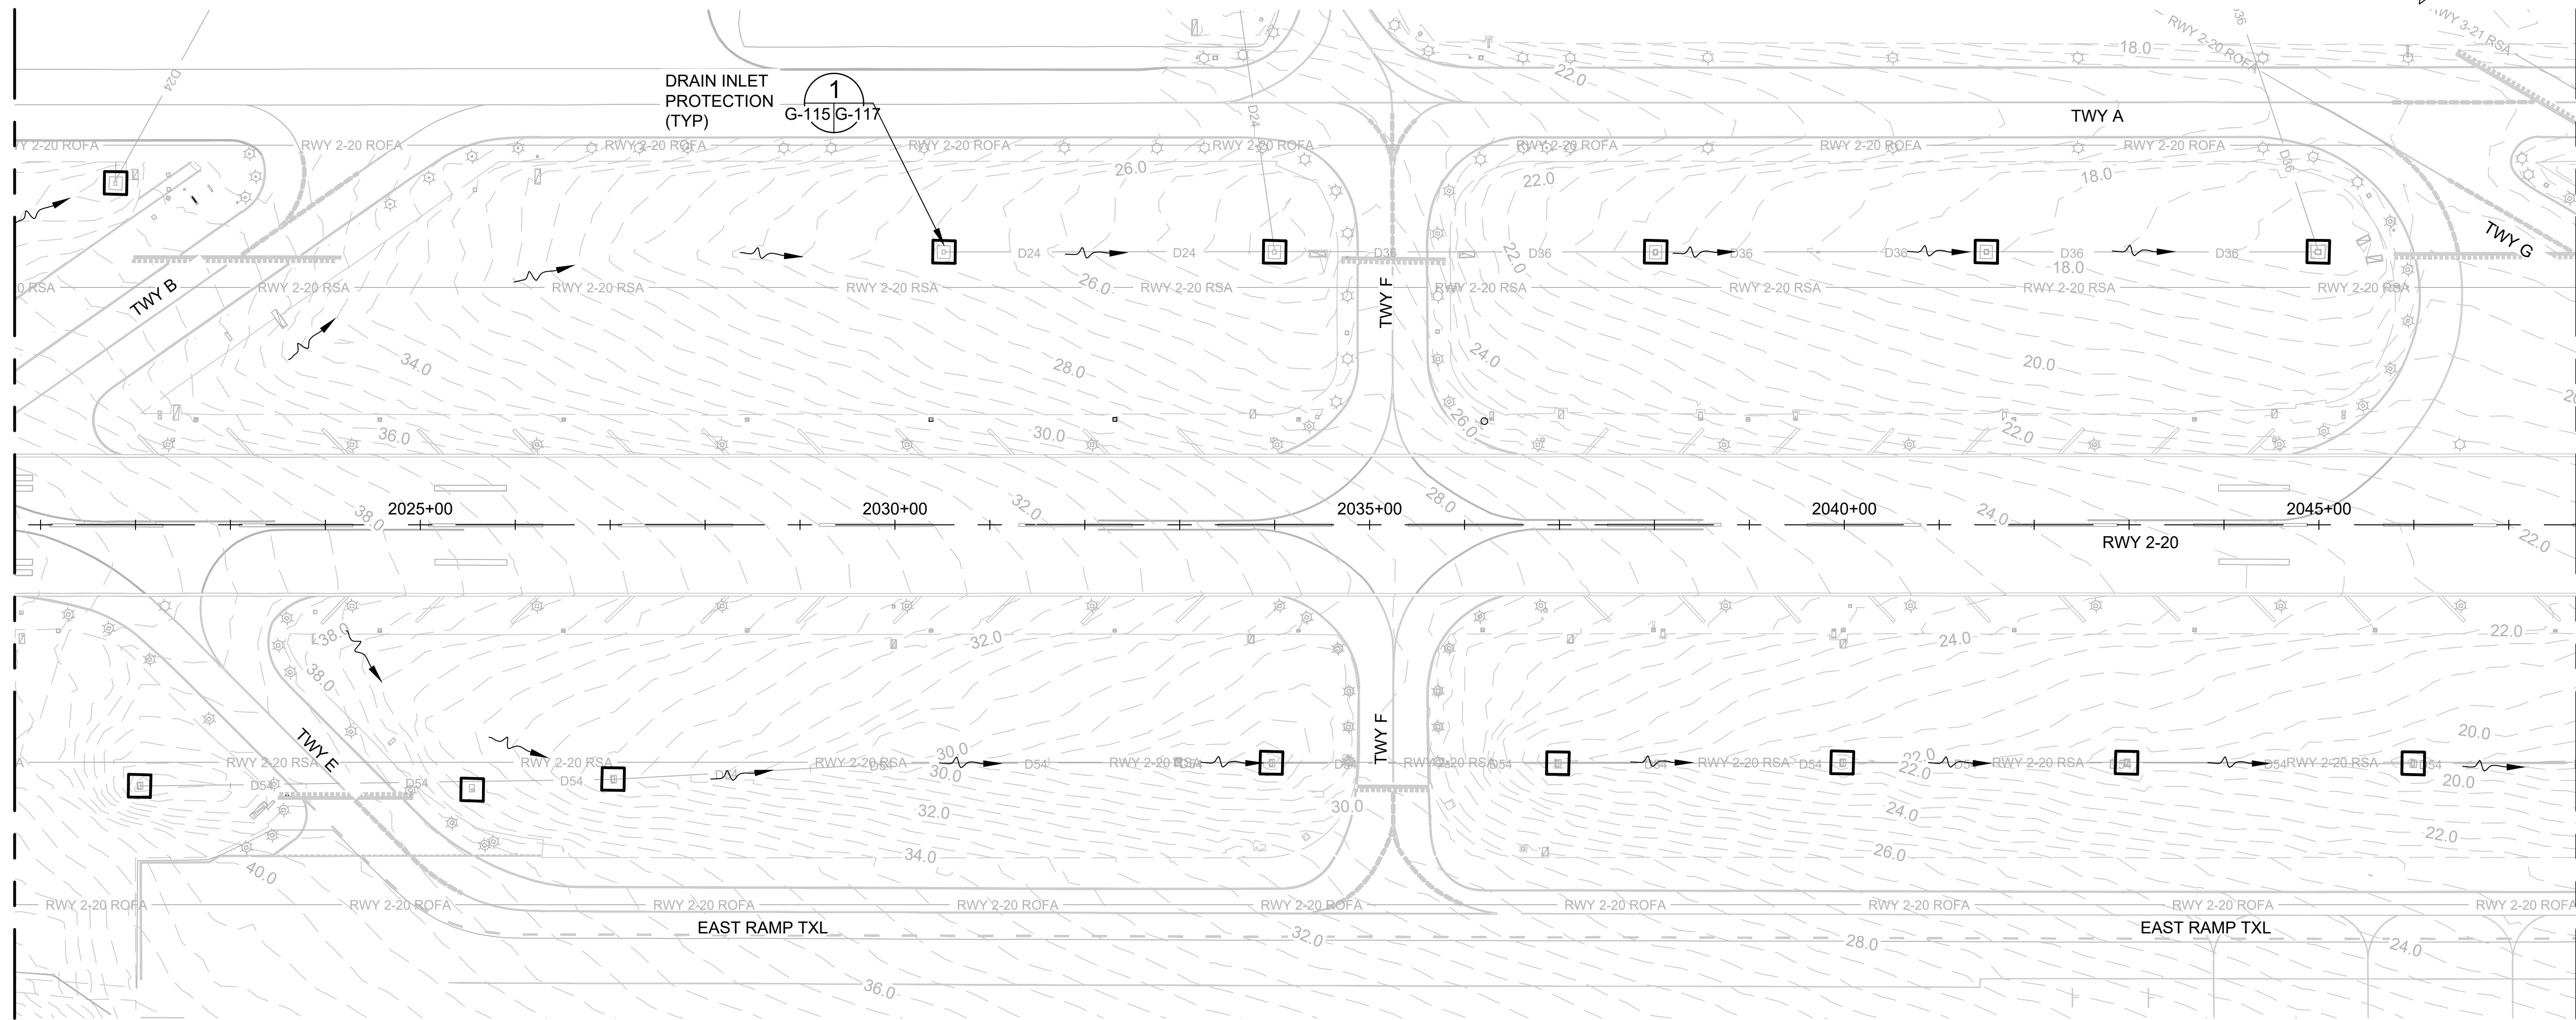

MATCHLINE, SEE DWG NO G-116

LEGEND:

-  DRAIN INLET PROTECTION (TYP) 1
G-115 G-117
-  -45.0- EXISTING CONTOURS
-  EXISTING DITCH FLOW DIRECTION

NOTES:

- PERFORM ALL EROSION CONTROL WORK IN ACCORDANCE WITH BEST MANAGEMENT PRACTICES OUTLINED IN G-117
- EROSION CONTROL MEASURES, AS SHOWN, OR AS APPROVED BY THE RPR SHALL BE PLACED PRIOR TO THE COMMENCEMENT OF CONSTRUCTION BASED ON THE PHASES OF WORK SHOWN.
- CONTRACTOR SHALL SUBMIT THEIR EROSION CONTROL PLANS FOR APPROVAL, SHOWING EACH PHASE OF WORK, AS OUTLINED ON THESE PLANS, PRIOR TO COMMENCING CONSTRUCTION ACTIVITIES.



Airports Division
DEPARTMENT OF TRANSPORTATION
STATE OF HAWAII




I HEREBY CERTIFY THAT THIS
WORK WAS PREPARED BY ME
OR UNDER MY SUPERVISION

Signature:  4/30/24
Expiration Date

DSGN.	DRWN.	CHKD.	APPD.
TR	NM	AC	SH

KEY PLAN / NOTES:

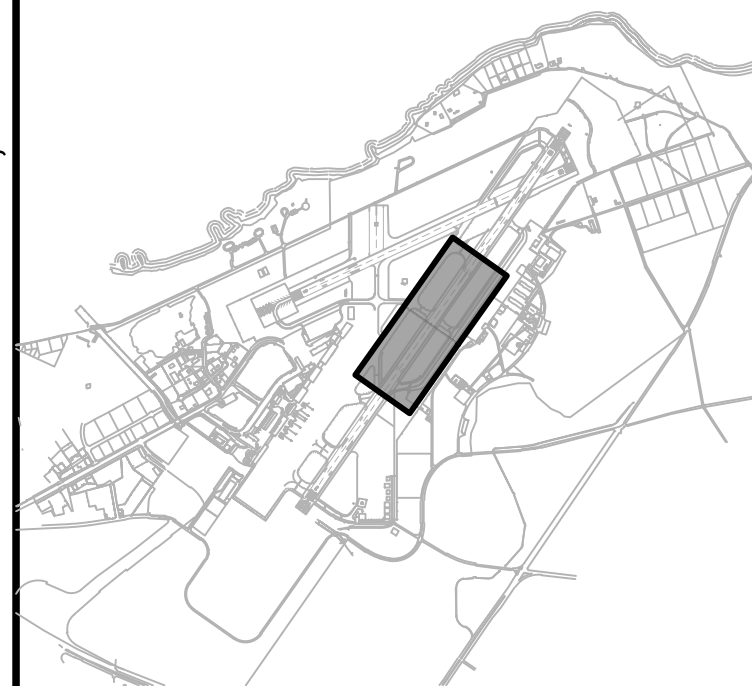

NO.	DATE	REVISIONS
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CONSTRUCTION
DOCUMENTS

NOVEMBER 2022
DATE

PROJECT TITLE :

RESURFACE RUNWAY 2-20

AT
KAHULUI AIRPORT
KAHULUI, MAUI, HAWAII

PROJECT NO.:


AM1022-21R

SHEET TITLE:


EROSION CONTROL
PLAN 2

DATE :	DWG. NO. G-115
11/2022	
SHEET :	
15 OF 46 SHEETS	

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KEY PLAN / NOTES:

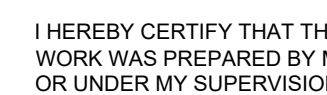

CONSTRUCTION DOCUMENTS

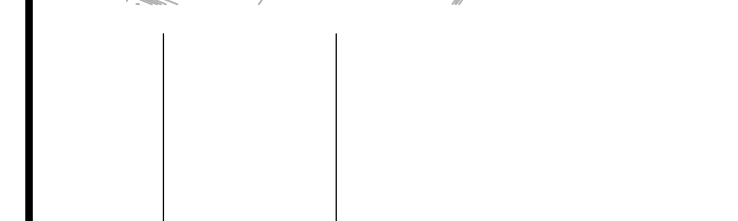NOVEMBER 2022

DATE

PROJECT TITLE :

RESURFACE RUNWAY 2-20

AT
KAHULUI AIRPORT
KAHULUI, MAUI, HAWAII

PROJECT NO.:	
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AM1022-21R


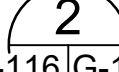

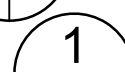

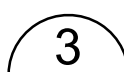



SHEET TITLE:

EROSION CONTROL PLAN 3

DATE :	DWG. NO.
11/2022	G-116
SHEET :	
16 OF 46 SHEETS	



LEGEND:

	COMPOST FILTER SOCK	
	DRAIN INLET PROTECTION	
	STABILIZED CONSTRUCTION ENTRANCE	
	EXISTING CONTOURS	
	EXISTING ACCESS GATE	
	EXISTING DITCH FLOW DIRECTION	

NOTES:

1. PERFORM ALL EROSION CONTROL WORK IN ACCORDANCE WITH BEST MANAGEMENT PRACTICES OUTLINED IN G-117
2. EROSION CONTROL MEASURES, AS SHOWN, OR AS APPROVED BY THE RPR SHALL BE PLACED PRIOR TO THE COMMENCEMENT OF CONSTRUCTION BASED ON THE PHASES OF WORK SHOWN.
3. CONTRACTOR SHALL SUBMIT THEIR EROSION CONTROL PLANS FOR APPROVAL, SHOWING EACH PHASE OF WORK, AS OUTLINED ON THESE PLANS, PRIOR TO COMMENCING CONSTRUCTION ACTIVITIES.
4. STABILIZED CONSTRUCTION ENTRANCES ARE SHOWN IN GENERAL LOCATIONS. UPON APPROVAL FROM RPR, CONTRACTOR TO ADJUST/RELOCATE AS REQUIRED BASED ON THEIR SEQUENCE OF WORK SUCH THAT THERE IS ALWAYS A STABILIZED ENTRANCE BETWEEN PAVED AND UNPAVED AREAS.

