



NEW WORK KEY NOTES:

- 5 REMOVE EXISTING EXHAUST FAN EF-5 INCLUDING BACK DRAFT DAMPER, 20"x20" REGISTER AND ROOF CURB.
- 6 REMOVE EXISTING EXHAUST FAN EF-6 INCLUDING BACK DRAFT DAMPER, 18"x18" REGISTER AND ROOF CURB.
- REMOVE PORTION OF EXISTING ROOF RIDGE PANEL AS REQUIRED FOR INSTALLATION ON NEW CONTINUOUS RIDGE VENTS.

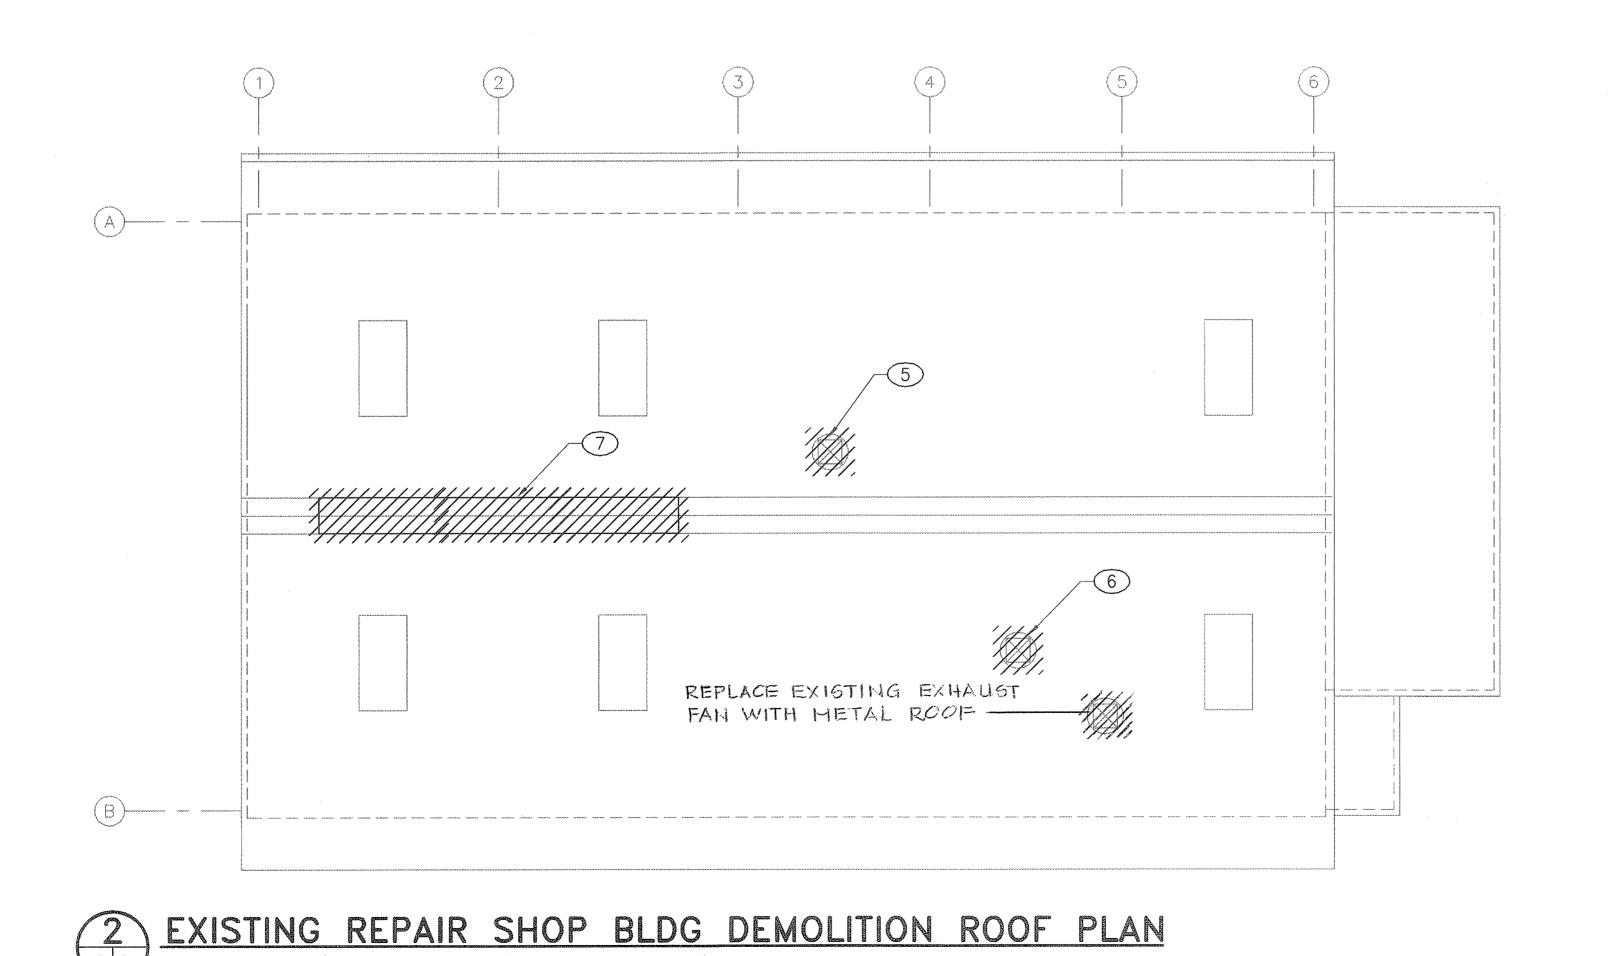

1/8"=1'-0"

1/8"=1'-0"

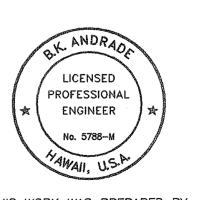


THIS WORK WAS PREPARED BY ME OR UNDER MY SUPERVISION. B. K. andrade 5/5/05

STATE OF HAWAII DEPARTMENT OF TRANSPORTATION HIGHWAYS DIVISION

EXISTING REPAIR SHOP BLDG MECHANICAL DEMOLITON PLANS MAUI DISTRICT BASEYARD REPAIR AND MAINTENANCE OF BUILDINGS AND GROUNDS, PHASE 3 PROJECT NO. HWY-M-08-04M

SCALE: AS SHOWN

DATE: MAY 2005 SHEET No. M-4 OF 5 SHEETS

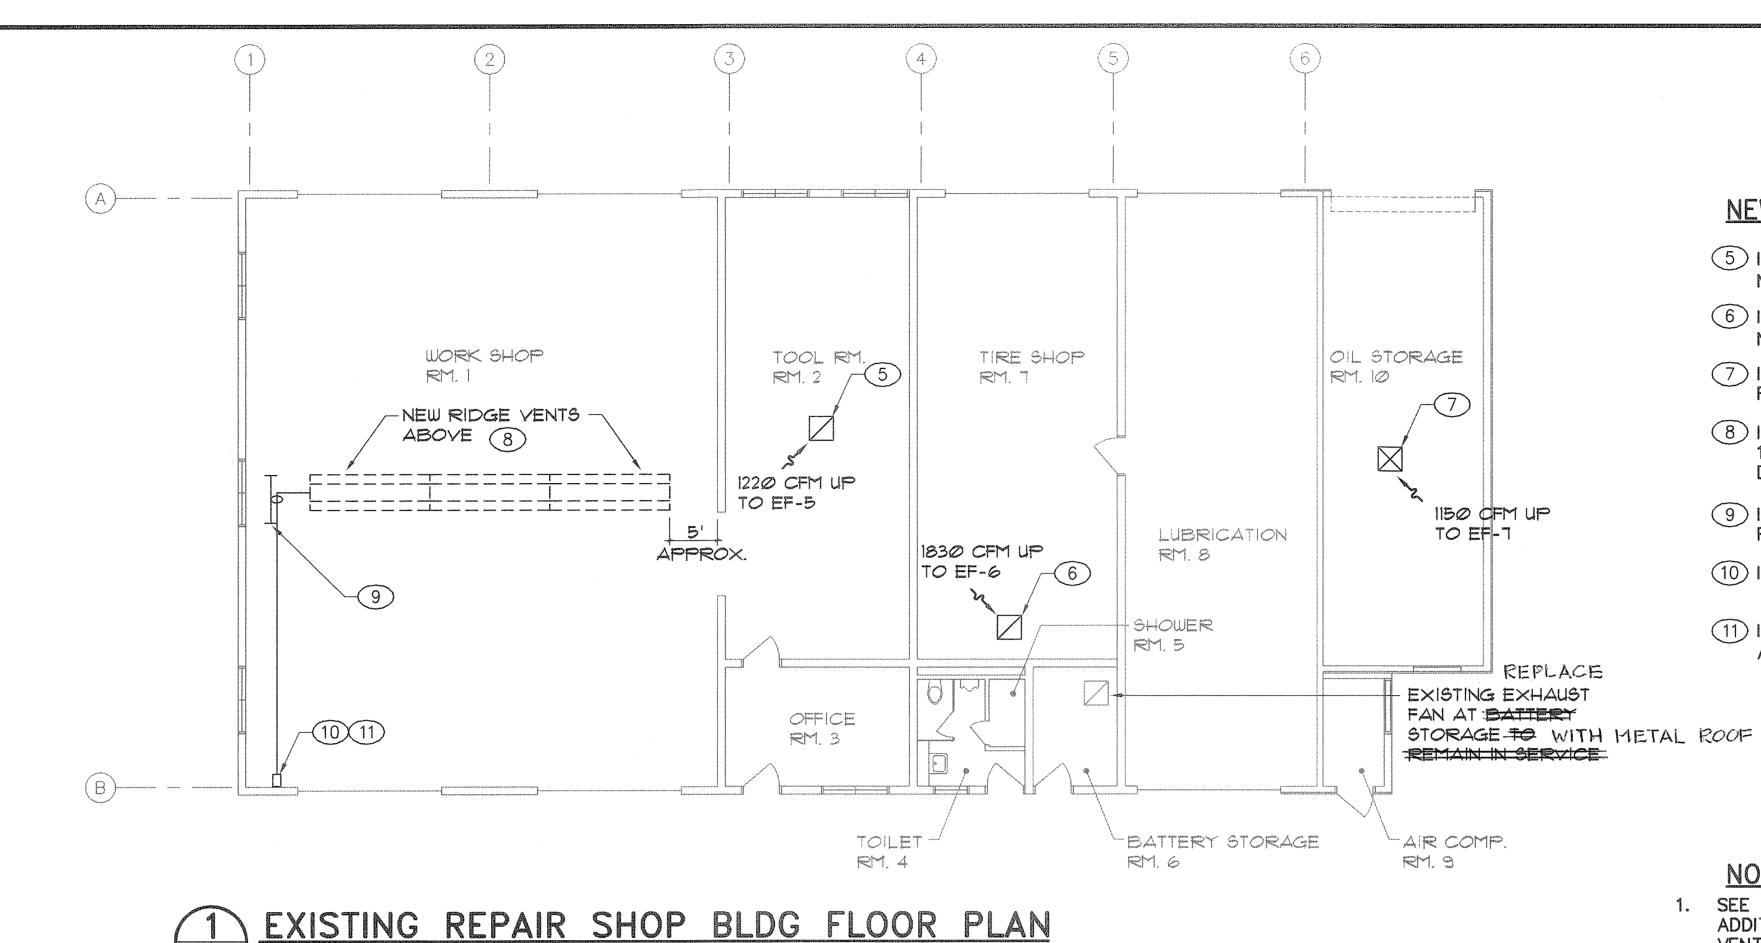

1/8"=1'-0"


1/8"=1'-0"


NEW WORK KEY NOTES:

- 5 INSTALL NEW EXHAUST FAN EF-5 IN EXISTING LOCATION. PROVIDE NEW 20"x20" REGISTER, BACKDRAFT DAMPER AND ROOF CURB.
- 6 INSTALL NEW EXHAUST FAN EF-6 IN EXISTING LOCATION. PROVIDE NEW 18"x18" REGISTER, BACKDRAFT DAMPER AND ROOF CURB.
- 7 INSTALL NEW EXHAUST FAN EF-7. PROVIDE NEW 12"x12" REGISTER, BACKDRAFT DAMPER AND ROOF CURB.
- (8) INSTALL NEW CONTINUOUS RIDGE VENT CONSISTING OF THREE (3) 10-FOOT LONG SECTIONS. EXACT LOCATION TO SUIT INSTALLATION DETAILS PROVIDED BY VENTILATOR MFR.
- 9 INSTALL NEW 3"x3"x1" ANGLE BETWEEN EXISTING ROOF PURLINS. INSTALL PULLEY FOR DAMPER OPERATING CHAIN.
- (10) INSTALL PULLEY FOR DAMPER OPERATING CHAIN AT CEILING LEVEL.
- (11) INSTALL CABLE OR CHAIN KEEPER FOR DAMPER CHAIN. MOUNT KEEPER AT 3'6" ABOVE FINISH FLOOR.

NOTES:

1. SEE EQUIPMENT SCHEDULE SHEET ON M-1 AND IN SPECIFICATIONS FOR ADDITIONAL INFORMATION ON NEW EXHAUST FANS AND CONTINUOUS RIDGE VENTILATORS.

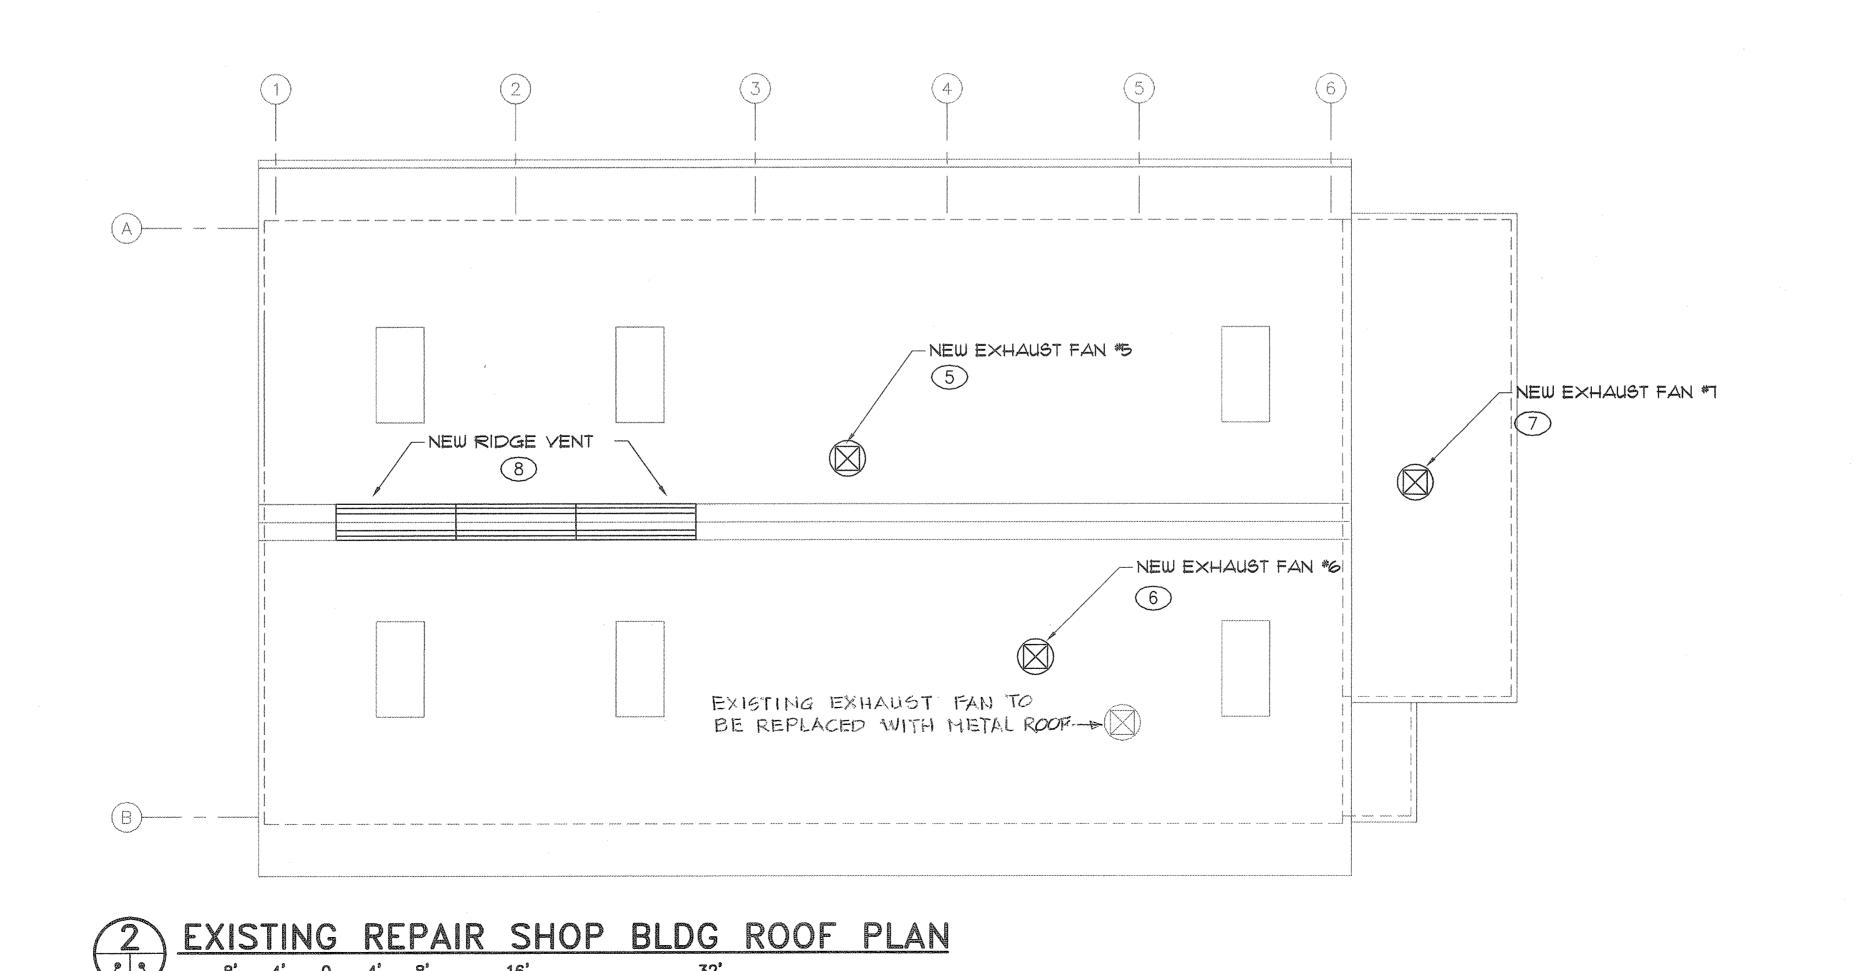

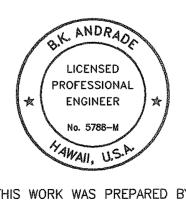

THIS WORK WAS PREPARED BY ME OR UNDER MY SUPERVISION. B.K. andrade 5/5/05

STATE OF HAWAII DEPARTMENT OF TRANSPORTATION HIGHWAYS DIVISION

EXISTING REPAIR SHOP BLDG MECHANICAL FLOOR & ROOF PLAN MAUI DISTRICT BASEYARD REPAIR AND MAINTENANCE OF BUILDINGS AND GROUNDS, PHASE 3 PROJECT NO. HWY-M-08-04M

SCALE: AS SHOWN

DATE: MAY 2005 SHEET No. M-5 OF 5 SHEETS