









FED. ROAD DIST. NO.	STATE	PROJ. NO.	FISCAL YEAR	SHEET NO.	TOTAL SHEETS
HAWAII	HAW.	HWY-M-03-99M	2001	14	15

ELECTRICAL SYMBOLS


-  Light Fixture
-  Junction Box, Large
-  Existing Junction Box
-  Existing Duplex Receptacle
-  Existing Motor
-  Existing Motor Controller
-  Existing Panel
-  Explosion Proof
-  Wiring In Raceway, Concealed
-  Existing Wiring To Remain

ELECTRICAL NOTES


- Contractor To Verify All Existing Conditions And Dimensions In The Field Prior To Commencement Of New Work.
- Contractor To Verify All Existing Conditions And Dimensions In The Field Prior To Commencement Of New Work.
- Provide A Separate Insulated Green Ground Conductor Sized In Accordance With NEC Table 250-95, In All Feeder And Branch Circuit Raceways.
- Verify Ratings Of All Electrically Operated Or Controlled Equipment Provided By The Owner And/Or By Other Trades. Coordinate Ratings Of Overcurrent Equipment, Devices, Conduit Disconnect Switches, And Wiring To Match The Actual Equipment Supplied, At No Additional Cost To The State.
- Provide sealing of conduits as required by N.E.C. 514.

FIXTURE SCHEDULE

TYPE	LAMP	DESCRIPTION
A	175 W MH	CEILING MOUNTED FIXTURE, CLASS I, DIVISION 2, SUITABLE FOR EXTERIOR USE AND WET LOCATIONS, LOW BAY REFRACTOR, HPF BALLAST.

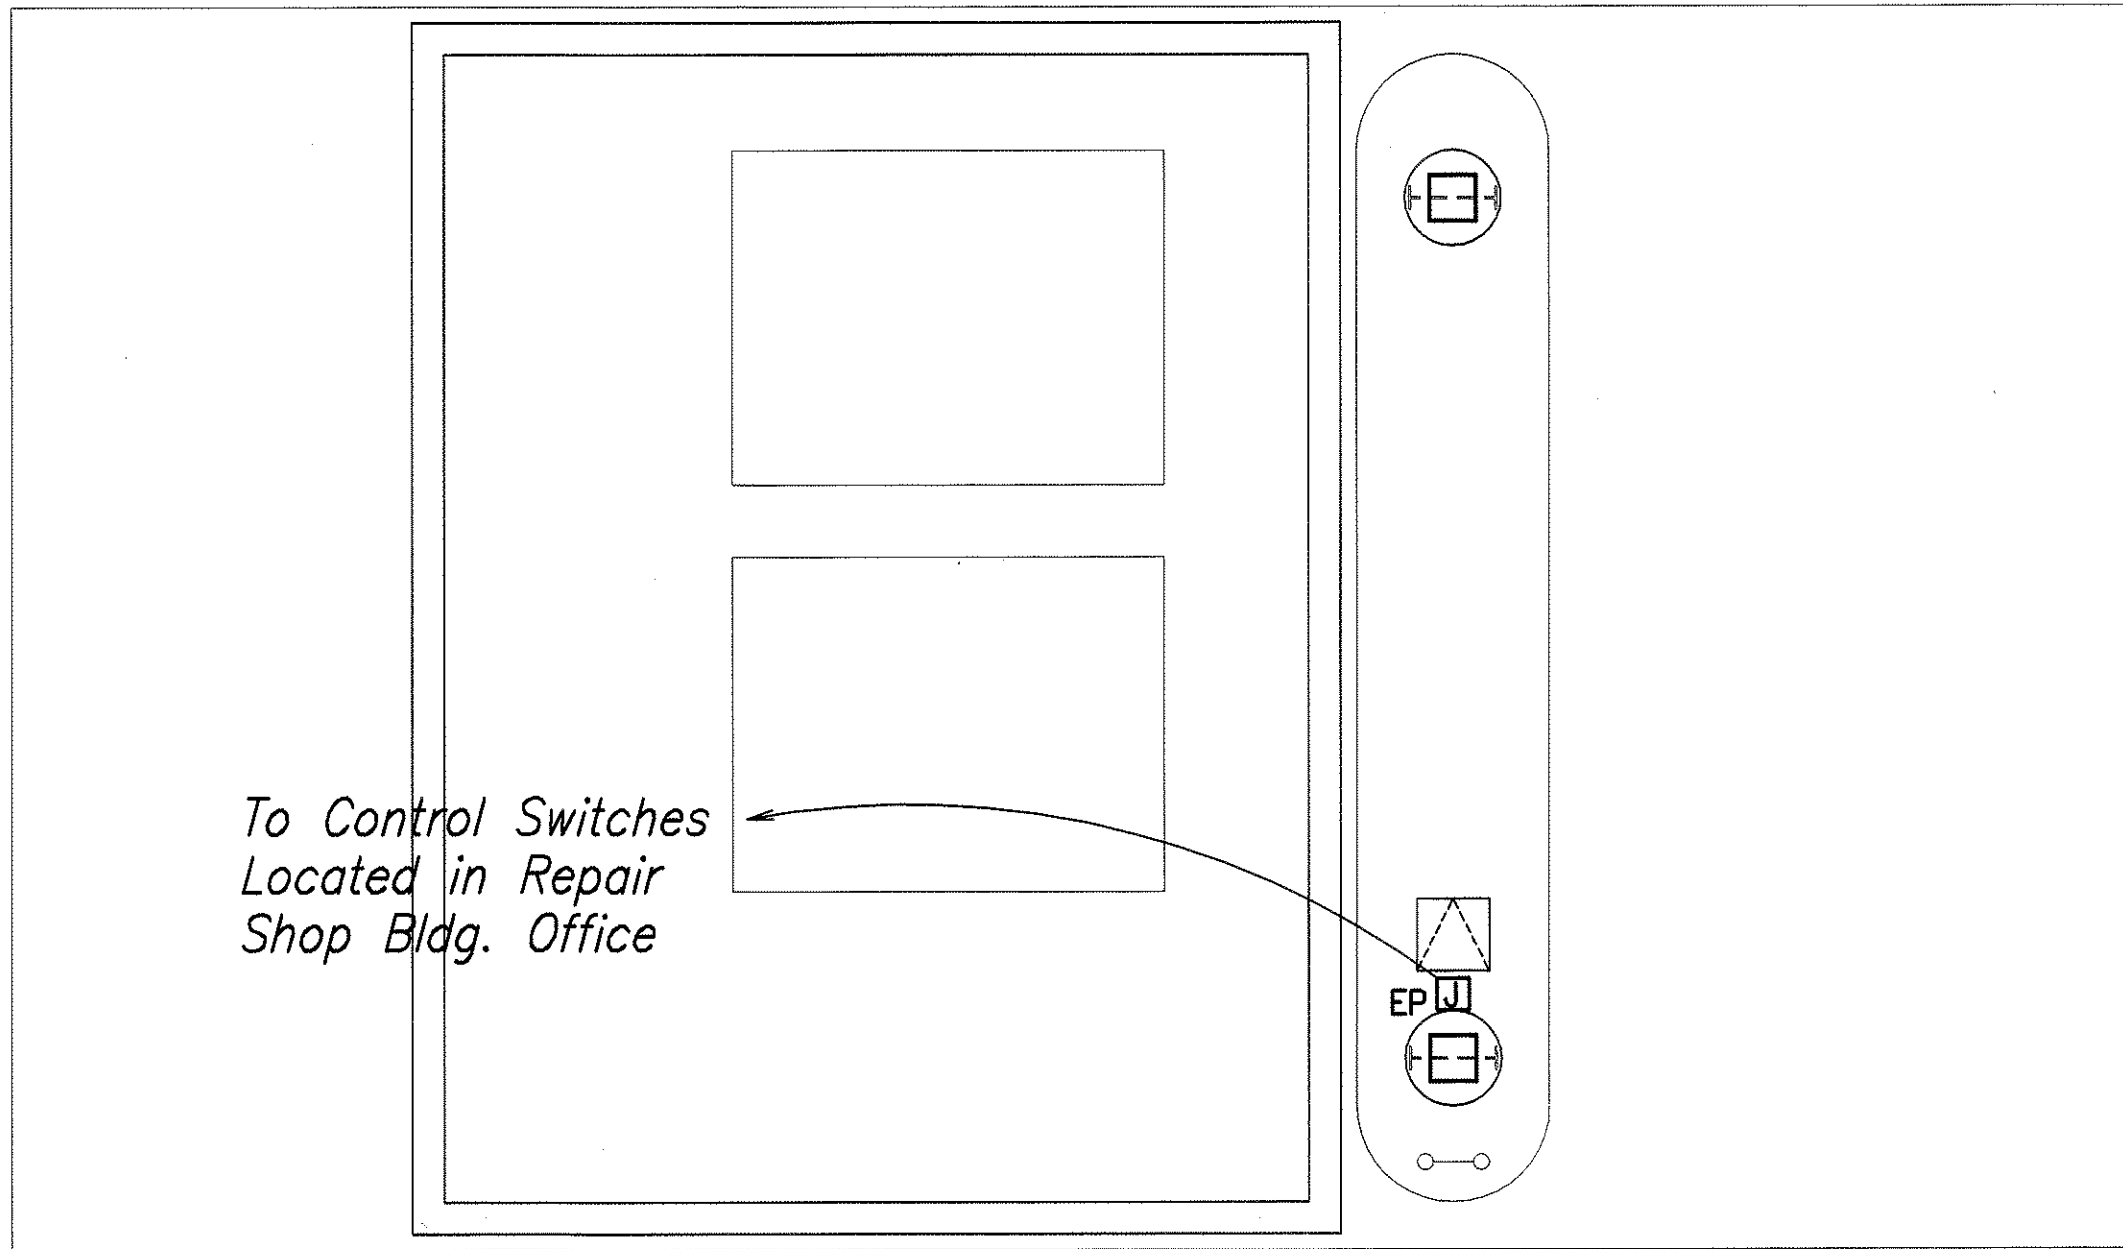


POWER PLAN
SCALE: 1/4" = 1'-0"

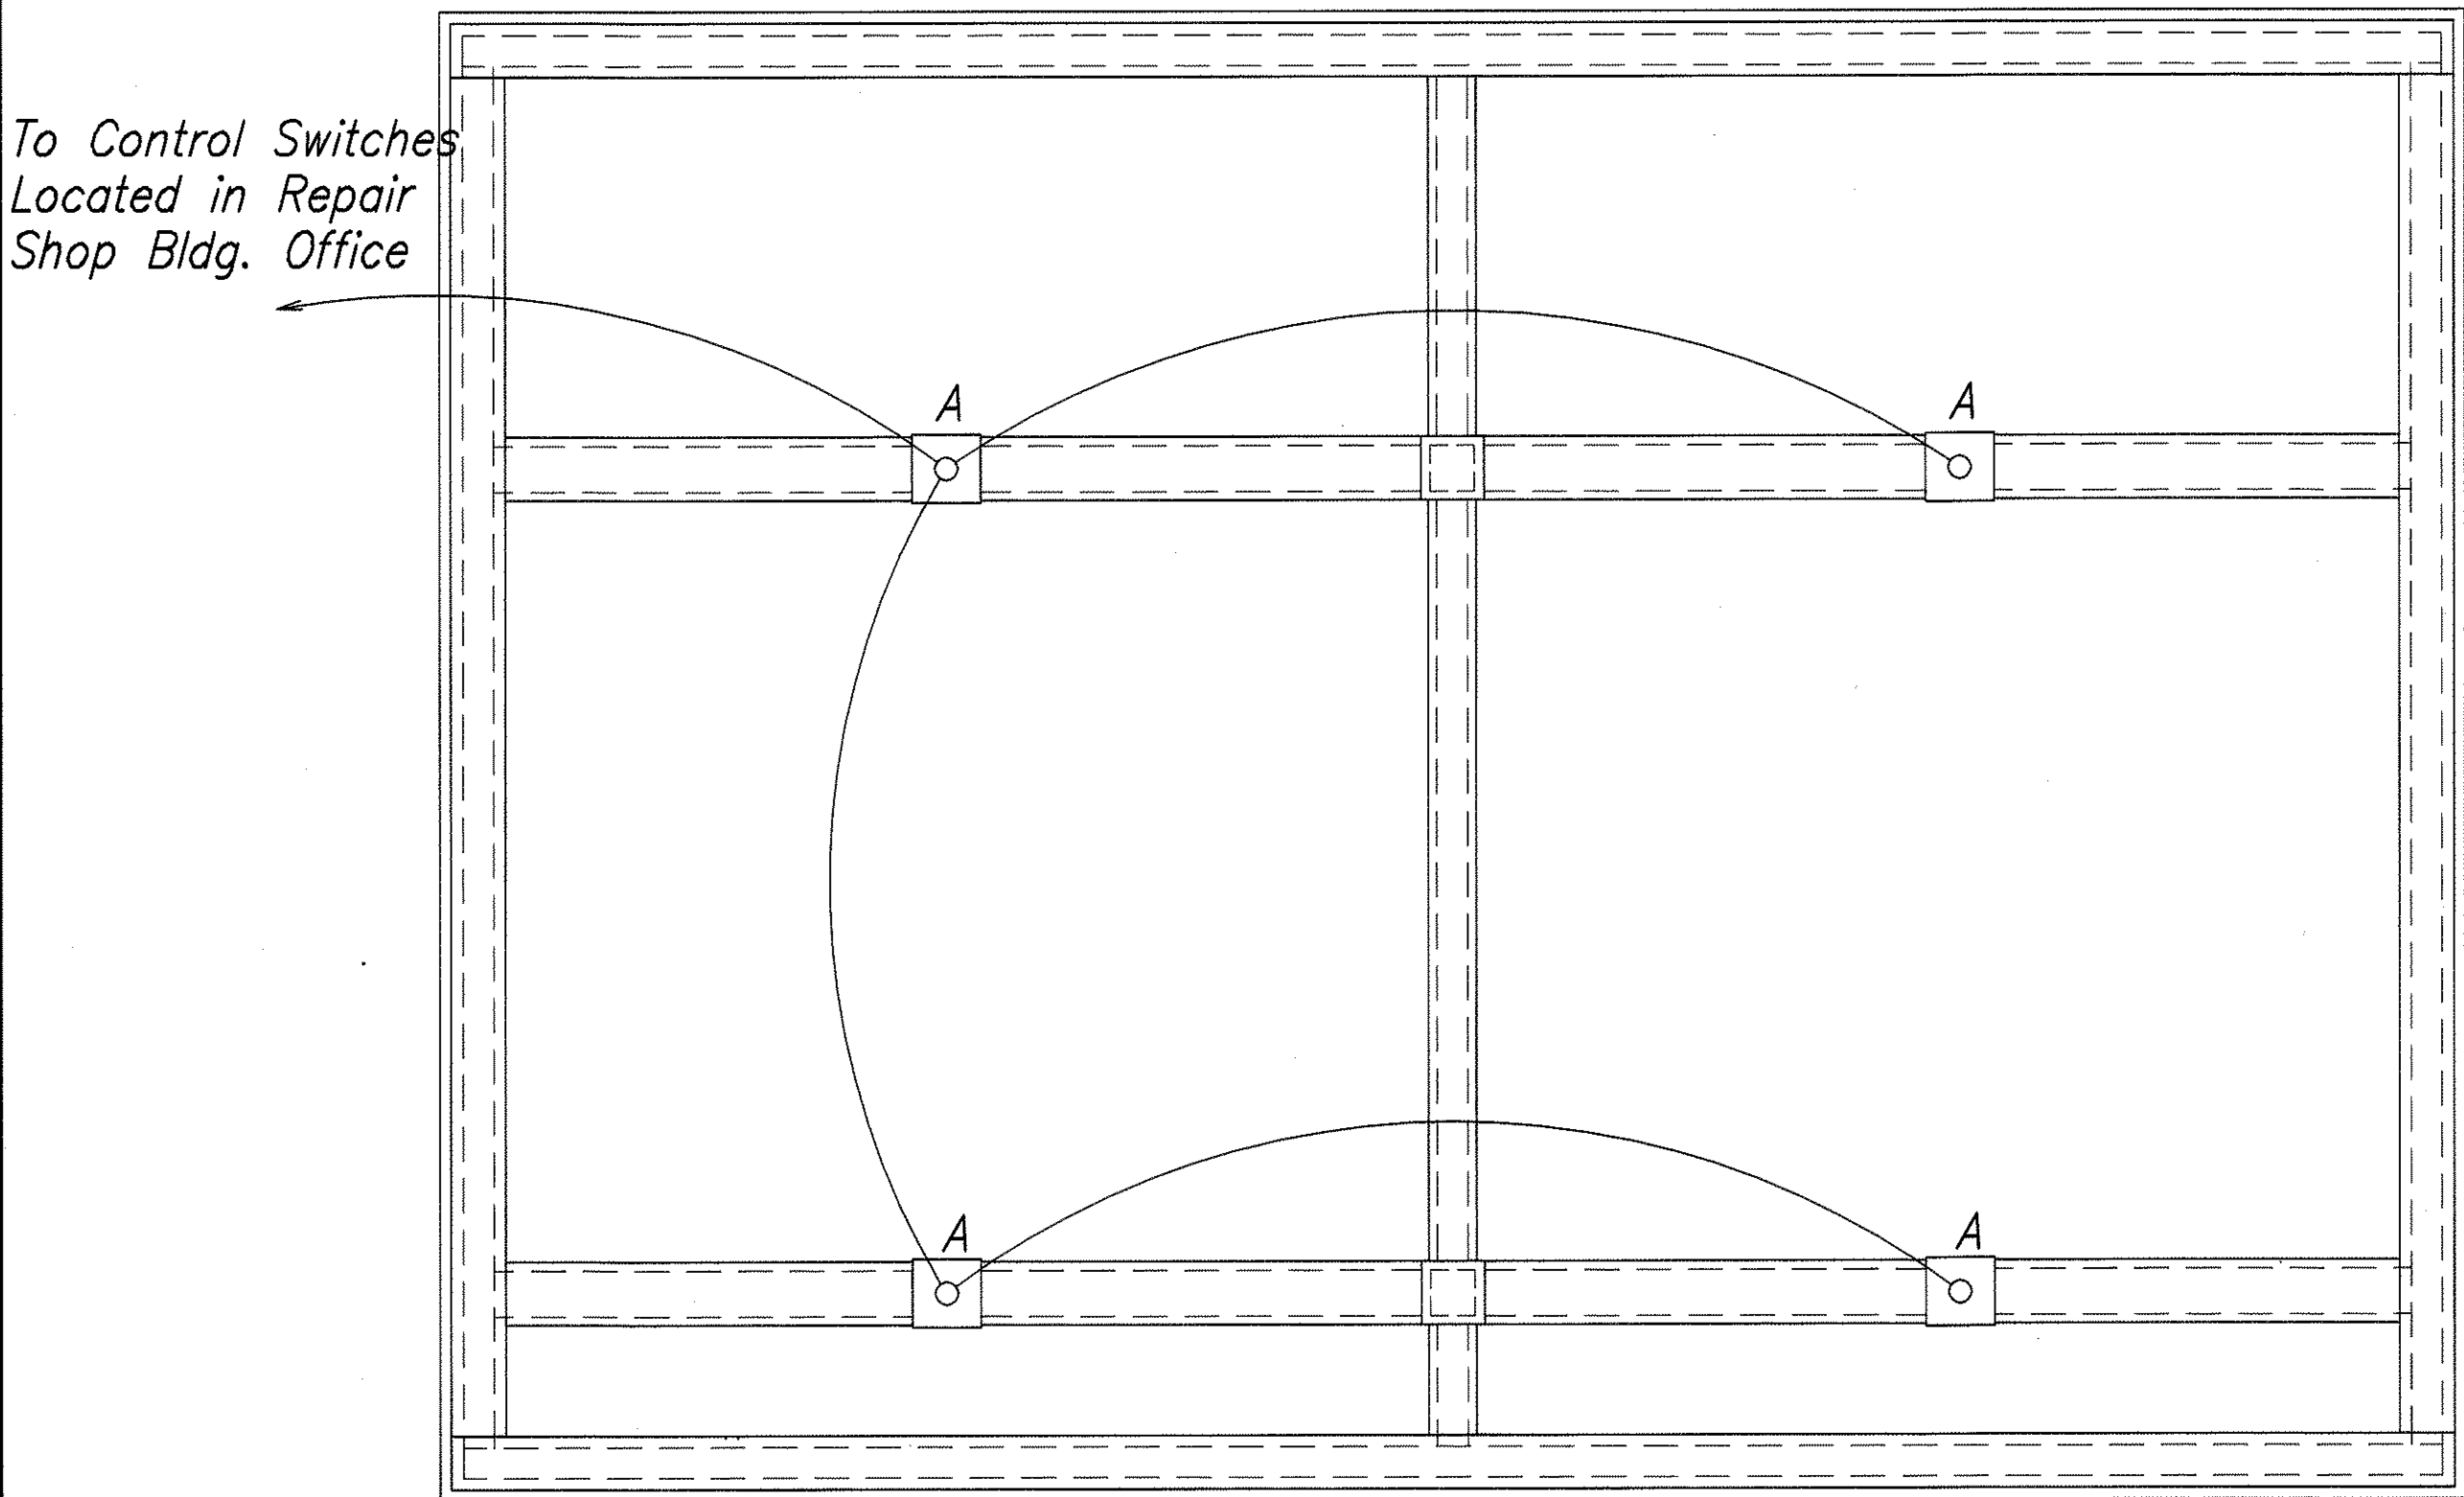

LIGHTING PLAN
SCALE: 1/4" = 1'-0"

SURVEY PLOTTED BY	DATE
DRAWN BY	
DESIGNED BY	
NOTED BY	
CHECKED BY	
ORIGINAL PLAN	
NOTE BOOK	
NO.	

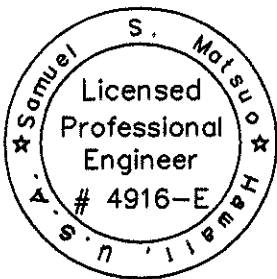

5-1-01
THIS WORK WAS PREPARED BY ME OR UNDER MY SUPERVISION.

E1.0

STATE OF HAWAII

DEPARTMENT OF TRANSPORTATION

HIGHWAYS DIVISION

GAS STATION BUILDING—

ELECTRICAL POWER PLAN,

LIGHTING PLAN

MAUI DISTRICT BASEYARD

Project No. HWY-M-03-99M

Scale: AS SHOWN Date: APR. 2001

SHEET No. E1.0 OF 2 SHEETS

