


FED. ROAD DIST. NO.	STATE	PROJ. NO.	FISCAL YEAR	SHEET NO.	TOTAL SHEETS
HAWAII	HAW.	HWY-M-05-98	2002	34	99

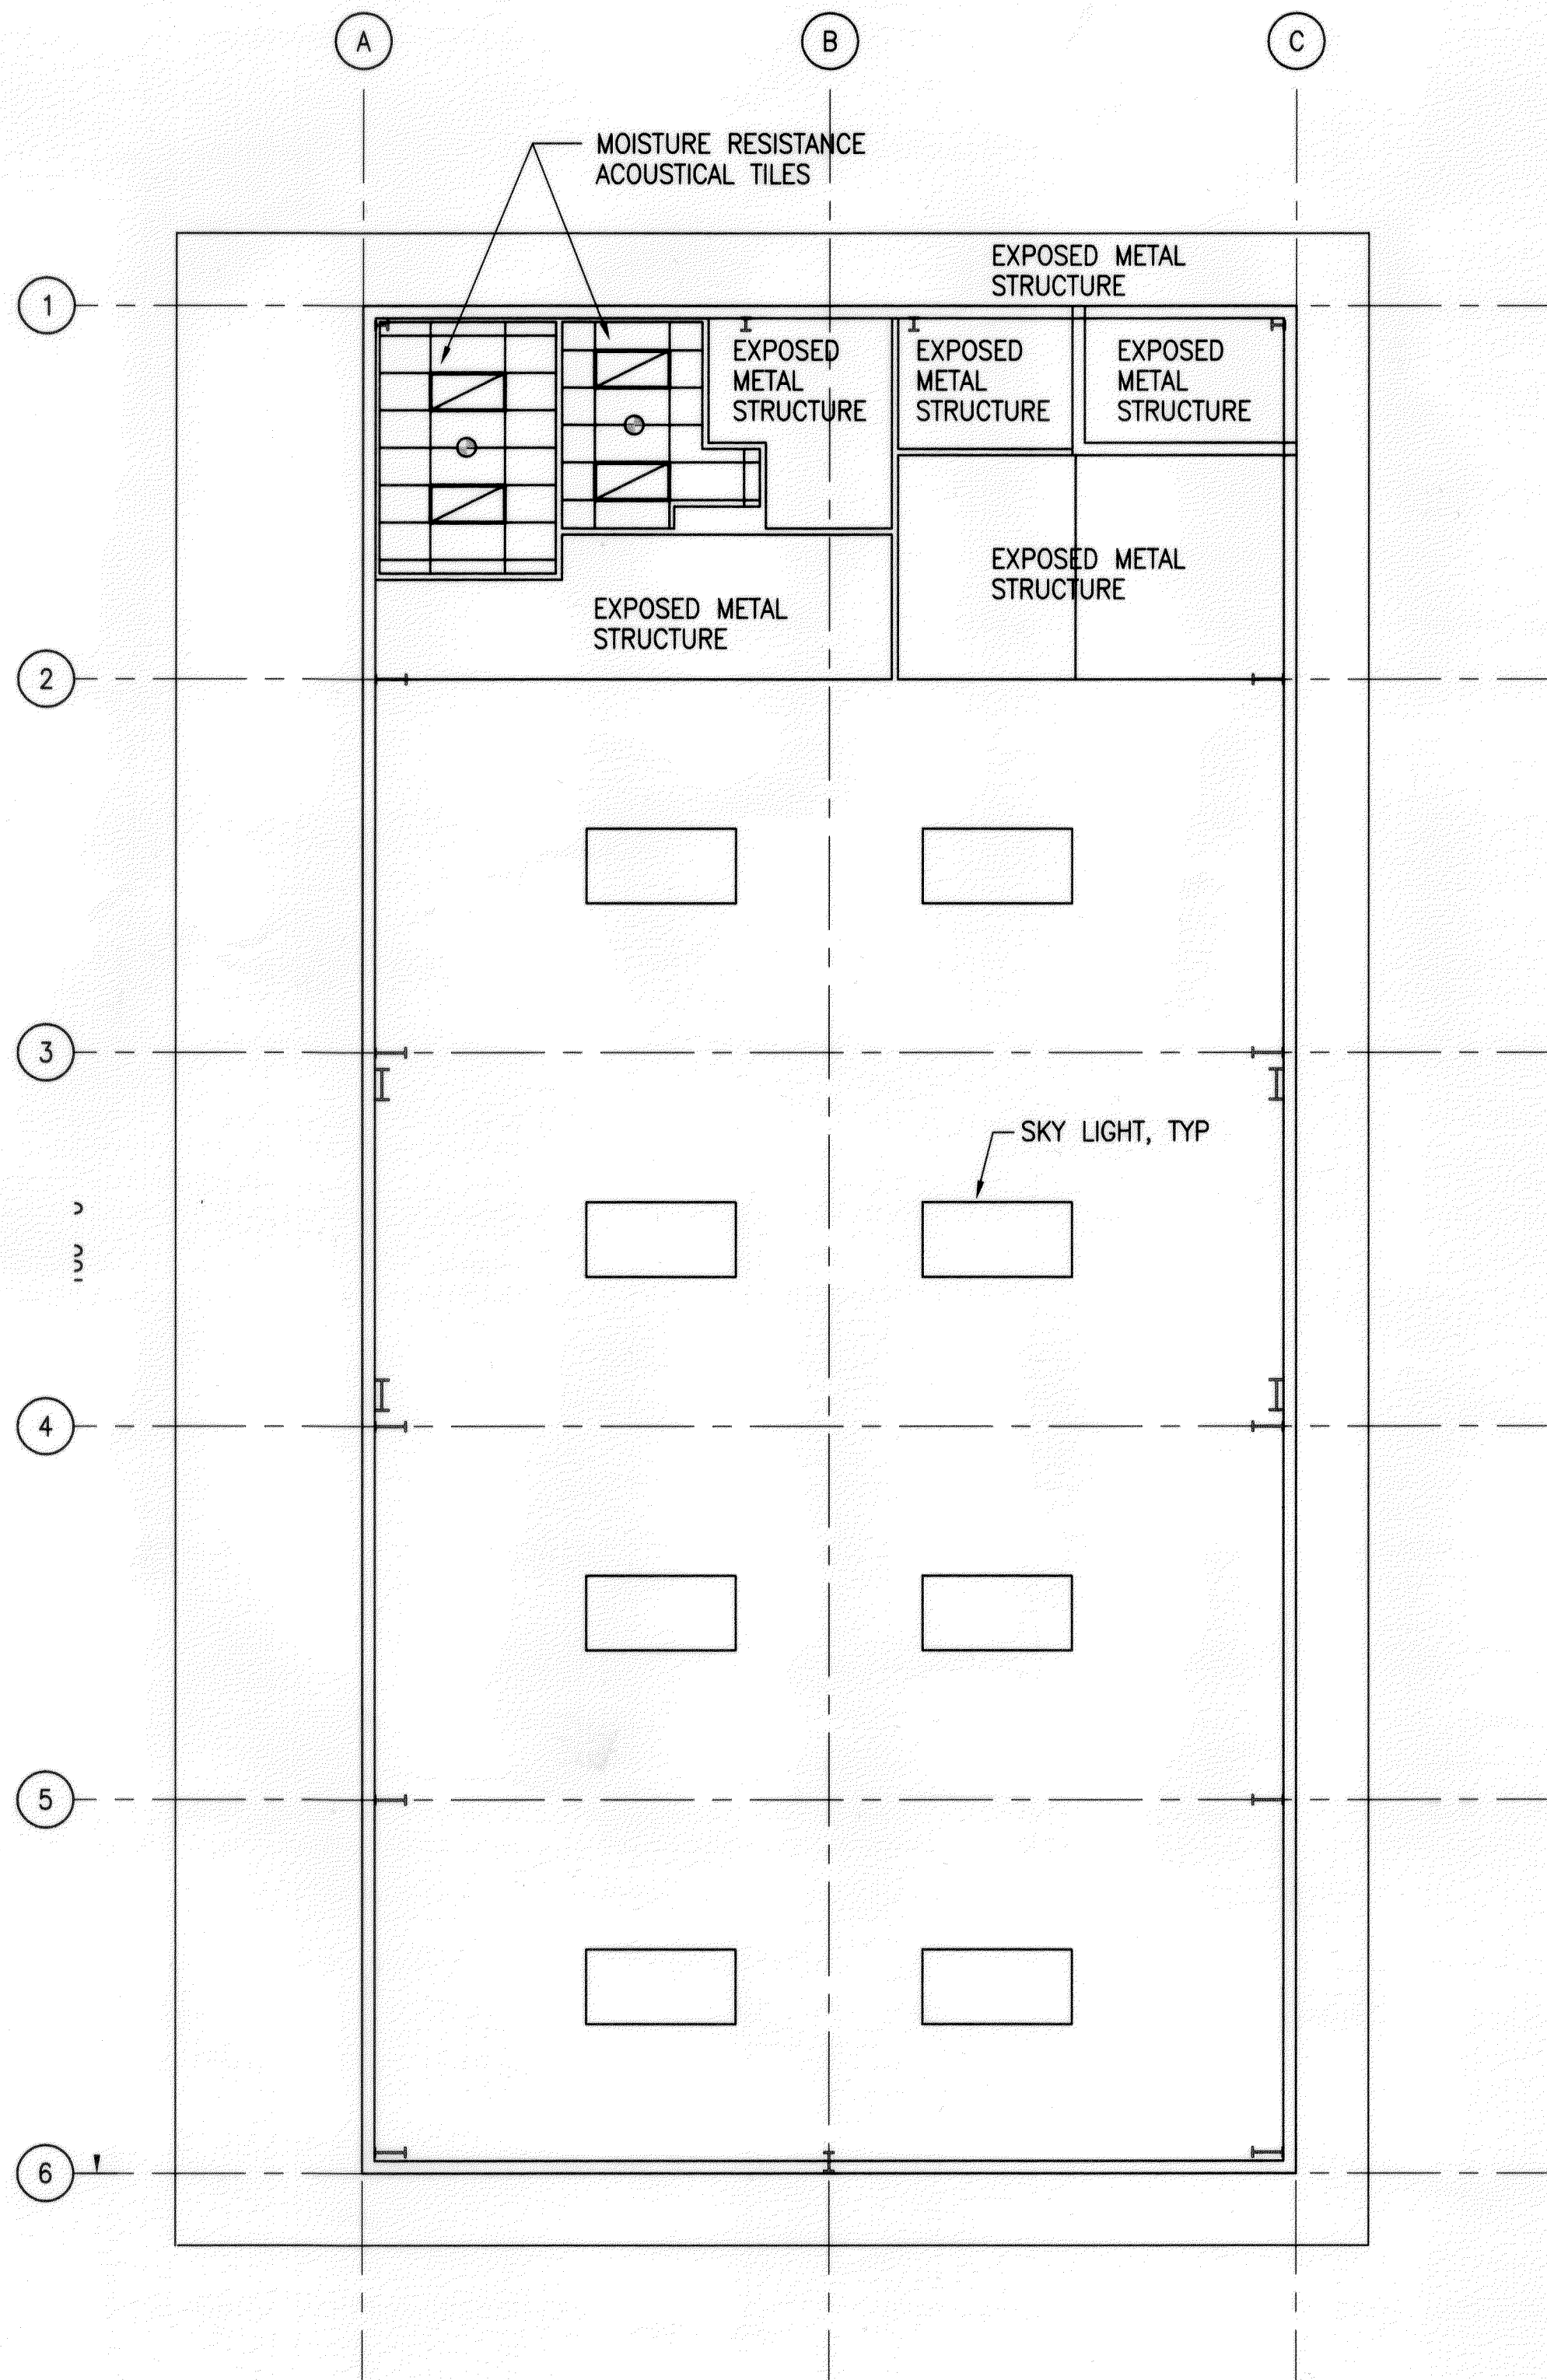


- NOTES:
- BRIDGE CRANE IS DEDUCTIVE ALTERNATE 3
 - VEHICLE LIFT IS DEDUCTIVE ALTERNATE 4
 - FINISHES
 - ROOFING, SIDING AND ASSOCIATED SHEET METAL WORK TO HAVE MANUFACTURERS COATING SYSTEM.
 - FOR PRE-ENGINEERED STRUCTURE EXPOSED EXTERIOR ELEMENTS TO BE HOT DIP GALVANIZED, CONCEALED AND INTERIOR ELEMENTS TO BE PRIME COATED, WITH EXPOSED ELEMENTS (EXTERIOR AND INTERIOR) PAINTED.


SURVEY PLOTTED BY	DATE
DESIGNED BY	
NOTED BY	
CHECKED BY	

6143A38.DWG 13:11 04/03/00 M:\DWG\6143-01\ARCH

A REFLECTED CEILING PLAN
A2.2 SCALE: 1/8"=1'-0"

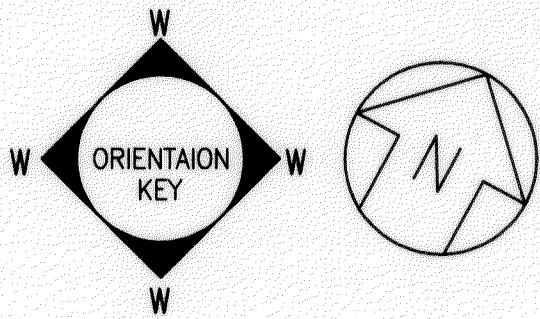

GRAPHIC SCALE:
8' 0 8' 16'
SCALE: 1/8"=1'-0"

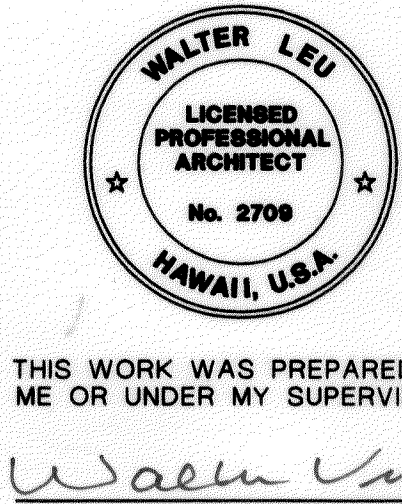

THIS WORK WAS PREPARED BY
ME OR UNDER MY SUPERVISION
Walter Leu

MAINTENANCE BUILDING

STATE OF HAWAII
DEPARTMENT OF TRANSPORTATION
HIGHWAYS DIVISION
**PARTIAL REFLECTED
CEILING PLAN**
MOLOKAI BASEYARD
MOLOKAI INDUSTRIAL PARK
Project No. HWY-M-05-98

Scale: As Noted
Date: SEPT. 13, 2001
SHEET No. A2.2 OF A2.6 SHEETS