FUEL DISPENSING SYSTEM NOTES

- 1. THE PUMPS ARE CONTROLLED MANUALLY AND DO NOT HAVE AUTOMATIC AUDITING FEATURES. FUEL DISTRIBUTION MUST BE LOGGED MANUALLY BY READING THE MECHANICAL ACCUMULATOR AT THE PUMP.
- 2. THE FUEL DISPENSING STATION SHALL BE IN COMPLIANCE WITH ALL STATE AND COUNTY REQUIREMENTS. THE ACCUMULATOR METERS ON THE PUMPS SHALL BE TESTED FOR COMPLIANCE WITH STATE REQUIREMENTS.

<u>DESCRIPTION - TANK LEAK MONITORING SYSTEM</u>

- 1. TANK PRODUCT LEVEL PROBE SENDS SIGNAL TO MONITOR, PROPORTIONAL TO LEVEL IN TANK.
- 2. TANK LEAK DETECTOR SENSOR LEVEL SWITCHES PROVIDE HIGH LEVEL CONTACT CLOSURE TO MONITOR.
- 3. UPON HIGH LEVEL IN TANK INTERSTITIAL SPACE DUE TO INNER TANK SHELL LEAKAGE, MONITOR SENDS ALARM SIGNAL TO LOCAL ALARM PANEL.
- 4. TANK LEVEL IS CONTINUOUSLY MONITORED. EITHER PRODUCT VOLUME OR LEVEL IS DISPLAYED AS SELECTED BY OPERATOR. HIGH TANK LEVEL DETECTED BY MONITOR SENDS ALARM SIGNAL TO ALARM PANEL.
- 6. ALARMS AT ALARM PANEL INCLUDE AUDIBLE HORN AND LIGHT. UPON ALARM, OPERATOR PUSHES ACKNOWLEDGE BUTTON, SILENCING AUDIBLE HORN. LIGHT REMAINS ILLUMINATED UNTIL ALARM CONDITION IS CORRECTED.
- 7. MONITOR SHALL BE ABLE TO DISTINGUISH BETWEEN STORAGE TANKS AND SHALL BE CAPABLE OF DISPLAYING SAME ON THE PANEL.


EQUIPMENT SCHEDULE

FUEL STORAGE TANK:

CONVAULT E4000 OR APPROVED EQUAL, 2-COMPARTMENT (3000 GALLON AND 1000 GALLON) ABOVE GROUND CONCRETE ENCASED STEEL FUEL STORAGE TANK WITH 30 MIL HIGH DENSITY POLYETHYLENE GEOMEMBRANE SECONDARY CONTAINMENT, STANDARD FINISH.


FUEL DISPENSER:

GASBOY 9123 OR APPROVED EQUAL, COMPACT COMMERCIAL SUCTION PUMP, 21 GPM (MAXIMUM DELIVERY RATE), 3/4 HP CONTINUOUS DUTY, 115/230/1/60, 12'-0" FLEXIBLE HOSE, HIGH HOSE RETRACTOR, SWIVELS, SHEAR VALVE, SIDE MOUNTED SUPPORTS.

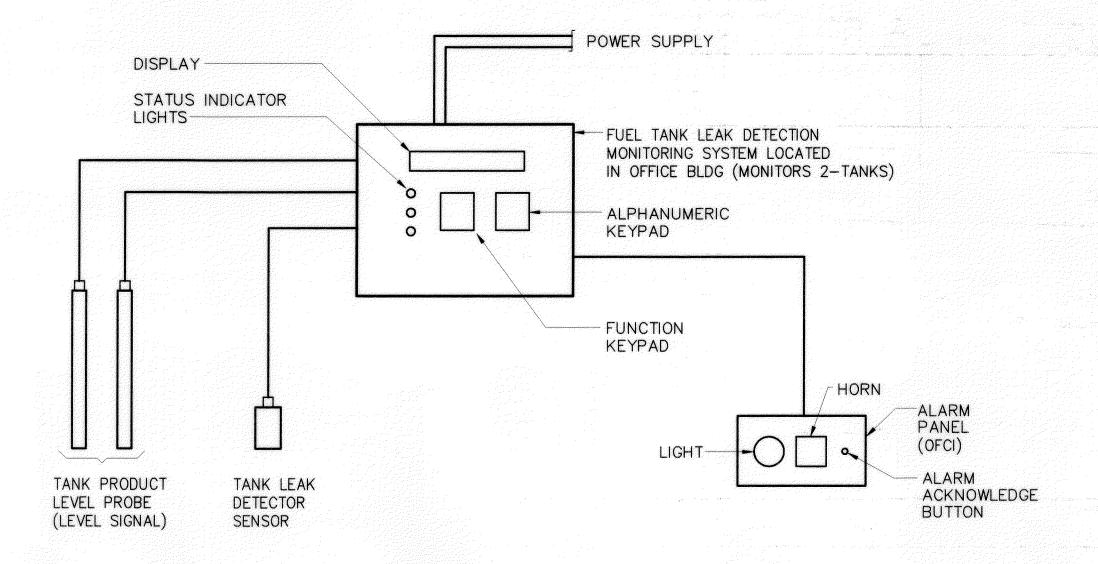


TANK LEAK MONITORING SYSTEM SCHEMATIC DIAGRAM SCALE: NONE

FED. ROAD DIST. NO. FED. AID-PROJ. NO. FISCAL YEAR SHEET NO. STATE SHEETS

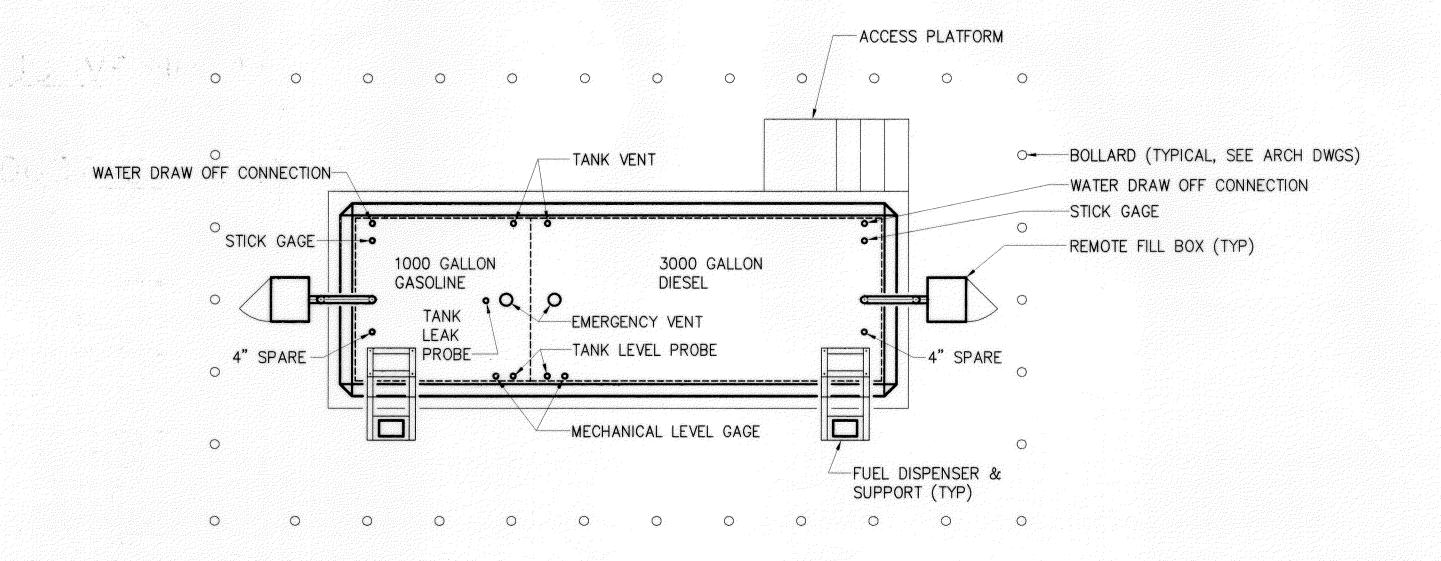

FUEL DISPENSING STATION FLOOR PLAN (SPLIT TANK) SCALE: 1/4" = 1'-0"

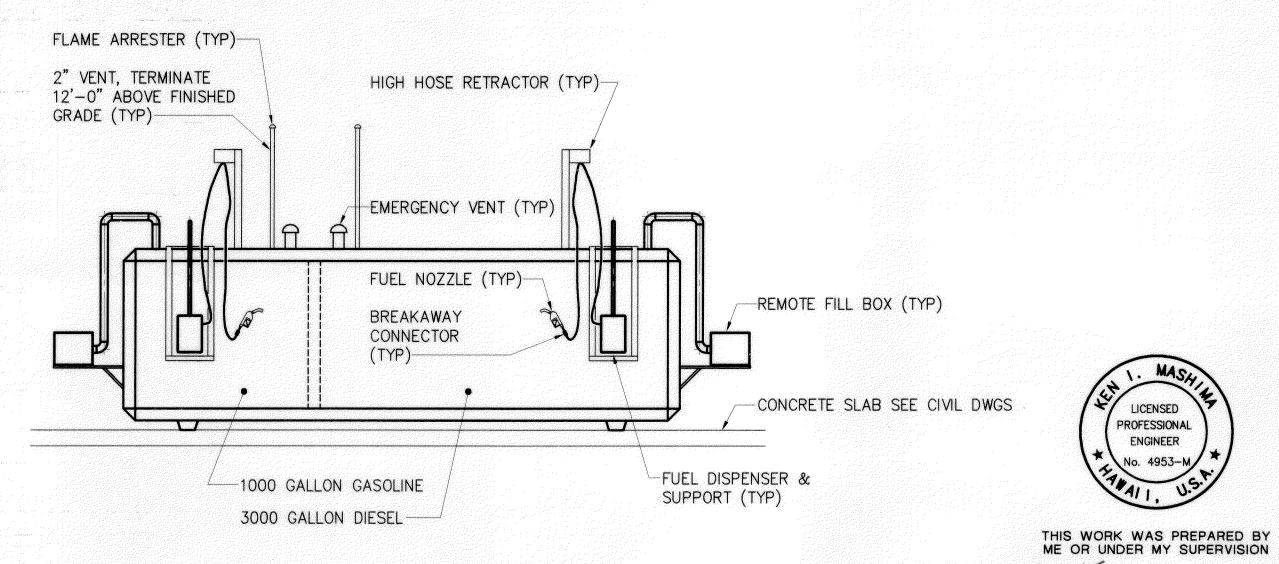


FUEL TANK SCHEMATIC ELEVATION SCALE: NONE

FUEL DISPENSING STATION


LICENSED

PROFESSIONAL

ENGINEER

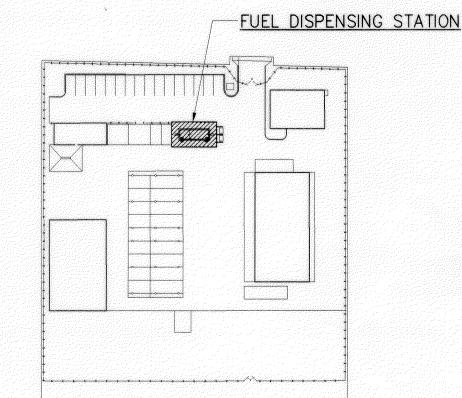



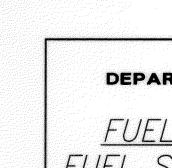

STATE OF HAWAII DEPARTMENT OF TRANSPORTATION HIGHWAYS DIVISION

FUEL DISPENSING STATION FUEL STOR. & DISP. FLR PLAN MOLOKAI BASEYARD

MOLOKAI INDUSTRIAL PARK Project No. HWY-M-05-98

Scale: As Noted

Date: SEPT 13, 2001

SHEET No. M4.1 OF M4.1 SHEETS

