


TYPICAL CONTROL DIAGRAM - CURFEW LIGHTS AND NIGHT LIGHTS

NOTES:

1. PROVIDE CONTACTORS AS REQUIRED TO CONTROL ALL NIGHT LIGHT AND CURFEW LIGHT CIRCUITS.

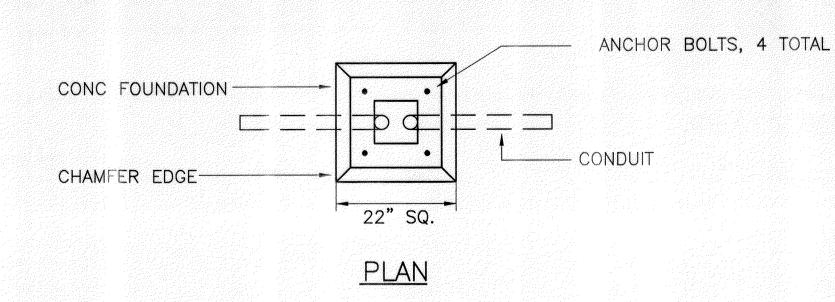


PARKING AREA LIGHT DETAIL N.T.S.

A

NOTES: FOR PARKING/WALKWAY AREA LIGHTS

1. POLE ASSEMBLY SHALL WITHSTAND 100MPH WIND VELOCITY WITH 1.3 GUST FACTOR.

- 2. ILLUMINATION LEVELS SHALL BE AS FOLLOWS:
- DRIVEWAY MIN. 2.5 FC AVG MAINTAINED W/ MAX 4 TO 1 UNIFORMITY PARKING MIN. 2.5 FC AVG MAINTAINED W/ MAX 4 TO 1 UNIFORMITY
- 3. SUBMIT FOOTCANDLE LEVEL PRINTOUT TO SHOW COMPLIANCE W/ ILLUMINATION LEVEL REQMT'S WITH ALL REQUEST FOR SUBSTITUTIONS & SHOP DRAWINGS.

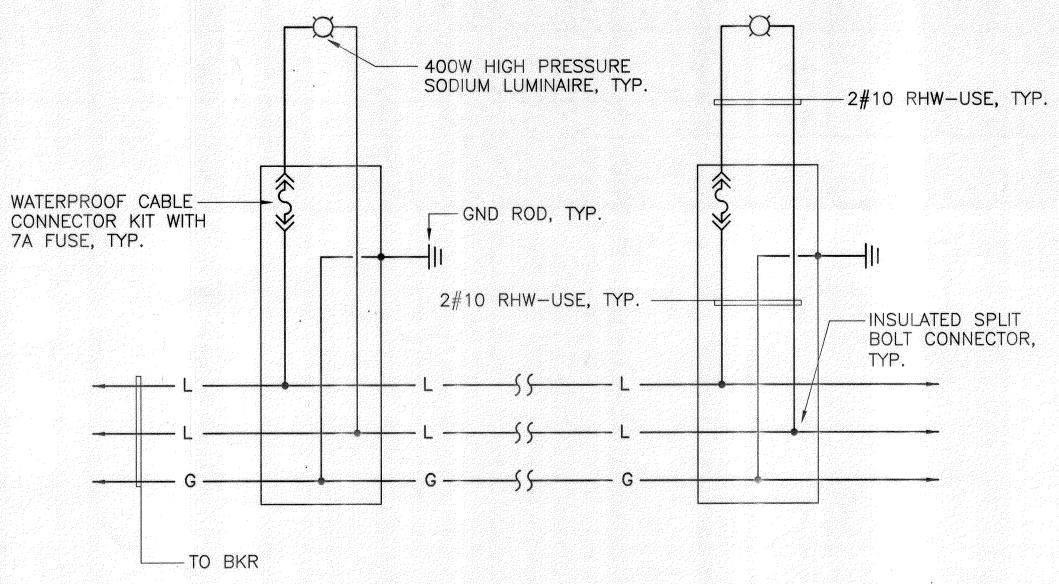

TYPICAL WIRING DIAGRAM—
DRIVEWAY/PARKING AREA LIGHTING



THIS WORK WAS PREPARED BY ME OR UNDER MY SUPERVISION

DEPARTMENT OF TRANSPORTATION
HIGHWAYS DIVISION

AREA LIGHT DETAILS AND
WIRING DIAGRAMS

MOLOKAI BASEYARD
MOLOKAI INDUSTRIAL PARK
Project No. HWY-M-05-98

STATE OF HAWAII

Scale: As Noted

Date: SEPT. 13, 2001

SHEET No. E4.1 OF E4.3 SHEETS

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