
FED. ROAD DIST. NO.	STATE	PROJ. NO.	FISCAL YEAR	SHEET NO.	TOTAL SHEETS
HAWAII	HAW.	HWY-M-ART18-01	2022	78	80

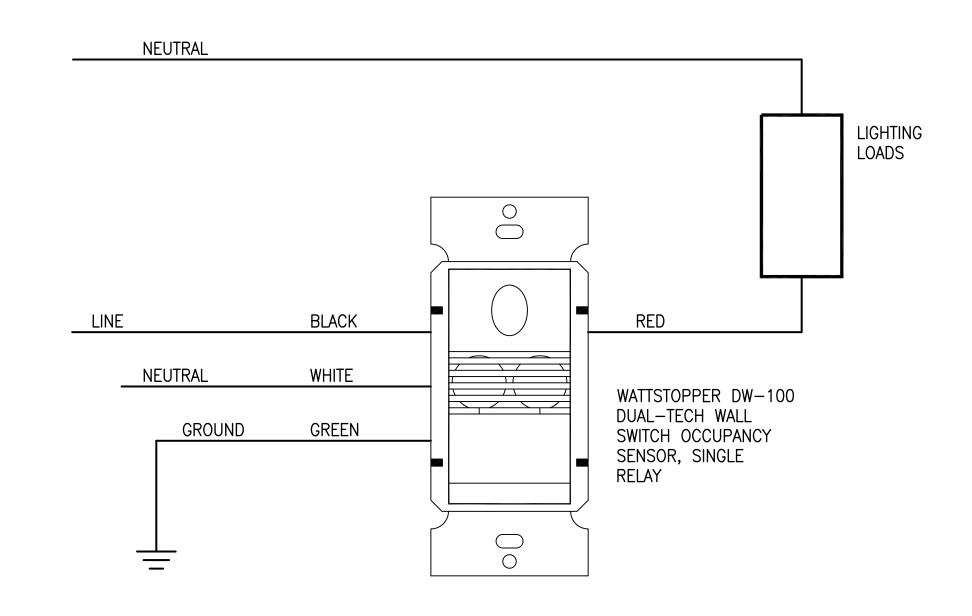


NEUTRAL WATTSTOPPER DW-200 DUAL-TECH WALL SWITCH OCCUPANCY SENSOR, DUAL RELAY LOAD A NEUTRAL WHITE GREEN GROUND LOAD B


NOTE:

ALL LOW VOLTAGE CONTROL WIRING SHALL BE INSTALLED IN CONDUIT, 3/4" MINIMUM

SINGLE RELAY SELF-CONTAINED OCCUPANCY SENSOR/WALL SWITCH CONTROL SCHEMATIC E21 NO SCALE CLOSET 1, CLOSET 2

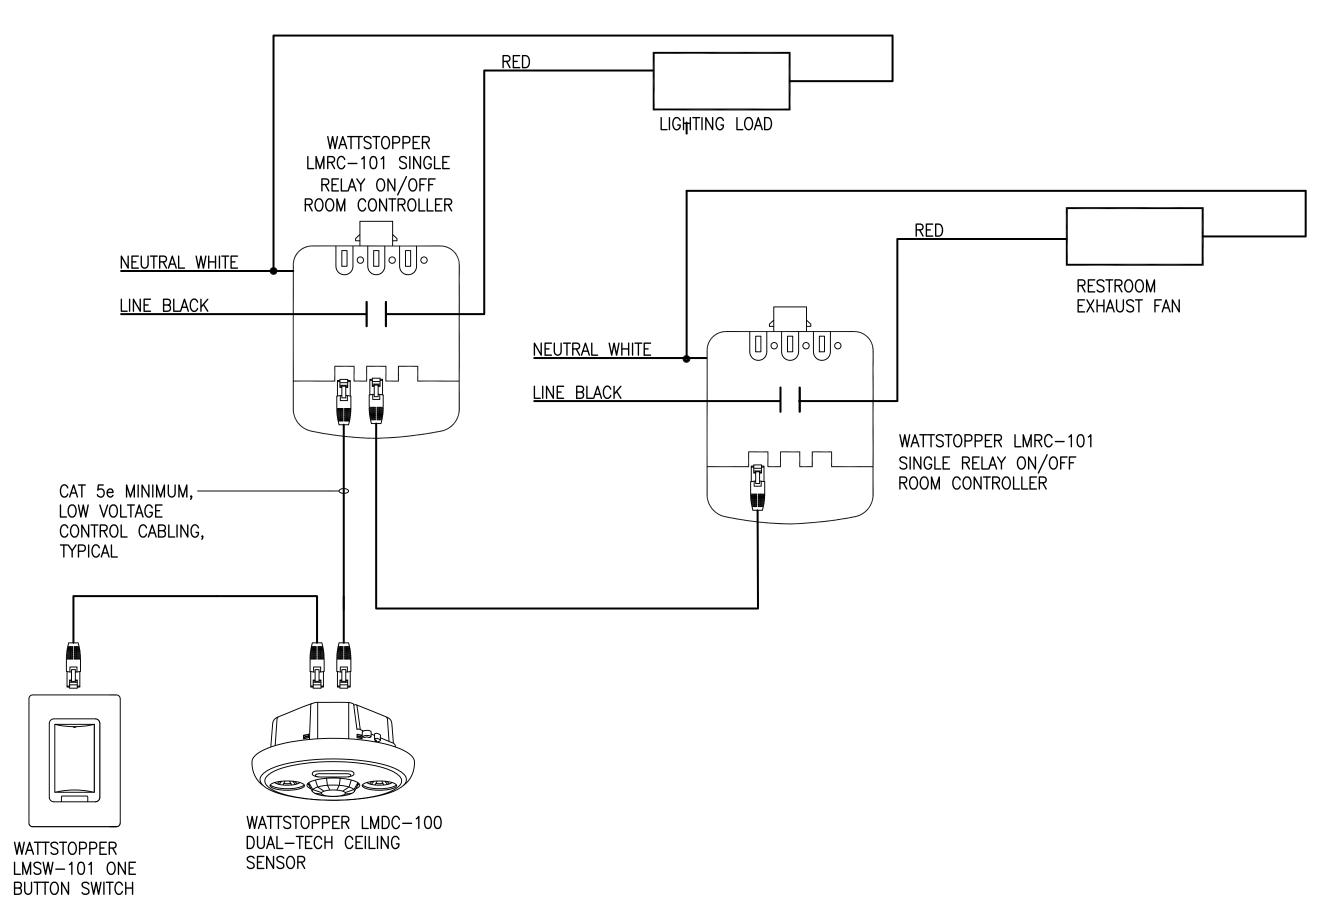

DUAL RELAY SELF-CONTAINED OCCUPANCY SENSOR/WALL SWITCH CONTROL SCHEMATIC E21 NO SCALE PRIVATE OFFICES

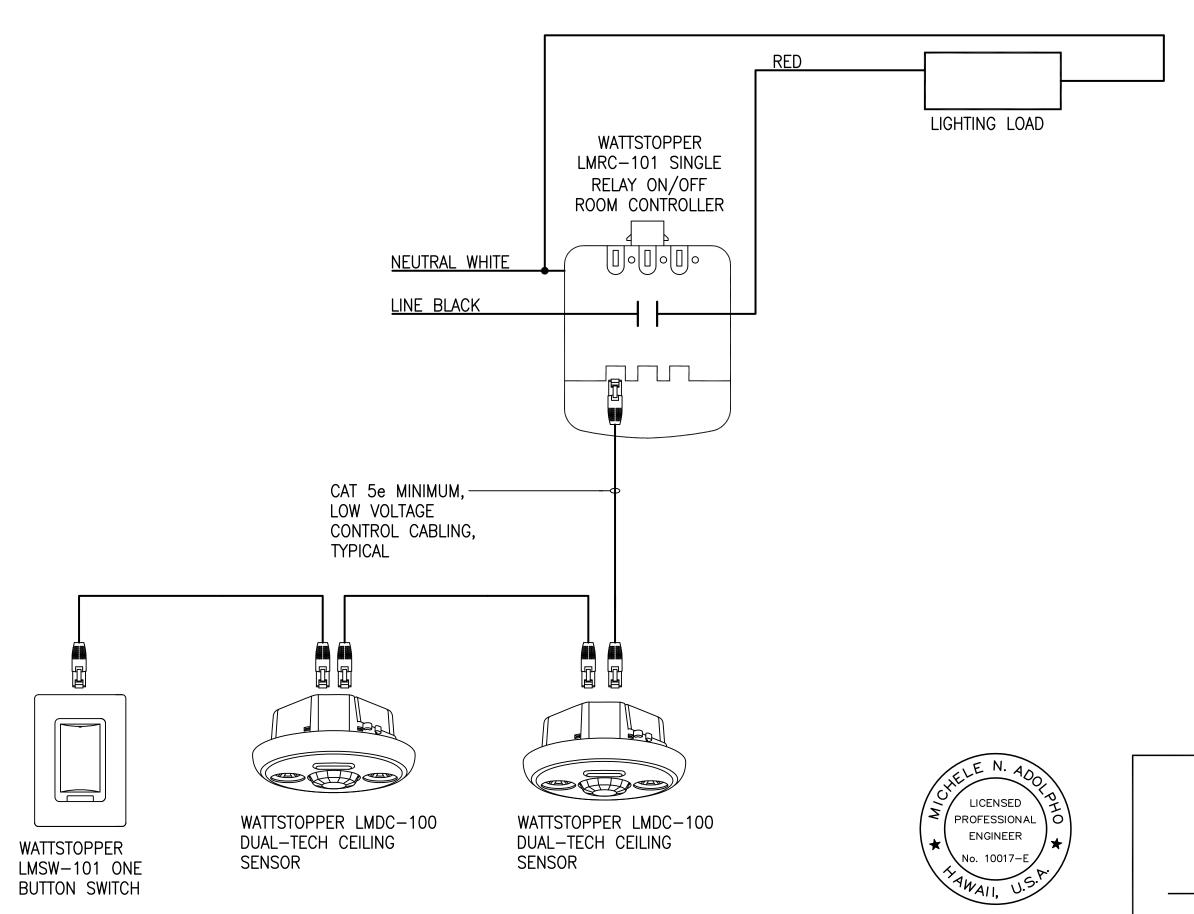

STATE OF HAWAII DEPARTMENT OF TRANSPORTATION HIGHWAYS DIVISION

LIGHTING CONTROL SCHEMATIC DIAGRAMS - 1

MAUI DISTRICT BASEYARD

Scale: AS SHOWN


Project No. HWY-M-ART18.01 Date: MAY 2022

PROJECT ENGINEER for ECS, Inc. APRIL 30, 2024
EXPIRATION DATE OF THE LICENSE

TYPICAL RESTROOM LIGHTING CONTROL SCHEMATIC - NEW OFFICE BUILDING E21 NO SCALE

TYPICAL HALLWAY LIGHTING CONTROL SCHEMATIC E21 NO SCALE

SHEET No. E21 OF 80 SHEETS

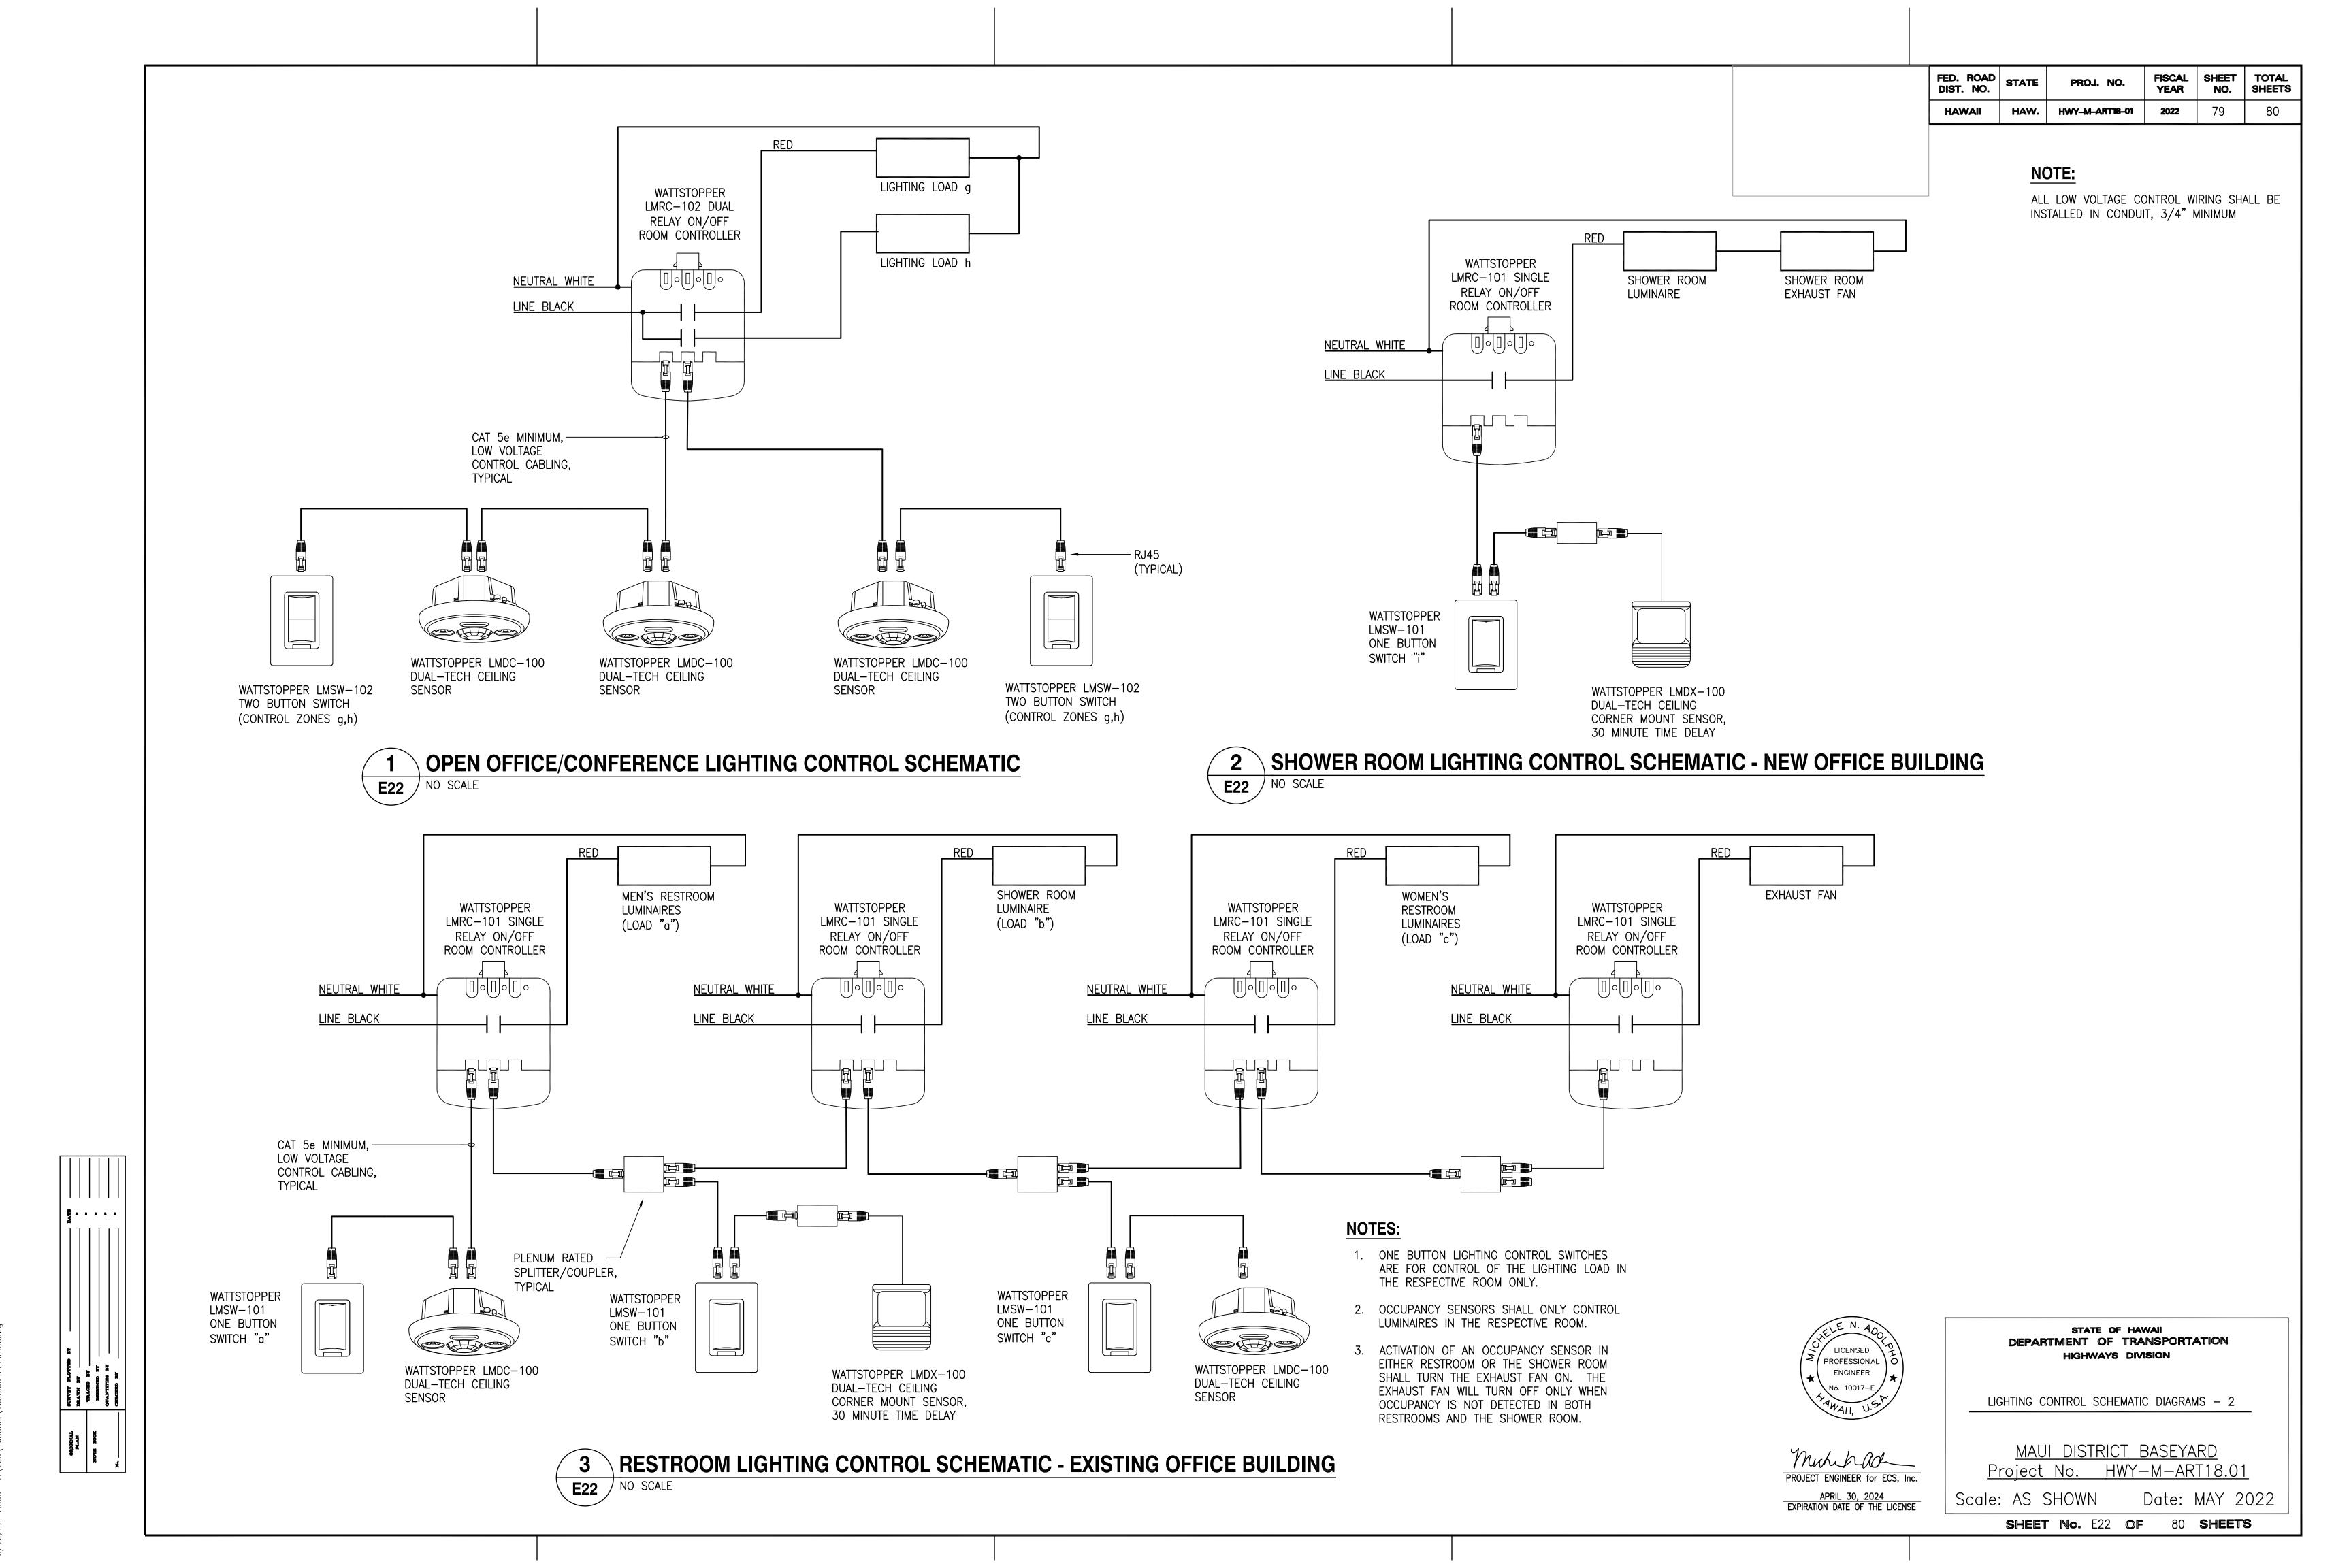

5/13/22-16:50 Y:\168\168 009\168 009 F22 R0