



## TEMPORARY CONSTRUCTION STABILIZATION Not to Scale

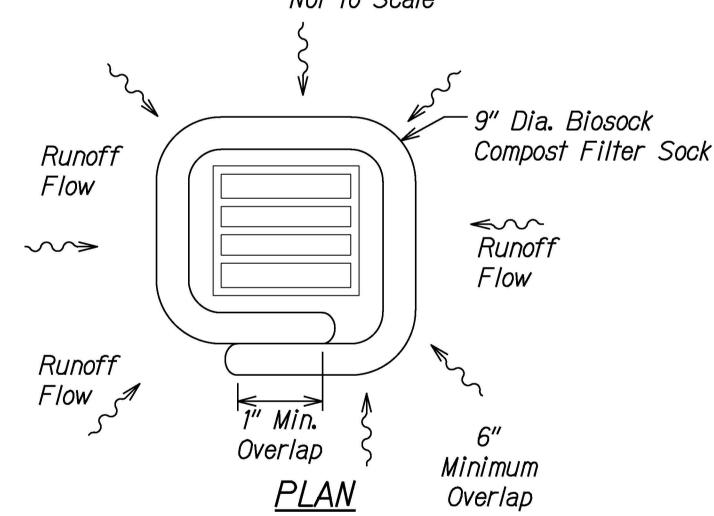

# BIOSOCK COMPOST FILTER SOCK DRAIN INLET PROTECTION DETAIL Not to Scale


#### BIOSOCK COMPOST FILTER SOCK NOTES:


- Remove accumulated sediment when depth reaches 1/3 the barrier height.
- Biosock material and compost shall be removed at the completion of construction (or a phase of construction) and shall be disposed or properly.
- No staking is required for slopes < 4:1.
- Compost shall not contain biosolids and should be consistent with United States Environmental Protection Agency guidelines.

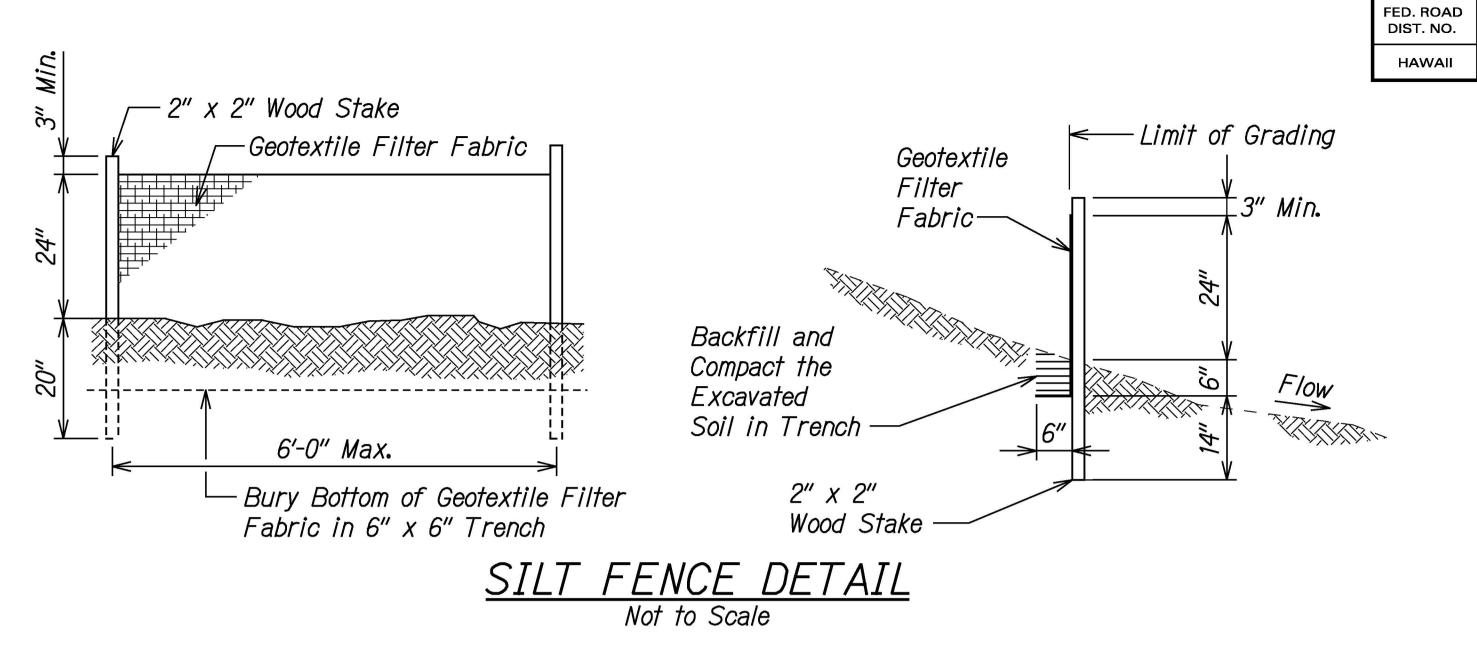

### **SILT FENCE NOTES:**

- 1. The filter fabric shall be a minimum of 36 inches wide.
- 2. If silt fence is obtained from manufacturer as a package (i.e. fabric attached to post) the manufacturer's installation instructions shall be adhered to.

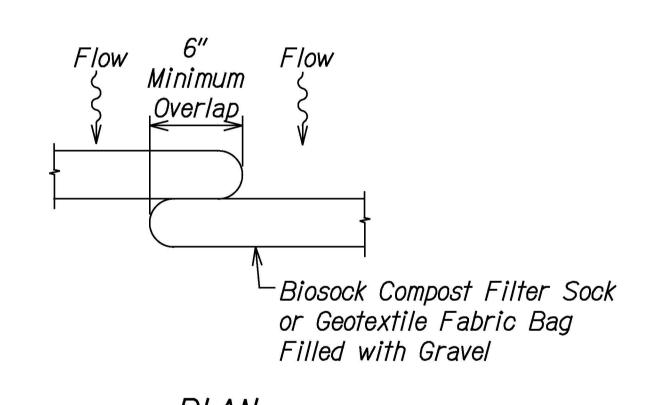

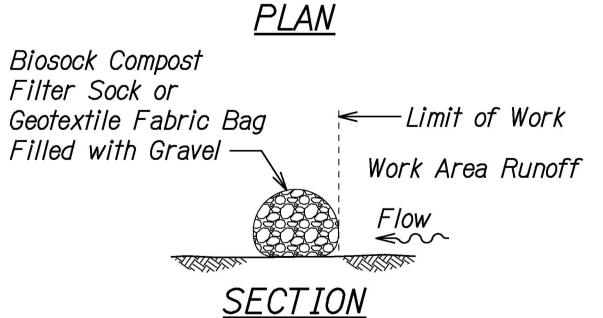


## BIOSOCK COMPOST FILTER SOCK DETAIL GRAVEL BAG DETAIL Not to Scale

### STAGING AREA NOTES:

- Place and tack down geotextile fabric over sheet plastic at staging area.
- 2. Place Biosocks or silt fence along low end of staging area perimeter to filter staging area runoff.
- 3. Place drip pans under all vehicles and equipment.
- 4. Provide spill kits at all staging areas.
- 5. Secure and provide secondary containment for portable toilets.
- Contractor to install temporary construction stabilization entrances for staging areas. See details on this Sht.

#### STORAGE AREA NOTES:


- Place Biosocks along storage area perimeter to filter runoff
- 2. Contractor to install temporary construction stabilization entrances for storage areas. See details on this Sht.

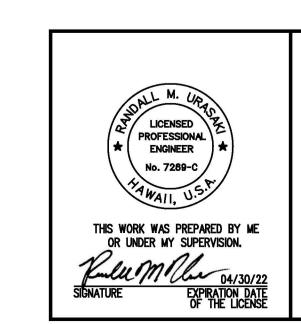

**DEPARTMENT OF TRANSPORTATION** WATER POLLUTION ♦ EROSION CONTROL DETAILS KUHIO HIGHWAY

Repairs to Wailua River Bridge Fed. Aid Project No. ER-23(001) Date: Apr. 2021 Scale: Not to Scale

SHEET No. *EC-4* OF 5 SHEETS

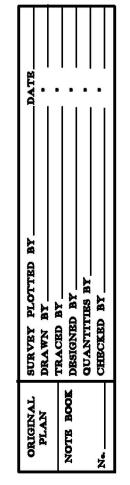

FISCAL SHEET YEAR NO.

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2021

FEDERAL AID PROJ. NO.

ER-23(001)