
FED. ROAD DIST. NO.	STATE	FED, AID PROJ, NO.	FISCAL YEAR	SHEET NO.	TOTAL SHEETS
HAWAII	HAW.	NH-056-1(50)	2010	79	297

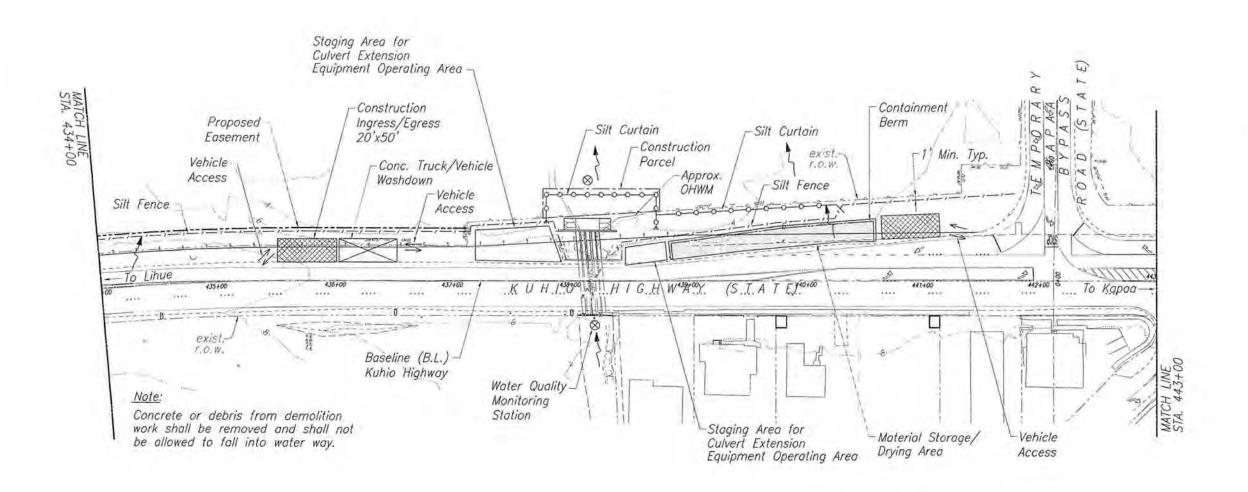

LEGEND:

Vehicle Washdown

Construction Ingress/Egress

Staging Area

Silt Fence

Silt Curtain

Inlet Protection

ELAN A. LOC LICENSES PROFESSIONAL ENGINEER

OR UNDER WAS PREPARED BY MY OR UNDER WY SUPERVISION

WESDI DEAMENT ECRPERATION LIC TAP DATE

DEPARTMENT OF TRANSPORTATION

EROSION CONTROL PLAN - 6

Kuhio Highway Short-Term Improvements

South Leho Drive to Aleka Loop

Fed. Aid Proj. No. NH-056-1(50)

Scale: As Noted Date: November 2009

SHEET No. 6 OF 8 SHEETS

SKIRKTY PLOTEEN DY
TRACES BY
DESIGNED DY
CHRISTIS BY
CHRISTIS BY
CHRISTIS BY

GRAPHIC SCALE: 40' 20' 0 40' 80 SCALE: 1" = 40' Water Quality
Monitoring Station


EROSION C


Kuhio Highway


South Leh

Fed. Aid P

Scale: As Not

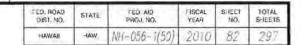


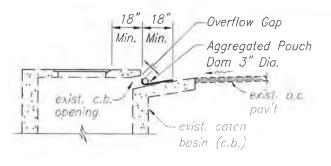


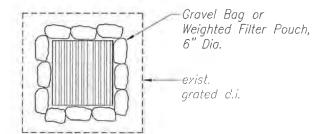

ELEVATION

AGGREGATE POUCH Not to Scale

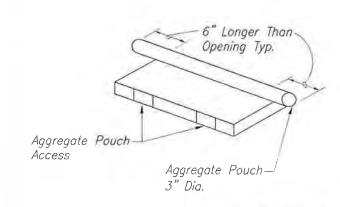

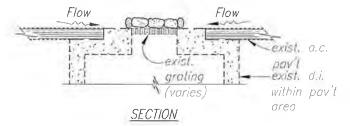


PLAN VIEW

SAND OR GRAVEL BAGS
AT GRATED DRAIN INLET

Not to Scale


AGGREGATE POUCH AT CATCH BASIN OPENING

Not to Scale

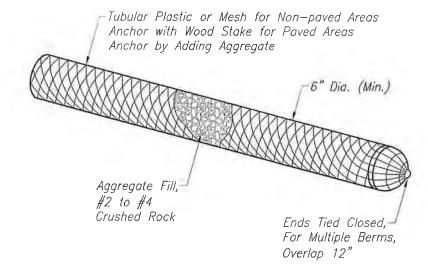

AGGREGATE FILTER POUCH

Not to Scale

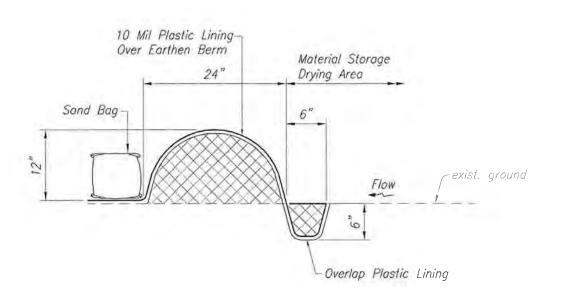

CONTAINMENT BERM Not to Scale



THIS WORK WAS PREPARED BY MI

WESON OKAMOTO CORPORATION UC EXP. DATE

STATE OF HAWAII
DEPARTMENT OF TRANSPORTATION
HIGHWAYS DIVISION


EROSION CONTROL DETAILS

Kuhio Highway Short-Term Improvements
South Leho Drive to Aleka Loop
Fed. Aid Proj. No. NH-056-1(50)

Scale: As Noted Date: November 2009

SHEET No. 1 OF 2 SHEETS



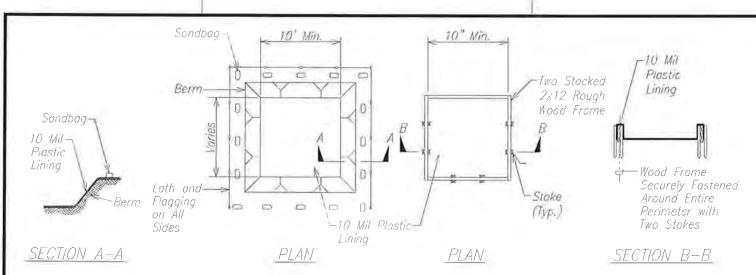

Netes:

- 1. Actual layout determined in field.
- 2. The concrete washout sign shall be installed within 30 feet of the temporary concrete washout facility.

CONCRETE VEHICLE WASH AREA (BELOW GRADE)

Notes:

- Actual layout determined in field.
- The concrete washout sign shall be installed within 30 feet of the temporary concrete washout facility.

CONCRETE VEHICLE WASH AREA (ABOVE GRADE)

WASHDOWN BASIN DETAIL

Not to Scale

Not to Scale

-2"x2" Wood Stake or 1 1/4" y 1 1/4" or Geotextile Filter-2"y2" Oak or Fabric Maple Stake Bury Bottom of Geotextile Filter Fabric in 6"x6" Trench 8' Max. SILT FENCE DETAIL

Geotextile Filter-Fabric Backfill and-Compact the Excavated Soil in Trench 2"x2" Wood-Stake or 1 1/4" x 1 1/4" or 2"x2" Oak or Maple Stake

SILT CURTAIN DETAIL

Not to Scale

8' O.C. Max.

Boom Float

Fasten Fabric to-

Boam Float, Typ.

DIST. NO.

HAWAII

- Chain Ballast

Foster Fabric to

Chain Ballast (Typ.)

STATE

FISCAL YEAR

- NH-056-1(50) 2010

SHEET NO.

83

NOTES:

exist.


cround

Arichor

Ballast,

Тур.

- 1. Fabric shall be high strength2 nylon reinforced vinyl high visibility yellow, 22 oz/yd weight.
- 2. Chain ballast shall 5/16" galvanized chain (min 1.1 lbs/ft)
- 3. Anchor ballast shall be minimum 50 lbs at 8' o.c.
- 4 Silt curtain shall be installed prior to start of construction in water which might result in discharges to state waters.
- 5. The Contractor shall notify the Engineer and water quality monitor two weeks prior to installation of silt curtain.

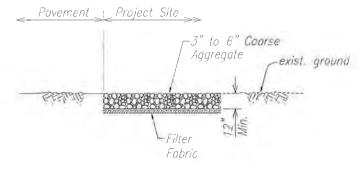

TEMPORARY STABILIZED CONSTRUCTION INGRESS/EGRESS Not to Scale



WESON DRAMOTO CORPORATION LIC EXP. DAT

STATE OF HAWAII
DEPARTMENT OF TRANSPORTATION

EROSION CONTROL DETAILS

Kuhio Highway Short-Term Improvements South Leho Drive to Aleka Loop Fed. Aid Proj. No. NH-056-1(50)

Scale: As Noted Date: November 2009

SHEET No. 2 OF 2 SHEETS

