


FED. ROAD DIST. NO. FISCAL SHEET TOTAL YEAR NO. SHEETS PROJ. NO. 56D-01-95M 1995 HAW.

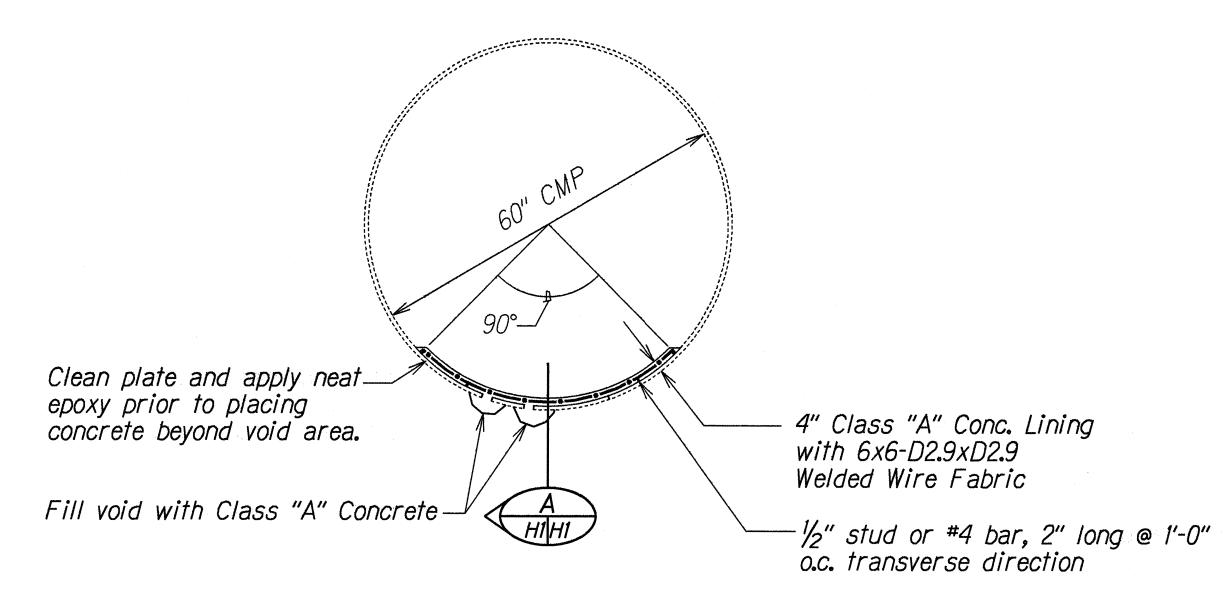

SECTION OF 60" CMP Scale: 3/4"=1'-0"

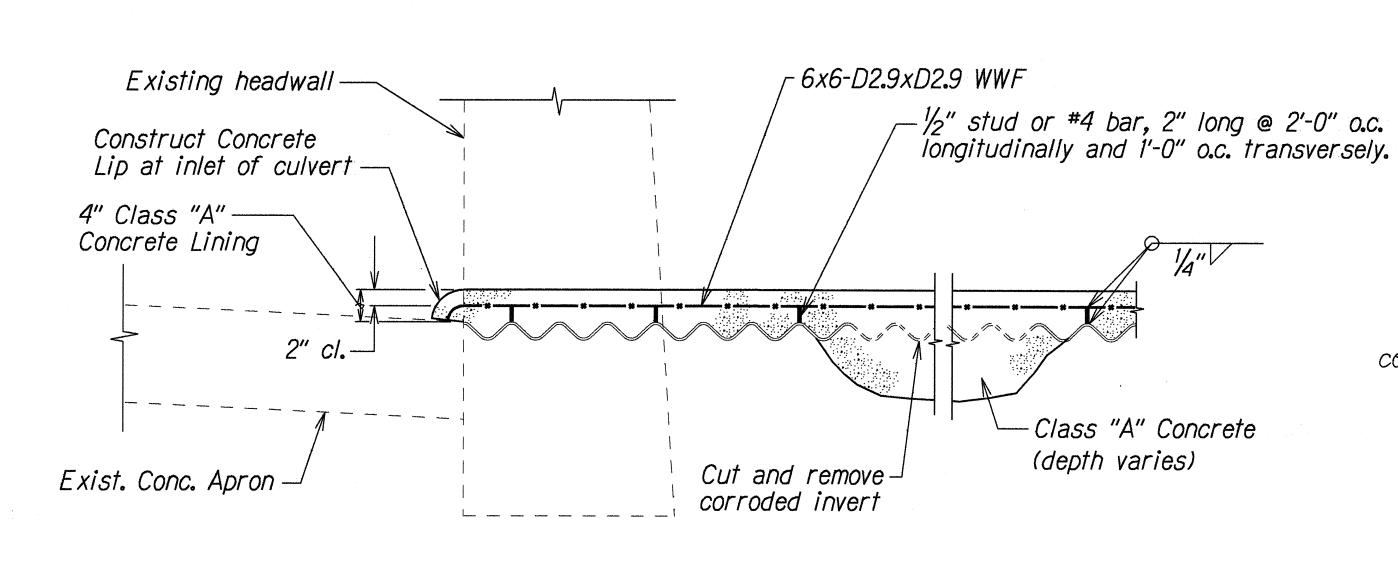


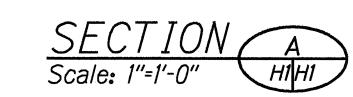

TYPICAL DETAILS OF 60" CORRUGATED METAL PIPE INVERT REPAIR

GENERAL NOTES:

- 1. The culvert surface to be in contact with the concrete shall be clean and dry to the satisfaction of the engineer. Badly corroded sections shall be cut and removed. Epoxy shall be neatly applied to the clean metal surface prior to placing concrete.
- 2. The welded wire fabric steel reinforcement shall be placed two inches above the crest of corrugations by welding to studs. The studs shall be welded to the structural plate culvert at two feet on centers longitudinally and 1'-0" transversely. If lapping of the welded wire fabric is necessary, it shall be lapped a minimum of six inches.
- 3. The welded wire fabric, studs and epoxy shall not be paid for separately but shall be considered incidental to concrete.
- 4. The concrete culvert lining shall be scored 3/4-inch deep transversely along the crest of corrugations, 20 feet on-center.

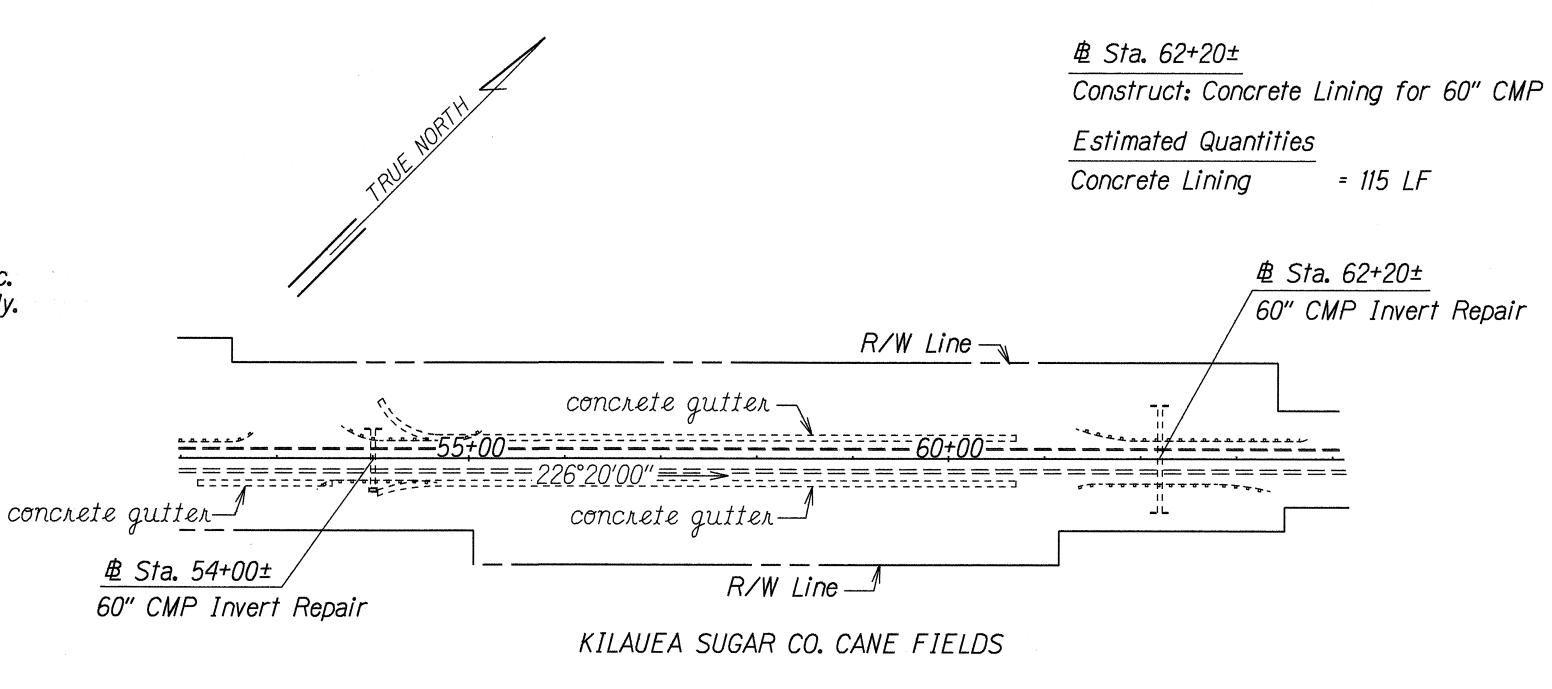

₿ Sta. 54+00±

Construct: Concrete Lining for 60" CMP

Estimated Quantities

Concrete Lining = 60 LF PLAN Scale: 1"=100'

DEPARTMENT OF TRANSPORTATION

DRAINAGE PLAN & DETAILS

KUHIO HIGHWAY <u>Drainage Repairs</u> PROJ. NO. 56D-01-95M

Scale: As Shown

Date: Mar, 1995

SHEET No. H1 OF

