


FED. ROAD DIST. NO. STATE 50E-01-98 HAW.

- 1. THE CONTRACTOR SHALL MEASURE AND RECORD THE GROUND RESISTANCE AT EACH STANDARD WITH NO EXTERNAL GROUND WIRES CONNECTED TO THE GROUND ROD. CONTRACTOR SHALL SCHEDULE GROUND RESISTANCE MEASUREMENTS 48 HOURS IN ADVANCE AND SHALL NOT PROCEED WITH MEASUREMENTS UNTIL APPROVAL IS GRANTED. SCHEDULES ARE SUBJECT TO CHANGE DEPENDING UPON WEATHER CONDITIONS. REPORTS SHALL INCLUDE NAME OF PERSONNEL CONDUCTING THE TEST, METER TYPE AND SERIAL NUMBER, DATE OF TEST AND SOIL CONDITIONS. TEST RESULTS SHALL BE CERTIFIED BY THE CONTRACTOR AND SUBMITTED TO THE ENGINEER.
- 2. CONTRACTOR SHALL NOT BACKFILL TRENCHES UNTIL APPROVAL HAS BEEN GRANTED BY THE ENGINEER.
- 3. COAT EXPOSED ANCHOR BOLT THREADS, HEX NUT, AND WASHER AFTER INSTALLATION WITH BEARING GREASE.
- 4. ALL NEUTRAL CONDUCTORS MUST HAVE WHITE INSULATION, ANY OTHER METHOD OF IDENTIFICATION IS UNACCEPTABLE.
- 5. CONTRACTOR TO ARRANGE WITH KECO TO ENERGIZE STREET LIGHT FOR A MINIMUM OF SIX (6) HOURS FOR INSPECTION AND ACCEPTANCE. CONTRACTOR TO ASSUME COST.
- 6. SUBMIT SHOP DRAWINGS FOR ALL STREET LIGHT COMPONENTS INCLUDING PULLBOXES FOR APPROVAL.
- 7. STREET LIGHTS SHALL NOT BE INSTALLED IN WALKWAYS.

STREET LIGHT CONSTRUCTION NOTES:


8. STREET LIGHT PULL BOXES SHALL BE LOCATED BEHIND STREET LIGHT AND SHALL NOT BE INSTALLED IN ROADWAYS OR ROADWAY SHOULDERS.

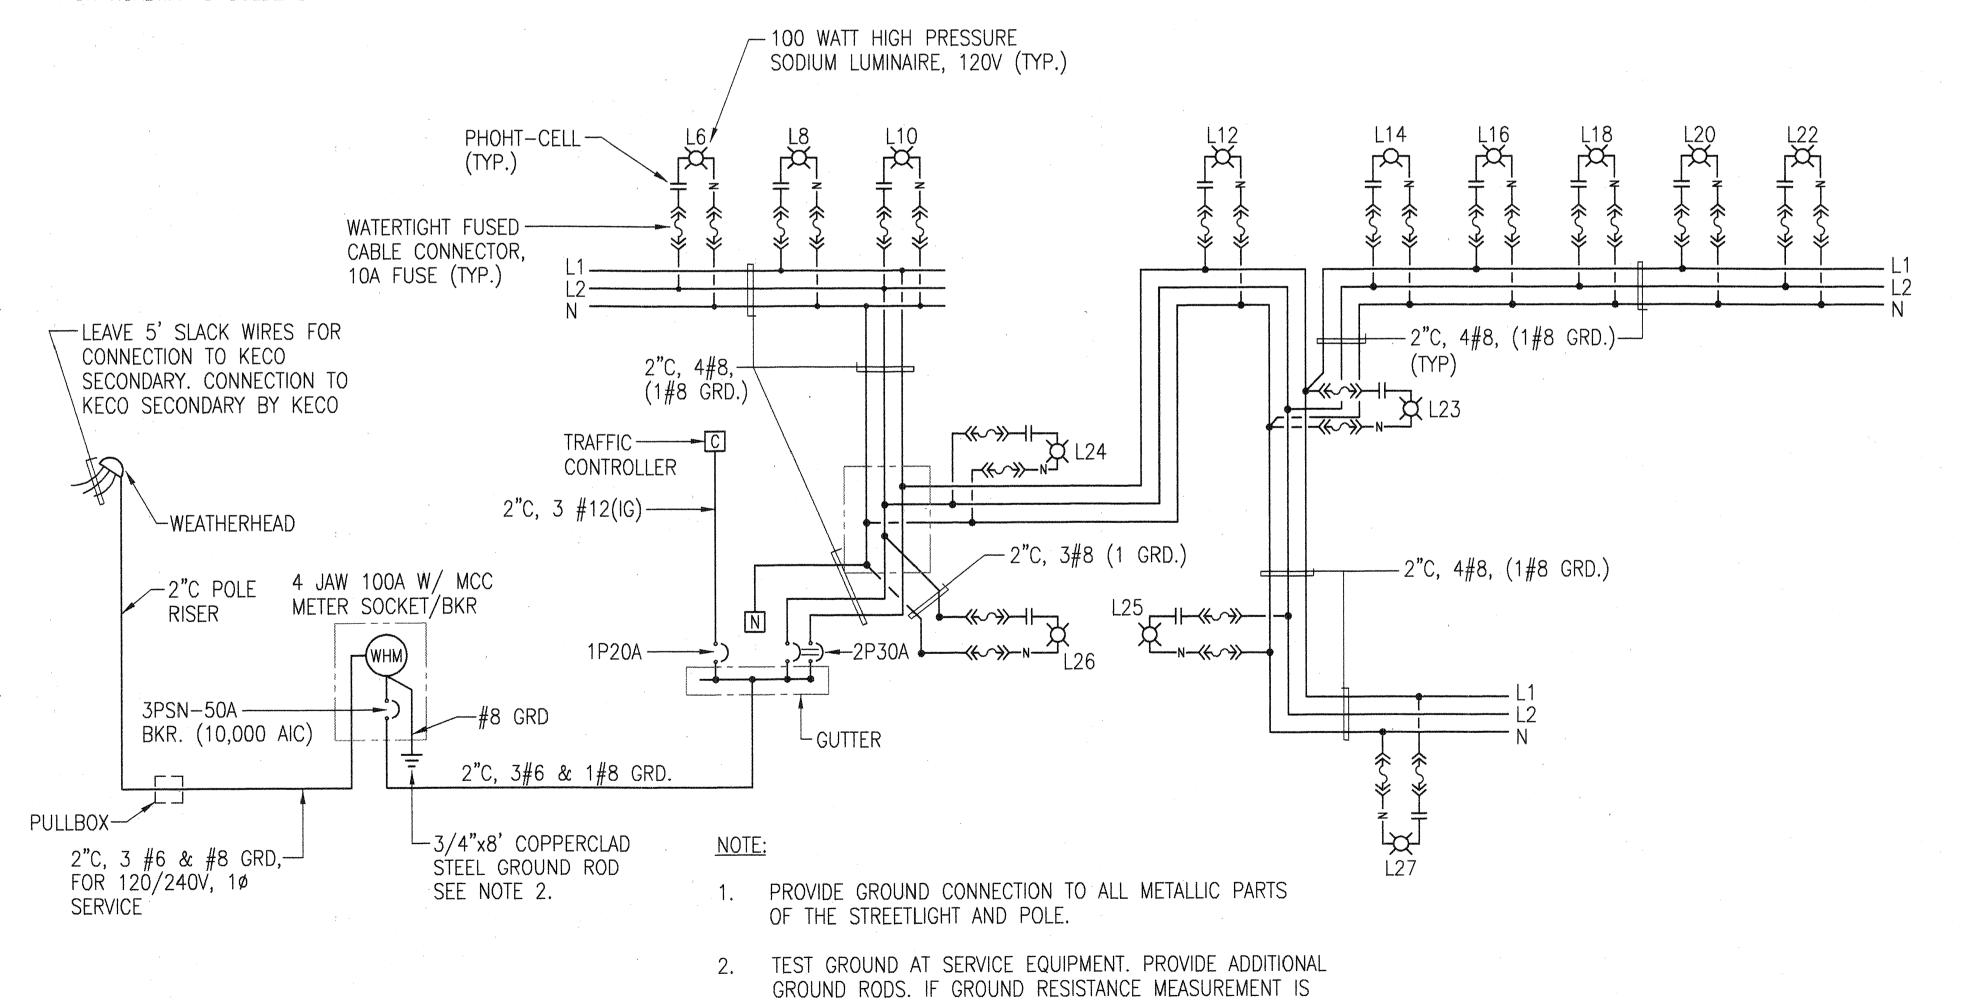


MORE THAN 25 OHMS TO GROUND.

NOT TO SCALE

SINGLE LINE DIAGRAM

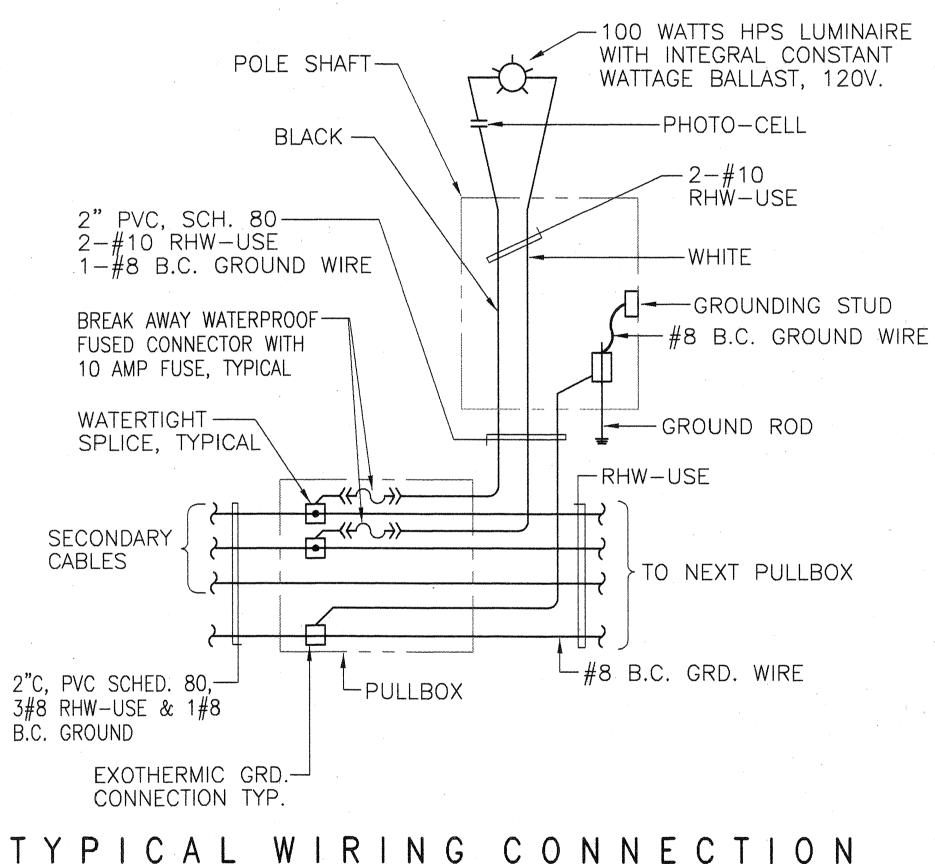

RING CONNECTION AGRAM FOR HIGHWAY LIGHT NOT TO SCALE

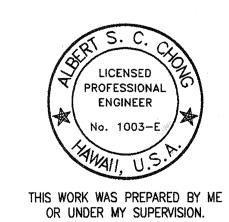

STATE OF HAWAII DEPARTMENT OF TRANSPORTATION HIGHWAYS DIVISION

WIRING DIAGRAMS

KAUMUALII HIGHWAY, KUHIO HIGHWAY & RICE STREET INTERSECTION IMPROVEMENTS PROJECT NO. 50E-01-98

acourt a Chong

SCALE: AS NOTED

DATE: SHEET No. 3 OF 7 SHEETS

ATE ::


TOTAL SHEETS


1998

50

HIGHWAY LIGHTING NOTES:


- 1. ALL STEEL SHAFTS, PLATES, MAST ARMS, BOLTS, SCREWS, NUTS AND WASHERS TO BE GALV. AFTER FABRICATION OR MODIFICATION.
- 2. 4" X 6 1/2" HANDHOLE REINFORCED W/#3 GA. RING 1 1/2" WIDE WELDED TO OUTSIDE OF POLE COVER OF 10 GA. PLATE LOCATE 90 DEGREES OF MAST ARM UNLESS SHOWN OTHERWISE.
- 3. ROUND TAPERED STEEL TUBE W/MAX. TAPER OF 0.15"/FOOT.
- 4. NO. 11 GAGE SHEET STEEL OF WELDABLE GRADE ACCEPTABLE IF STEEL AFTER FABRICATION HAS A MIN. YIELD STRENGTH OF 40,000 PSI.
- 5. THE COST FOR CABLES AND EXCAVATING & BACKFILLING THE CONDUIT TRENCH SHALL BE INCIDENTAL TO THE CONDUITS.

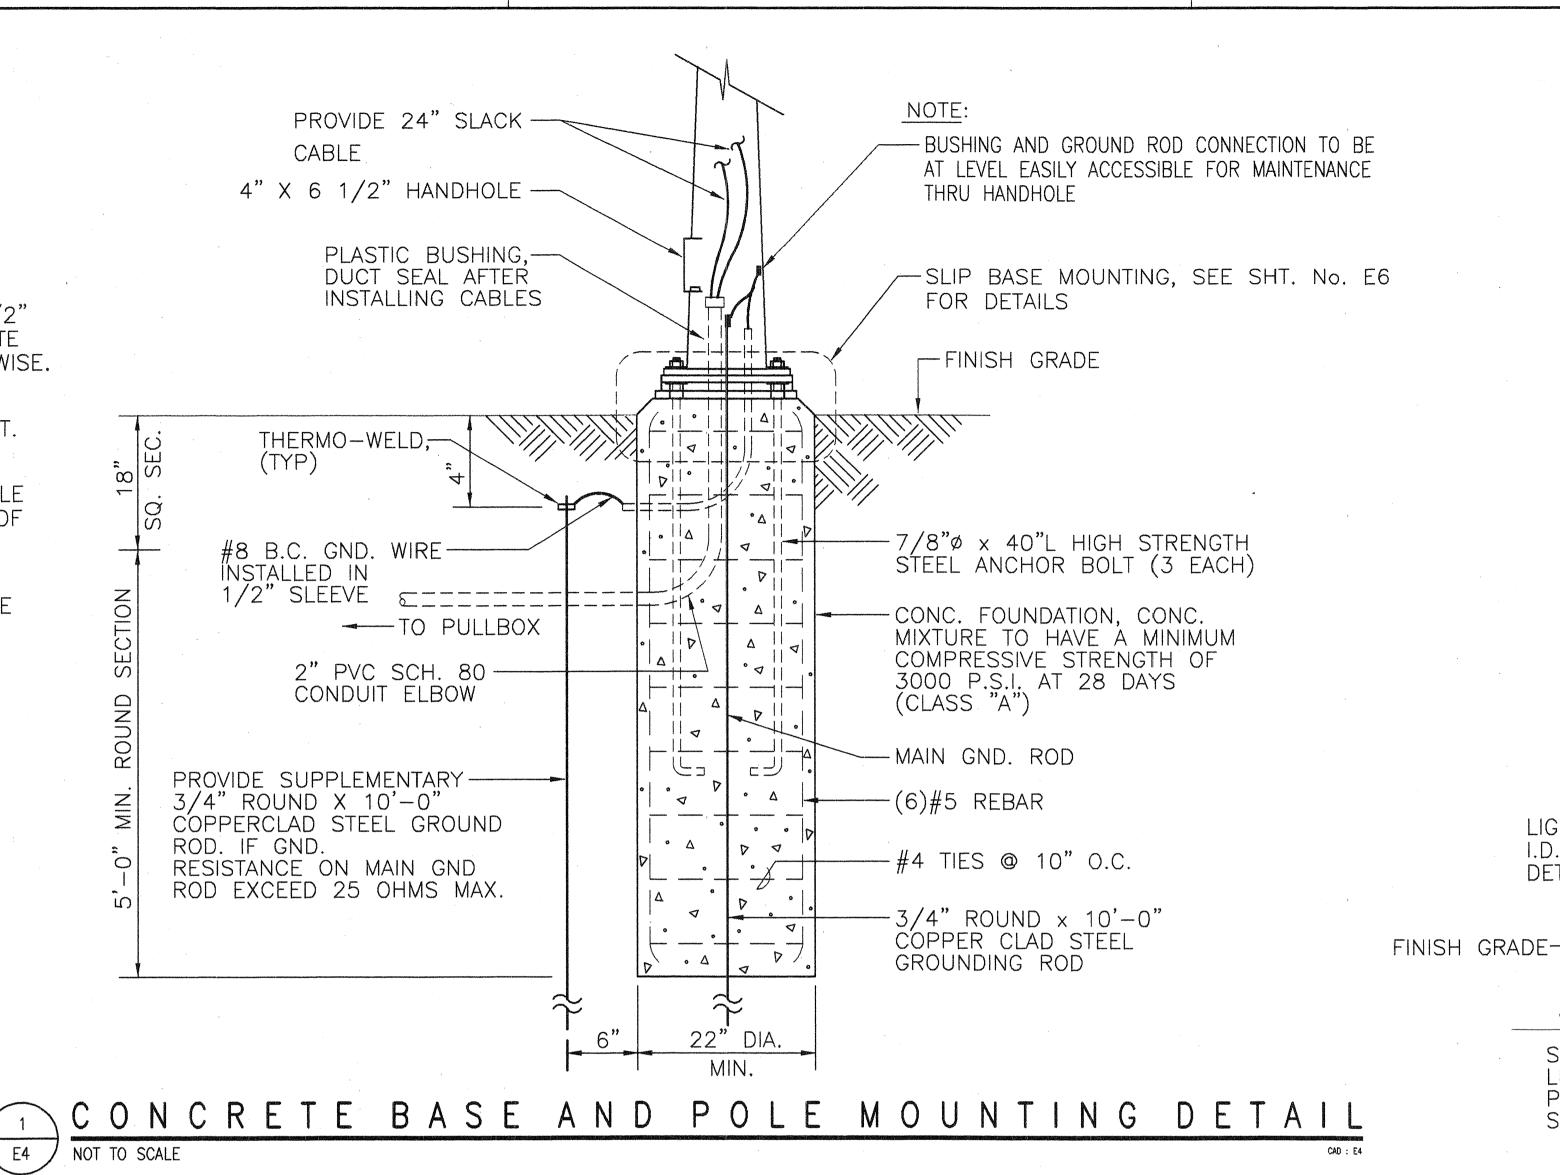

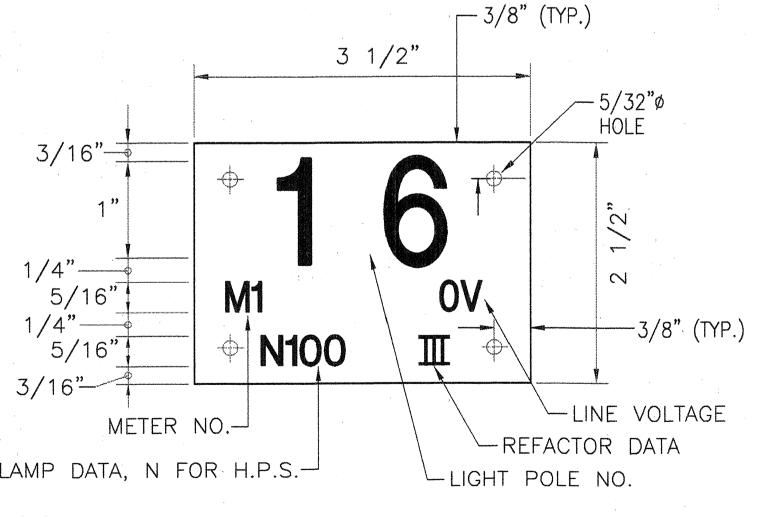

NOTES:

- 1. USE 3 PLY LAMINATED FLEXIBLE PLASTIC BLACK-WHITE-BLACK THICKNESS: BLACK CAP SHEET-0.010", WHITE BASE SHEET-0.052", BLACK BASE SHEET-0.010".
- 2. LIGHT POLE NUMBER SIZE SHALL BE 1" HIGH AND ENGRAVED 1/8" WIDE, WHITE IN COLOR (NUMBER AS REQUIRED).
- 3. NOMENCLATURE SIZE SHALL BE 5/16" HIGH AND EXGRAVED 1/32" WIDE, WHITE IN COLOR (METER NUMBER, CIRCUIT NUMBER, LINE VOLTAGE, LAMP DATA AND REFACTOR DATA AS REQUIRED).
- 4. ATTACH TO ALUMINUM AND STEEL POLES WITH NO. 8 STAINLESS STEEL, 1/2" LONG DRIVE SCREWS IN 1/8" DRILL HOLE. ATTACH TO WOOD POLES WITH 4D ÁLIMINUM NAILS.
- 5. NUMBERS ARE INSCRIBED BY CUTTING THROUGH "BLACK CAP SHEET" TO EXPOSE "WHITE LETTERS".

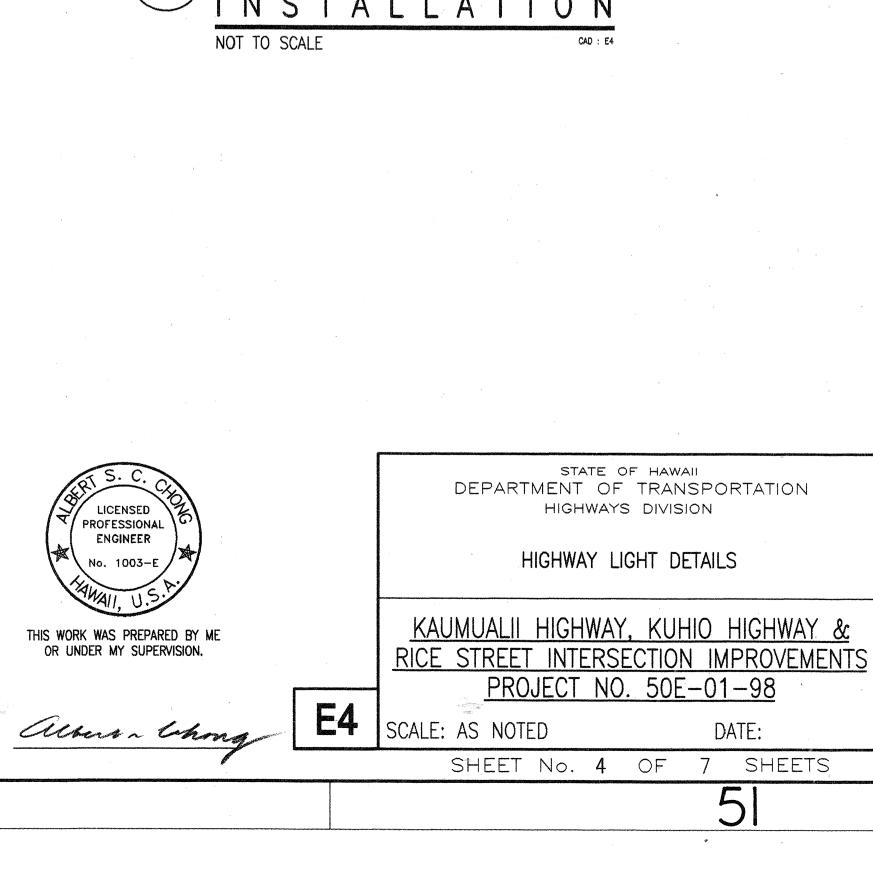

FED. ROAD DIST. NO.

STATE

12'-0" BRACKET ARM

GALVANIZED STEEL

BRACKET ARM

CONTINUOUS TAPER ROUND GALVANIZED STEEL POLE

SHOULDER

WIDTH

VARIES

STANDARD

- CONCRETE BASE

SEE

-¢ OF POLE

UNLESS OTHERWISE NOTED

RAINTIGHT

METAL CAP

LIGHT STANDARD -

I.D. TAG, SEE

STREET-

LIGHTING

PULLBOX SEE 1

E4

HANDHOLE-

O

DET.

PROJECT NO.

50E-01-98

100 WATTS HPS LUMINAIRE FISCAL SHEET YEAR NO.

1998 51

--PHOTO--CELL

30'-0", MOUNTING HEIGHT


EDGE OF

ROADWAY

ROADWAY


TOTAL SHEETS




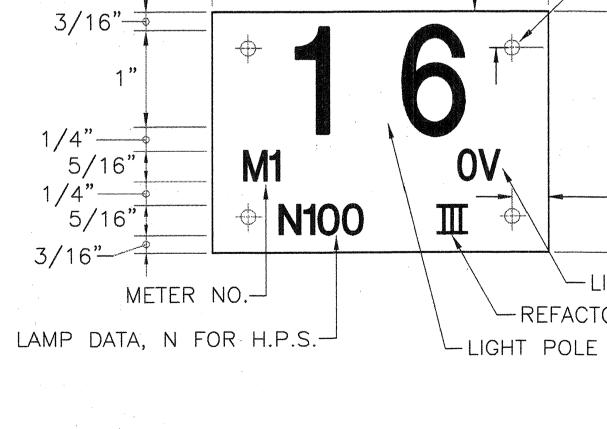


ATE

THIS WORK WAS PREPARED BY ME OR UNDER MY SUPERVISION.

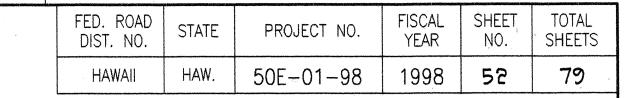

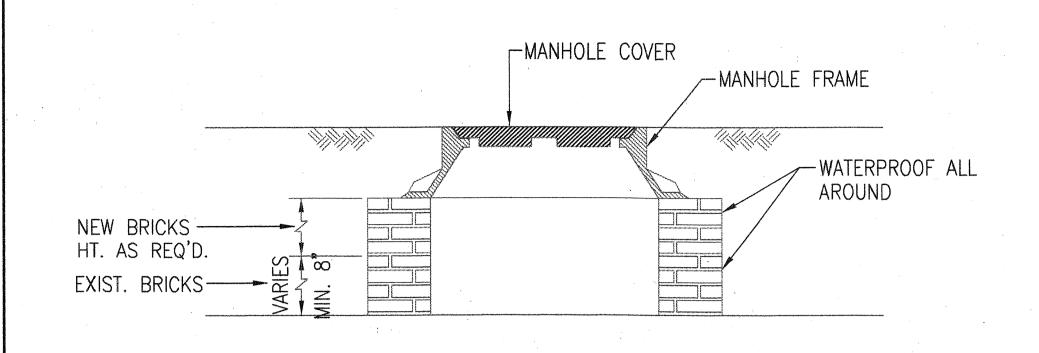

MANHOLE COVER SECTION NOT TO SCALE

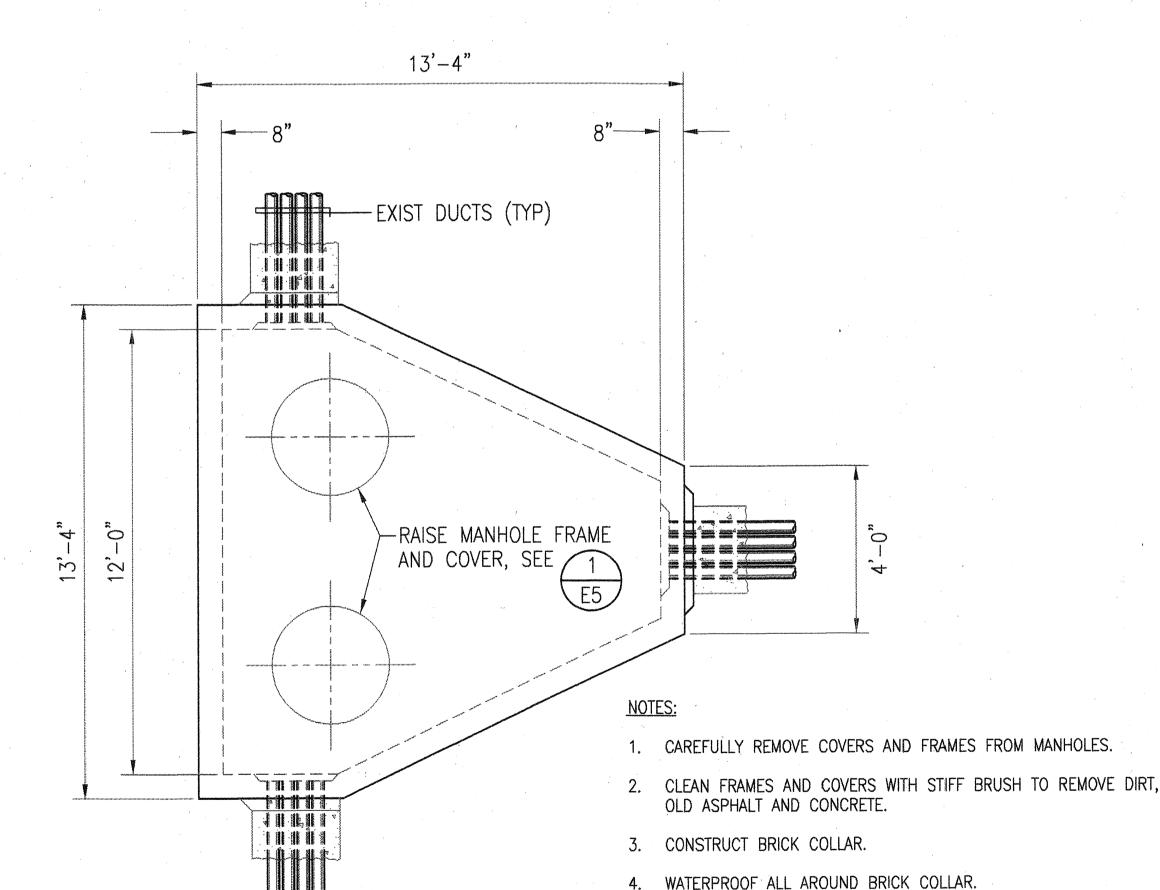

EXIST. TELEPHONE MANHOLE

5. SUPPLY BEADS OF ADHESIVE TO TOP OF COLLAR.

7. PATCH WITH ASPHALT OR CONCRETE AS REQUIRED AROUND THE

8. ALL WORK SHALL BE DONE IN THE PRESENCE OF GTE FIELD INSPECTOR. COORDINATE WITH GTE.

ATE ...

NOT TO SCALE

- FIBERGLASS-REINFORCED ENCLOSURE, NEMA 4X WITH DOOR, SEE NOTE 7 PLUG 3" PIPE WITH --CIRCUIT BREAKER METER SOCKET/MAIN BKR. NEMA 1, SEALABLE, STAINLESS 1/4" PLATE (TYP.) 9" x 5 1/2" ACRYLIC— -7" MIN. STEEL ENCLOSURE WINDOW & STAINLESS STEEL FRAME. SEE NOTES 6 AND 7 3/16" (TYP.) -4" x 4" x 18" GUTTER 6" MIN.-5'-6" NOMINAL MIN. TO 6'-0" MAX. -2 1/2" x 2 1/4" x 1/4" \angle ------3"ø PIPE GALV. STEEL. (TYP.) PROVIDE WEATHERPROOF WELDED TO PIPE. (TYP.) SEALANT AROUND CONDUIT - 3"ø PIPE GALV. STEEL. (TYP.) PENETRATIONS (TYP.) -10"W x 12"H x 6"D SPLICE CAN, STAINLESS PULLBOX — 2" GALV. STEEL CONDUIT STEEL, NEMA 3R 3/4"C, & #8 GRD.-—6" MIN. -CONC. BASE, 3000 PSI FINISH GRADE FINISH GRADE-@ 28 DAYS THERMOWELD-3/4"ø x 8' LONG COPPERCLAD — STEEL GROUND ROD — 6" MIN. -6" MIN. TO KECO SERVICE-LTO STREET TO TRAFFIC 3" MIN. 2"C, PVC SCHED. 80, CONTROLLER LT. PB 90° BEND, 3' RADIUS


FRONT ELEVATION

NOTES:

SECTION 'A-A'

- 1. ALL CONDUITS TO CONTAIN A POLYOLEFIN PULL LINE. (JET LINE CAT. #232 OR EQUIV.)
- 2. PEDESTAL SHALL BE HOT-DIPPED GALVANIZED AFTER FABRICATION.
- 3. ALL FASTENING BOLTS, NUTS & WASHERS SHALL BE STAINLESS STEEL PROVIDE ONE COAT SHOP PRIMER & TWO COATS OF ACRYLIC ENAMEL FINISH. COLOR TO MATCH CONTROLLER CABINET.
- 4. PROVIDE MINIMUM 4 FT. CLEARANCE IN FRINT OF METER.
- 5. * INDICATES SEALABLE ENCLOSURE.
- 6. WINDOW LOCATION TO CORRESPOND WITH METER LOCATION.
- 7. HOFFMAN ENGINEERING OR APPROVED EQUAL. COLOR TO MATCH CONTROLLER. ENCLOSURE: A-48H3620GQRLP INTERIOR PANEL: A-48P36 STAINLESS STEEL WINDOW KIT: A-PWK95NFSS CONTRACTOR SHALL ENSURE THAT SERVICE EQUIPMENT BEING PROVIDED SHALL FIT WITHIN ENCLOSURE.

ELECTRICAL SERVICE DETAIL

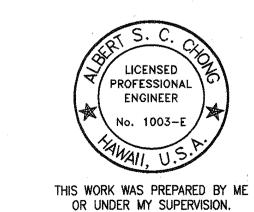

STATE OF HAWAII DEPARTMENT OF TRANSPORTATION HIGHWAYS DIVISION

MISCELLANEOUS DETAILS

KAUMUALII HIGHWAY, KUHIO HIGHWAY & RICE STREET INTERSECTION IMPROVEMENTS PROJECT NO. 50E-01-98

Current a Chong

SCALE: AS NOTED

DATE:

SHEET No. 5 OF 7 SHEETS

52

