


E-6

E-6

TYPICAL ROADWAY DUCT SECTION (CONCRETE ENCASED)

NOTES:

- 1. Electrical and Telephone Ducts Similar.
- 2. Provide 2" Separation Between Ducts of Same System and 3" Between Ducts of Different Systems.
- 3. See Duct Section Details for Conduit Arrangement.
- 4. Warning Tapes, Duct Spacers and Miscellaneous Items are Incidental Costs.

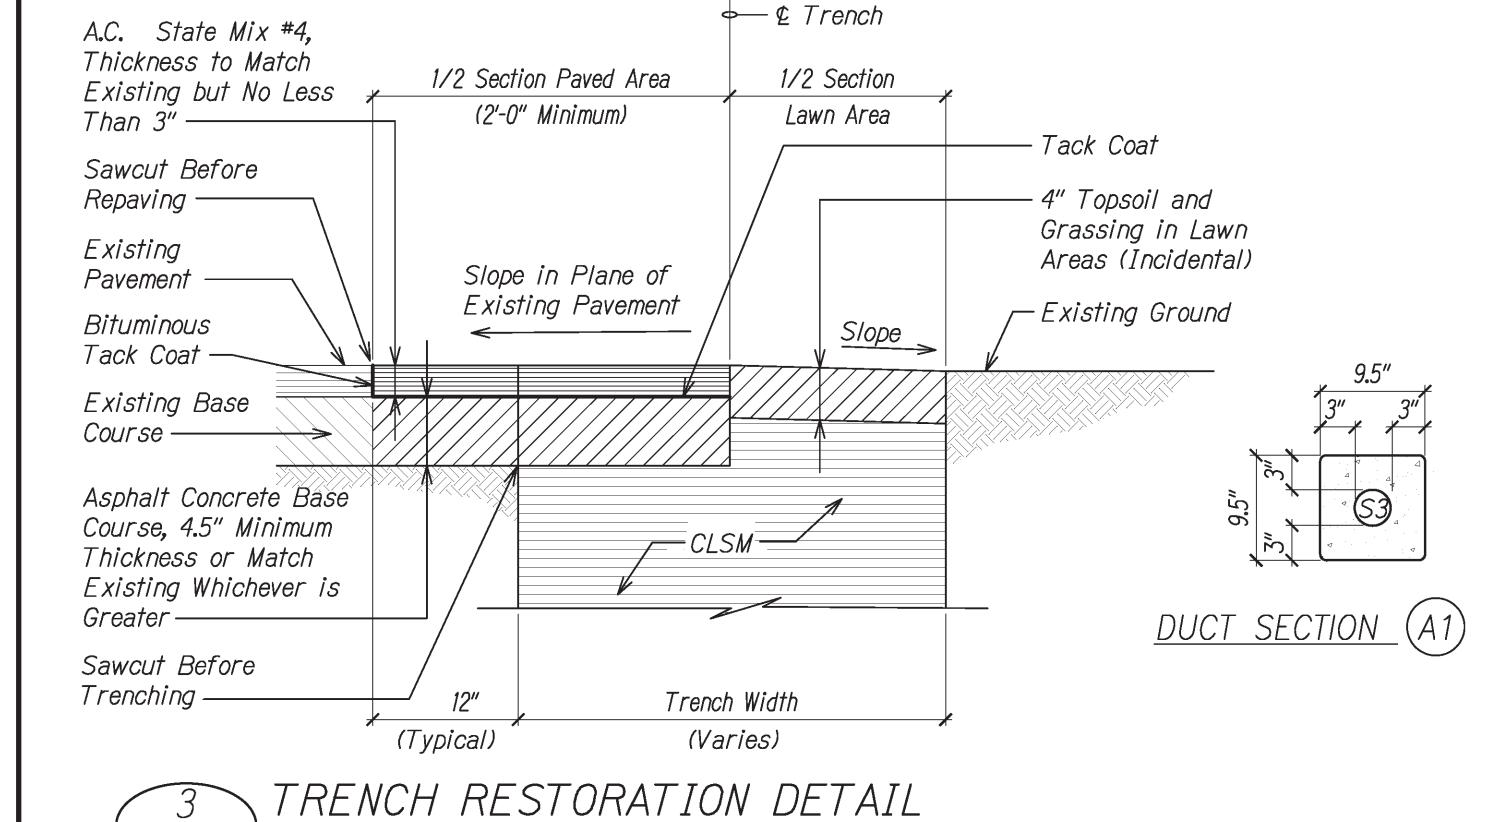


1. Any Part of the Trench Excavated Below the Established


Refilled and Compacted with Select Material, or Paved

with AC by the Contractor at His Expense.

Grade or Beyond the Maximum Permitted Width Shall be

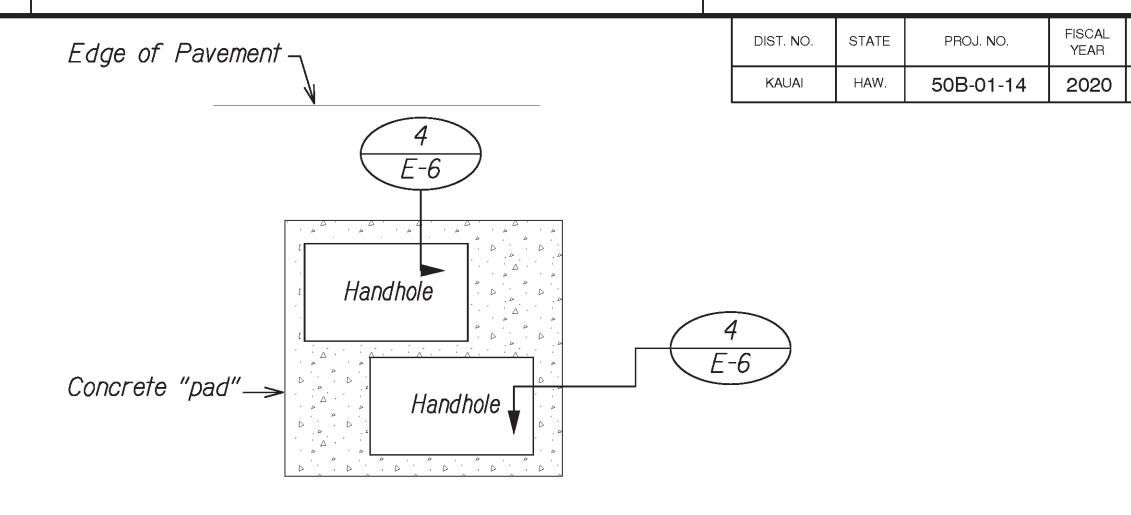



TYPICAL HANDHOLE GROUP PLAN E-6

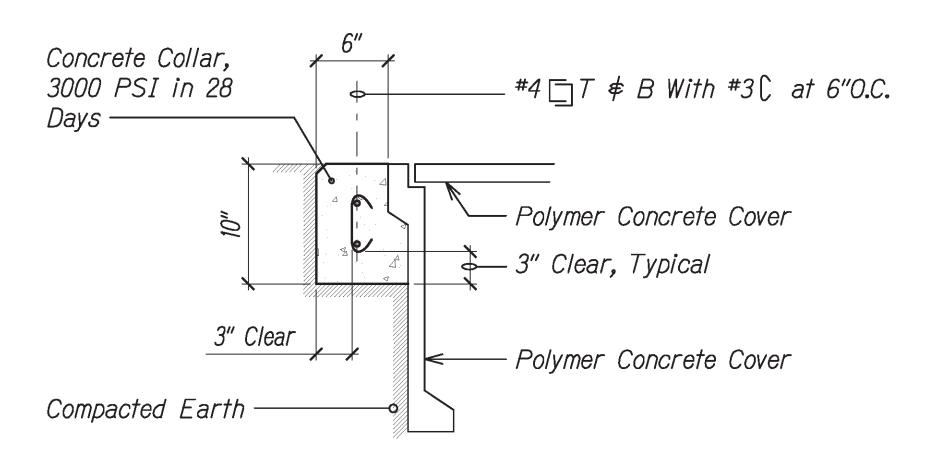





1. Provide Concrete Collar Around All New Handholes.

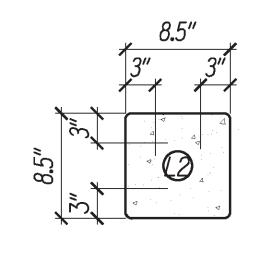

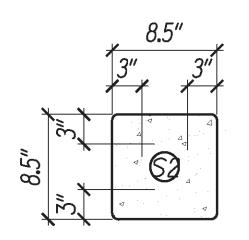

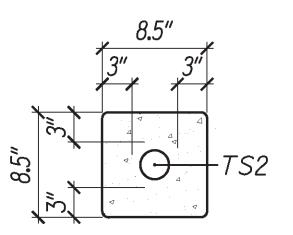

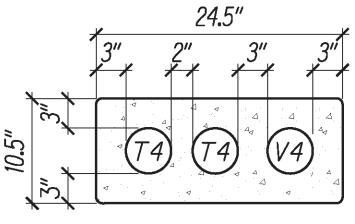

TOTAL SHEETS

SHEET NO.

39




DUCT SECTION (A3)

DUCT SECTION (A4)

DUCT SECTION (C)


DUCT SECTION LEGEND

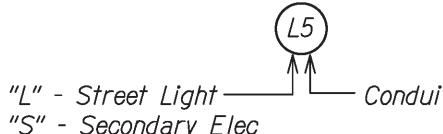

- Conduit Size

"S" - Secondary Elec "T" - Telephone "TS" - Traffic Signal

"V" - CATV

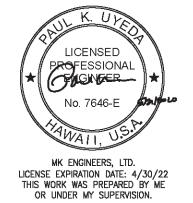


STATE OF HAWAI'I
DEPARTMENT OF TRANSPORTATION HIGHWAYS DIVISION

ELECTRICAL DETAILS - 1

Kaumualii Highway Intersection Improvements at Waimea Canyon Drive and Menehune Road/Halepule Road Project No. 50B-01-14

Scale: As Shown

Date: May 2020 SHEET No. E-6 OF 11 SHEETS

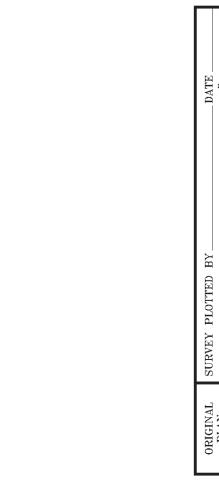

DIST. NO.	STATE	PROJ. NO.	FISCAL YEAR	SHEET NO.	TOTAL SHEETS
KAUAI	HAW.	50B-01-14	2020	40	44

NOTES:


- 1. Handhole Designed in Accordance with KIUC Standards Using 4,000 PSI Compressive Strength Concrete and 60,000 PSI Yield Strength ASTM A-615 Steel Reinforcement per Calcs.
- 2. All Concrete and Reinforced Concrete Work Shall be Done in Accordance with Applicable Provisions of the American Concrete Institute's Building Code Requirements for Reinforced Concrete (ACI 318-87).
- 3. Handhole to be Placed on a 6" Base on Firm/Compacted Backfill or on Undisturbed Soil.
- 4. Product to be Stenciled: Walker Industries Date of Pour Product Mark No.
- 5. Provide Endbells for All Conduit Entries.

ORDERING INFORMATION:


2' x 4' x 34" KIUC for Assembly as Shown. Approved for KIUC Specs. Total Weight of Assembly Shown is 1230#.

THE FOLLOWING MATERIALS TO BE SHIPPED WITH EACH HANDHOLE:

- (1) Top Section. Wt. 400#.
- (2) Bottom Section with Knockouts. Wt. 430#.
- (3) 1/2" Dia. x 4" Lifting Hole (Contr. to Grout Solid After Placement of Section).
- 4 Conduit Opening Knockout.
- 5 Concrete Cover, Refer to HECo Dwg. No. 11312.

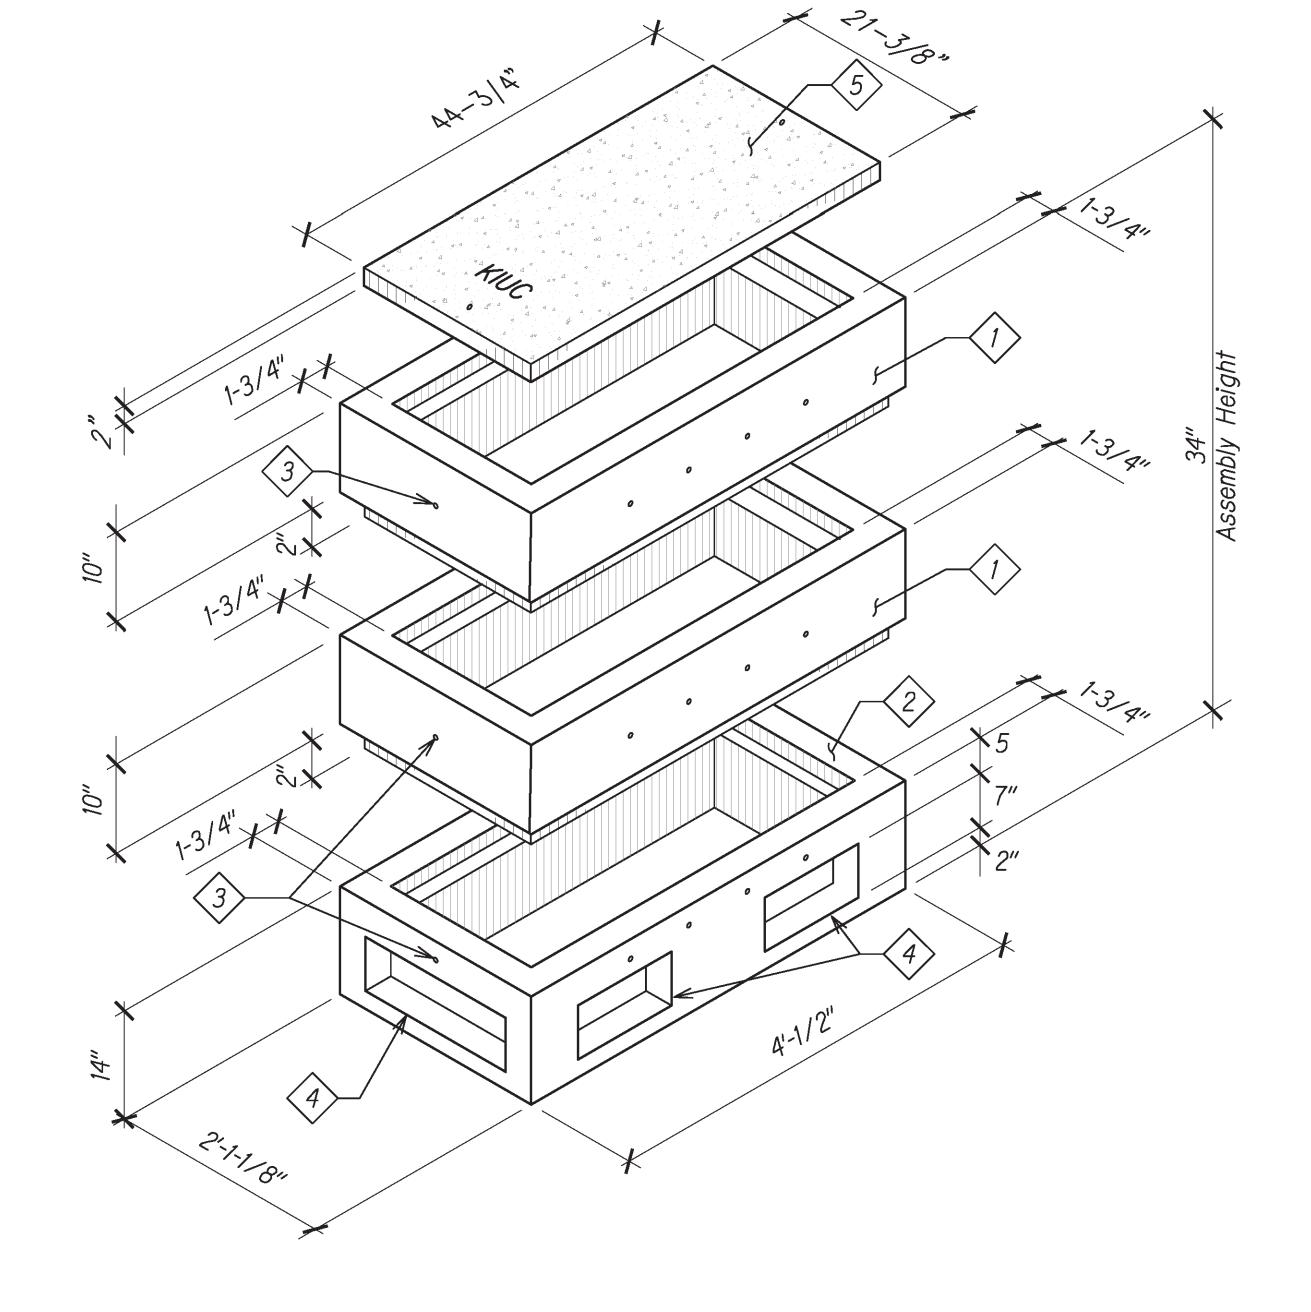



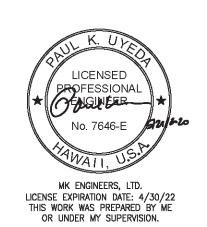

STATE OF HAWAI'I DEPARTMENT OF TRANSPORTATION


ELECTRICAL DETAILS - 2

Kaumualii Highway Intersection Improvements at Waimea Canyon Drive and Menehune Road/Halepule Road

Project No. 50B-01-14

Scale: As Shown

Date: May 2020 SHEET No. E-7 OF 11 SHEETS

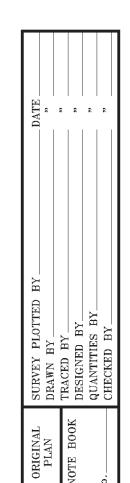

-Cover Logo: "CATV" - Cable Television (102) 3/8 - 16 UNC, 4-Inch Stainless Steel Hex Head Bolt With Washer (2) — 00 Polymer Concrete Cover * -1/2" x 4" TOP VIEW With 0.5 COF Skid Lift Slots (2) Resistant Surface 26" Polymer Concrete Box -SIDE VIEW PULLBOX INSTALLATION, **TYPICAL**

Lifting Bolt (4)



NOTES:

- 1. All Conduits Shall Enter Horizontally at the Bottom of the Pullboxes, Provide Endbells.
- 2. All Dimensions and Lines are Approximate.
- 3. Field Adjust Pullbox Locations and Conduit Clearances as Required.
- 4. Pullbox Covers Shall be Labeled "CATV".
- 5. Install 5/8" x 8'-0" Copper Clad Ground Rods in Each Pullbox.
- 6. Pullboxes will be Quazite Type, Tier 22 Rating, Part #PG 2436BA18 or Equal.
- 7. Pullbox Covers will be Quazite Type, Tier 22 Rating, Part #PG2436BAHH0017P or Equal.
- 8. Pullbox Specifications:
 - Heavy Duty With Open Bottom, Polymer Concrete
 - Design: 22,500 Lbs.
 - Test Loading: 33,750 Lbs.
 - UL Listed, ANSI/SCTE 77, ANSI Tier 22
- 9. Pullbox Cover Specifications:
 - Heavy Duty With 2 Hex Head Bolts, Polymer Concrete
 - Design: 22,500 Lbs.
 - Test Loading: 33,750 Lbs.
 - UL Listed, ANSI/SCTE 77, ANSI Tier 22

MK ENGINEERS, LTD.
LICENSE EXPIRATION DATE: 4/30/22
THIS WORK WAS PREPARED BY ME
OR UNDER MY SUPERVISION.

STATE OF HAWAI'I DEPARTMENT OF TRANSPORTATION HIGHWAYS DIVISION


ELECTRICAL DETAILS - 3

Kaumualii Highway Intersection Improvements at Waimea Canyon Drive and Menehune Road/Halepule Road


Project No. 50B-01-14

Scale: As Shown

Date: May 2020 SHEET No. E-8 OF 11 SHEETS

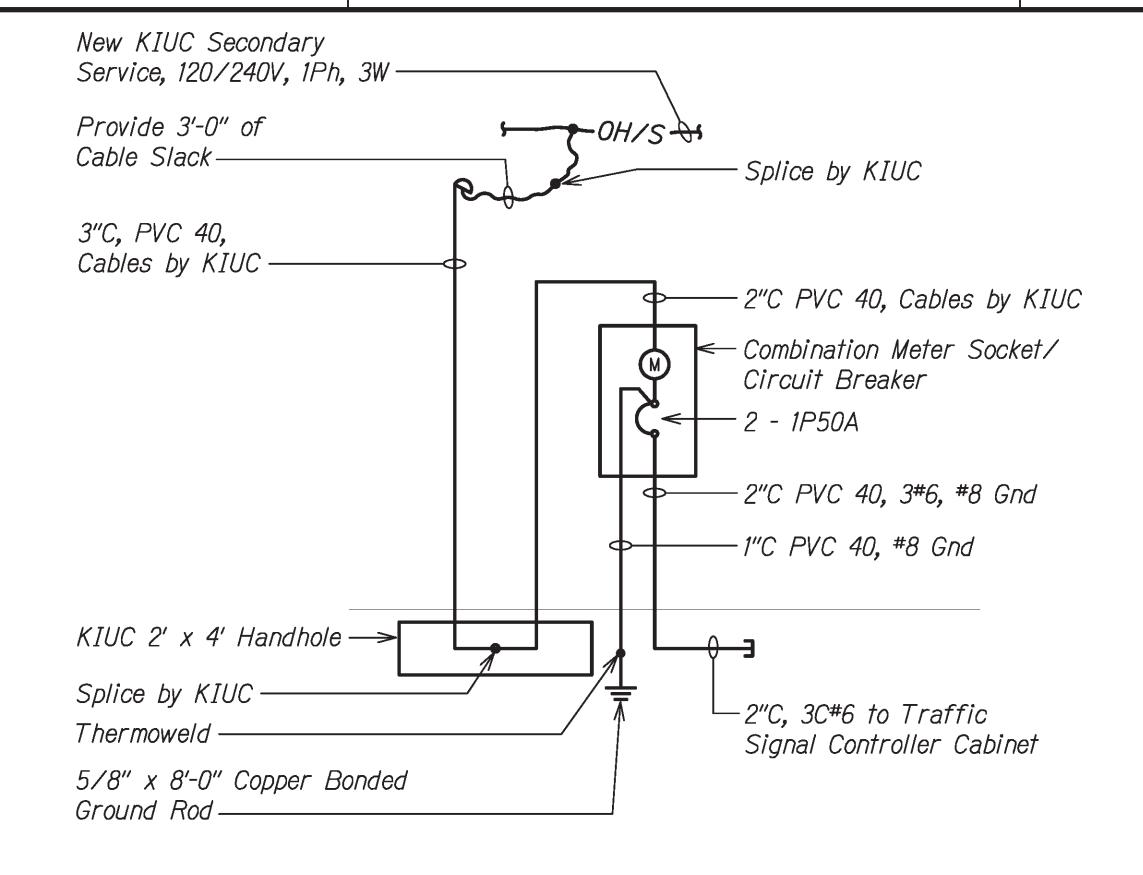


ONE-LINE DIAGRAM (TRAFFIC SIGNAL SYSTEM) E-9 NTS

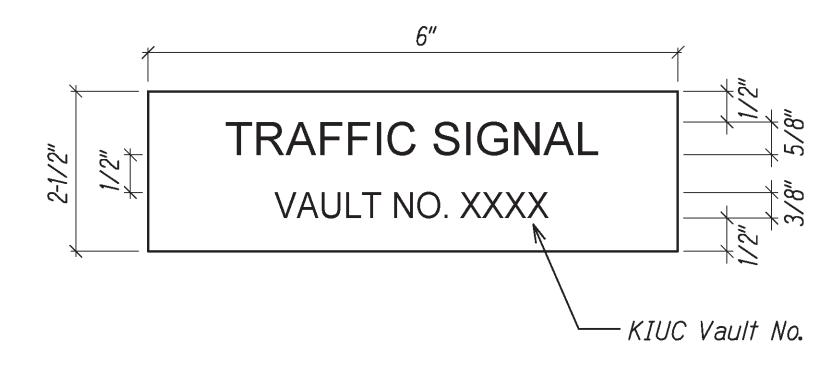



NOTES:

- 1. Use 3-Ply Laminated Flexible Plastic, Black-White-Black Tickness: Black Cap Sheet - 0.010", White Base Sheet -0.052", Black Base Sheet - 0.010".
- 2. Attach to Meter Box Using Scotch 3M Brand Very High Bond (VHB) Double Coated Acrylic Foam Tape or Equivalent.
- 3. Letters/Numbers Shall be 1/16" Stroke, (White in Color).
- 4. Leters/Numbers Shall be Inscribed by Cutting Through "Black Cap Sheet" to Expose White Letters/Numbers.

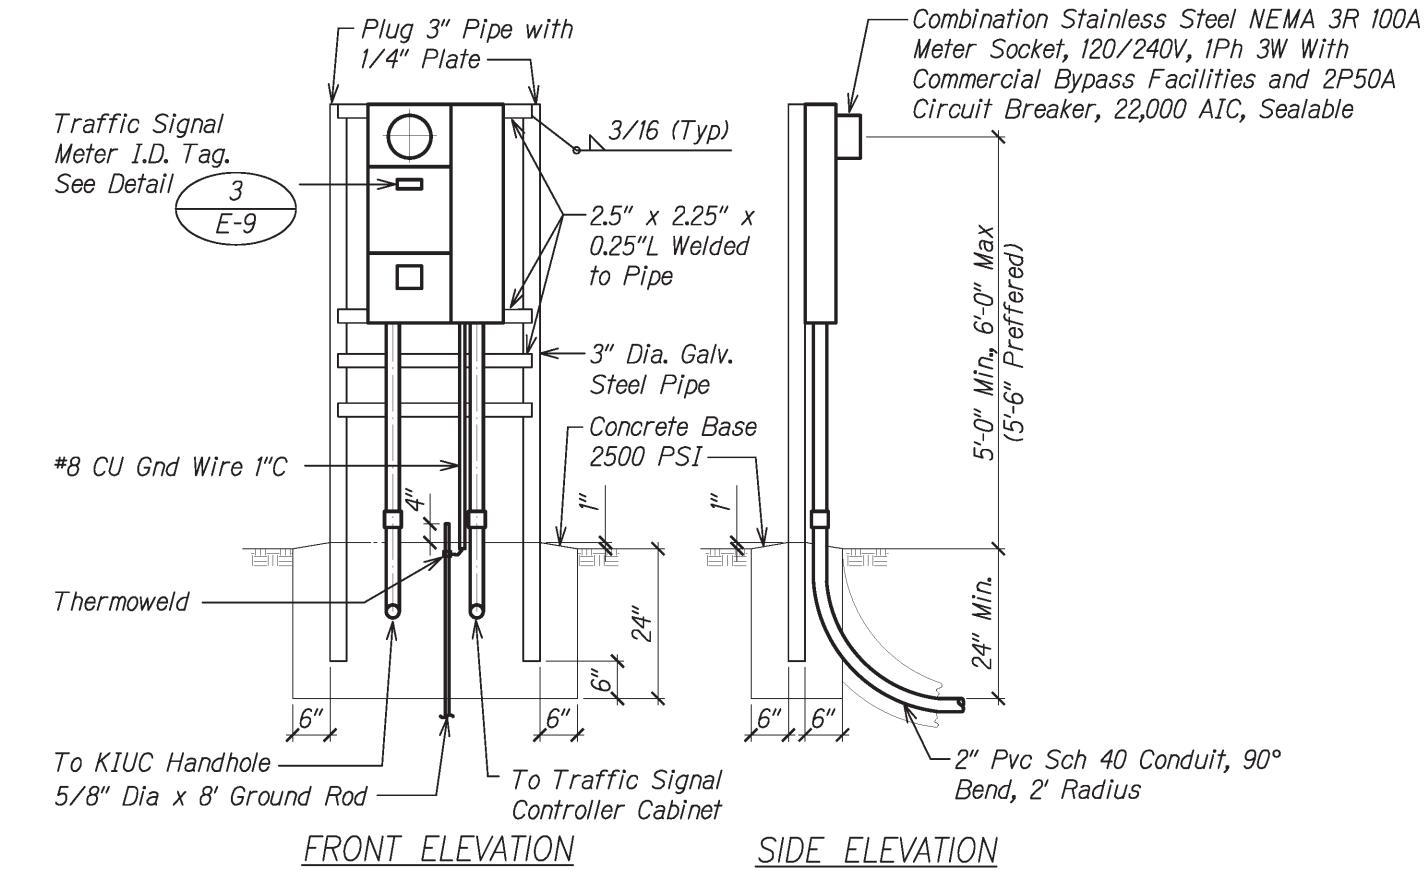

METER PEDESTAL FOR TRAFFIC SIGNAL METER

NOTES:

- 1. Pedestal Shall be New Hot Dipped Galvanized After Fabrication.
- 2. All Fastening Bolts, Nuts, and Washers Shall be New Stainless Steel. All Hardware Shall be Brass, Bronze, or Stainless Steel.
- 3. Service Equipment Shall be Installed in Accordance with KIUC Requirements.
- 4. Provide a Minimum of 4 Feet of Clear and Level Workspace Clearance in Front of Metering and Service Equipment.
- 5. Provide Plastic Meter Socket Cover and Band for All Blank Meter Sockets. Label Plastic Cover with Contractor's Name and Number so Cover can be Returned After Meter Installation.
- 6. Provide a Permanent Phenolic Nameplate (Black with White Letters) for all Meter Sockets to Identify the Address, Unit, Space, Area or Load Served (e.g. "Parking Lot").
- 7. The Grounding Electrode Conductor Shall Not Pass Through KIUC's Sealable Sections or Compartments.
- 8. KIUC Service Conductors Shall be Separated by Suitable Barriers from the Customer's Load Conductors. Also, the Customer's Load Conductors Shall Not Pass Through KIUC's Sealable Sections or Compartments.



STATE OF HAWAI'I DEPARTMENT OF TRANSPORTATION


ELECTRICAL DETAILS - 4


Kaumualii Highway Intersection Improvements at Waimea Canyon Drive and Menehune Road/Halepule Road Project No. 50B-01-14

Scale: As Shown

Date: May 2020

SHEET No. E-9 OF 11 SHEETS

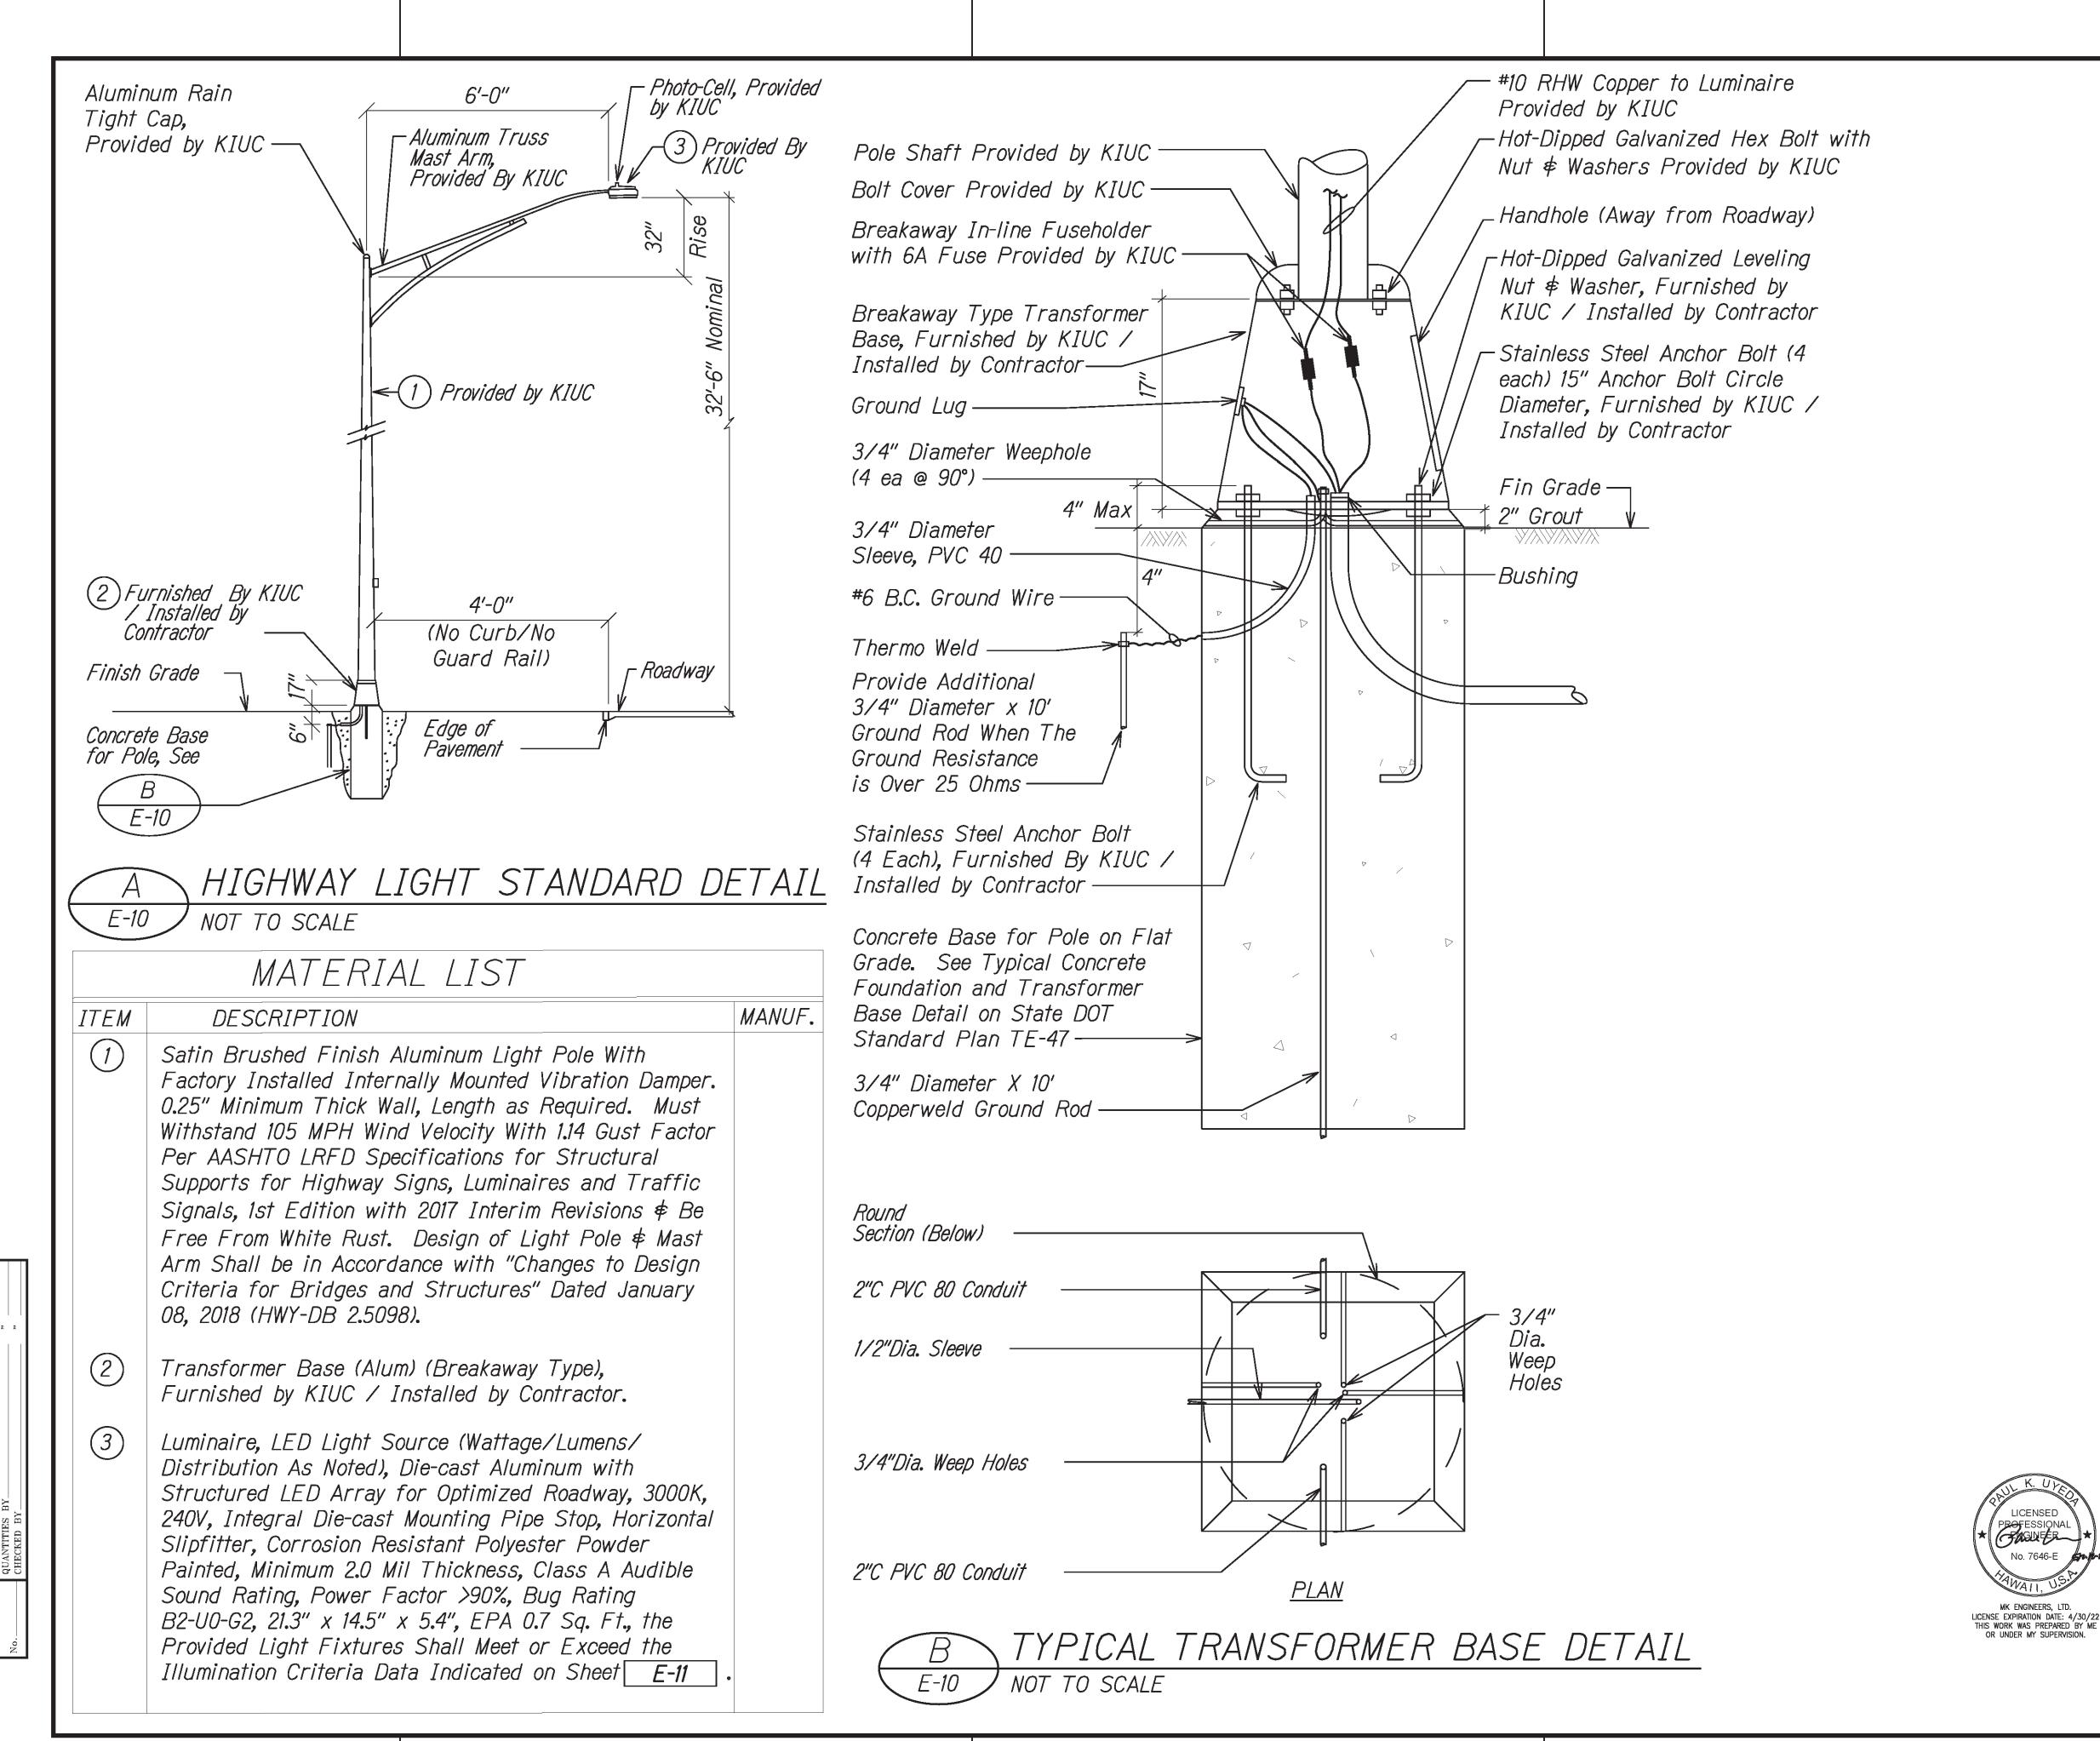

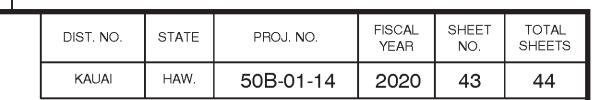

LICENSED

STATE OF HAWAI'I **DEPARTMENT OF TRANSPORTATION**

ELECTRICAL DETAILS - 5

Kaumualii Highway Intersection Improvements at Waimea Canyon Drive and Menehune Road/Halepule Road Project No. 50B-01-14

Scale: As Shown

Date: May 2020 SHEET No. *E-10* OF *11* SHEETS