FED. ROAD DIST. NO.	STATE	PROJ. NO.	FISCAL YEAR	SHEET NO.	TOTAL SHEETS
HAWAII	HAW.	HWY-K-01-03	2008	29	37

<u>INDEX TO STRUCTURAL DRAWINGS</u>									
SHEET NO.	<u>DESCRIPTION</u>								
S0.1	Index to Structural Drawings								
S0 <b>.</b> 2	General Notes								
<i>S0.3</i>	Symbols and Abbreviations								
<i>S0.4</i>	Typical Details								
S0 <b>.</b> 5	Typical Details								
<i>S1.1</i>	Typical Retaining Wall Section - Kaumualii Highway								
<i>S1.2</i>	Typical Shotcrete Section - Kaumualii Highway								
<i>S2.1</i>	Typical Retaining Wall Section - Kuhio Highway								
S3.1	Typical Retaining Wall Section - Kuamoo Road								
·									

LICENSED PROFESSIONAL ENGINEER NO. 8104-S NO. 8104-S SIGNATURE LIC. EXPIRATION

R. M. TOWILL CORPORATION

DEPARTMENT OF TRANSPORTATION
HIGHWAYS DIVISION

INDEX TO STRUCTURAL
DRAWINGS

Kaumualii Highway, Kuhio Highway
& Kuamoo Road Retaining Walls
Project No. HWY-K-01-03

Date: MAY 2008 Scale: AS NOTED

SHEET No. \$0.1 OF 9 SHEETS

RMTC JOB NO. : 1-20132-0E

General Specifications: Hawaii Department of Transportation, Standard Specifications for Road and Bridge Construction, 2005, together with Special Provisions prepared for this contract.

# 2. <u>Design Specifications:</u>

- (A) AASHTO LRFD Bridge Design Specifications (Fourth Edition, 2007) and modifications by the HDOT Highways Division.
- (B) HDOT Memorandum HWY-DB 2.6843 dated February 14, 2005 with subject title "Design Criteria for Bridges and Structures".

# 3. Loads:

(A) Seismic Loads: Acceleration coefficient - 0.09

## 4. <u>Materials:</u>

(A) All concrete strengths shall be as noted below:

<u>Item No.</u>	Structural Parts	Classes of Concrete	Compressive Strength <u>f'c (28 Days)</u>
(1)	Concrete Wall and Footing	-	4000 PSI
(2)	Cast-in-place Downturn	-	4000 PSI
(3)	Except as noted otherwise, all others	A	3000 PSI

- (B) The use of any calcium chloride in any concrete is prohibited.
- (C) All reinforcing steel shall be ASTM A 615, Grade 60 unless otherwise noted.
- (D) All anchor bolts, washers and nuts shall be ASTM A 193 (UNS S31600) stainless steel unless otherwise specified.
- (E) All dowels with non-shrink grout into existing wall shall be ASTM A 955 UNS 531603 Grade 60 deformed stainless steel reinforcement.

## 5. Reinforcement:

- (A) The covering measured from the surface of the concrete to the face of any reinforcing bar shall be as follows, except as otherwise noted.
- f (1) Concrete cast against earth = 3"
  - (2) All others unless otherwise noted = 2"
- (B) Reinforcing bars shall be detailed in accordance with the latest edition of the A.C.I. Detailing Manual unless otherwise noted.
- (C) Minimum clear spacing between parallel bars shall be 1 1/2 times the diameter of bars (for non-bundled bars). In no case shall the clear distance between the bars be less than 1 1/2 times the maximum size of the coarse aggregate or 1 1/2".
- (D) All dimensions relating to reinforcing bars are to centers of bars unless otherwise noted.
- (E) Reinforcing bars shall be securely tied at all intersections and lap splices except where the spacing of intersections is less than one foot in each direction, in which case alternate intersections shall be tied.

#### 6. Retaining Wall Notes:

- (A) All work related to the retaining walls required for this project shall be performed in accordance with Standard Specification Section 503 Concrete Structures. Precast walls will not be permitted.
- (B) The Contractor shall provide and maintain a stable slope above and below the retaining walls.

#### 7. Construction Notes:

- (A) The Contractor shall verify all dimensions and site conditions and shall report any discrepancies in writing to the Engineer before commencing work or ordering materials.
- (B) The Contractor shall verify all site conditions and not rely upon these plans for existing elevations and azimuths, roads, roadway gutters, curbs and sidewalks, etc. Conditions may differ from those shown.
- (C) The Contractor shall be solely responsible for the protection of adjacent properties, utilities and existing and new structures from damage due to construction. Repairing any damage shall be at the Contractor's own expense, to the satisfaction of the Engineer.
- (D) The Contractor shall verify the location of all utility lines and notify the respective owners before commencing with excavation, and any temporary piling or sheeting.
- (E) The Contractor shall be responsible for any relocation and/or temporary supports of power poles during construction.

  See Civil Plans for further requirements.
- (F) Except as otherwise noted, all vertical dimensions are measured plumb.
- (G) For concrete finish see Standard Specifications and Special Provisions.
- (H) Control joints may be a construction joints providing the details are same as for control joints.
- (I) Unless otherwise noted, all exposed concrete edges shall be chamfered 3/4" x 3/4".
- (J) All construction dust debris or other material not incorporated in the permanent work shall not be allowed to contaminate the project site and shall be removed from the project site at the Contractor's expense.

#### 8. Foundation:

(A) For boring logs and other geotechnical information, see "Geotechnical Investigation" by URS Corporation.

6/13/08 / Revised Note

DATE REVISION

LICENSED
PROFESSIONAL
ENGINEER

NO. 8104—S

THIS WORK WAS PREPARED BY ME OR UNDER MY
SUPERVISION AND CONSTRUCTION OF THIS PROJECT
WILL BE UNDER MY OSSERVATION. "OBSERVATION OF
CONSTRUCTION" IS DEFINED IN CHAPTER 16–115, HAWAII
ADMINISTRATIVE RULES, ENTITLED "PROFESSIONAL ENGINEERS,
ARCHITECTS." SURVEYORS AND LANDSCAPE ACHITECTS."

Signature LIC. EXPIRATION

R. M. TOWILL CORPORATION

DEPARTMENT OF TRANSPORTATION

GENERAL NOTES


<u>Kaumualii Highway, Kuhio Highway</u> <u>& Kuamoo Road Retaining Walls</u> <u>Project No. HWY-K-01-03</u>

Scale: AS NOTED

SHEET No. \$0.2 OF 9 SHEETS

ADD. 30

Date: MAY 2008

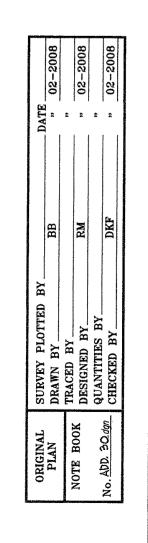


RMTC JOB NO. : 1-20132-0E


				SYMBOLS AND	<u>ABBREVIATIONS</u>				ROAD STATE PROJ. NO. FISCAL SHEET YEAR NO. S
<b>}</b>	And	Det.	Detail	Ga.	Gage, Gauge	NF	Near Face	НА	WAII HAW. HWY-K-01-03 2008 31
9	At .	Dia.	Diameter	Galv.	Galvanized	N	North		
ſ	Diameter	Dim.	Dimension	Gr.	Grade	NIC	Not in Contract	Std.	Standard
•	Number	Dist.	Distance	Grd.	Ground	No.	Number	Sta.	Station
		Dwls.	Dowels	GRP	Grouted Rubble	NTS	Not to Scale	Stirr.	Stirrup
Abbr.	Abbreviation	Dn.	Down		Pavement			Stl.	Steel
Add.	Additional, Added	Dbl.	Double			0/5	Offset	Str.	Straight
<i>\/t</i> .	Alternate	DI	Drain Inlet,	Ht.	Height	oc	On Center	Struct.	Structure
AB	Anchor Bolt		Ductile Iron	(H)	Hinge	Opn'g	Opening	Symm.	Symmetrical
AC .	Asphaltic Concrete	Dwg., Dwgs.	Drawing, Drawings	Horiz., H	Horizontal	0B	Outbound		
pprox.	Approximate			HDOT	State of Hawaii	OD	Outside Diameter	Temp.	Temporary
Z.	Azimuth	E	East		Department of	OG	Outside Girder,	Thk.	Thick
		EA, Ea., ea.	Each		Transportation		Outbound Girder	$\mathcal{T}$	Тор
3k.	Back	EF	Each Face	HS	High strength			<i>T</i> <b>₽</b> B	Top and Bottom
Bal.	Balance	EFH	Each Face Horizontal			Perf.	Perforated	TFE	Top of Footing Elevation
3	Baseline	EFV	Each Face Vertical	IB	Inbound	PL	Plate	Tot.	Total
3 <i>m</i> .	Beam	EP	Edge of Pavement	In.	Inch	PCF	Pounds per Cubic Foot	Transv.	Transverse
Bet.	Between	ES	Edge of Shoulder	ID	Inside Diameter	<i>PSF</i>	Pounds per Square Foot		Structural Tubing
3F	Both Faces,	EW	Each Way	IF	Inside Face	PSI	Pounds per Square Inch	. •	Typical
,,	Back Face	Elec.	Electrical	Int.	Interior	PLF	Pounds per Linear Foot	ryp.	rypicar
BW .	Both Ways	El., Elev.	Elevation	Inv.	Invert	Pt., Pts.	Point, Points	Undergrd.	Underground
BFE	Bottom of Footing	Eq.	Equal			PVC	Polyvinyl Chloride	Onder gra.	Orider ground
	Elevation	Est.	Estimated	Jt.	Joint	Prestr.	Prestressed	Vor	Varias
Bot., Bott., B	Bottom	Exc.	Excavation			7 7 0077 .	7 7 0077 00000	Var.	Varies Varies
3/†.	Bolt	Excl.	Excluding	K	Kips	Rad., R	Radius	Vert., V	Vertical
		Exist., Ex.	Existing	KF	Kip Foot	RF	Rear Face	VC	Vertical Curve
ant.	Cantilever	Exp., (E)	Expansion	KSF	Kips Per Square Foot	Rebar	Reinforcing Bar	W 40	
SIP .	Cast-in-Place	EJ	Expansion Joint	KSI	Kips Per Square Inch	Ref.	Reference	W/C	Water/Cement Ratio
· - ·	Centerline	Ext.	Exterior	KLF	Kips Per Linear Foot	Reinf.	Reinforced, Reinforcing,	W/	With
- SG	Center of Gravity		_,,,,,,,,,,,,,,,,,,,,,,,,,,,,,,,,,,,,,,			/\ <i>\\\</i>	Reinforcement	<i>W</i>	West
C	Center to Center	FF	Far Face. Front Face	L	Length	Req'd.	Required	WWF	Welded Wire Fabric
	Class	f'c	Specified Compressive	Ib., Ibs., LBS.	Pound, Pounds	Ret.	Retaining	WP	Work Point, Working Point
ir.	Clearance	. 0	Strength of Concrete	Ltg. Std.	Lighting Standard	Rt.	Right		
iol.	Column		at 28 days	LF, Lin. Ft.	Linear Feet/Foot	ROW	Right of Way	Yr.	Year
Conc.	Concrete	Ft.	Feet, Foot	LS	Lump Sum	Rdwy.	Roadway		
RM	Concrete Rubble	Fig.	Figure	Longit.	Longitudinal	Mawy.	Noadway		
. 1 (101	Masonry	Fin. Gr.	Finish Grade			Sect.	Section		
Conn.	Connection	(F)	Fixed	M	Modified				
Const.	Construction	FB	Flat Bar	 MH	Manhole	Sht.	Sheet		
SJ	Control Joint	Ftg.	Footing	Max.	Maximum	Sim.	Similar		
	Control Joint	FA	Force Account	Min.	Minimum	SI.	Slope		
Const. Jt.	Construction Joint	f's	Ultimate Tensile	Misc.	Miscellaneous	<b>S</b>	South Casain a	NO K. FUJIA	STATE OF HAWAII DEPARTMENT OF TRANSPORTATION
Cont.	Continuous		Strength of Tendon	MPH	Miles Per Hour	Spc., Spg.	Spaces, Spacing	LICENSED PROFESSIONAL PENGINEER	HIGHWAYS DIVISION
CFCW	Continuous Flashing			IVI I I	WITTOO T OF TIOUT	Sprd.	Spread	NO. 8104-S	SYMBOLS AND ABBREVIATION
. •	Compound Waterproofing					Spec.	Specification	AMAII, U.S. P	
CF .	Cubic Feet					SF	Square Feet	THIS WORK WAS PREPARED BY ME OR UNDER MY SUPERVISION AND CONSTRUCTION OF THIS PROJECT WILL BE UNDER MY OBSERVATION. "OBSERVATION OF OBSERVATION" IS DEFINED IN CHAPTER 16—115, HAWAII INISTRATIVE RULES, ENTITLED "PROFESSIONAL ENGINEERS, RCHITECTS, SURVEYORS AND LANDSCAPE ARCHITECTS."	Kaumualii Highway, Kuhio Highway
Y, Cu. Yd.	Cubic Yard					SY		1. 1.1. 4	<u>&amp; Kuamoo Road Retaining Walls</u> <u>Project No. HWY-K-01-03</u>
-						SS	Stainless Steel	SIGNATURE LIC. EXPIRATION	110 July 1100 1111 11 01 00


RMTC JOB NO. : 1-20132-0E

21

SHEET No. \$0.3 OF 9 SHEETS

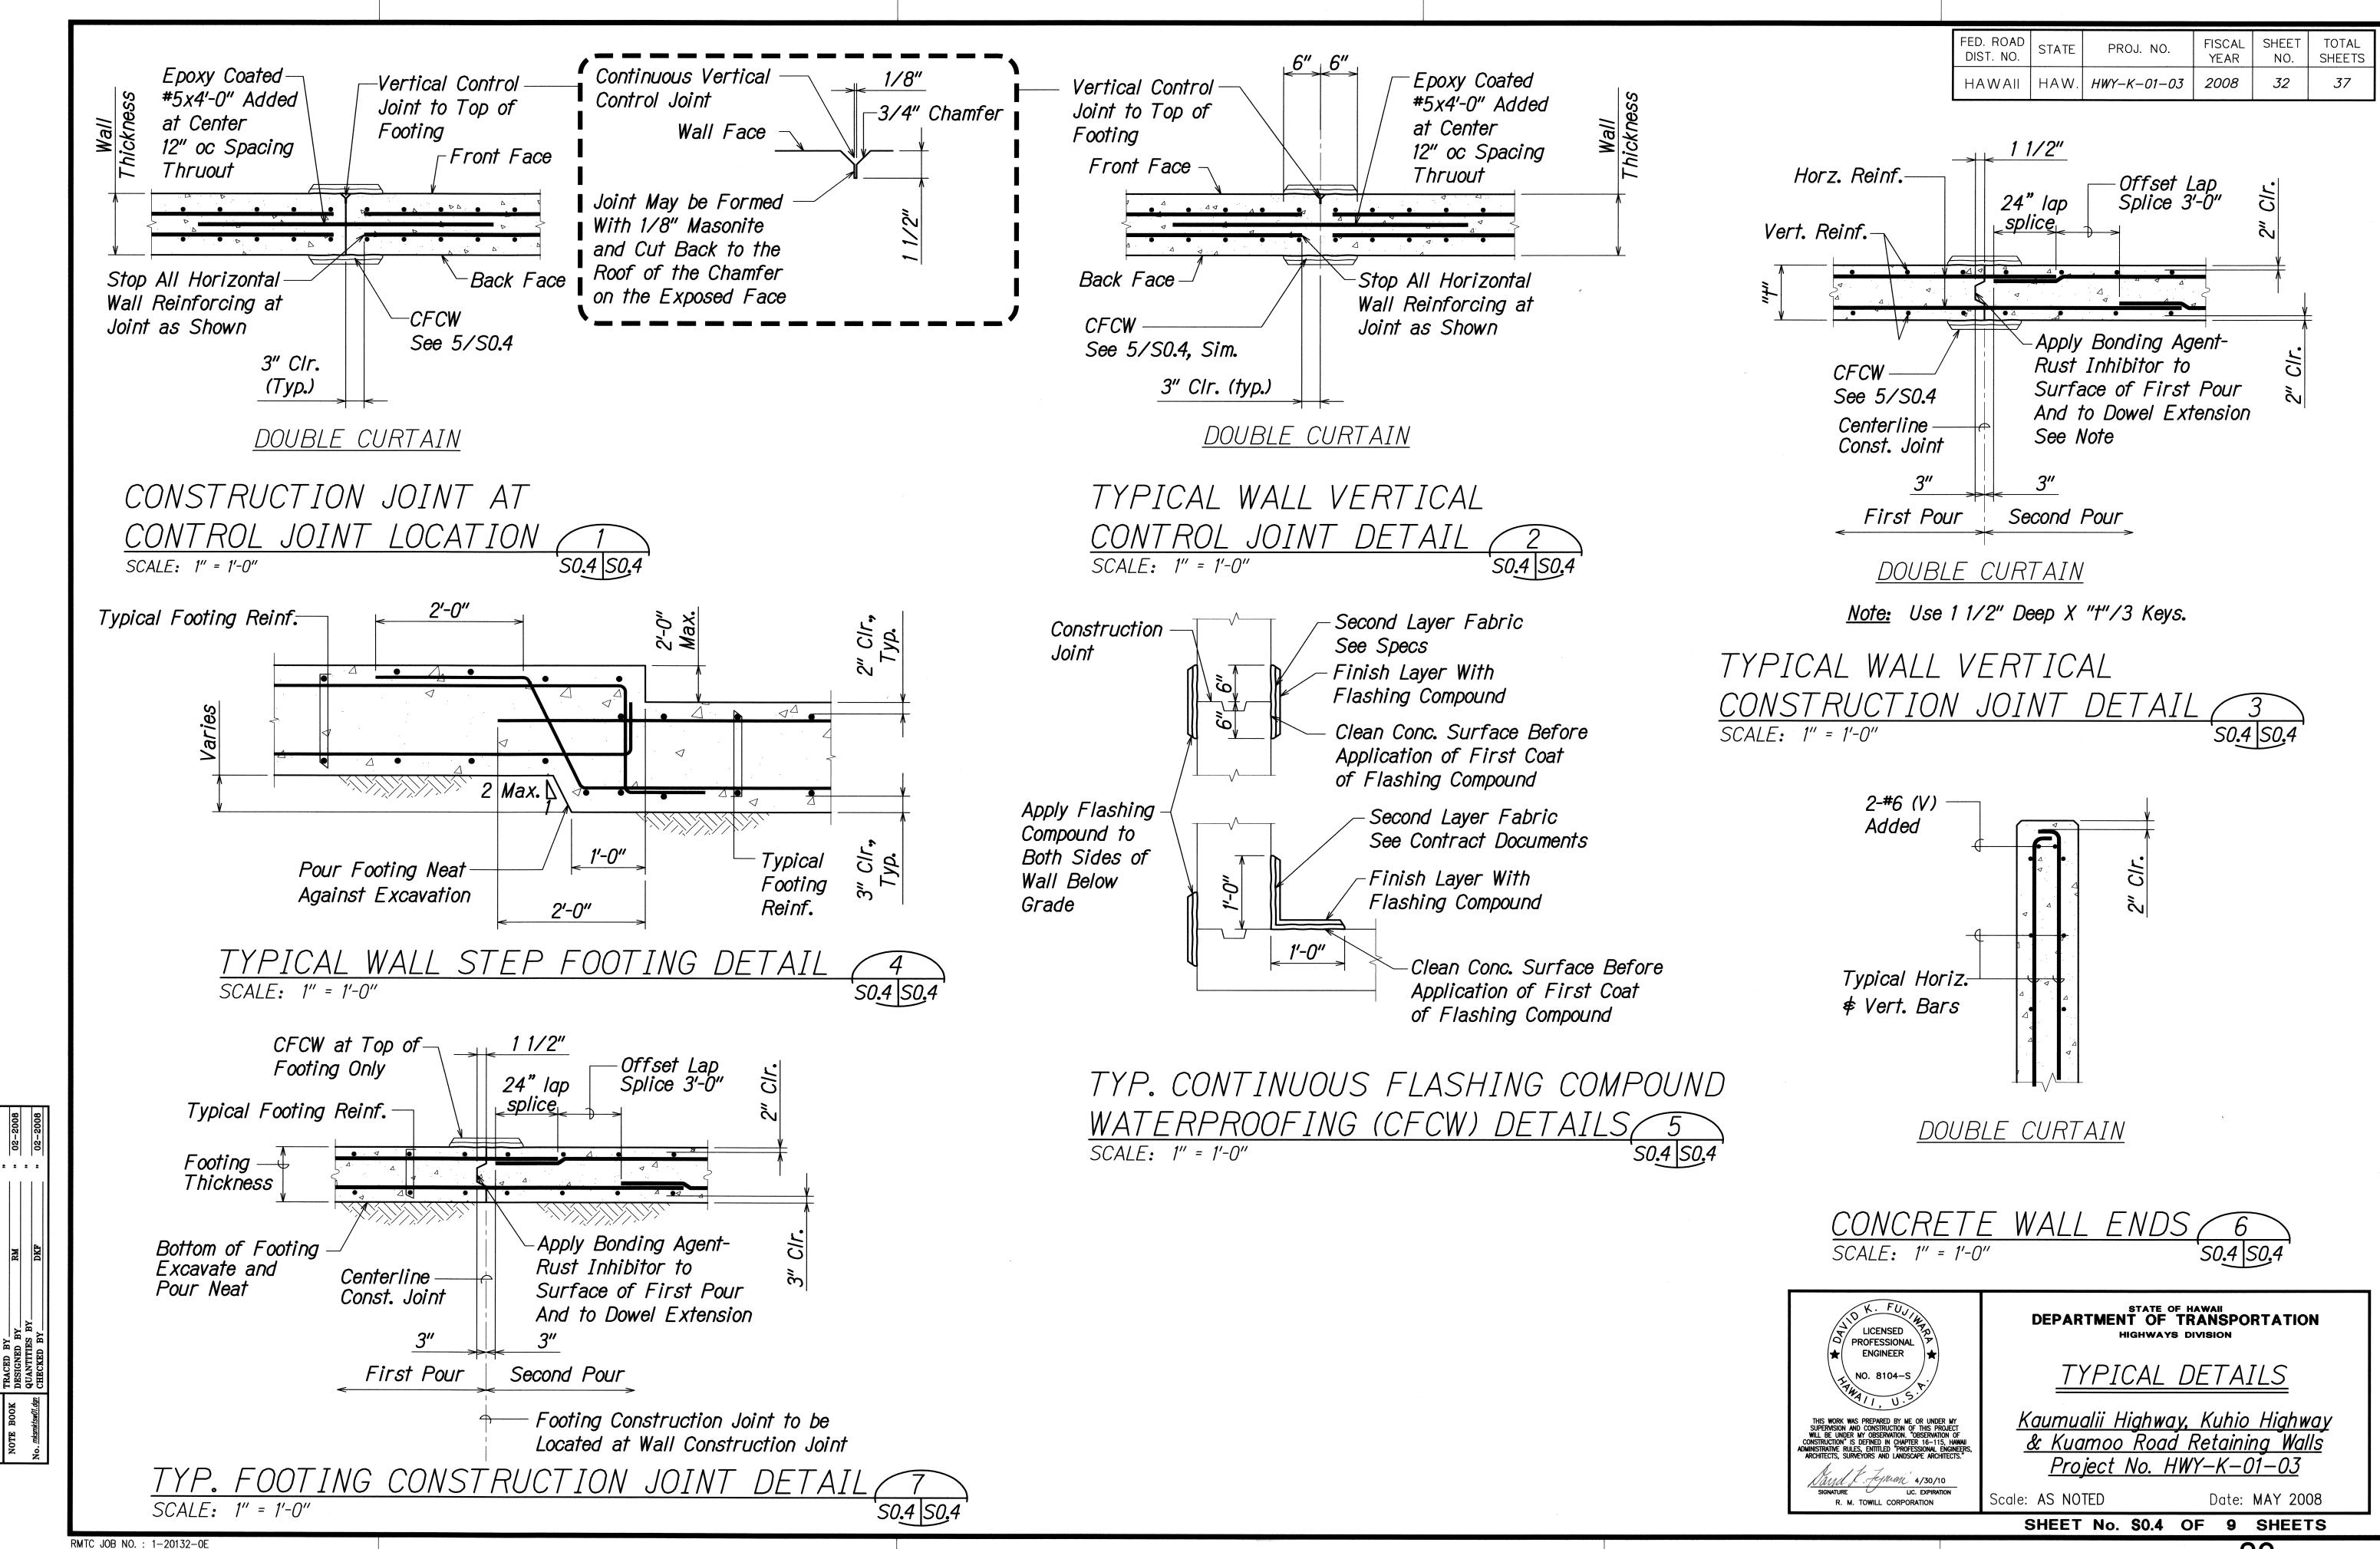

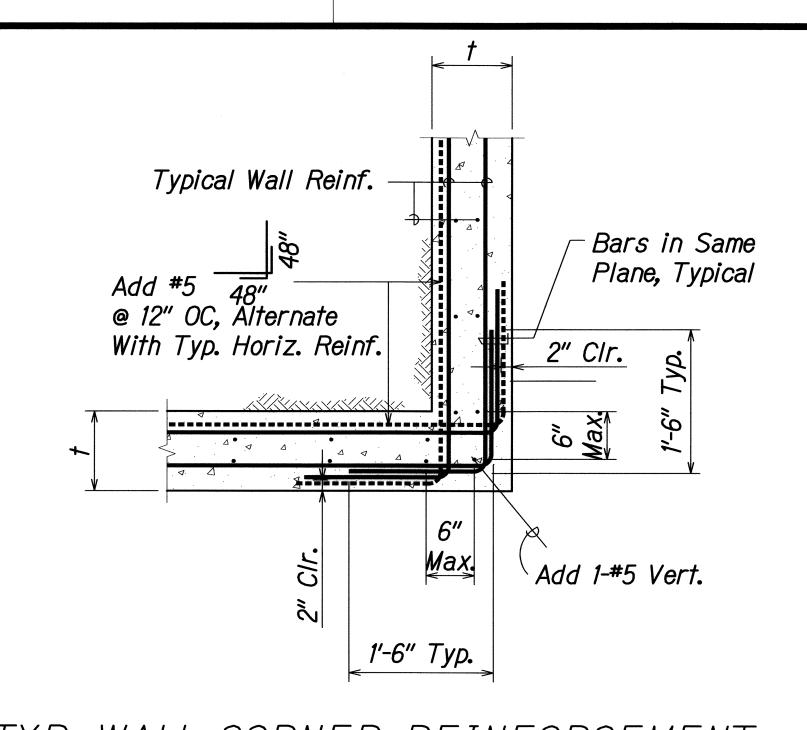

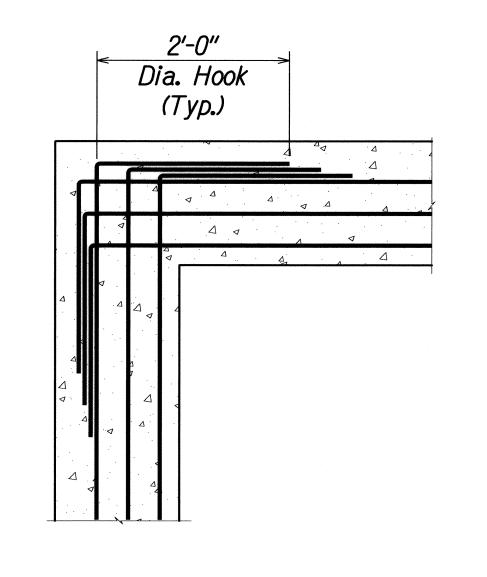

AT CORNERS

TYP. WALL CORNER REINFORCEMENT
LAPPING (DOUBLE CURTAIN)

SCALE: 1" = 1'-0"

50.5 | 50.5


TYPICAL WALL FOOTING DETAIL 2

SCALE: 1" = 1'-0"

S0.5 S0.5

Lap Length of Vert. Reinf. in Wall						
Bar Size	L					
#4	2'-0"					
#5	2'-6"					
#6	3'-0"					
#7	4'-6"					
#8	5'-2"					
#9	5′-10″					


Unless Otherwise Noted

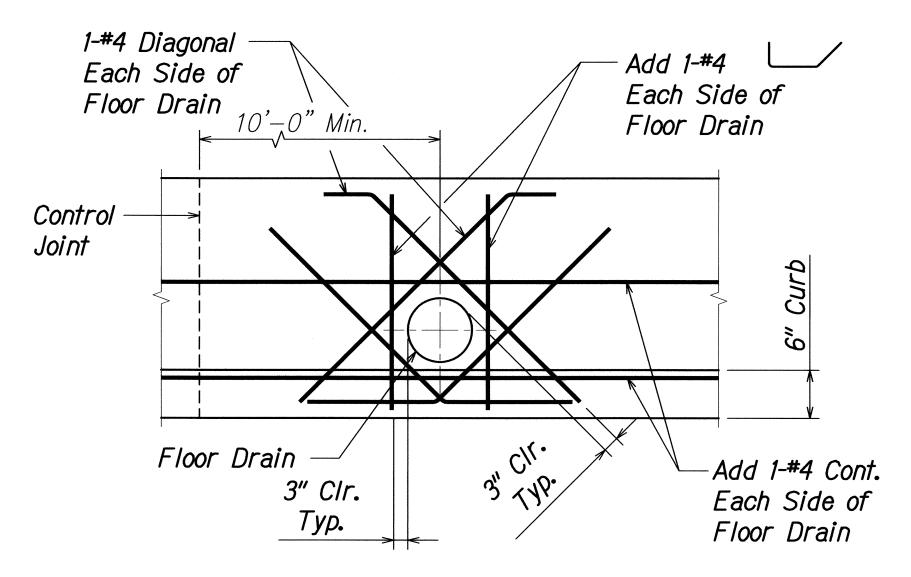

ADDED REINFORCING AT FLOOR DRAIN
WITHIN SWALE

SCALE: 1" = 1'-0"

S0.5 S0.5

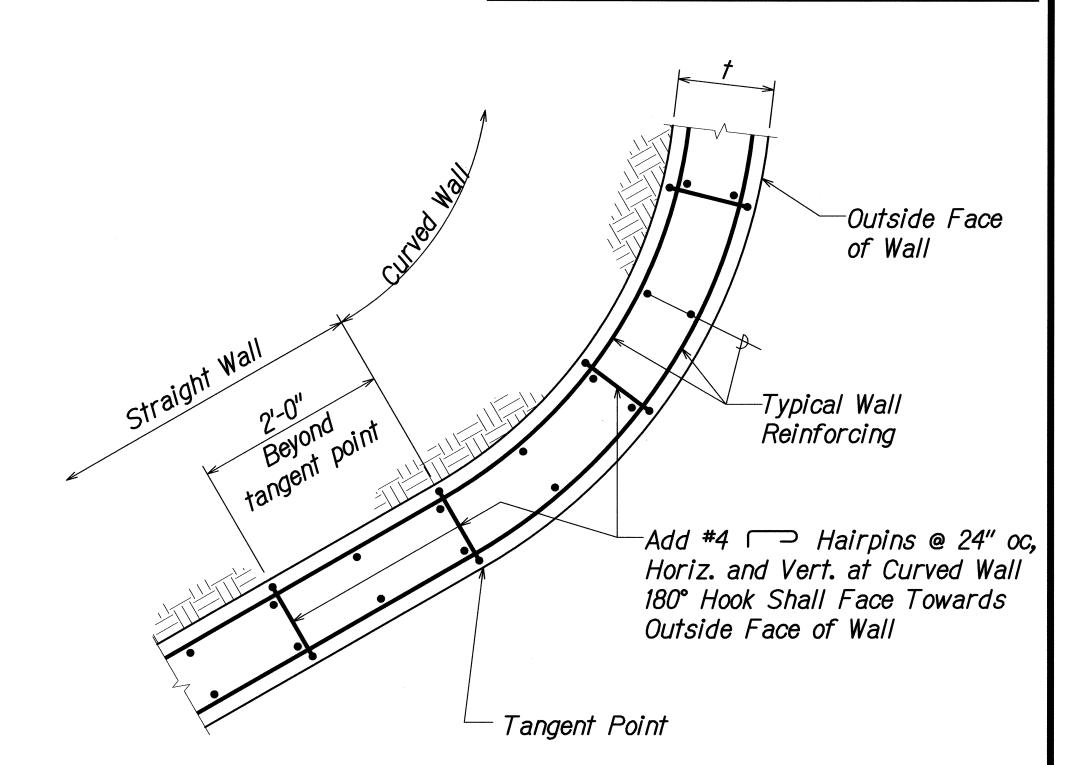

FED. ROAD DIST. NO.


FISCAL YEAR

PROJ. NO.

HAWAII HAW HWY-K-01-03

SHEET NO. TOTAL SHEETS



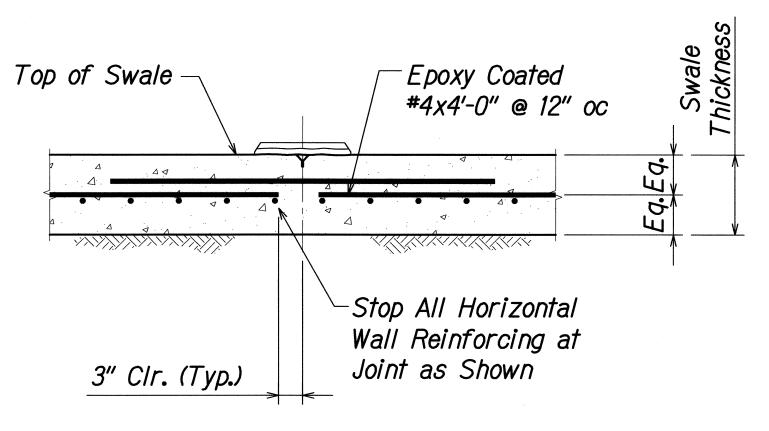


TYPICAL SWALE

CONTROL JOINT DETAIL 5

SCALE: 1" = 1'-0"

SO.4 SO.4

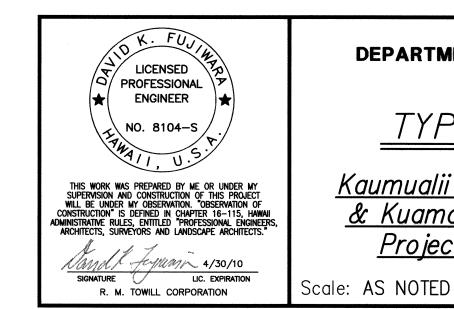

DEPARTMENT OF TRANSPORTATION

TYPICAL DETAILS

Kaumualii Highway, Kuhio Highway

& Kuamoo Road Retaining Walls

Project No. HWY-K-01-03

ale: AS NOTED

Date: MAY 2008

SHEET No. \$0.5 OF 9 SHEETS

 ORIGINAL
 SURVEY PLOTTED BY
 BB
 DATE


 PLAN
 DRAWN BY
 "


 NOTE BOOK
 TRACED BY
 "

 No. mksmktsw02.dqn
 QUANTITIES BY
 "


 CHECKED BY
 DKF
 "


RMTC JOB NO. : 1-20132-0E

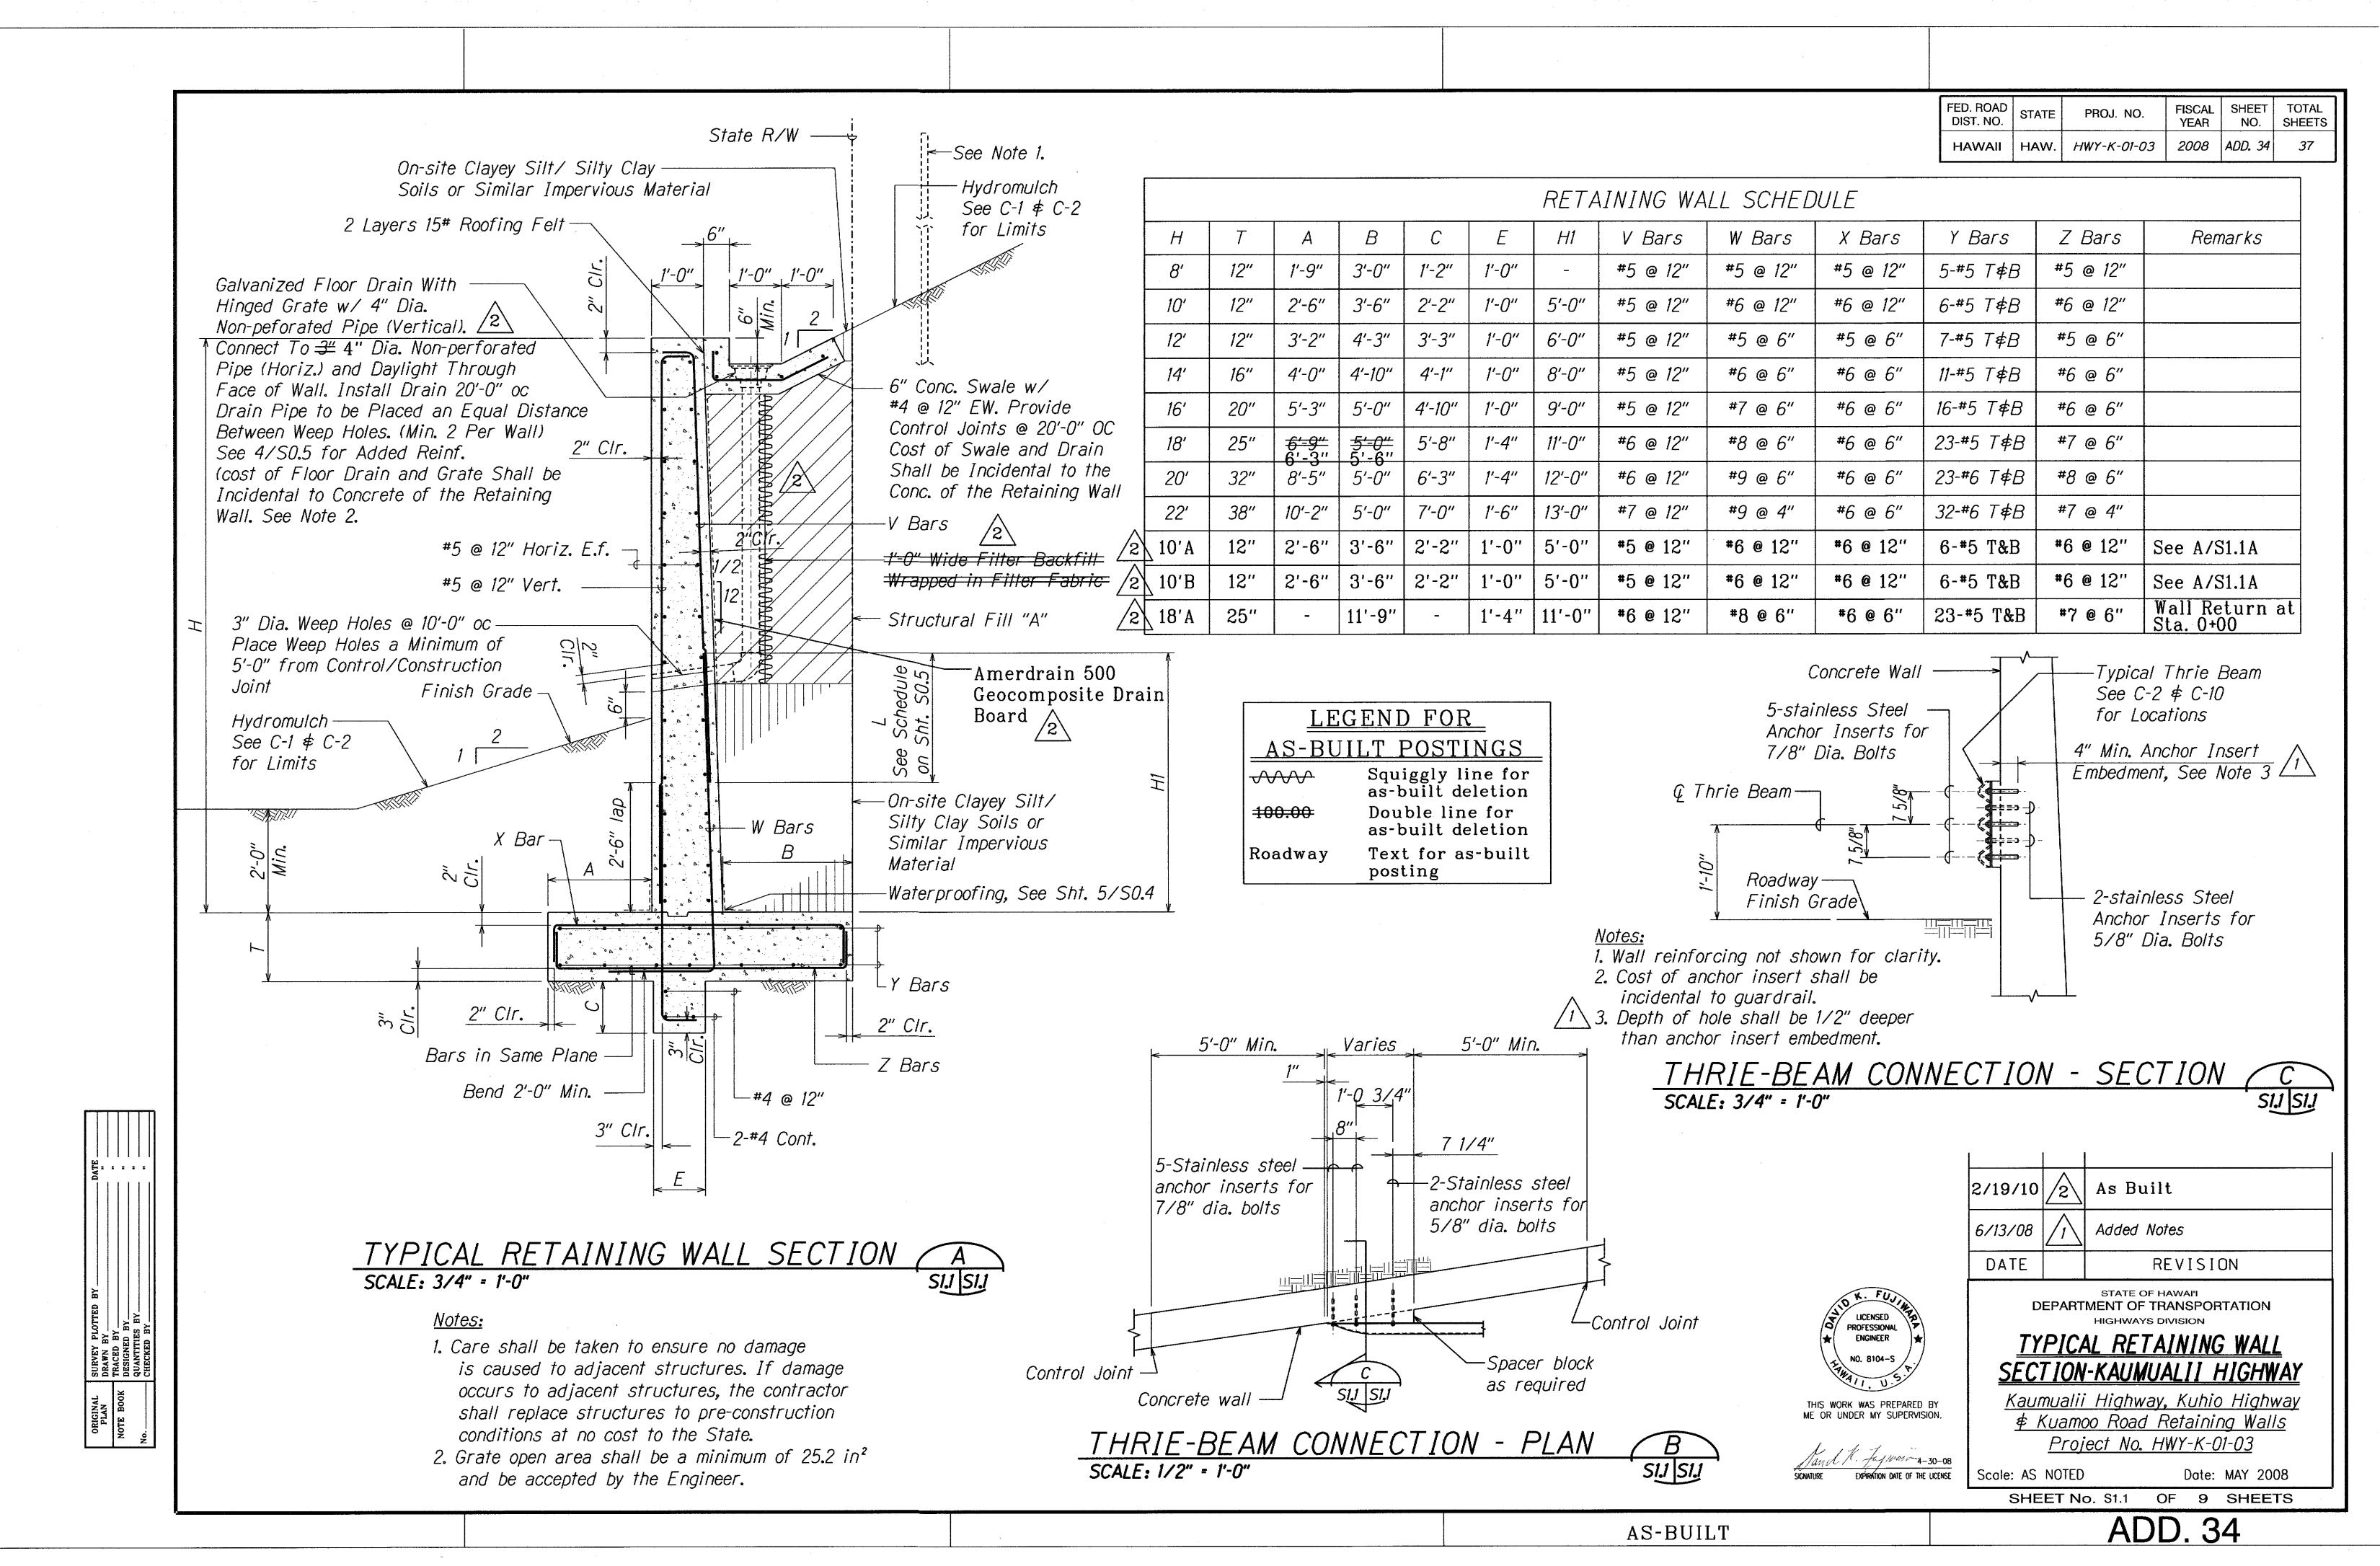

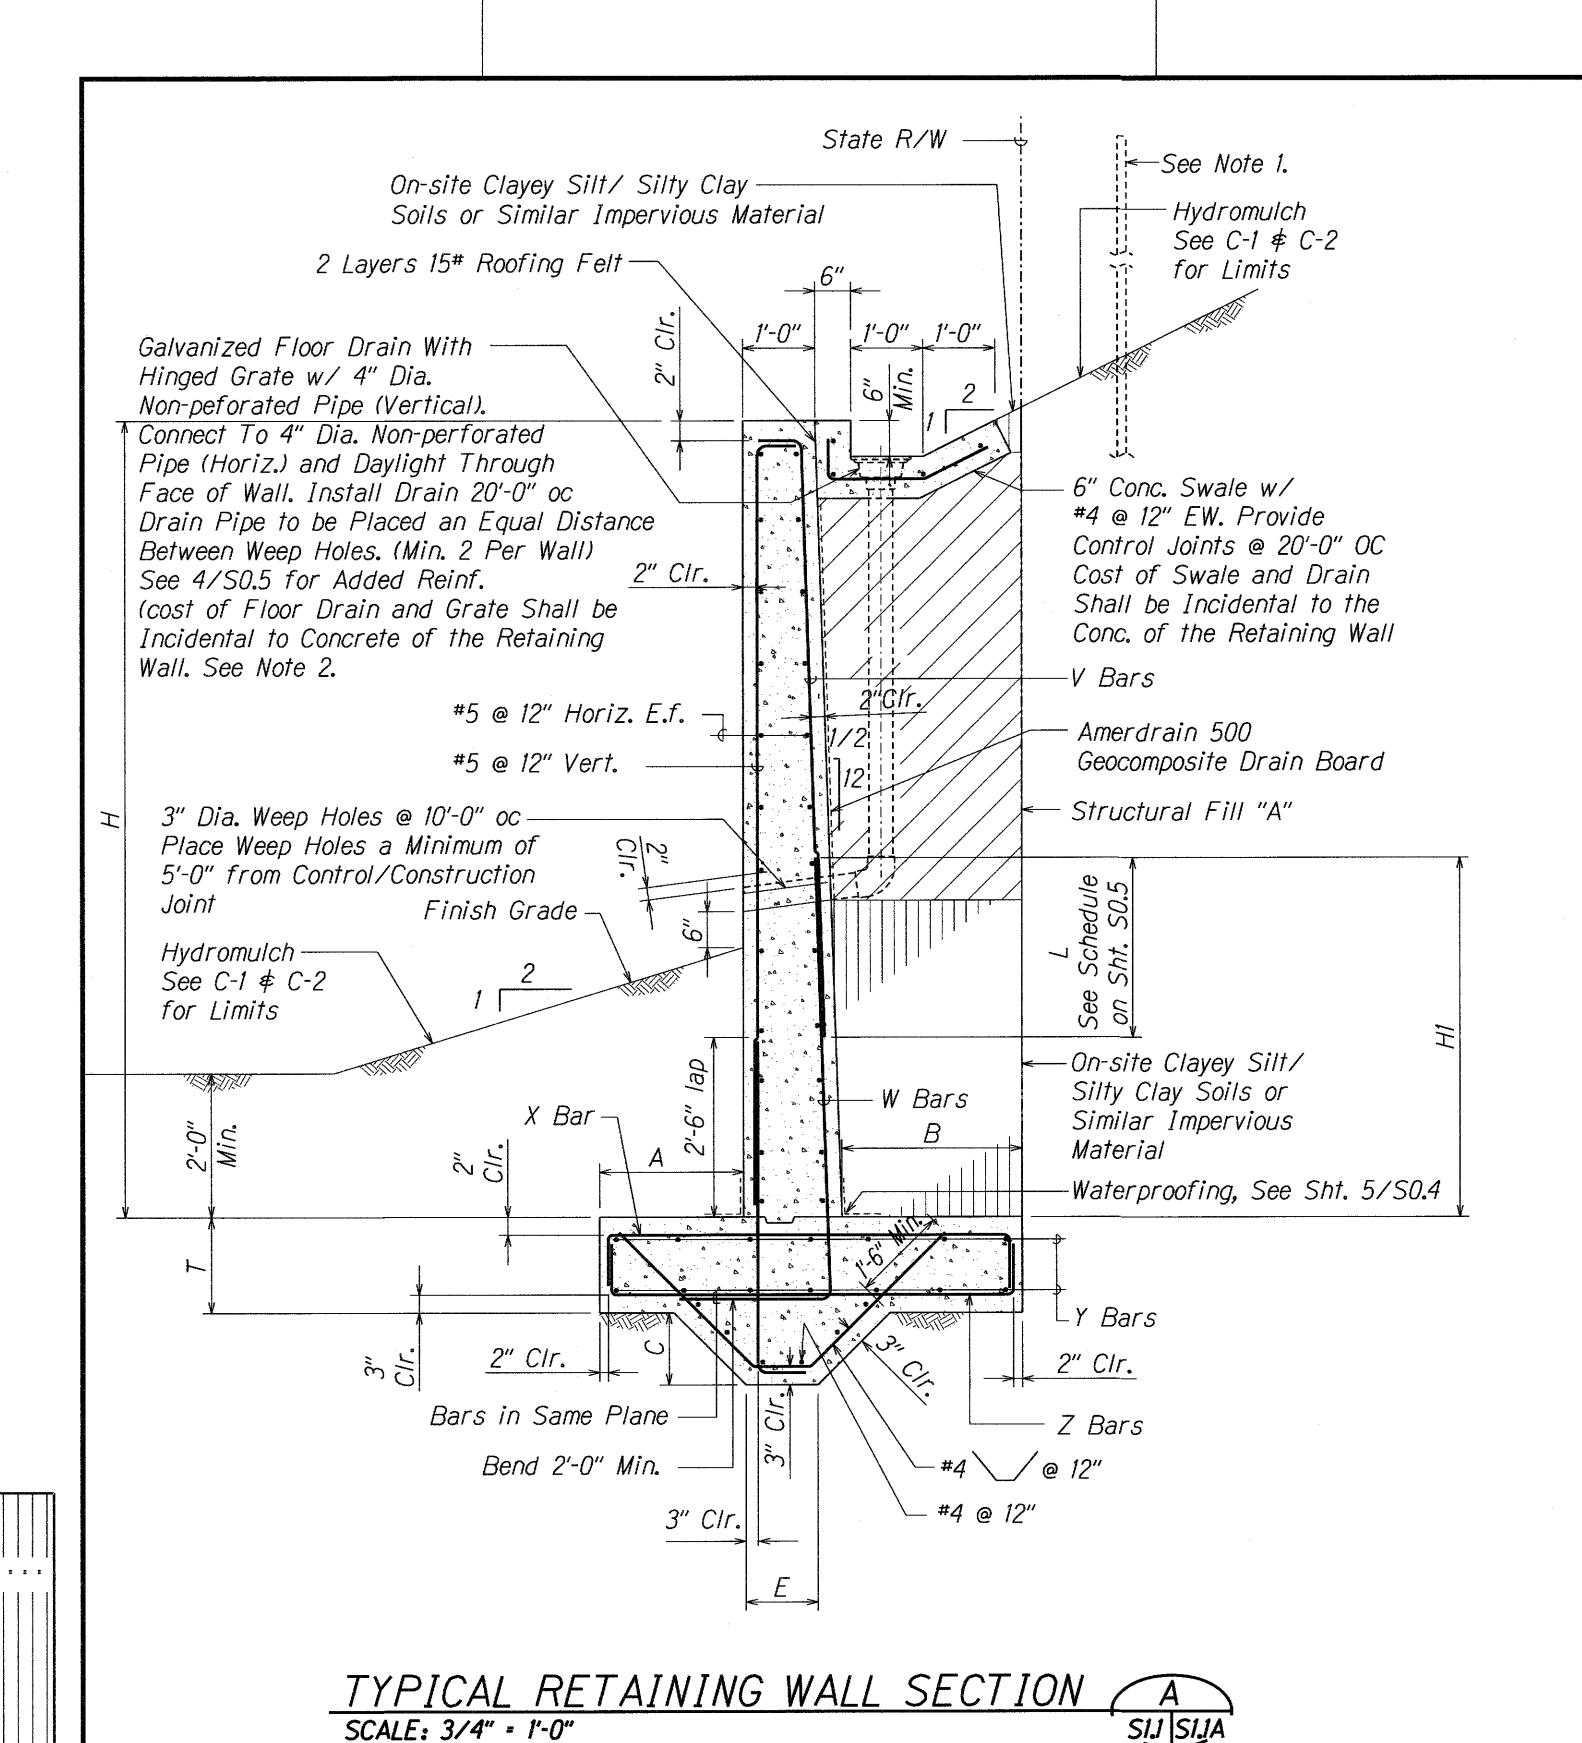

FED. ROAD<br/>DIST. NO.STATEPROJ. NO.FISCAL<br/>YEARSHEET<br/>NO.TOTAL<br/>SHEETSHAWAIIHAW.HWY-K-01-03200834S-137

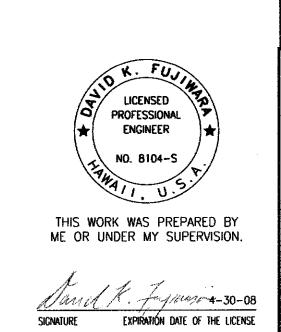

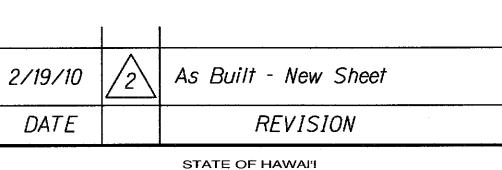

STATE OF HAWAI'I
DEPARTMENT OF TRANSPORTATION
HIGHWAYS DIVISION

# TYPICAL RETAINING WALL SECTION-KAUMUALII HIGHWAY

Kaumualii Highway, Kuhio Highway


\* Kuamoo Road Retaining Walls

Project No. HWY-K-01-03

Scale: AS NOTED Date: MAY 2008

SHEET No. S1.1A OF 9 SHEETS

34S-1

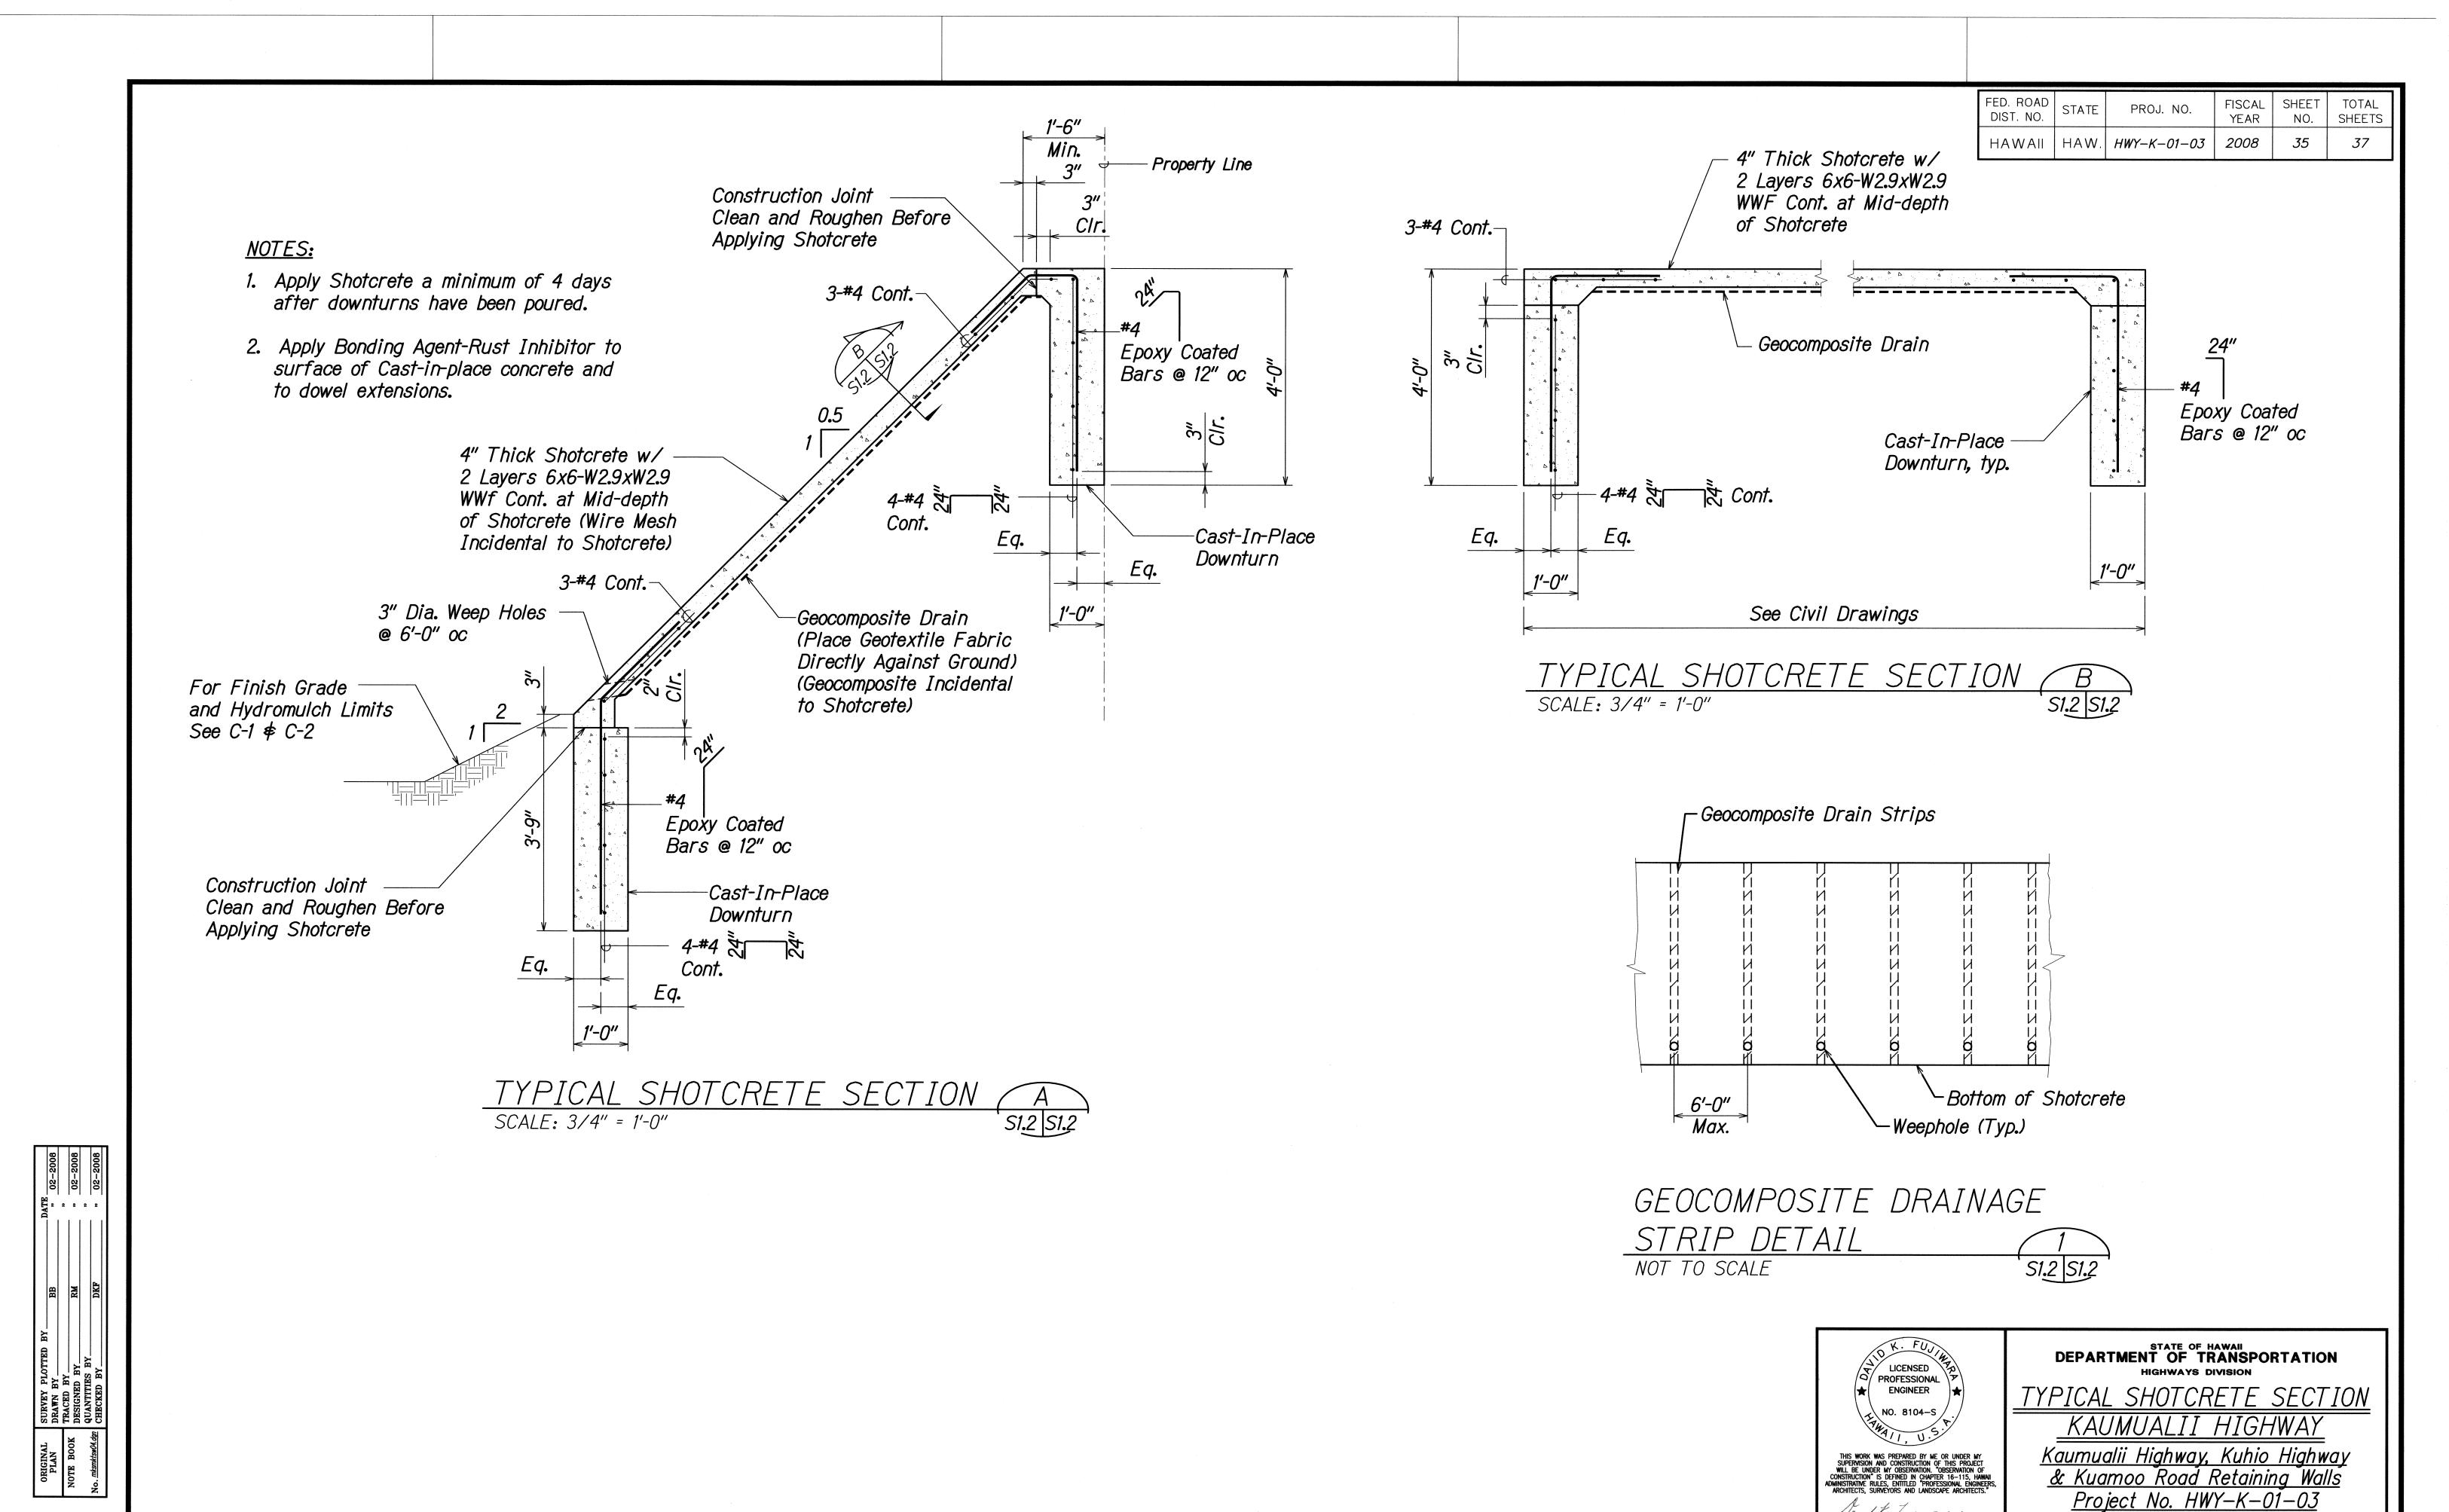


RMTC JOB NO. : 1-20132-0E

35

SHEET No. \$1.2 OF 9 SHEETS


Date: MAY 2008

Scale: AS NOTED

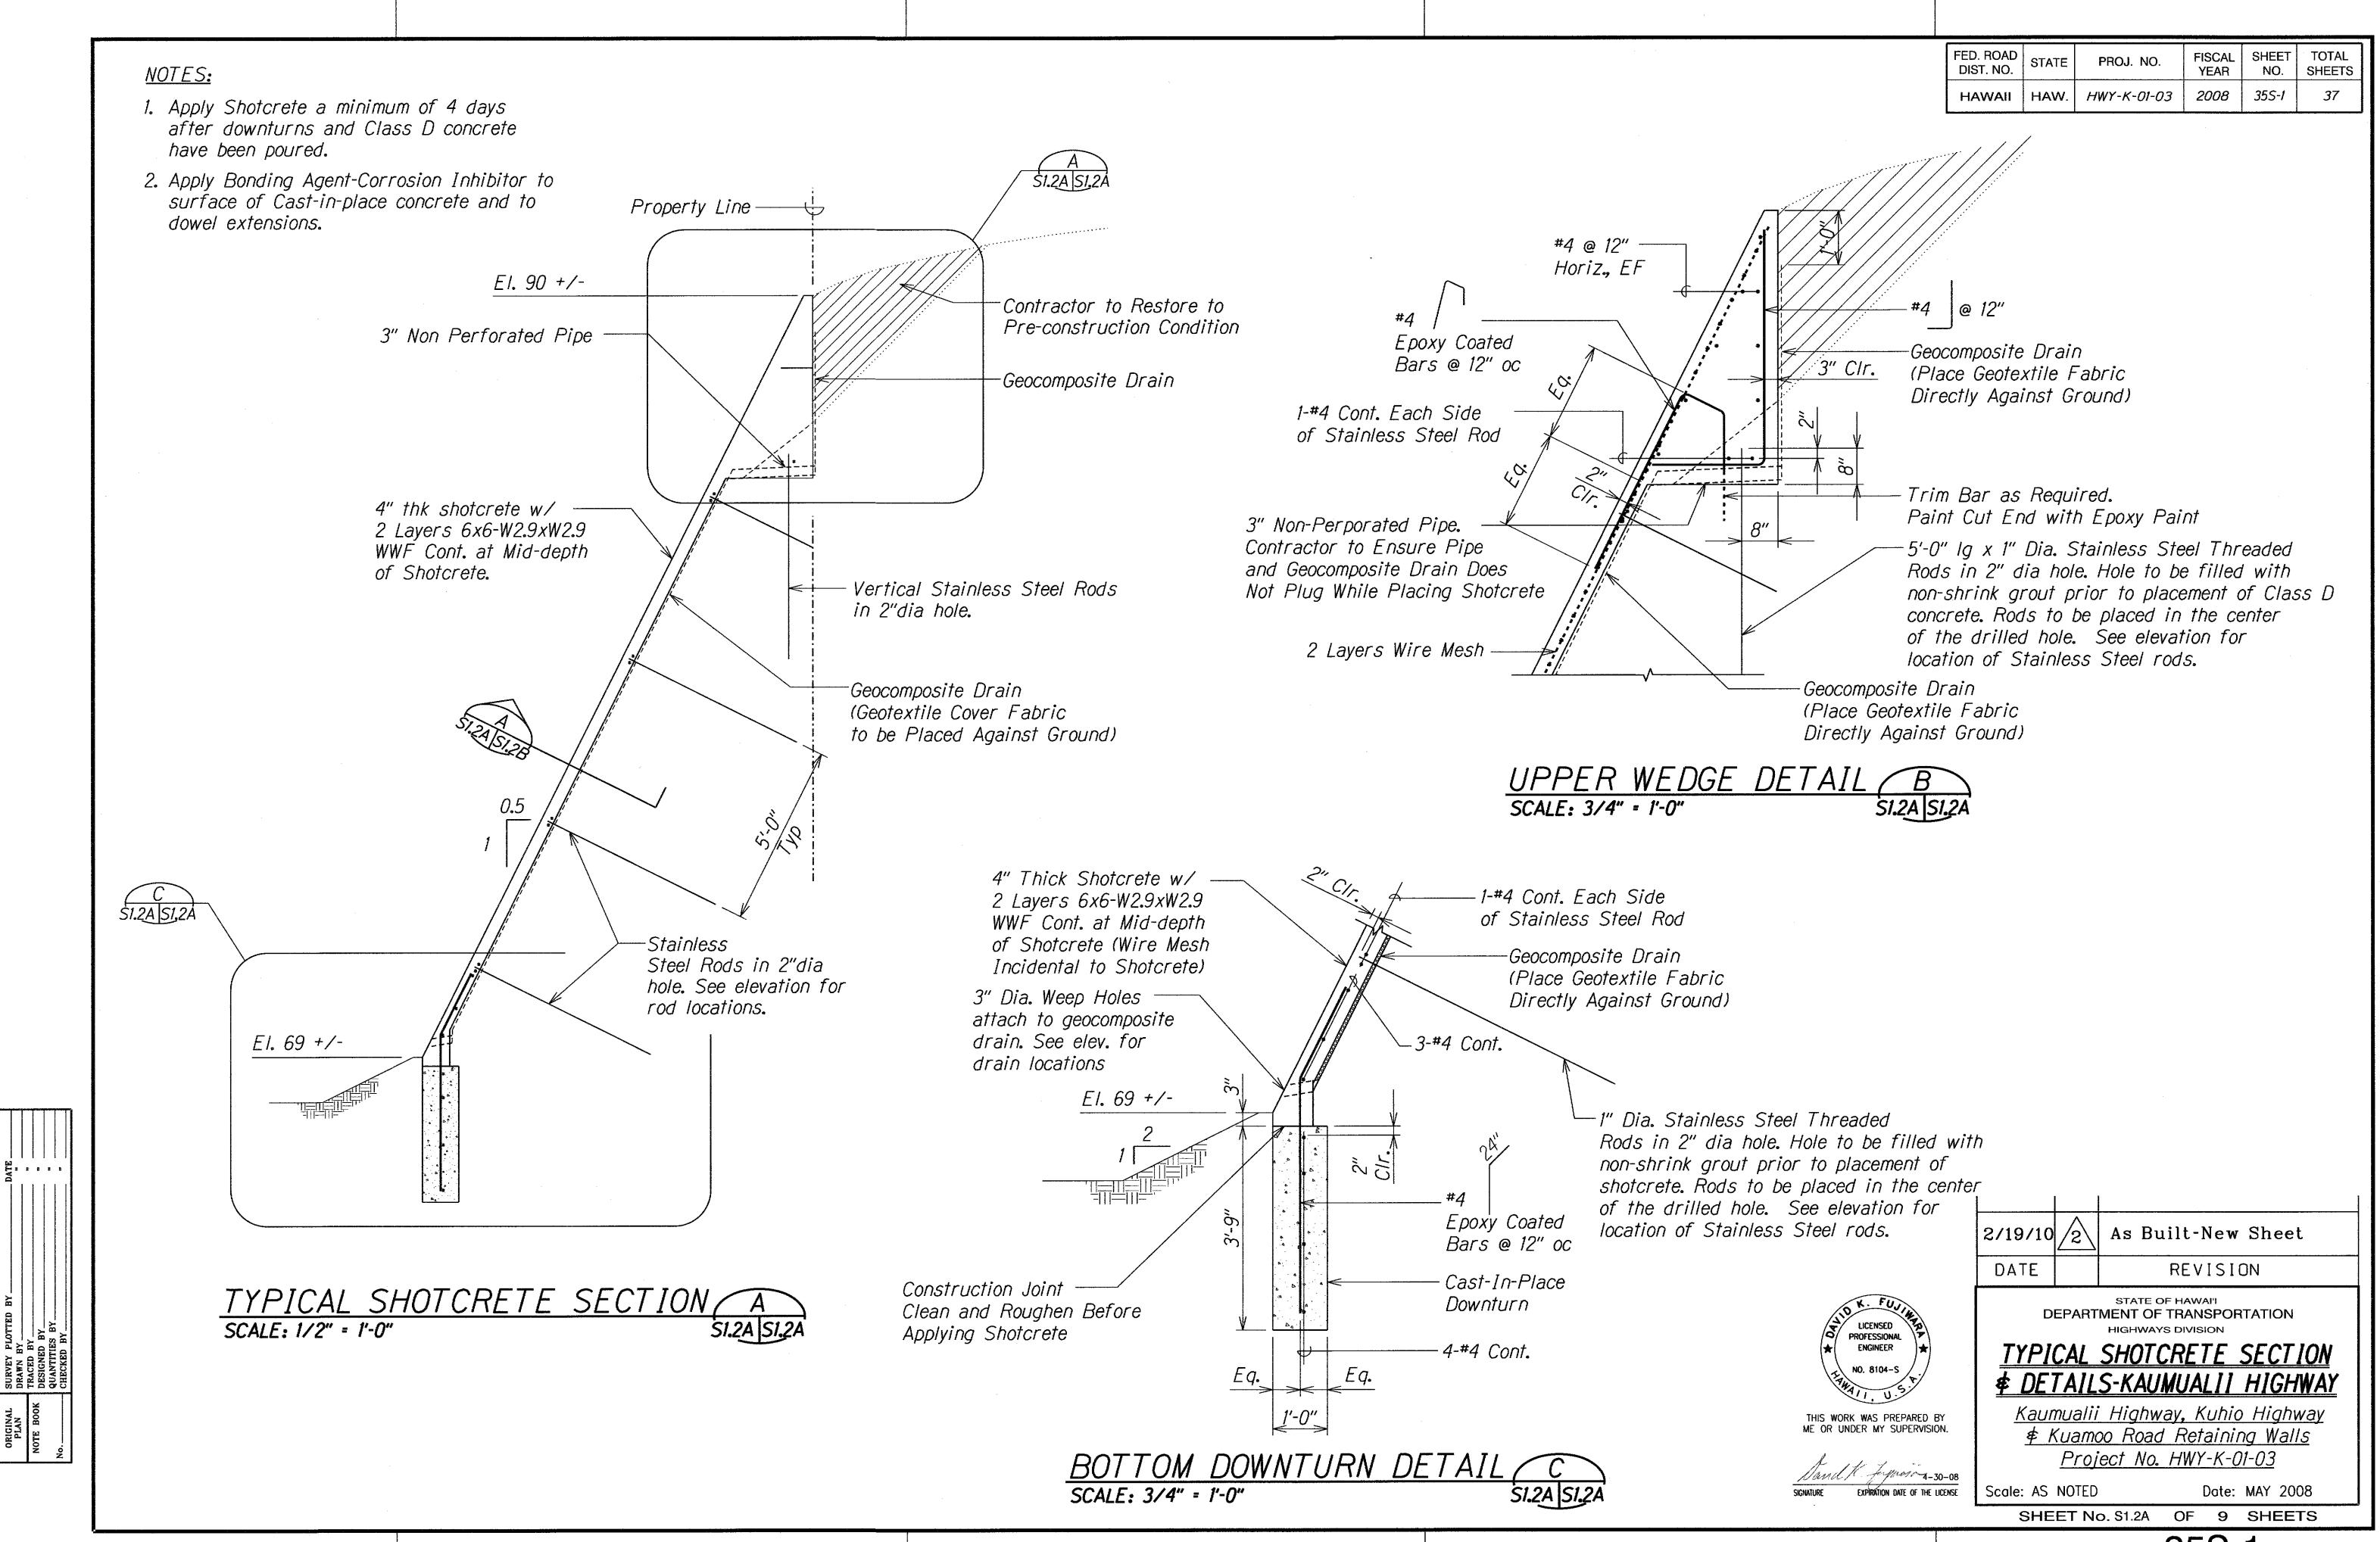

35S-1


FED. ROAD<br/>DIST. NO.STATEPROJ. NO.FISCAL<br/>YEARSHEET<br/>NO.TOTAL<br/>SHEETSHAWAIIHAW.HWY-K-01-03200835S-237

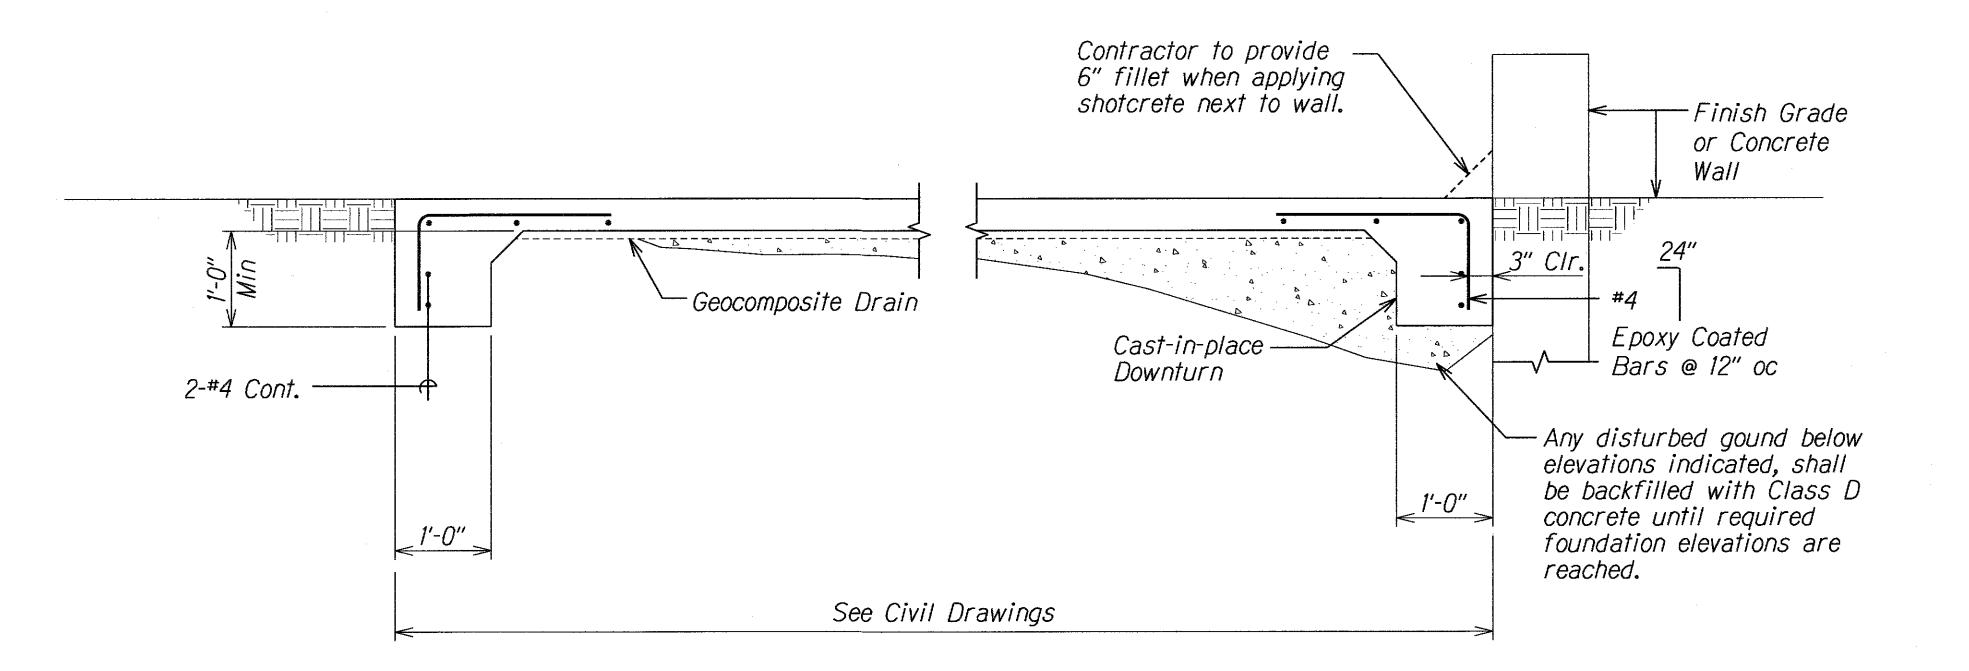

TYPICAL SHOTCRETE SECTION A

SCALE: 1" = 1'-0"


S1.2A S1.2B

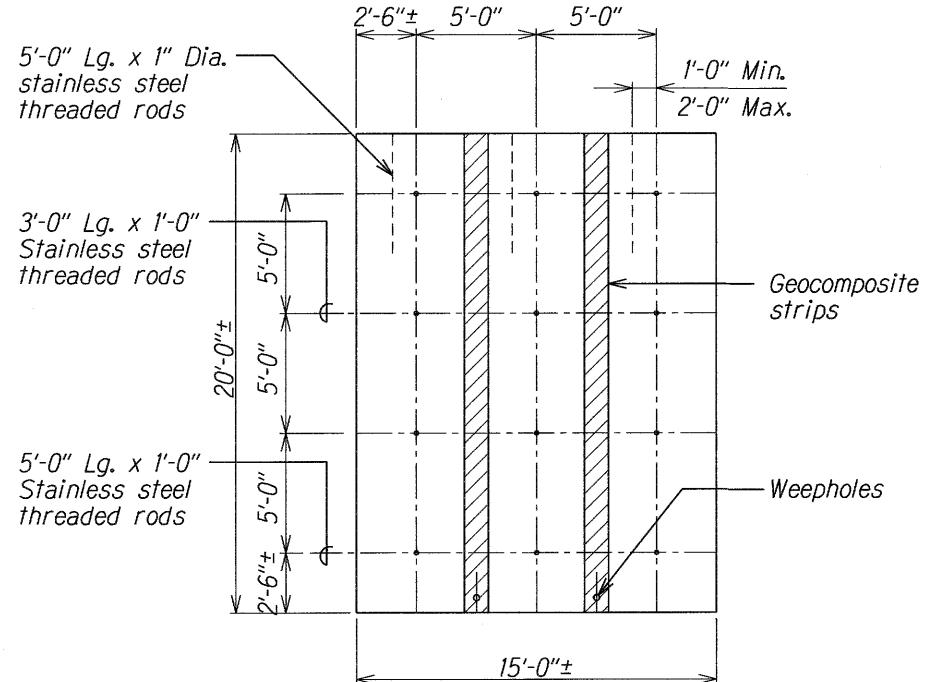

DOWEL LAYOUT AND GEOCOMPOSITE

DRAINAGE STRIP DETAIL

SCALE: 1/4" = 1'-0"

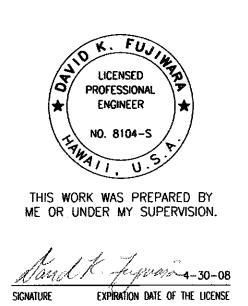

2/19/10 2 As Built-New Sheet

DATE REVISION

STATE OF HAWAPI
DEPARTMENT OF TRANSPORTATION

# TYPICAL SHOTCRETE SECTION AND DETAIL KAUMUALII HIGHWAY


Scale: AS NOTED

SHEET No. S1.2B


Date: MAY 2008

OF 9 SHEETS

35S-2

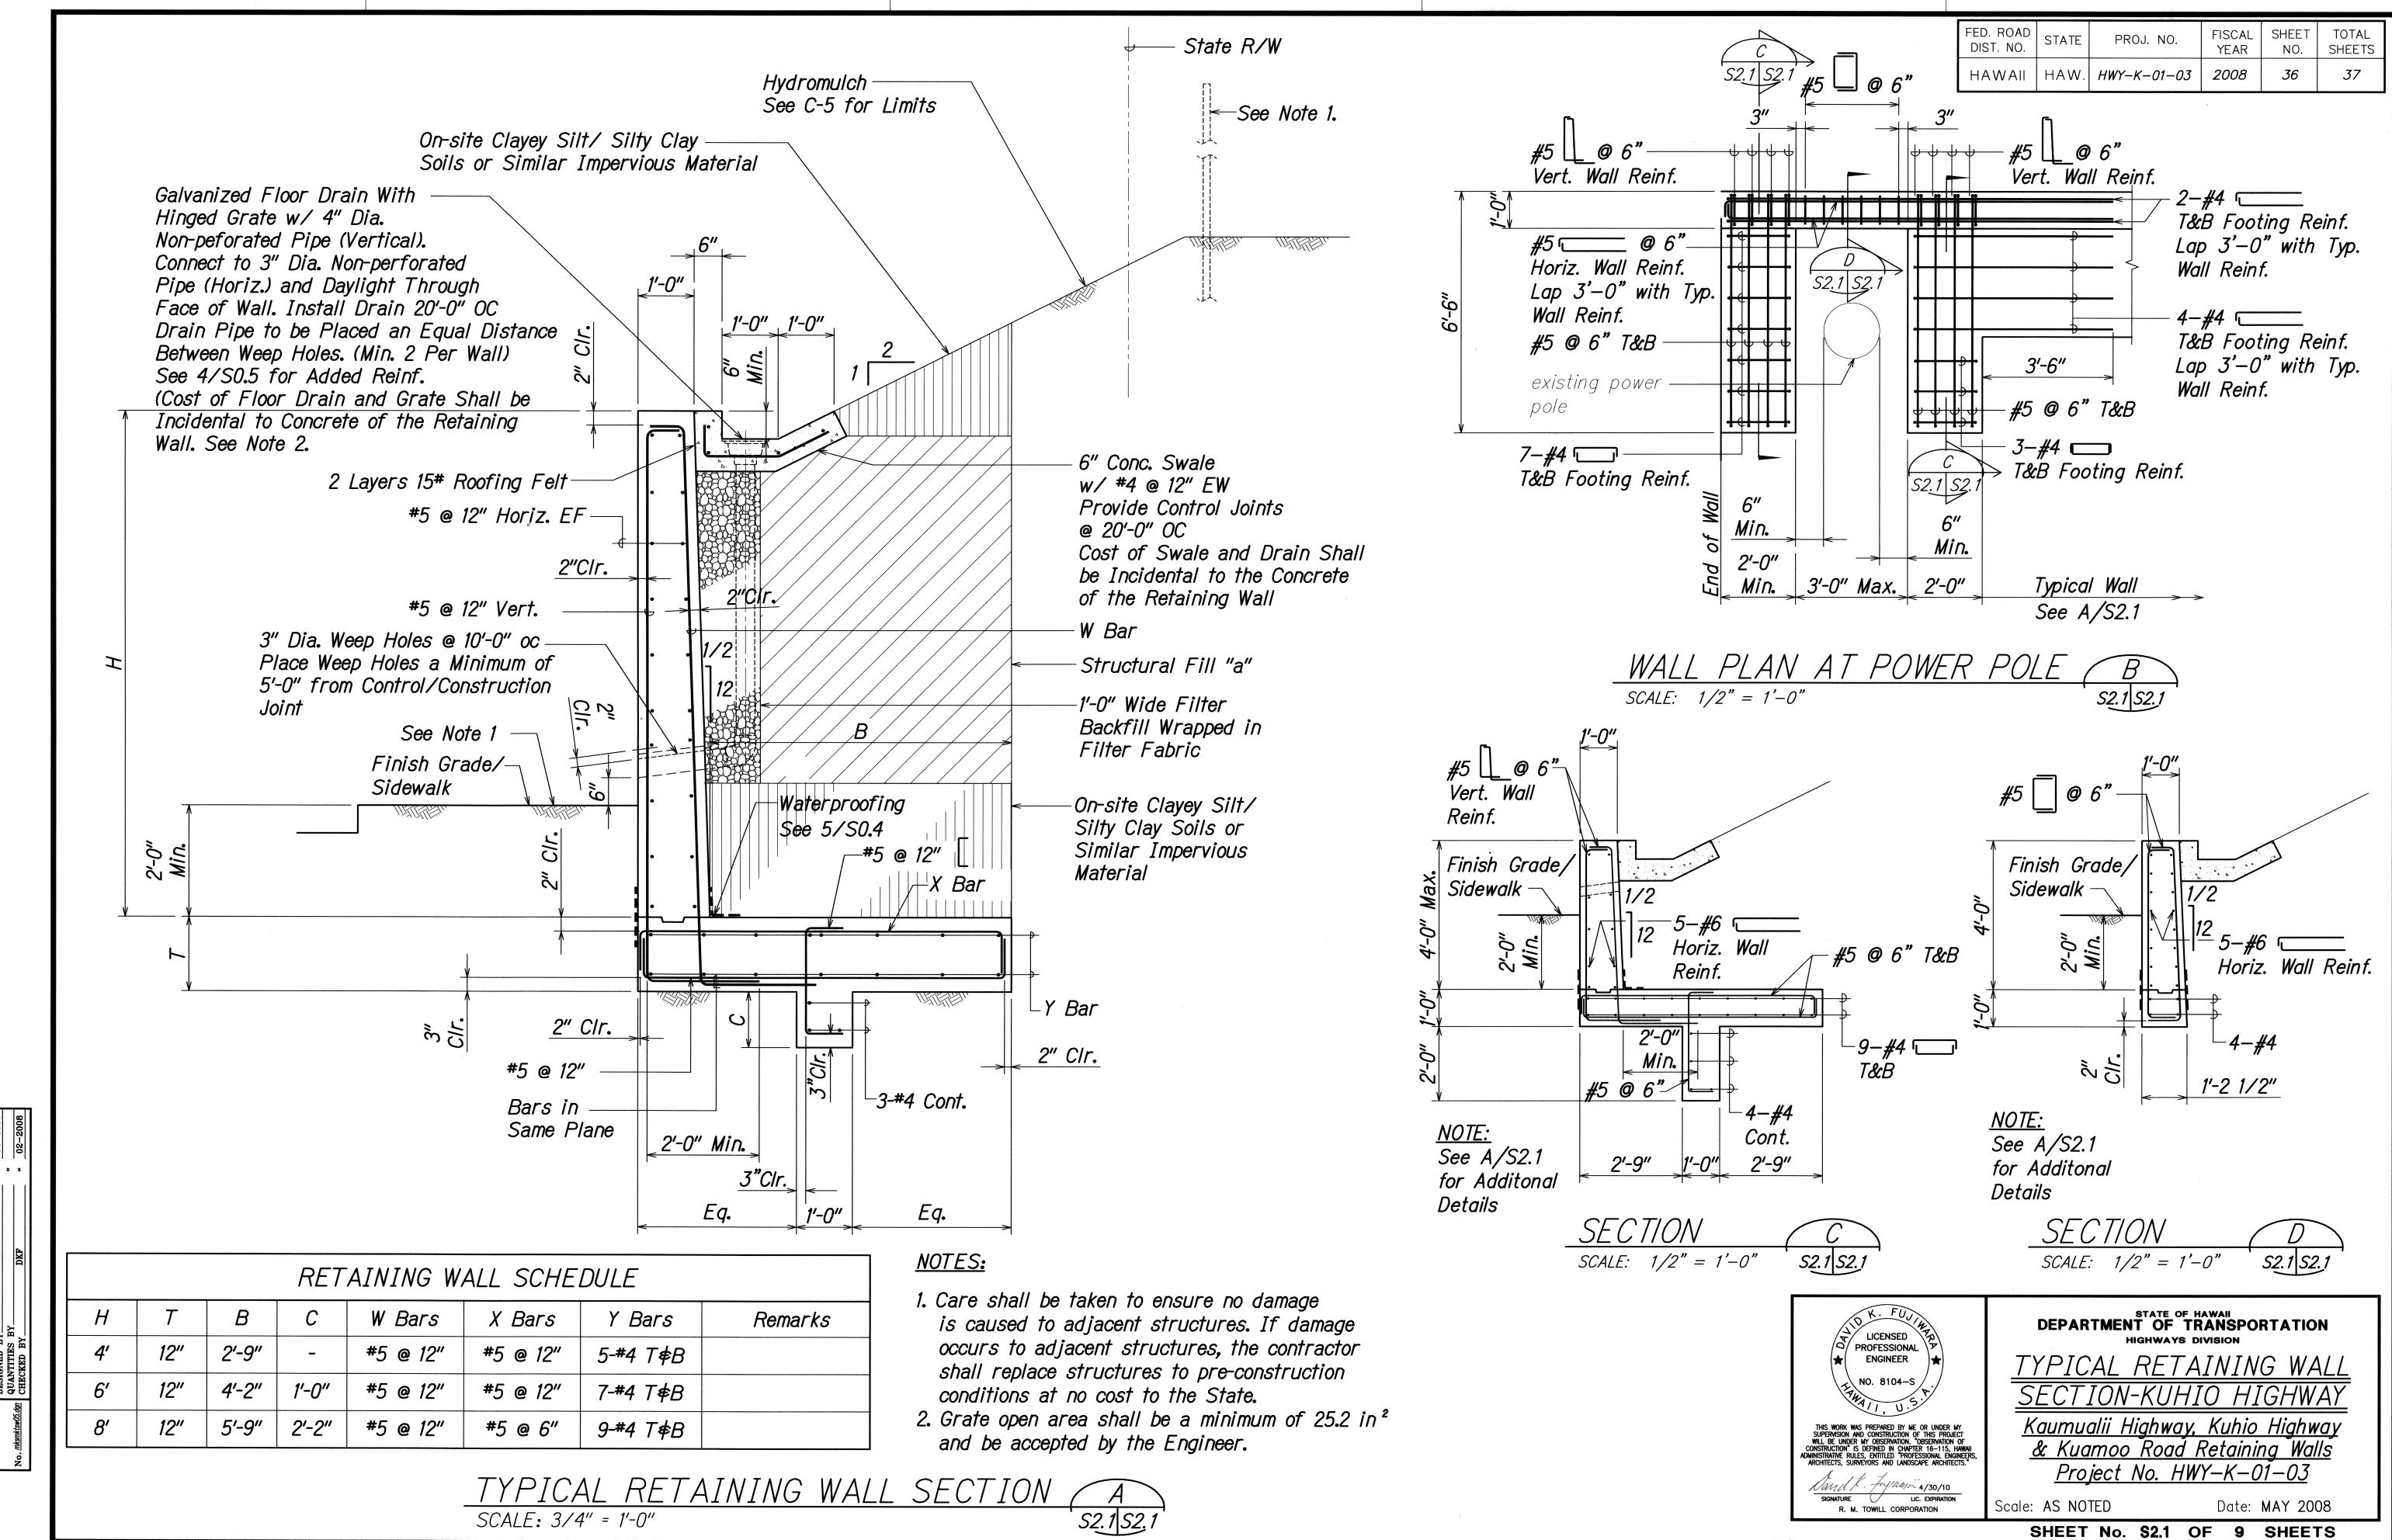

RMTC JOB NO. : 1-20132-0E

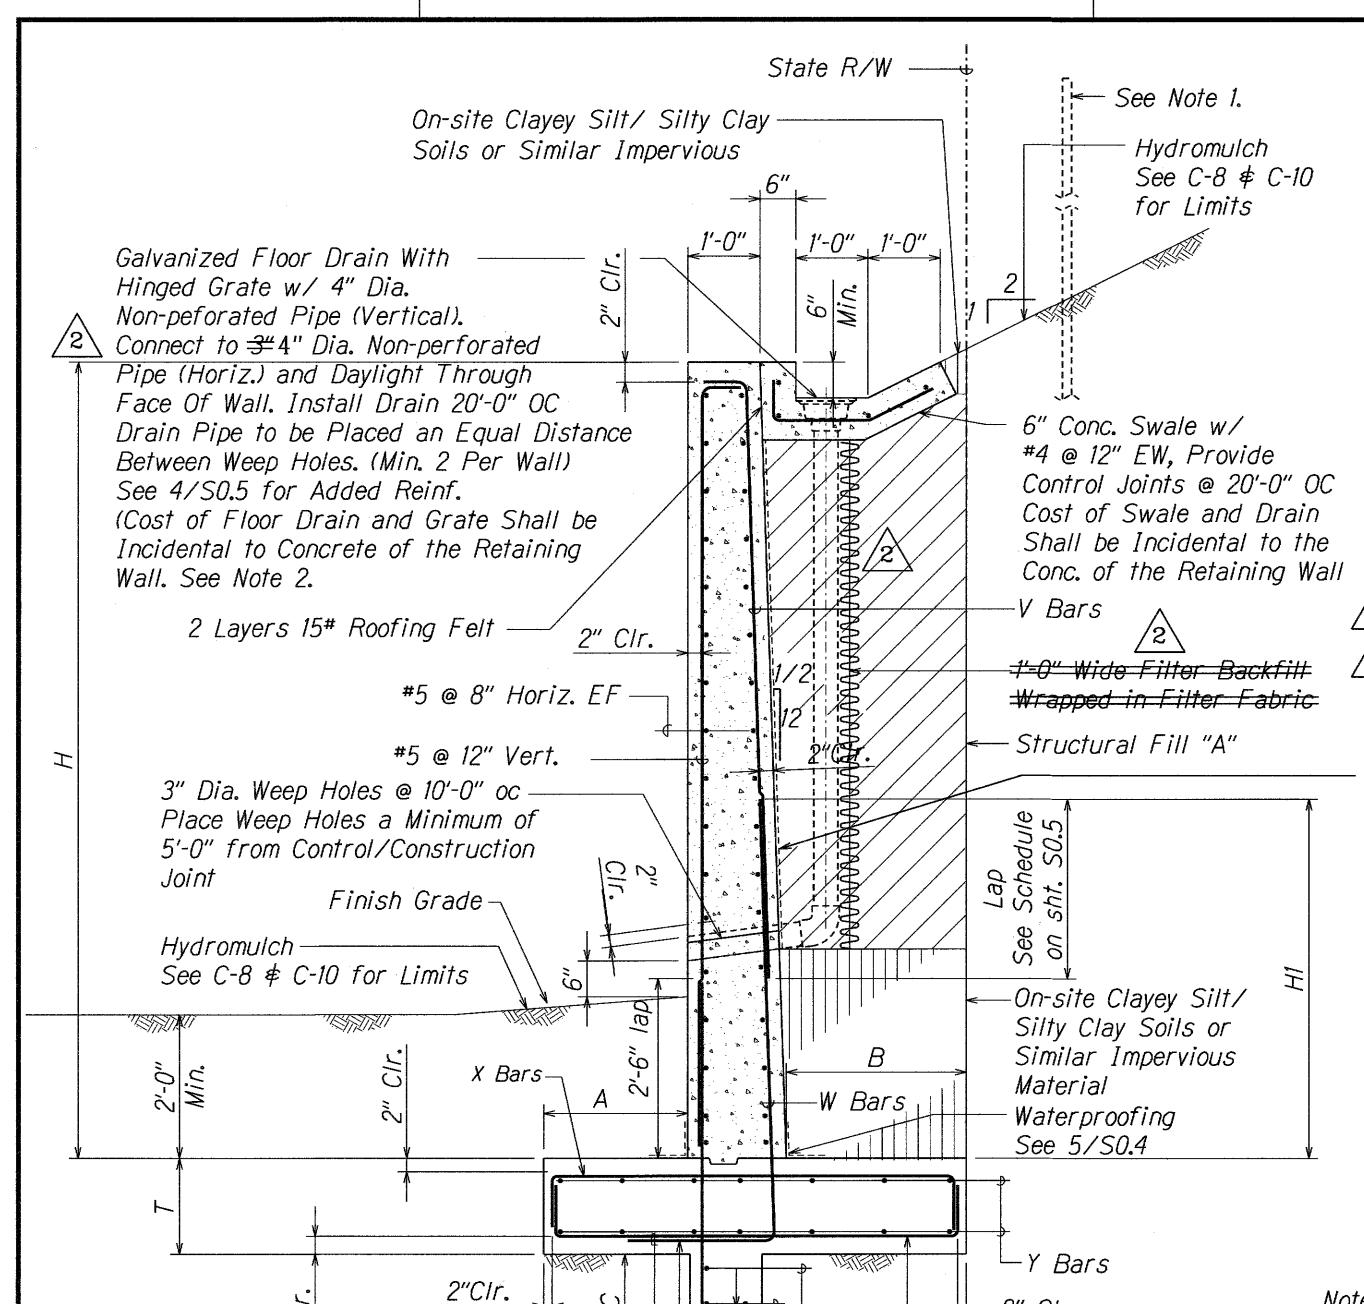

FED. ROAD DIST. NO.	STATE	PROJ. NO.	FISCAL YEAR	SHEET NO.	TOTAL SHEETS
HAWAII	HAW.	HWY-K-01-03	2008	37	37

	RETAINING WALL SCHEDULE												
Ī	Н	T	Α	В	С	Ε	H1	V Bars	W Bars	X Bars	Y Bars	Z Bars	Remarks
	8'	12"	1'-0"	4'-2"	2'-0"	1'-0"	-	#5 @ 12"	#5 @ 12"	#6 @ 12"	5-#5 T <b>¢</b> B	#5 @ 12"	
	10'	12"	1'-0"	5′-8"	3'-1"	1'-0"	4'-0"	#5 @ 12"	#6 @ 12"	#6 @ 6"	6-#5 T <b>\$</b> B	#5 @ 12"	
	12'	16"	1'-0"	7′-6″	4'-3"	1'-0"	5'-0"	#5 @ 12"	#5 @ 6"	#7 @ 6"	11-#5 T <b>\$</b> B	#5 @ 12"	
	14'	16"	3'-0"	6'-3"	5′-2″	1'-4"	7′-0″	#5 @ <i>12"</i>	#6 @ 6"	#6 @ 6"	12-#5 T <b>¢</b> B	#5 @ 6"	
	16'	20"	4'-2"	6'-3"	6'-2"	1'-4"	8'-0"	#6 @ 12"	#7 @ 6"	#6 @ 6"	16-#5 T¢B	#6 @ 6"	
	18'	24"	5'-8"	6'-3"	7'-2"	1′-6″	9'-0"	#6 @ 12"	#8 @ 6"	#6 @ 6"	22-#5 T <b>¢</b> B	#7 @ 6"	
$\sqrt{s}$	15.5	20"	4'-1"	6'-3"	6'-10"	1'-6"	8'-0"	#6 @ 12''	#7 @ 6''	#6 @ 6"	16-#5 T&B	#6 @ 6"	Sta. 1+05 to 1+20
$\sqrt{s}$	16.5	20"	4'-0"	7'-3"	7'-7"	1'-8"	9'-0"	#6 @ 12''	#7 @ 6''	<b>#</b> 6 @ 6''	18-#5 T&B	#7 @ 6"	Sta. 0+95 to 1+05

Amerdrain 500 🔼 Geocomposite Drain Board

#### *Notes:*

2" CIr.

-Z Bar

└─#4 @ 12"

-2-#4 Cont.

- 1. Care shall be taken to ensure no damage is caused to adjacent structures. If damage occurs to adjacent structures, the contractor shall replace structures to pre-construction conditions at no cost to the State.
- 2. Grate open area shall be a minimum of 25.2 in2 and be accepted by the Engineer.

TYPICAL RETAINING WALL SECTION SCALE: 3/4" = 1'-0"

3" Clr.

3,

Bars in Same Plane

Bend 2'-0" Min.


# LEGEND FOR

# AS-BUILT POSTINGS

Squiggly line for as-built deletion **√√√** <del>100.00</del>

Roadway

Double line for as-built deletion Text for as-built Sand K. Feynand-30-08 posting

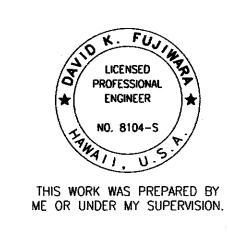

EXPIRATION DATE OF THE LICENSE

2/19/10 /2 As Built DATE REVISION

> STATE OF HAWAI'I
> DEPARTMENT OF TRANSPORTATION HIGHWAYS DIVISION

# TYPICAL RETAINING WALL SECTION - KUAMOO ROAD

Kaumualii Highway, Kuhio Highway ★ Kuamoo Road Retaining Walls Project No. HWY-K-01-03

Scale: AS NOTED SHEET No. \$3.1

Date: MAY 2008 OF 9 SHEETS