



FED. ROAD DIST. NO.	STATE	PROJ. NO.	FISCAL YEAR	SHEET NO.	TOTAL SHEETS
HAWAII	HAW.	HWY-K-03-98	2001	113	150

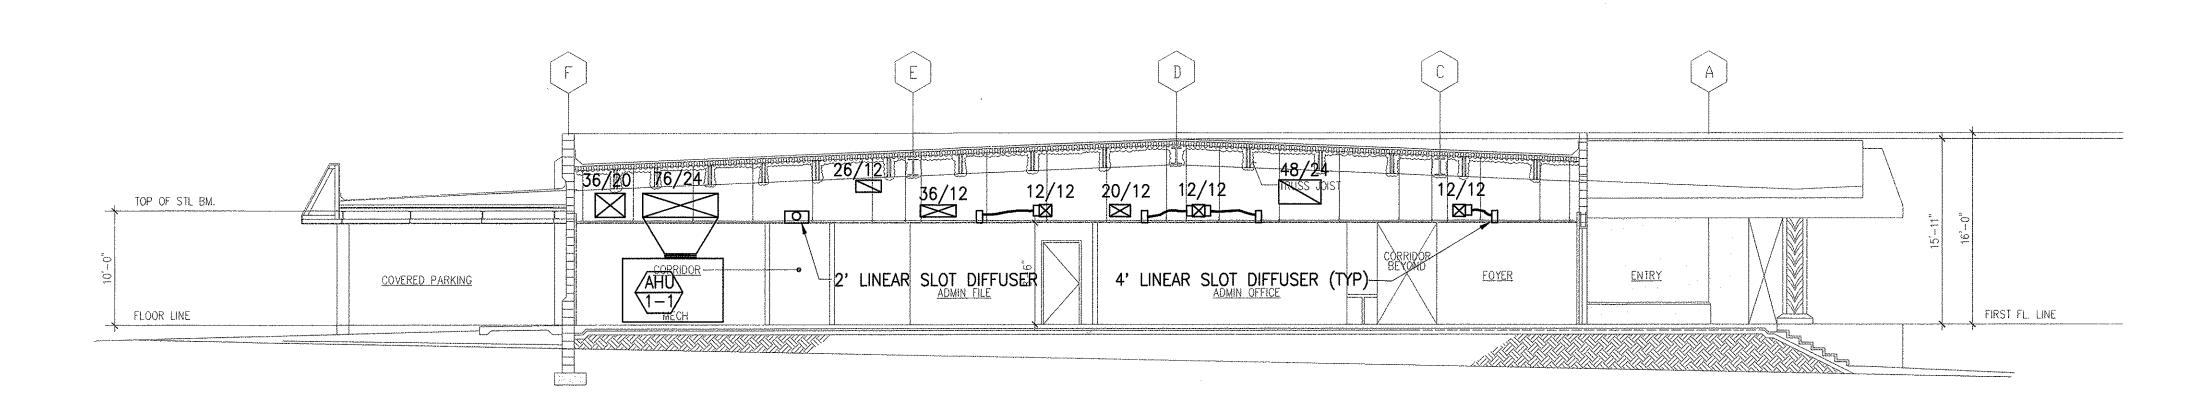

<u>SECTION</u> SCALE: 1/8"=1'-0"

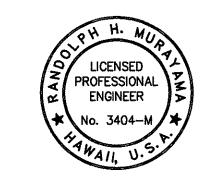

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STATE OF HAWAII DEPARTMENT OF TRANSPORTATION HIGHWAYS DIVISION


CENTRALIZED DISTRICT OFFICE AND BASEYARD COMPLEX LIHUE, KAUAI PROJECT NO. HWY-K-03-98


ADMINISTRATION BUILDING SECTIONS

SCALE: AS NOTED

DATE:MARCH 30, 01

SHEET NO. M2.04 OF 150 SHEETS

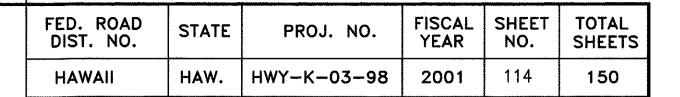

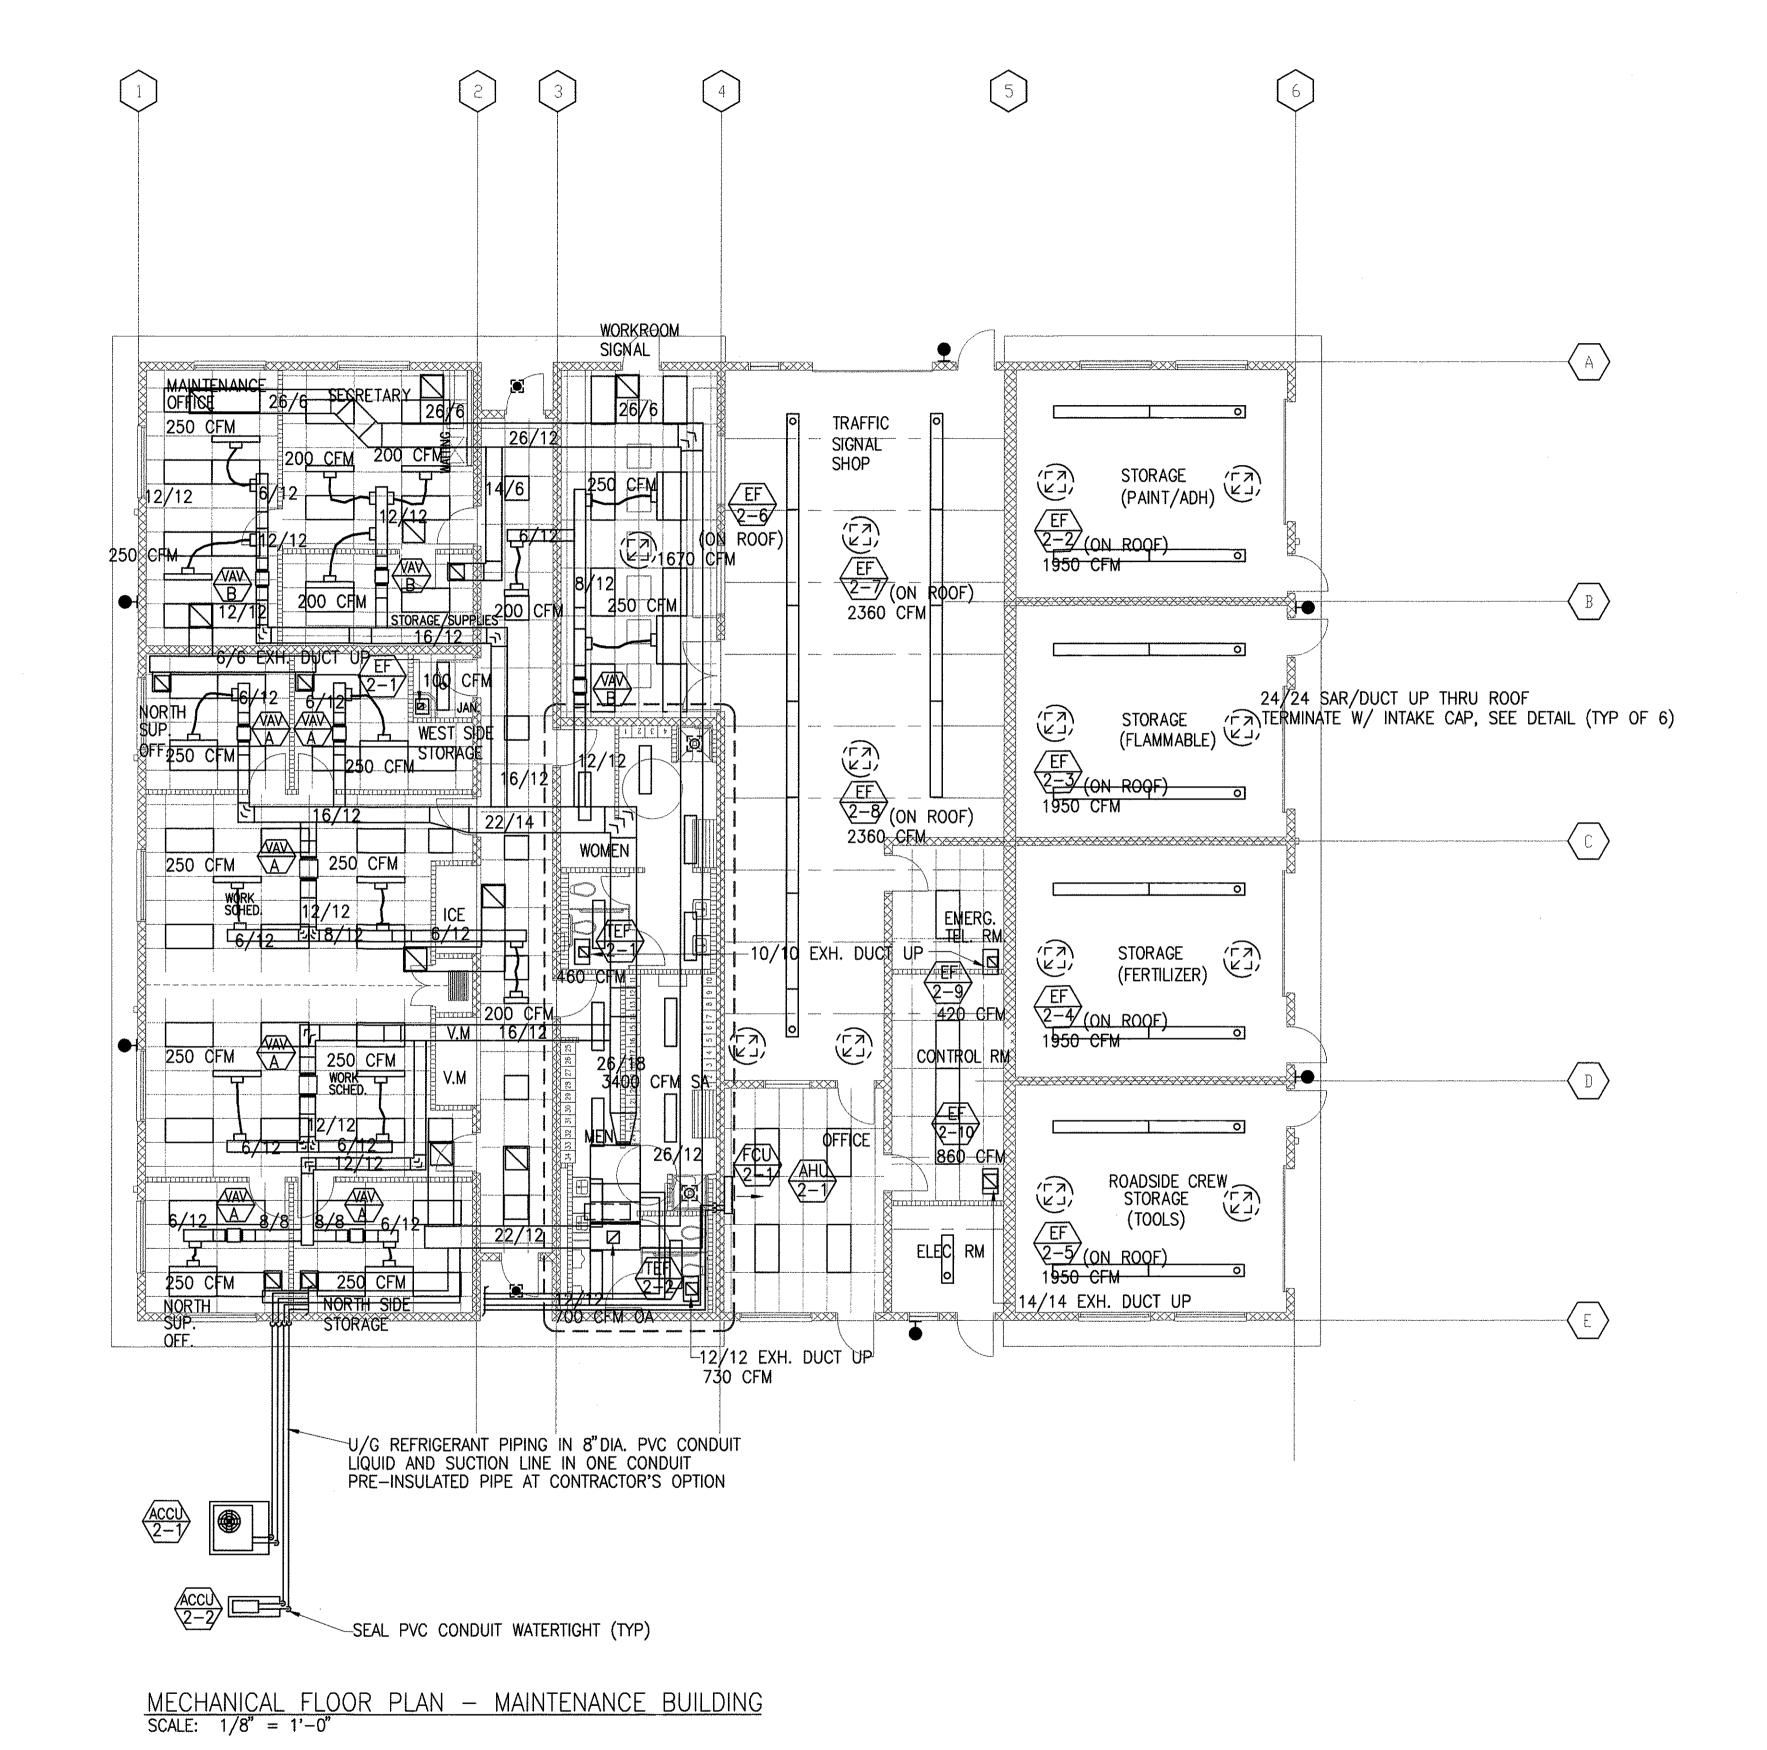

LICENSED PROFESSIONAL ENGINEER
No. 3404-M

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SIGNATURE

DEPARTMENT OF TRANSPORTATION
HIGHWAYS DIVISION

CENTRALIZED DISTRICT OFFICE

AND BASEYARD COMPLEX

LIHUE, KAUAI


PROJECT NO. HWY-K-03-98

MAINTENANCE BUILDING


MECHANICAL FLOOR PLAN

SCALE: AS NOTED DATE: MARCH 30, 01


SHEET NO. M3.01 OF 150 SHEETS

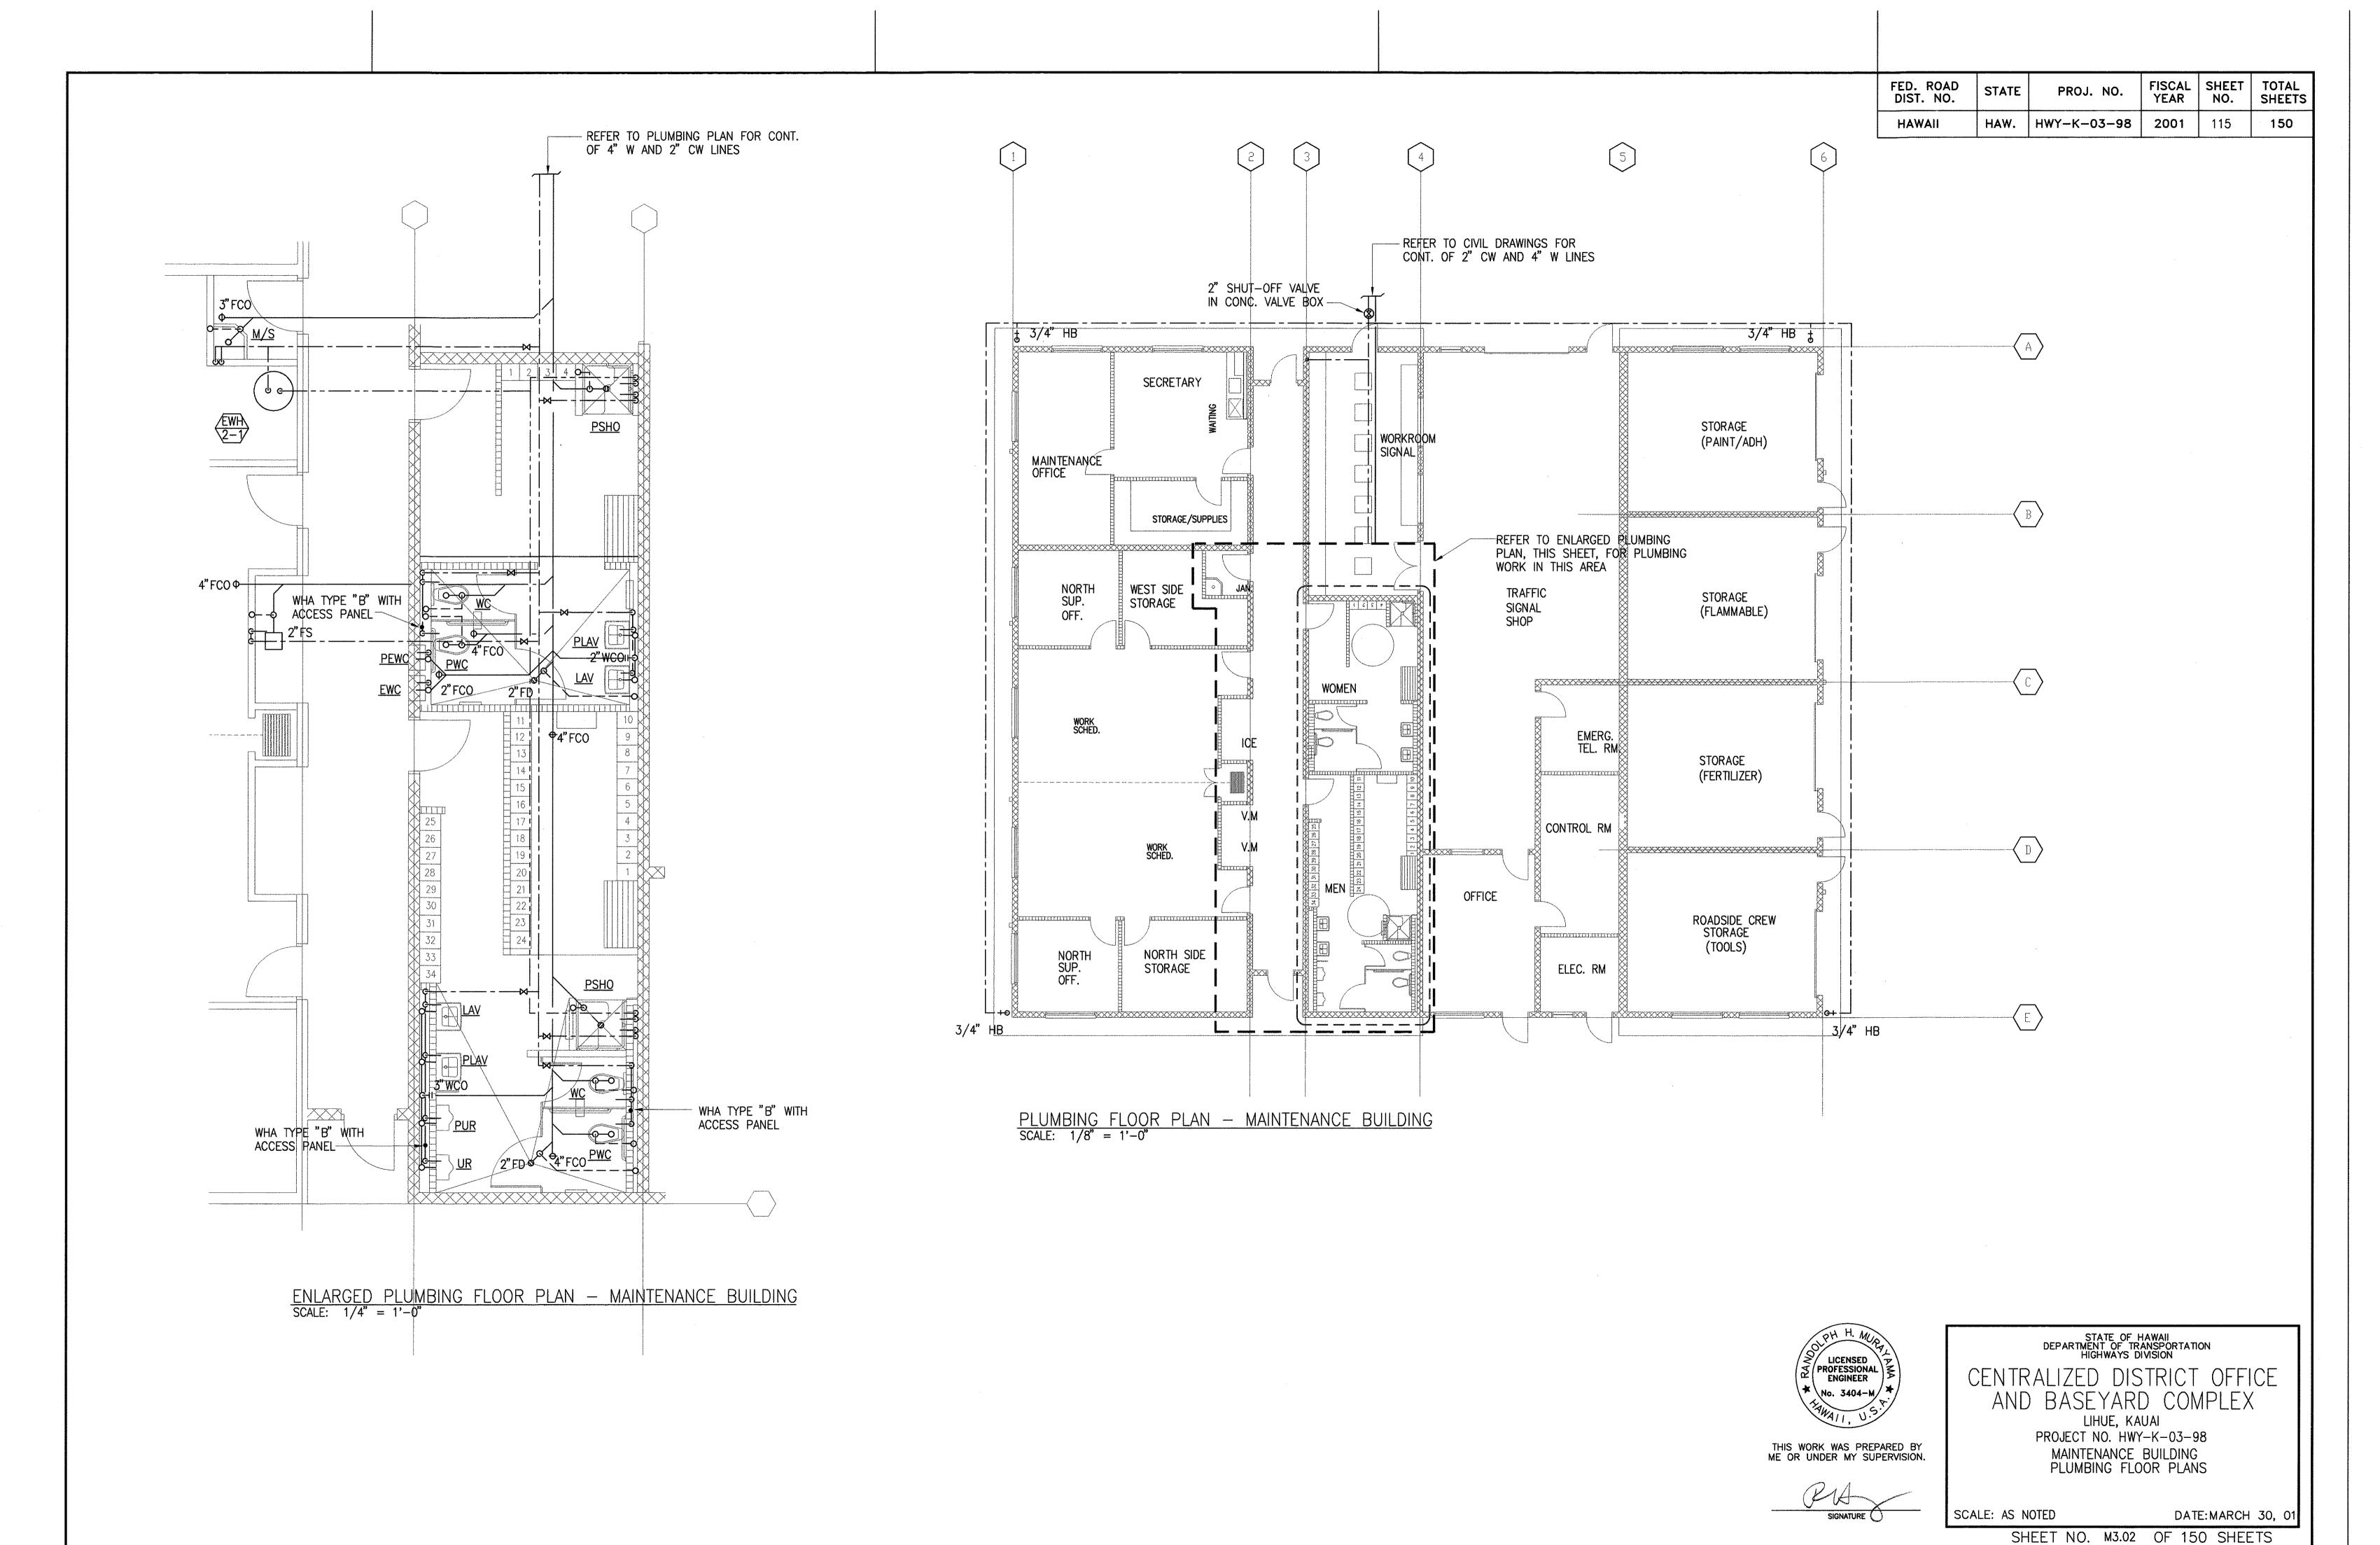


·	FED. ROAD DIST. NO.	STATE	PROJ. NO.	FISCAL YEAR	SHEET NO.	TOTAL SHEETS
	HAWAII	HAW.	HWY-K-03-98	2001	116	150

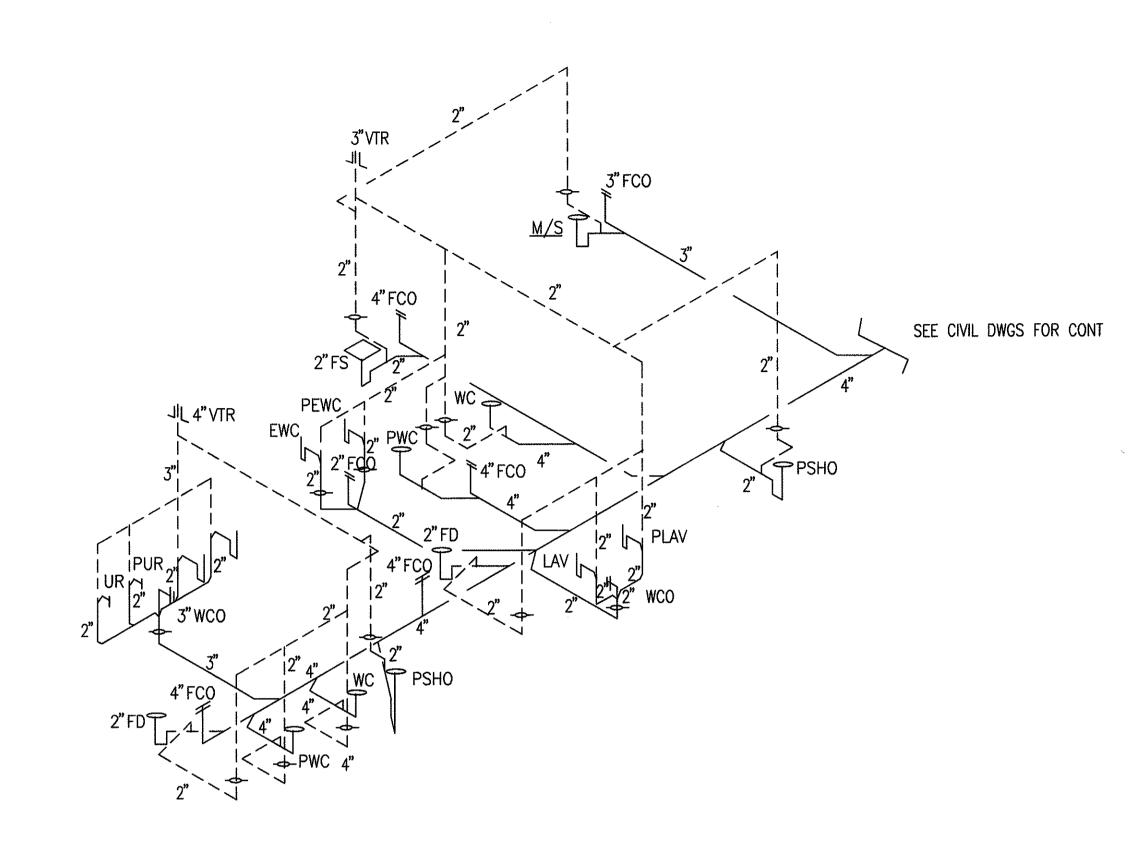

WASTE AND VENT PIPING DIAGRAMS

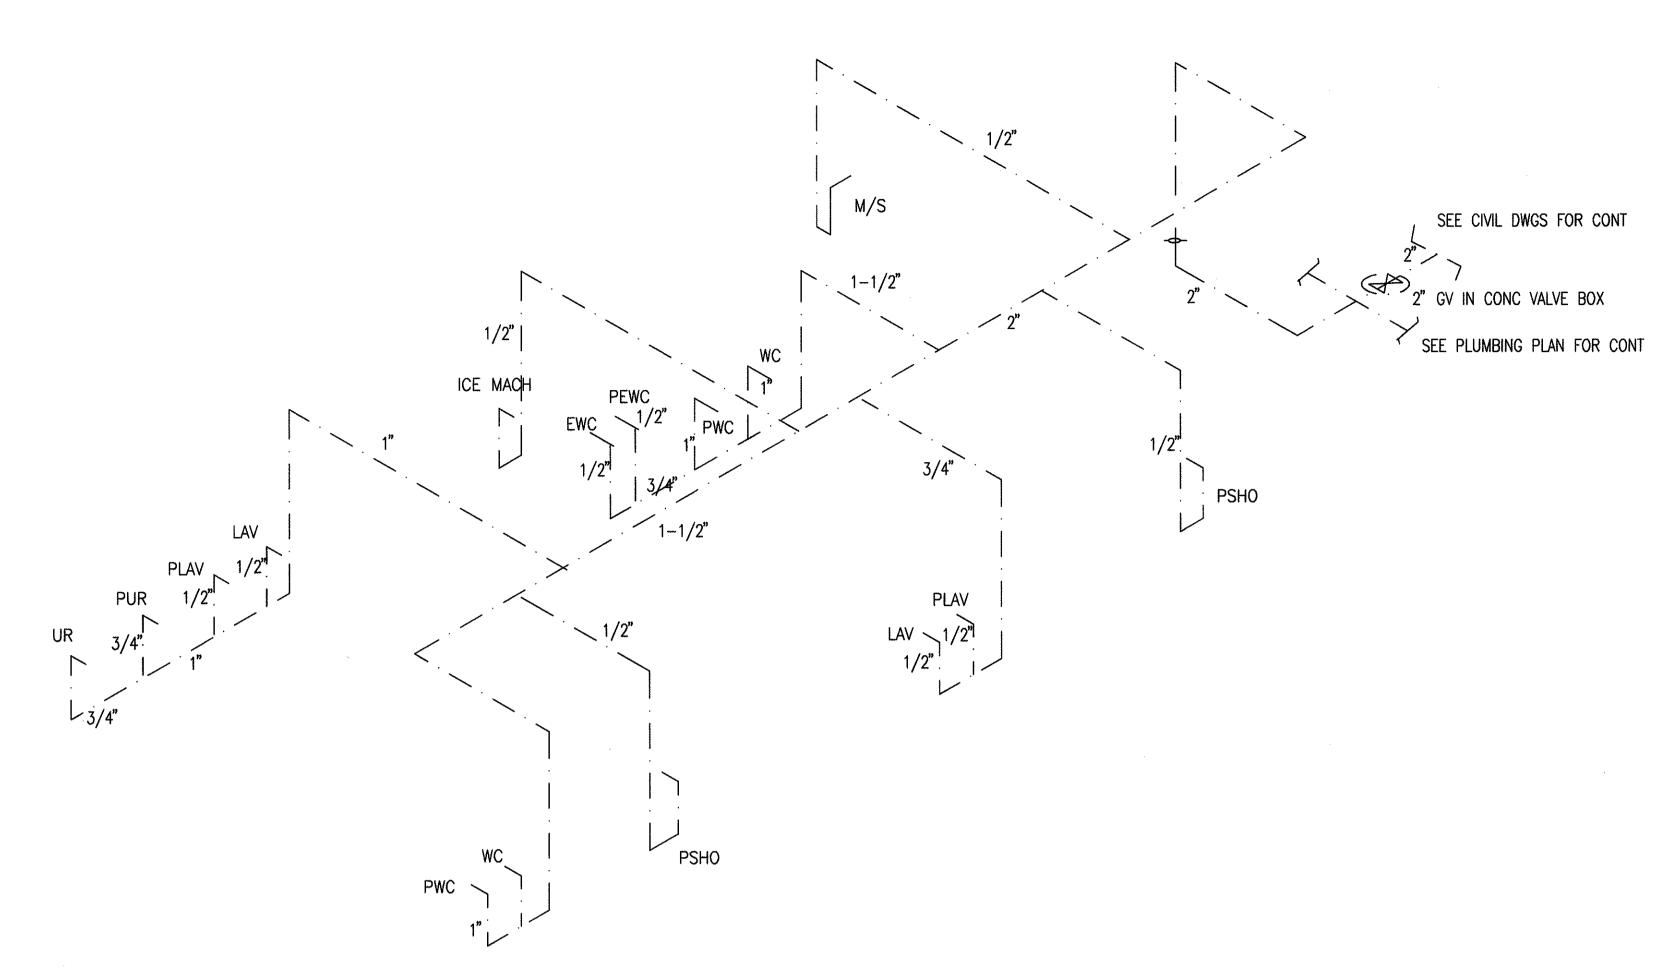

HOT AND COLD WATER PIPING DIAGRAMS

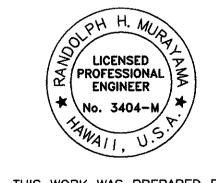

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STATE OF HAWAII DEPARTMENT OF TRANSPORTATION HIGHWAYS DIVISION

CENTRALIZED DISTRICT OFFICE AND BASEYARD COMPLEX

LIHUE, KAUAI
PROJECT NO. HWY-K-03-98
MAINTENANCE BUILDING
PLUMBING DIAGRAMS


SCALE: AS NOTED

DATE:MARCH 30, 01


SHEET NO. M3.03 OF 150 SHEETS

116

FED. ROAD DIST. NO.	STATE	PROJ. NO.	FISCAL YEAR	SHEET NO.	TOTAL SHEETS
HAWAII	HAW.	HWY-K-03-98	2001	117	150

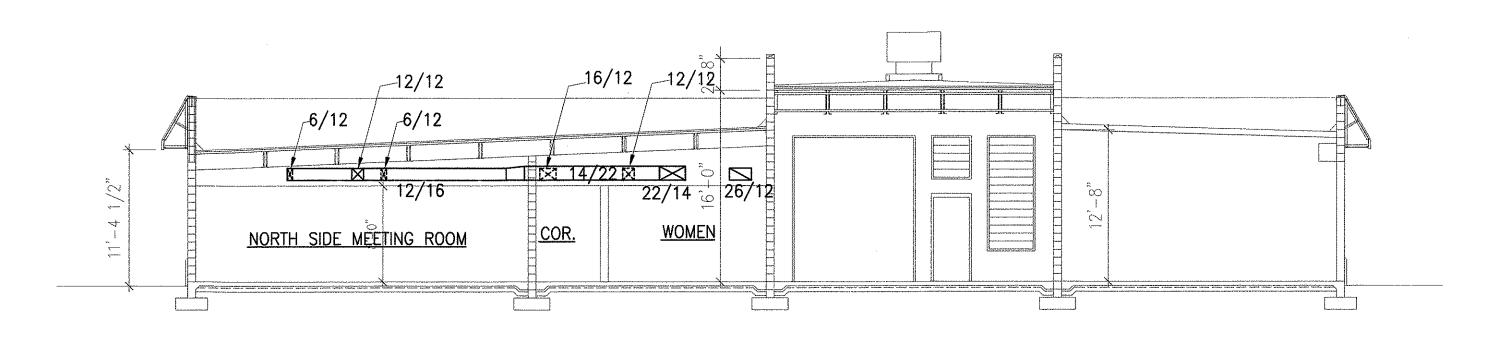

SECTION SCALE: 1/8"=1'-0"

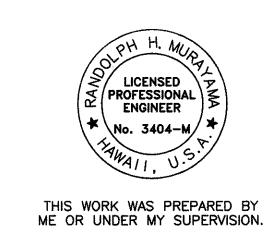

Q 1 SIGNATURE

STATE OF HAWAII DEPARTMENT OF TRANSPORTATION HIGHWAYS DIVISION


CENTRALIZED DISTRICT OFFICE AND BASEYARD COMPLEX

LIHUE, KAUAI
PROJECT NO. HWY-K-03-98
MAINTENANCE BUILDING
MECHANICAL SECTIONS

SCALE: AS NOTED

DATE:MARCH 30, 01

SHEET NO. M3.04 OF 150 SHEETS

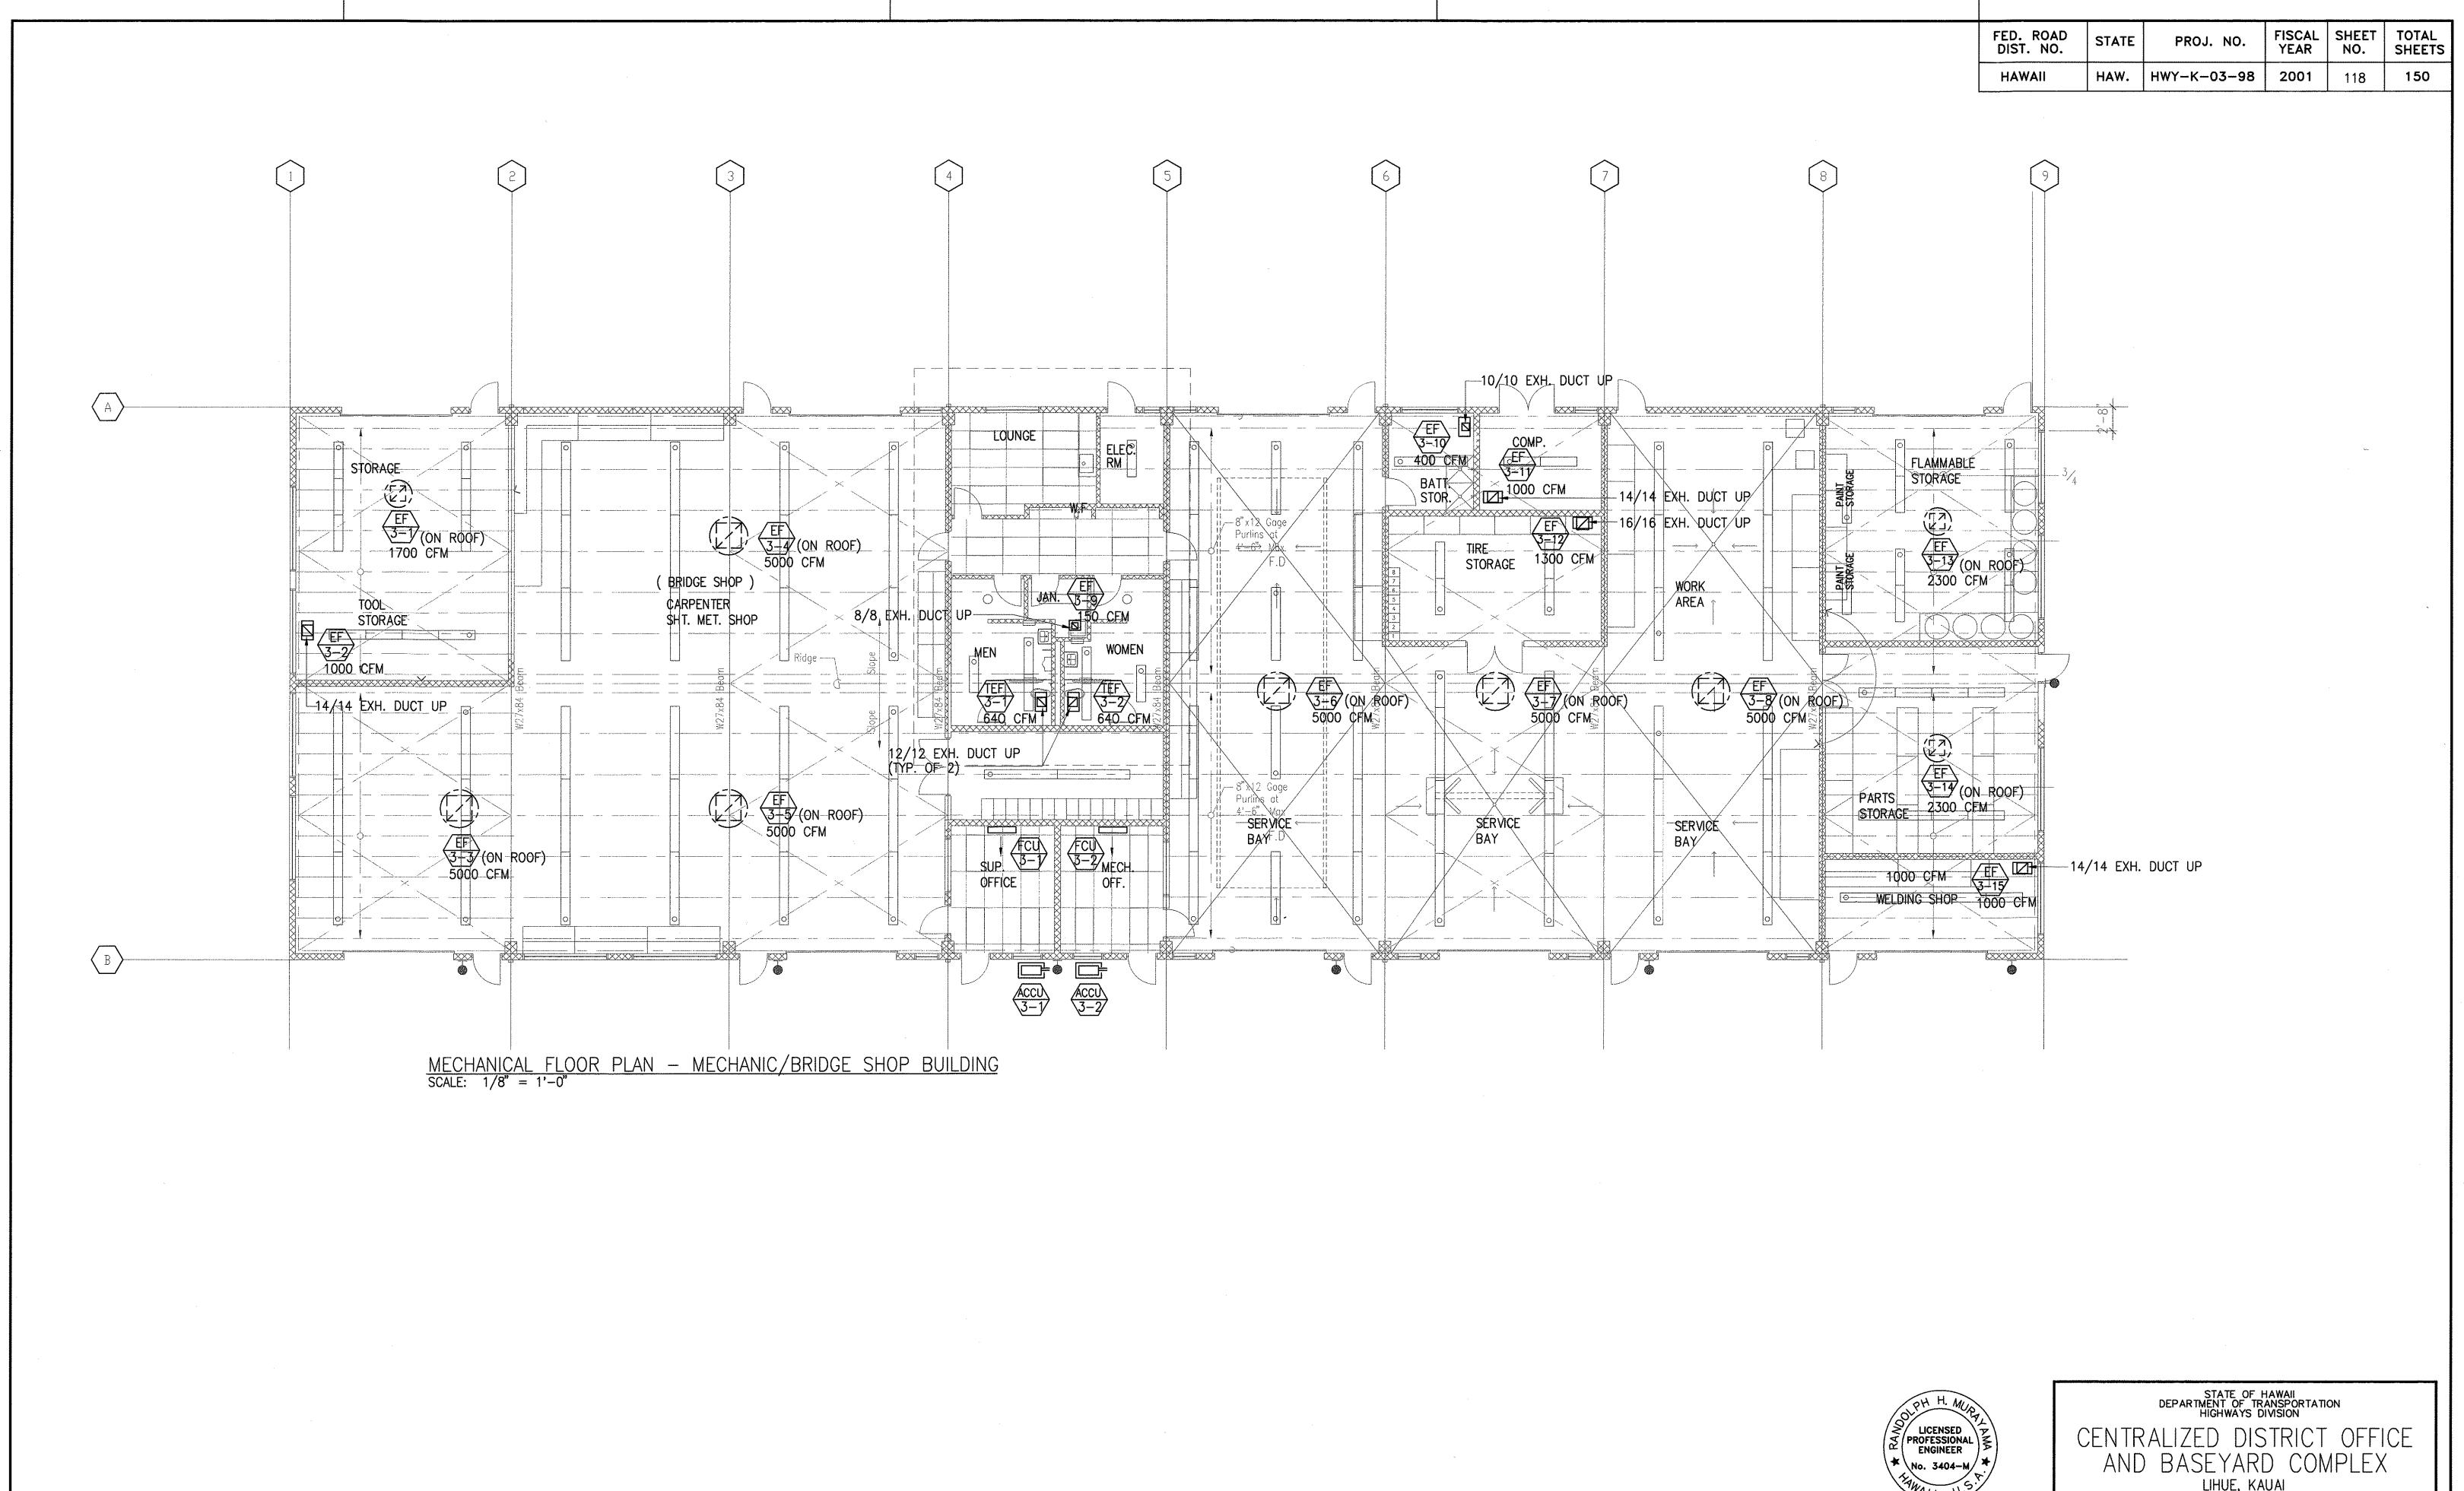



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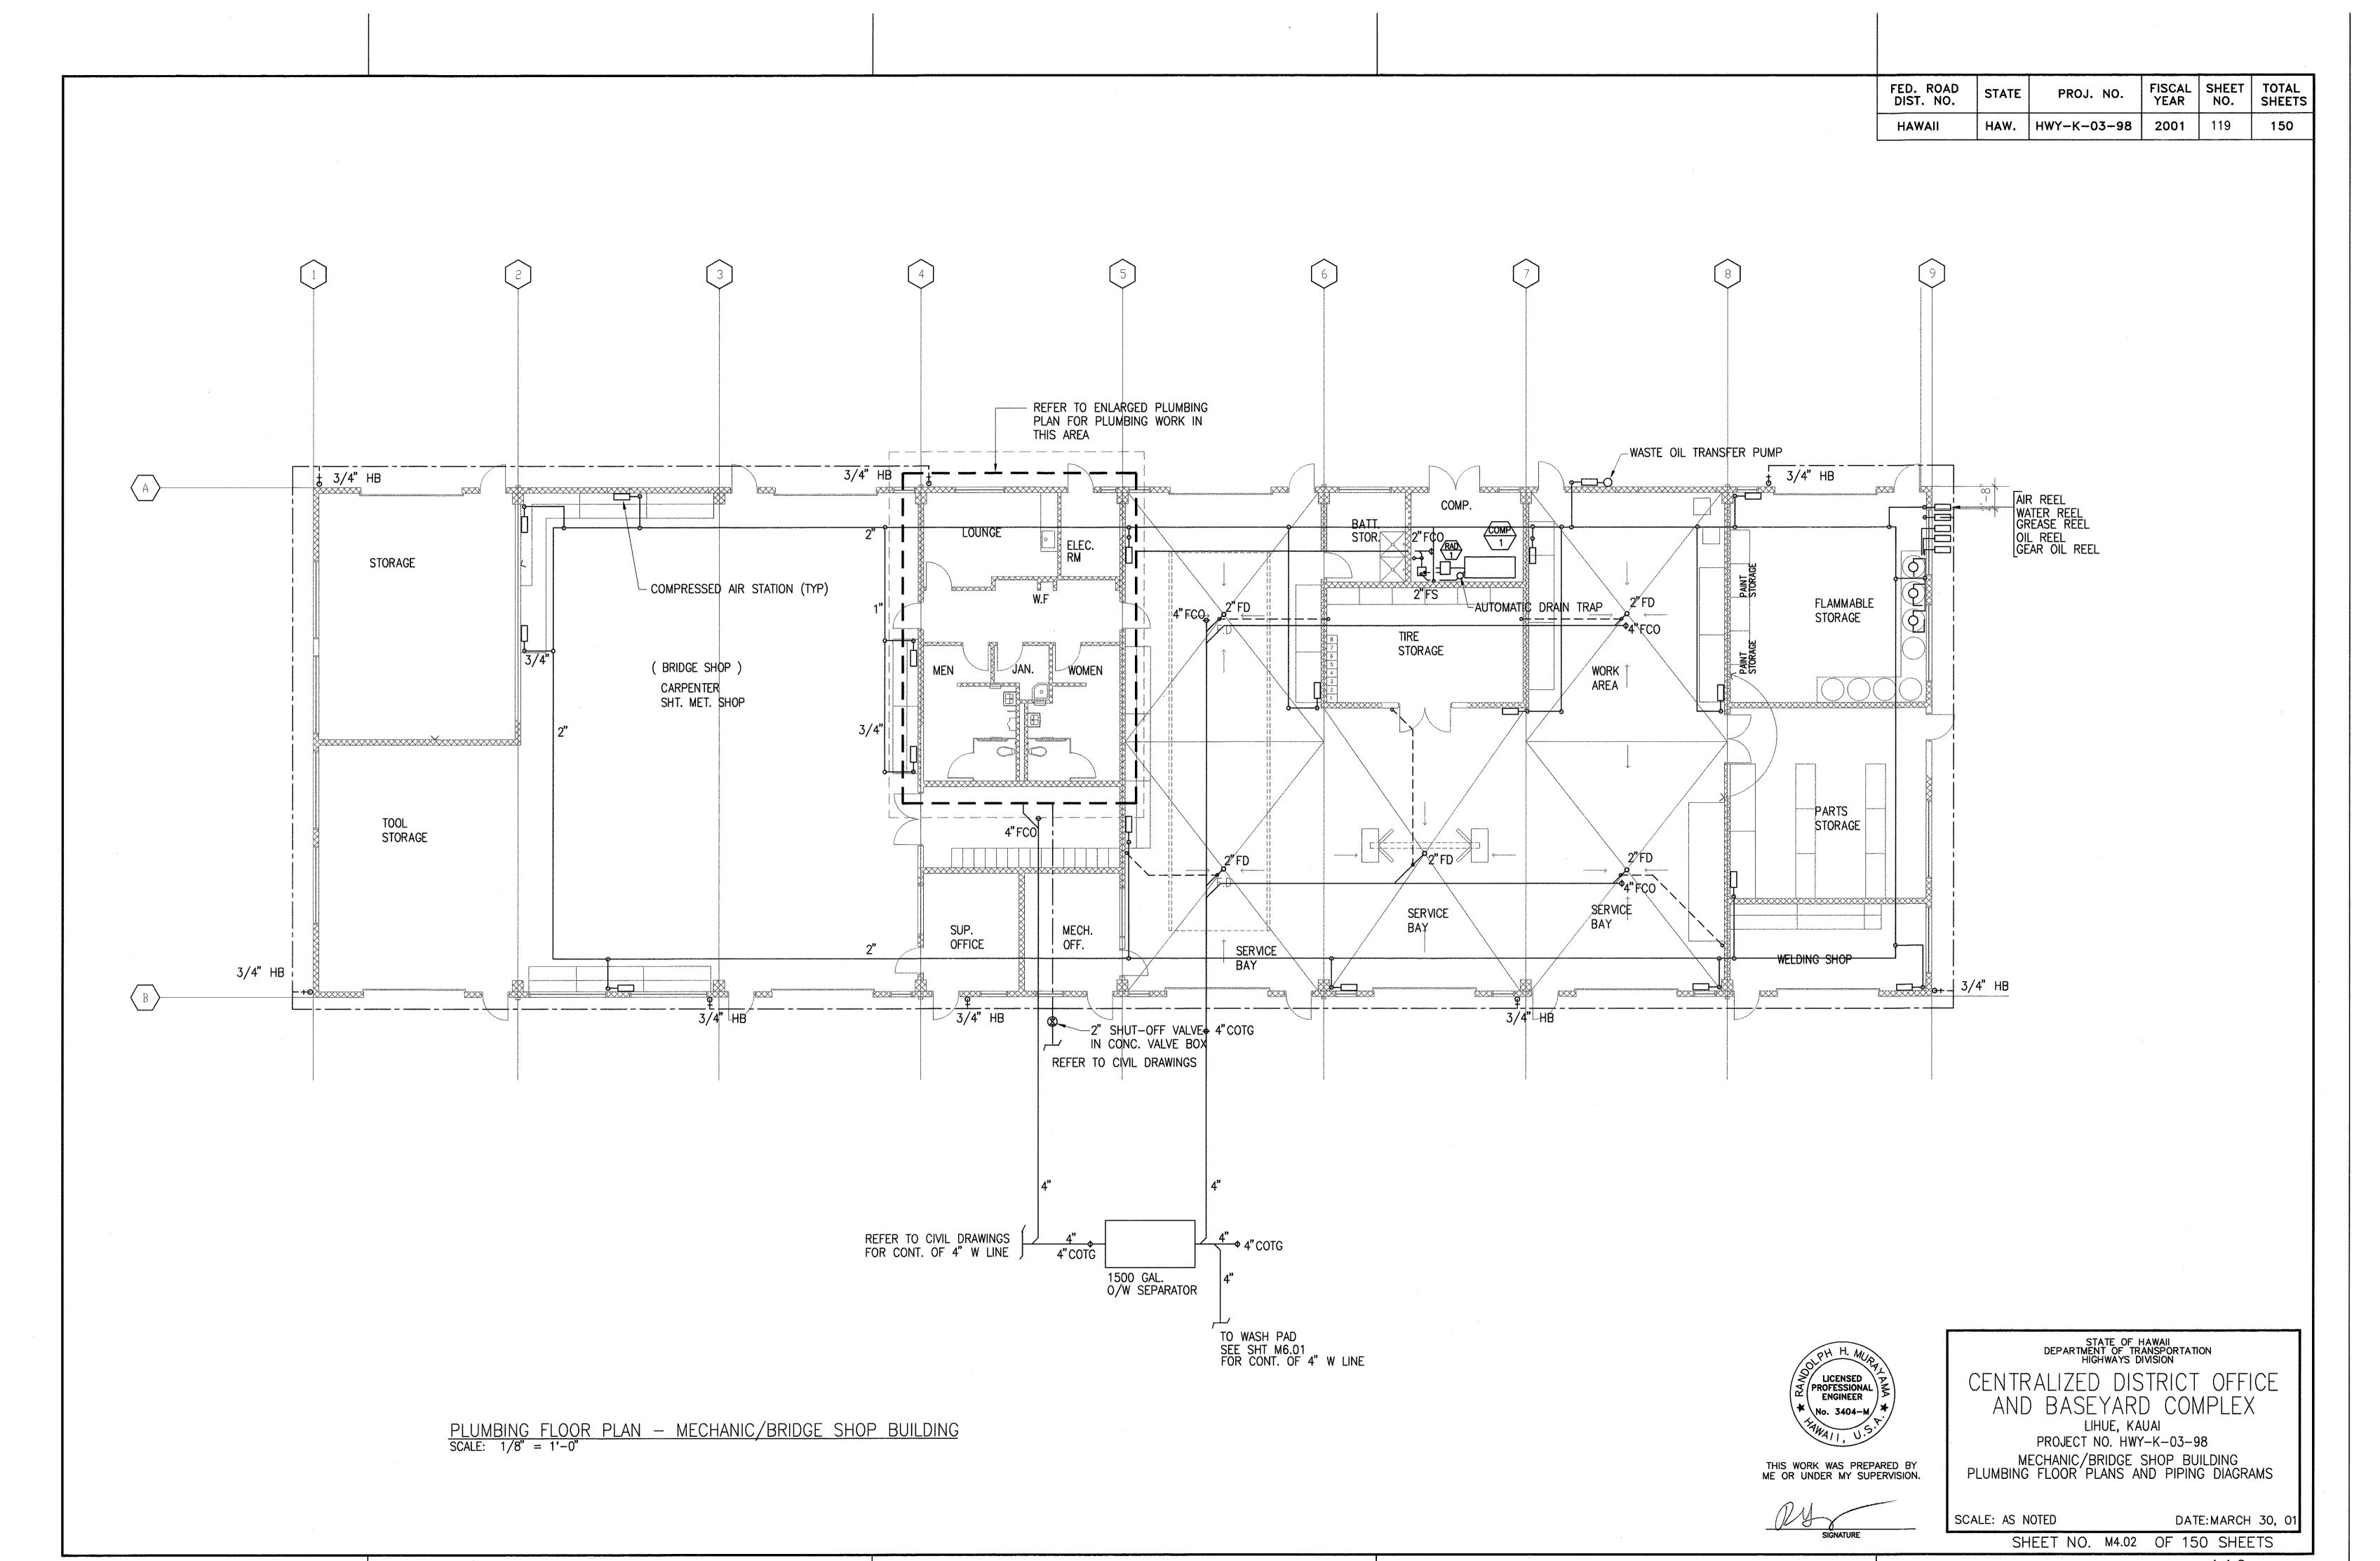
LIHUE, KAUAI PROJECT NO. HWY-K-03-98


MECHANIC/BRIDGE SHOP BUILDING MECHANICAL FLOOR PLAN


SCALE: 1/8" = 1'-0"

DATE:MARCH 30, 01


SHEET NO. M4.01 OF 150 SHEETS



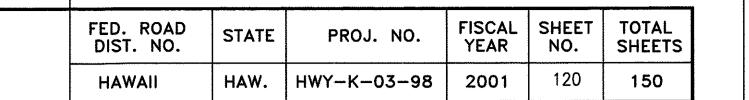

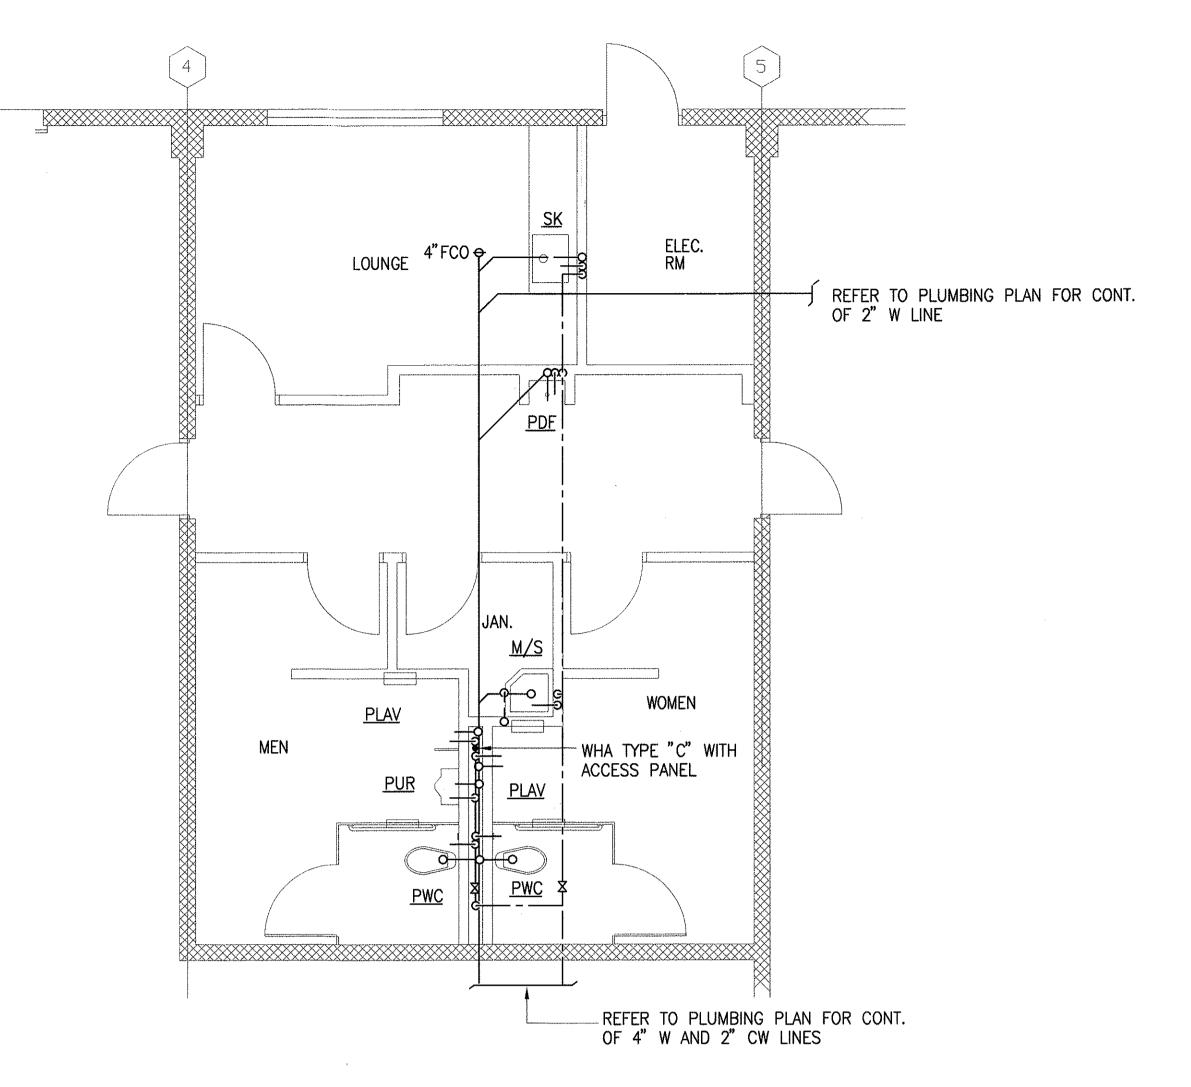

MECHANIC/BRIDGE SHOP BUILDING — ENLARGED PLUMBING FLOOR PLAN SCALE: 1/4" = 1'-0"

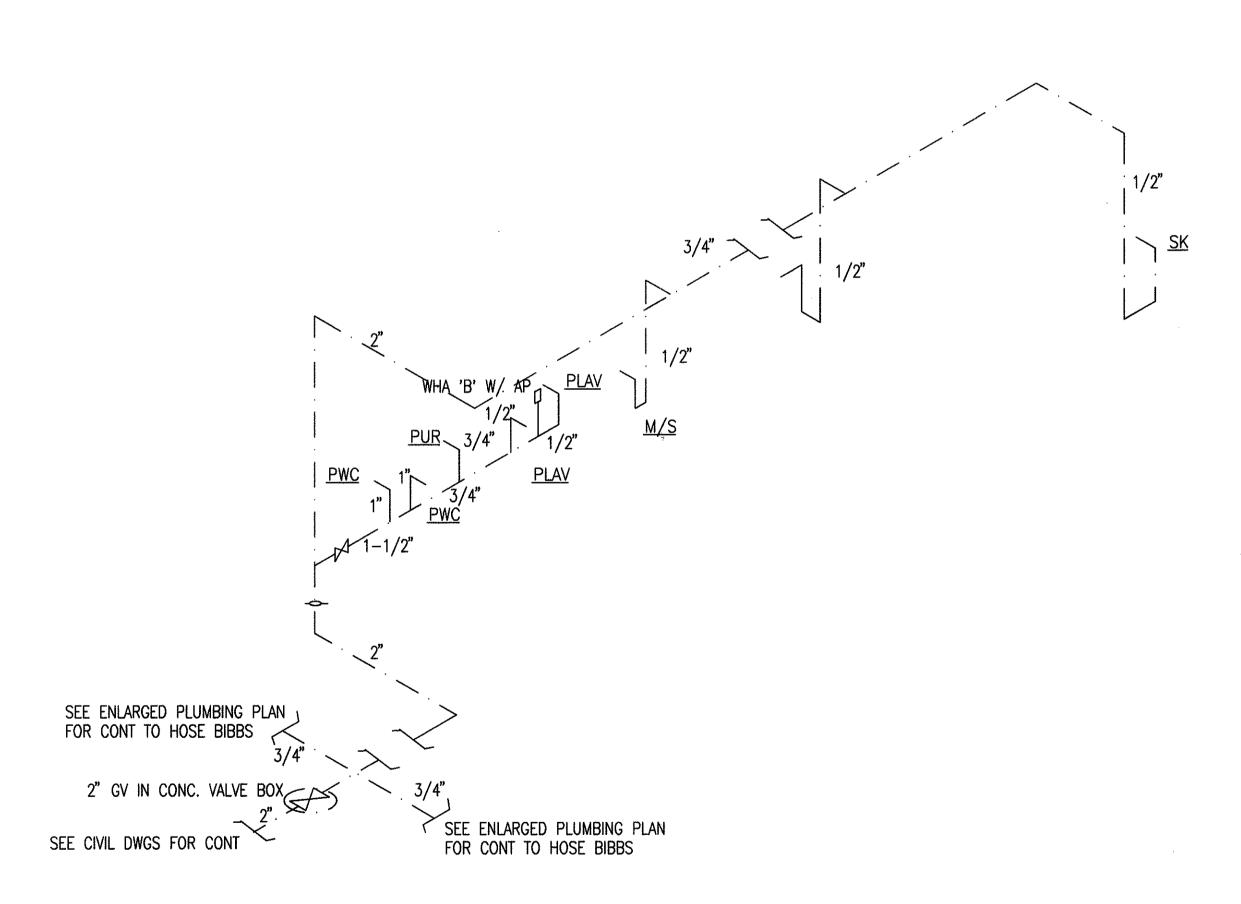

WATER PIPING DIAGRAMS




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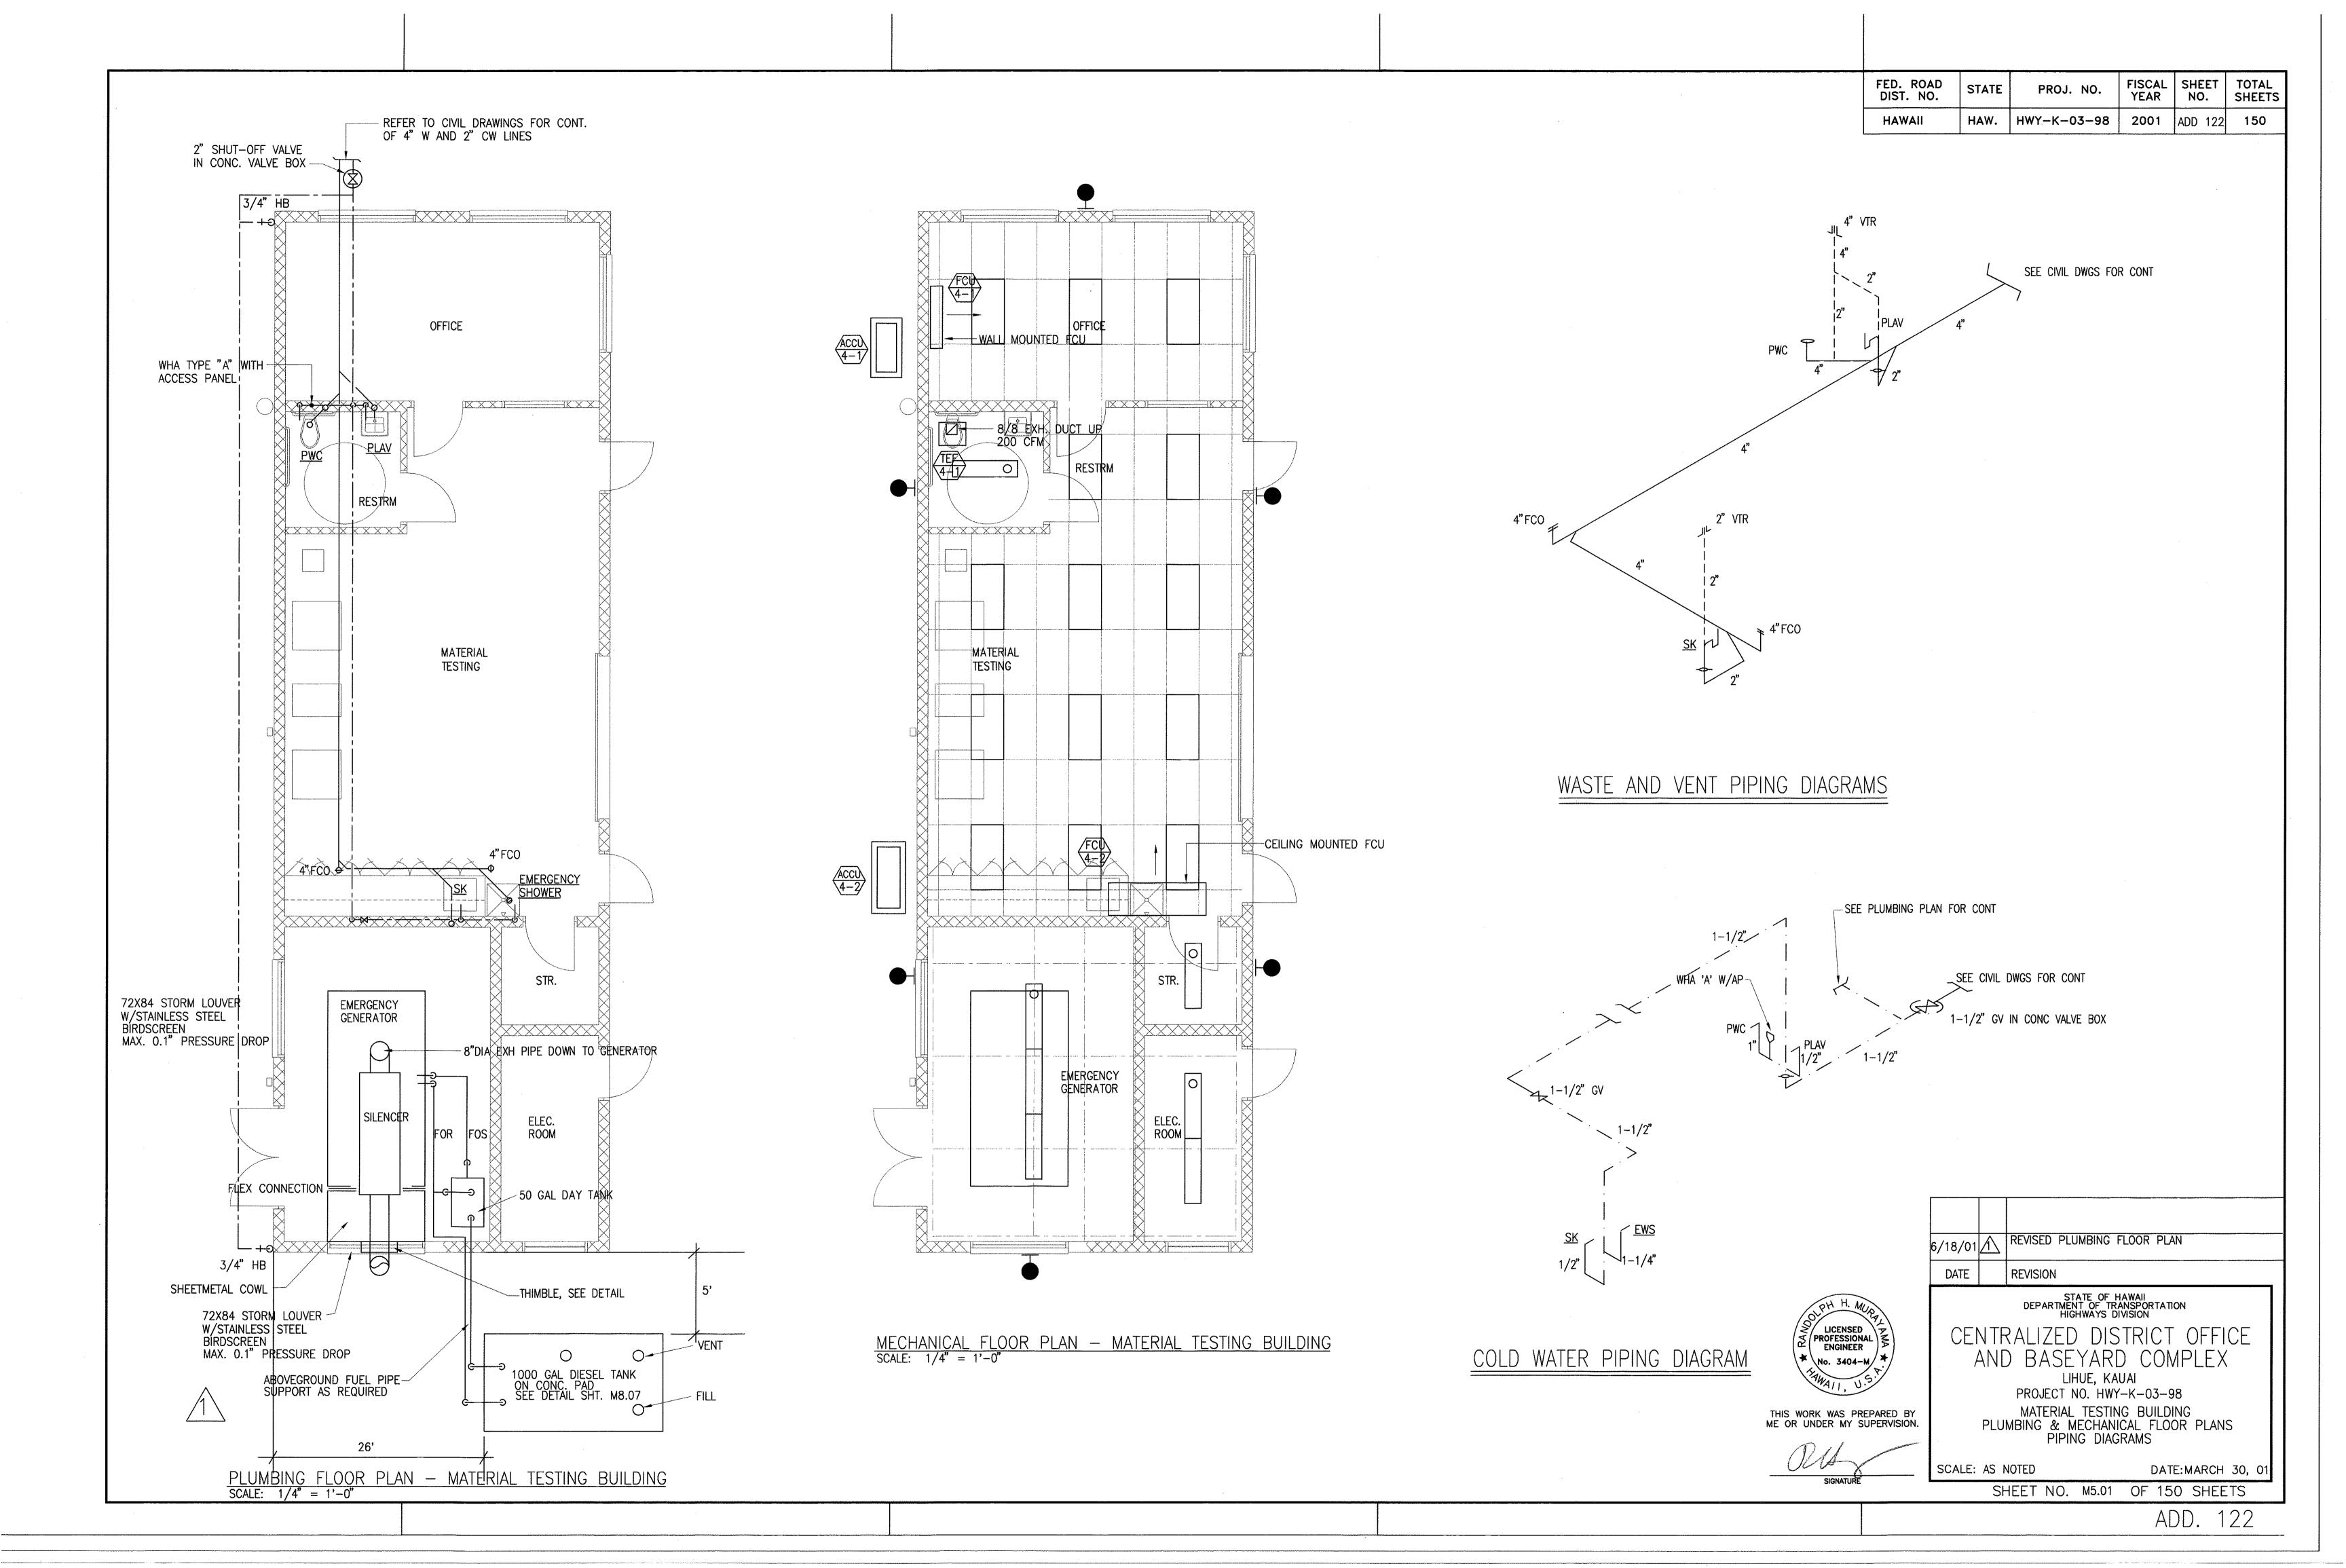
STATE OF HAWAII DEPARTMENT OF TRANSPORTATION HIGHWAYS DIVISION CENTRALIZED DISTRICT OFFICE
AND BASEYARD COMPLEX
LIHUE, KAUAI
PROJECT NO. HWY-K-03-98
MECHANIC/BRIDGE SHOP BUILDING
PARTIAL PLUMBING PLAN, PIPING DIAGRAMS


SCALE: AS NOTED

DATE:MARCH 30, 01

SHEET NO. M4.03 OF 150 SHEETS



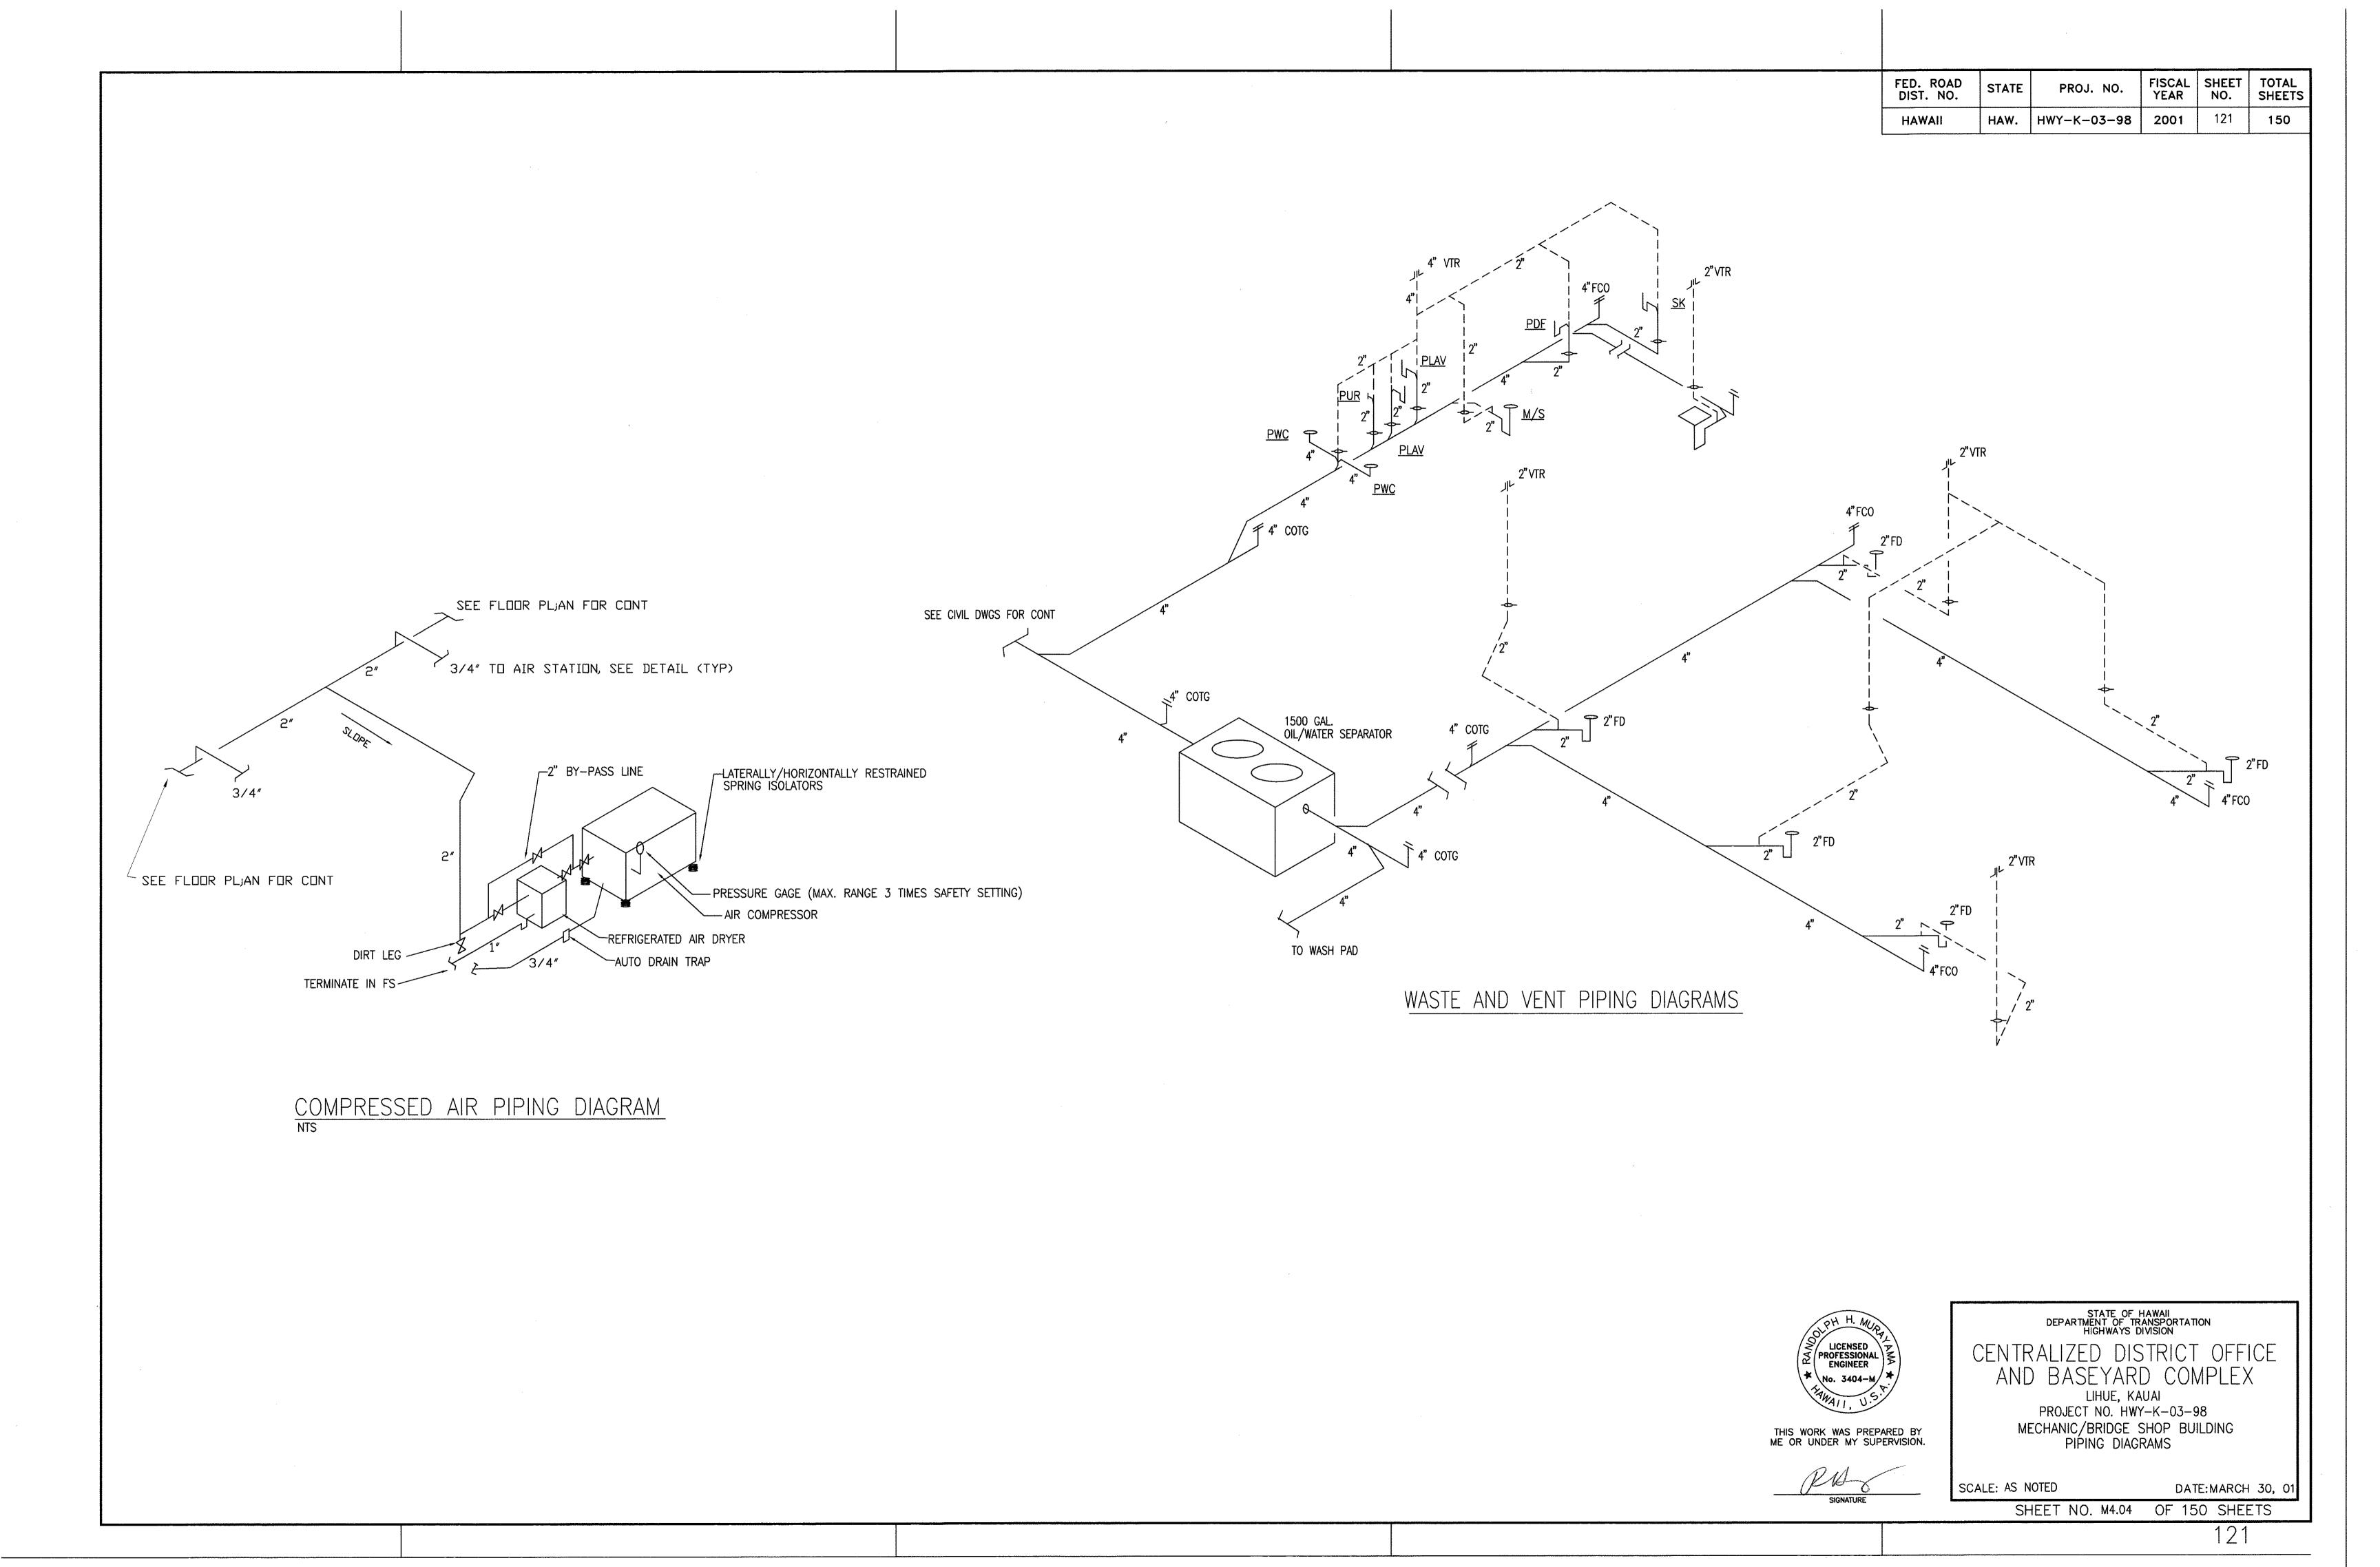

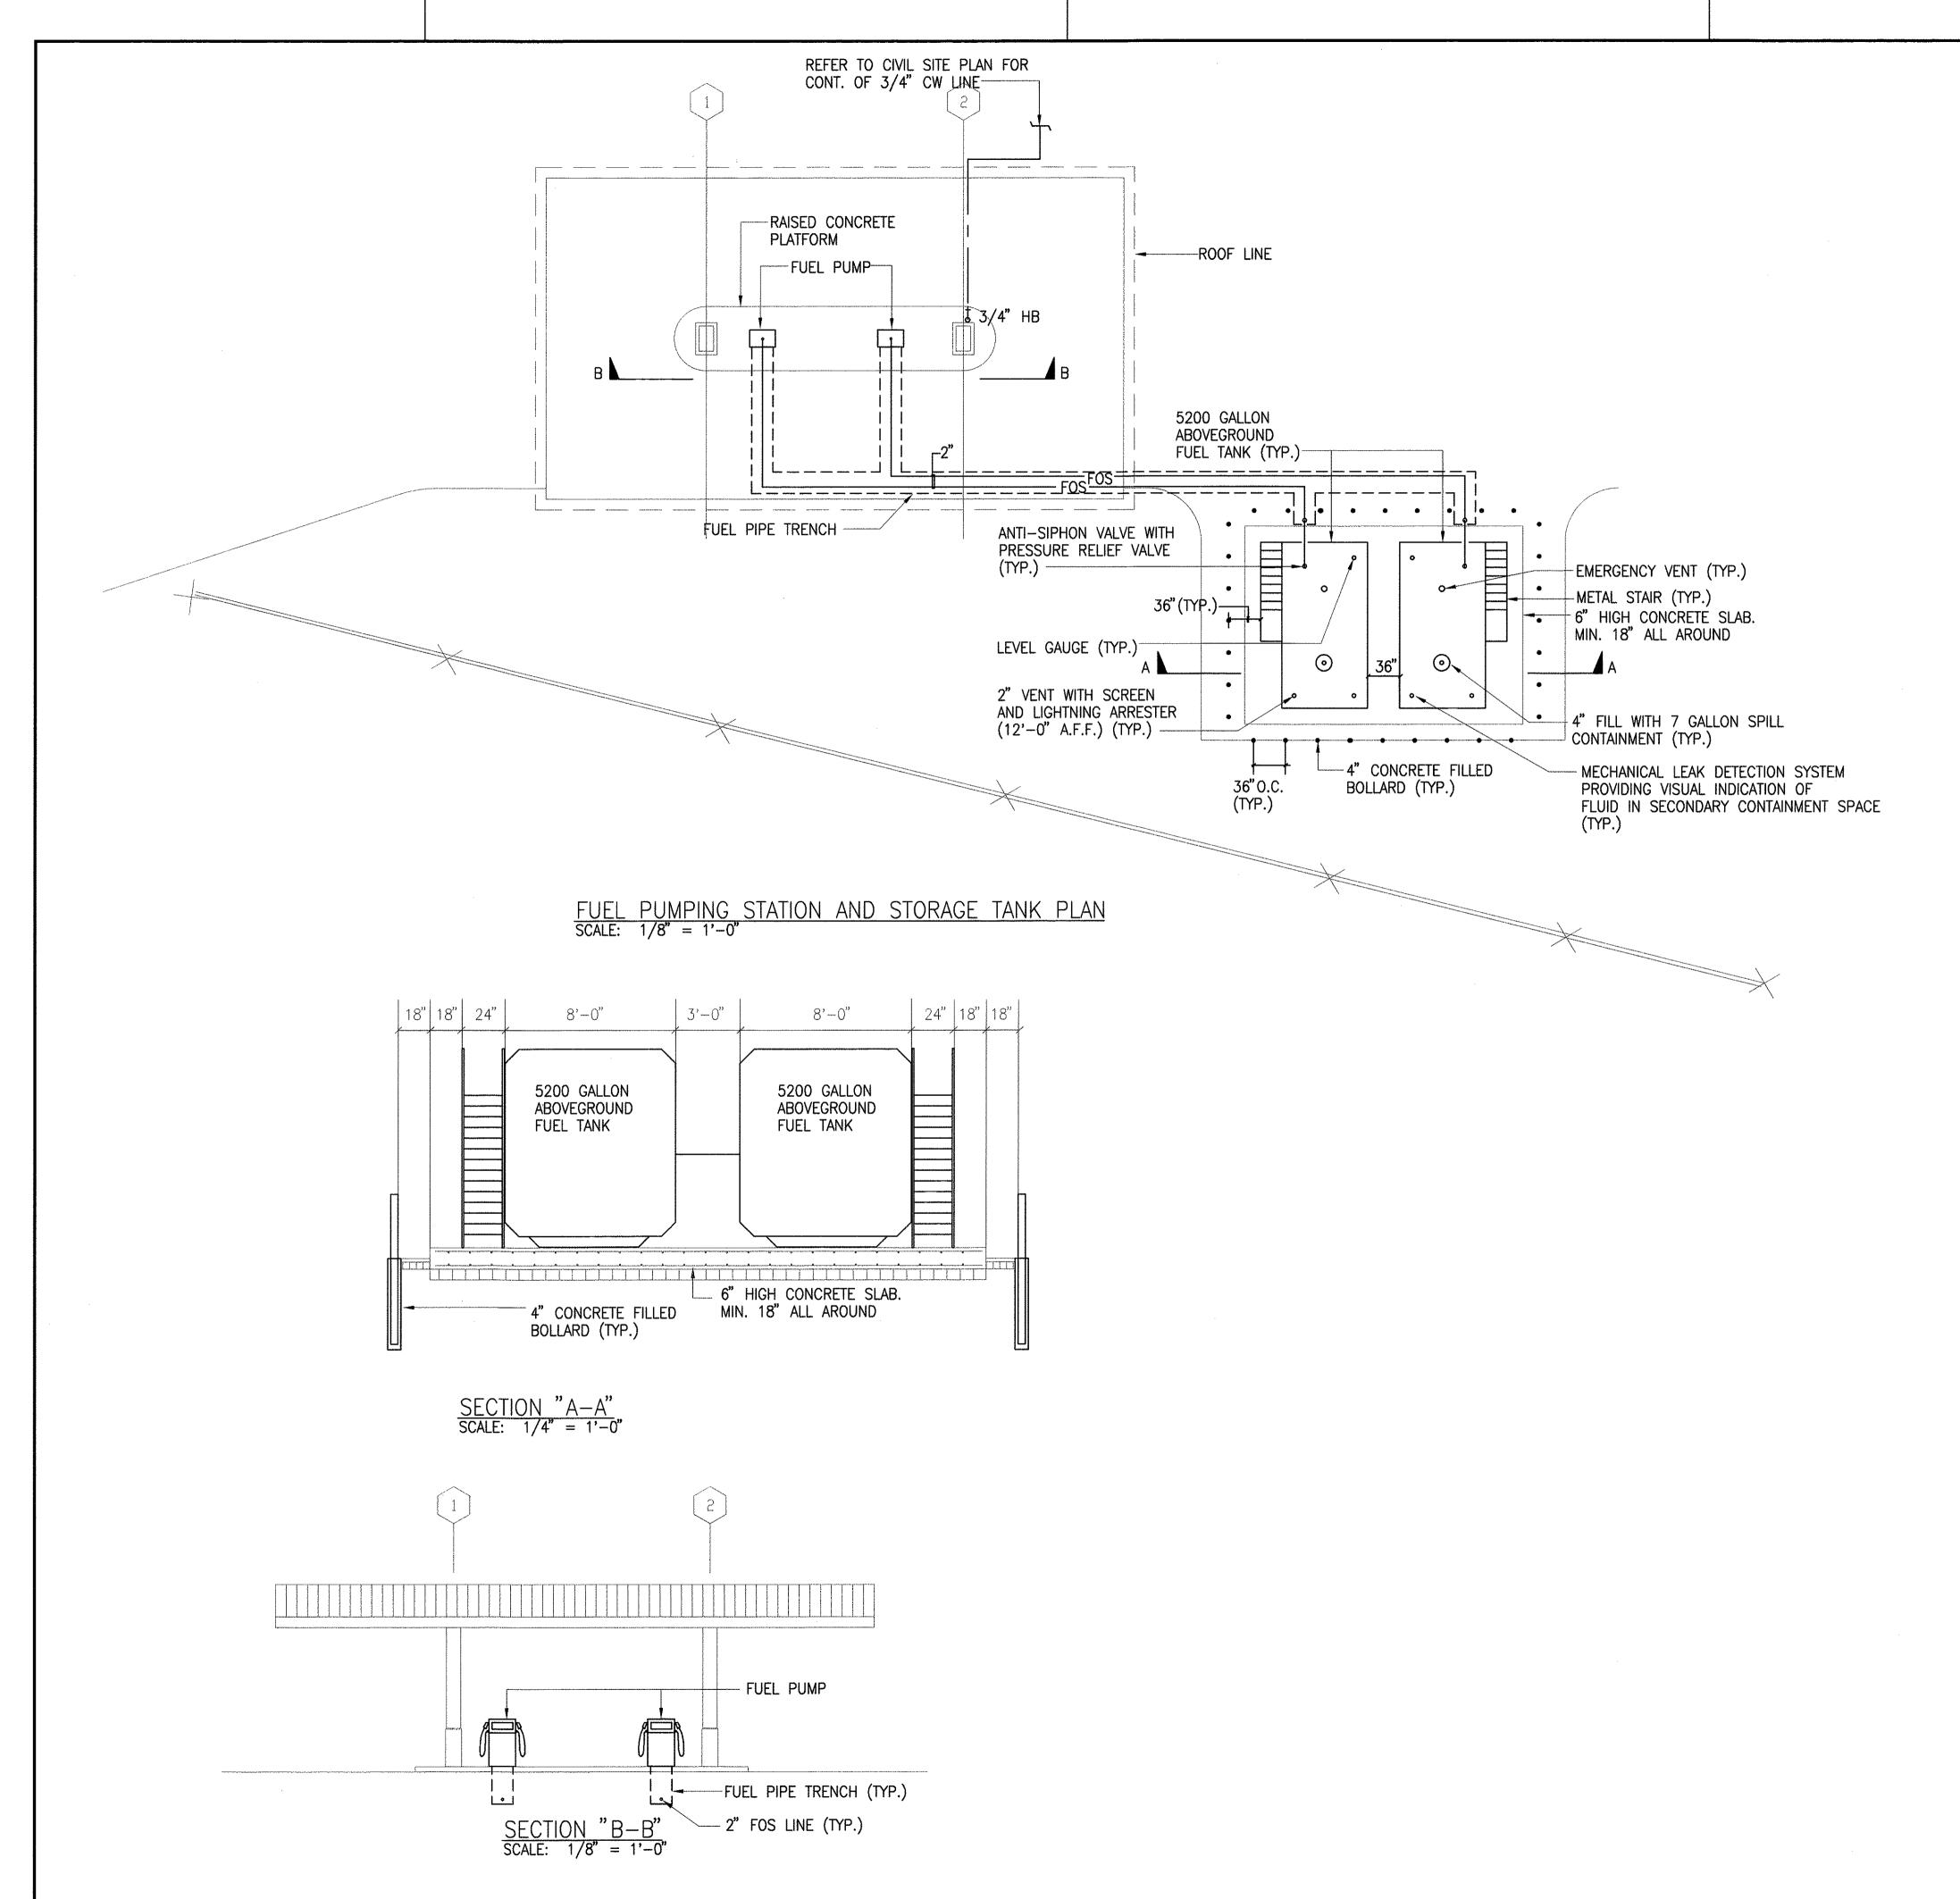

FED. ROAD<br/>DIST. NO.STATEPROJ. NO.FISCAL<br/>YEARSHEET<br/>NO.TOTAL<br/>SHEETSHAWAIIHAW.HWY-K-03-982001123150

**INSTALLATION NOTES:** 

THE CONTRACTOR SHALL FURNISH ALL EQUIPMENT AND MATERIALS AND PROVIDE ALL LABOR FOR INSTALLATION OF THE FUEL STORAGE TANKS AND FUEL DISPENSING AND TICKETING SYSTEM SHOWN ON PLANS, COMPLETE IN PLACE, AND READY FOR OPERATION.

AFTER COMPLETING THE INSTALLATION, THE CONTRACTOR SHALL TEST THE FUEL STORAGE AND FUEL DISPENSING AND TICKETING SYSTEM AND SHALL MAKE THE NECESSARY ADJUSTMENTS, REPLACEMENTS AND/OR CORRECTIONS TO INSURE SAFE AND PROPER OPERATION OF THE ENTIRE SYSTEM.


- 2. INSTALLATION SHALL COMPLY WITH APPLICABLE COUNTY, STATE AND FEDERAL REGULATIONS AND GUIDELINES.
- 3. ABOVEGROUND FUEL TANKS SHALL BE CONVAULT 5000 GALLON TANKS, OR APPROVED EQUAL. ALL TANK
  ACCESSORIES REQUIRED FOR A COMPLETE INSTALLATION SHALL BE INCLUDED. BOTH TANKS SHALL BE IDENTICAL
  AND SHALL BE DESIGNED TO BE FILLED FROM THE SAME END.
- 4. FUEL DISPENSERS SHALL BE BENNET FLEETMASTER, SELF—CONTAINED, SINGLE PRODUCT, TWIN PUMP STATIONS, OR APPROVED EQUALS. ALL DISPENSERS SHALL BE EQUIPPED WITH A TICKET PRINTING SYSTEM TO BE USED AS SPECIFIED IN THE SPECIAL PROVISIONS. (TICKET PRINTING SYSTEM SHALL BE COMPATIBLE FOR USE WITH THE SAMPLE TICKET SHOWN ON SHEET M8.07)

SERVICE HOSES SHALL BE 18' LONG (MIN.), U.L. LISTED WITH SAFETY BREAKAWAY CONNECTIONS. NOZZLES SHALL BE U.L. LISTED WITH AN AUTOMATIC SHUT-OFF VALVE. ALL ACCESSORIES AND COUPLING HARDWARE (SHEAR VALVES, ETC.) REQUIRED FOR THIS INSTALLATION SHALL BE U.L. LISTED.

- 5. CONCRETE FILLED PIPE GUARDS SALL BE INSTALLED AROUND THE FUEL STORAGE TANK AREA AS SHOWN ON THE PLANS. AFTER INSTALLATION, ALL PIPES SHALL BE CLEANED AND PAINTED WITH ONE COAT OF PRIMER AND TWO COATS OF YELLOW PAINT. STEEL POSTS INCLUDING CONCRETE FOUNDATIONS SHALL BE CONSIDERED INCIDENTAL TO ITEM NO. 678J006 ABOVEGROUND FUEL TANK, DISPENSING AND TICKETING SYSTEM.
- 6. SEISMIC TANKS RESTRAINTS SHALL BE GALVANIZED STEEL AND SHALL CONFORM TO THE MANUFACTURER'S SPECIFICATIONS. ALL BOLTS, NUTS AND WASHERS SHALL BE STAINLESS STEEL.
- 7. FOR ACCESS TO TOP OF FUEL TANKS, METAL STAIR UNITS SHALL BE INSTALLED AS SHOWN ON THE PLANS. STAIR UNITS SHALL BE CONVAULT MULTI—STEP MODEL OR AN APPROVED EQUAL, CONFORMING TO OSHA REQUIREMENTS AND SHALL BE COMPATIBLE FOR USE WITH THE FUEL STORAGE TANKS. CONCRETE SLAB SHALL EXTEND BEYOND THE BOTTOM OF THE STAIR UNIT AS SHOWN ON THE PLANS.

### EQUIPMENT SCHEDULE

FUEL PUMP:
GASBOY MODEL 9153ATW1M OR APPROVED EQUAL, TWIN NOZZLE FUEL DISPENSER WITH SUCTION PUMP. PUMP RATED AT UP TO 22 GPM. TWO (2) 3/4 HP MOTORS, 115 V/1 PH/60 HZ.

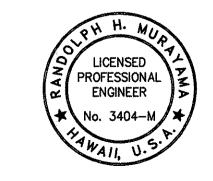

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DEPARTMENT OF HAWAII
DEPARTMENT OF TRANSPORTATION
HIGHWAYS DIVISION

CENTRALIZED DISTRICT OFFICE

AND BASEYARD COMPLEX
LIHUE, KAUAI
PROJECT NO. HWY-K-03-98


PROJECT NO. HWY-K-03-98
FUEL STATION - MECHANICAL PLAN


SCALE: AS NOTED

DATE:MARCH 30, 01

SHEET NO. M6.01 OF 150 SHEETS

FED. ROAD DIST. NO.	STATE	PROJ. NO.	FISCAL YEAR	SHEET NO.	TOTAL SHEETS
HAWAII	HAW.	HWY-K-03-98	2001	124	150

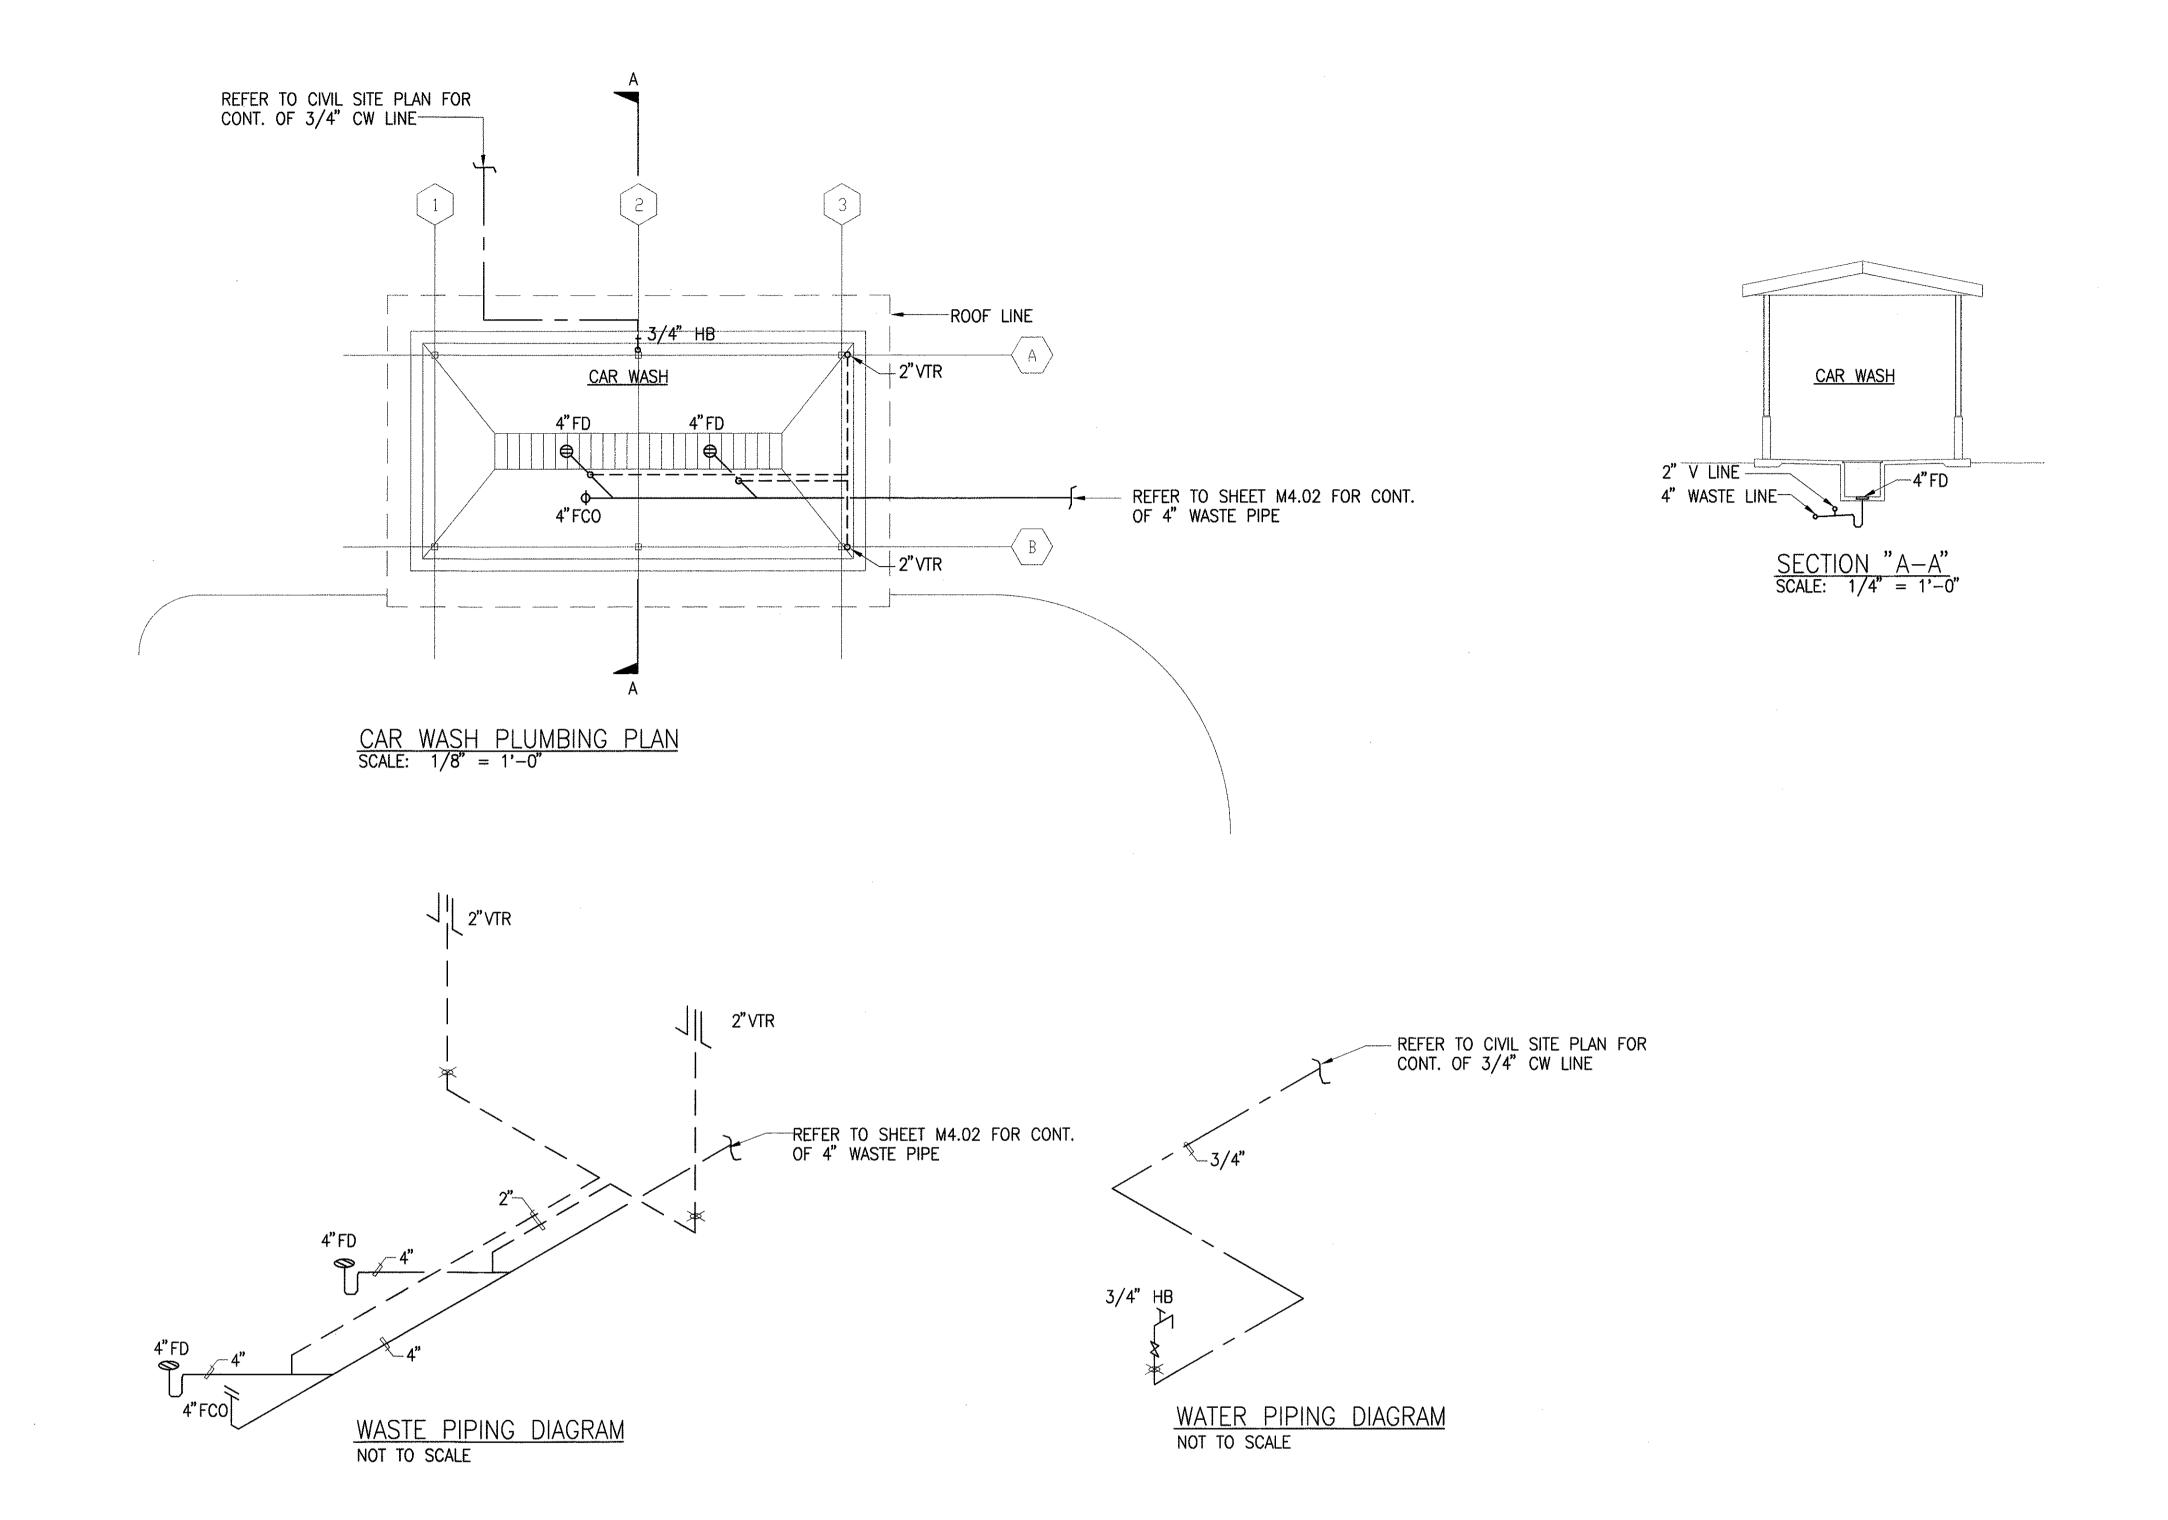

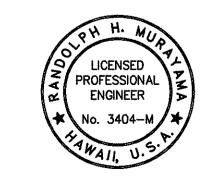

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AND BASEYARD COMPLEX LIHUE, KAUAI PROJECT NO. HWY-K-03-98 WASH PAD — MECHANICAL PLAN AND PIPING DIAGRAMS

STATE OF HAWAII DEPARTMENT OF TRANSPORTATION HIGHWAYS DIVISION

CENTRALIZED DISTRICT OFFICE

SCALE: AS NOTED

SHEET NO. M6.02 OF 150 SHEETS

DATE: MARCH 30, 01

### MECHANICAL EQUIPMENT SCHEDULE

											***
UNIT NO.	LOCATION	CFM	T.S.P.	FAN RPM	HP	W	V/PH/HZ	OPERATING WEIGHT (LBS)	SONES	MODEL NO.	REMARKS
TEF TEF 1-1/1-2	ADMINISTRATION BLDG. MEN, WOMEN	540	0.25"	758		798	115 V/1 PH/60 HZ	56	5.1	GREENHECK MODEL SP-262 OR EQUAL	INTERLOCK WITH LIGHT SWITCH OF ROOM SERVED
(EF) 1-1	ADMINISTRATION BLDG. JANITOR	100	0.25"	1072		76	115 V/1 PH/60 HZ	15	2.0	GREENHECK MODEL SP-216 OR EQUAL	INTERLOCK WITH LIGHT SWITCH OF ROOM SERVED
TEF 2-1	MAINTENANCE BLDG. WOMEN	460	0.25"	644		584	115 V/1 PH/60 HZ	56	4.9	GREENHECK MODEL SP-260 OR EQUAL	INTERLOCK WITH LIGHT SWITCH OF ROOM SERVED
TEF 2-2	MAINTENANCE BLDG. MEN	730	0.25"	854		584	115 V/1 PH/60 HZ	56	5.8	GREENHECK MODEL SP-260 OR EQUAL	INTERLOCK WITH LIGHT SWITCH OF ROOM SERVED
EF 2-1	MAINTENANCE BLDG. JANITOR	100	0.25"	1072	**************************************	76	115 V/1 PH/60 HZ	15	2.0	GREENHECK MODEL SP-216 OR EQUAL	INTERLOCK WITH LIGHT SWITCH OF ROOM SERVED
EF 2-2 TO 2-5	MAINTENANCE BLDG. STORAGE ROOMS	1950	0.5"	770	1/3		115 V/1 PH/60 HZ	103	7.9	GREENHECK MODEL CUBE-180-3 OR EQUAL	PROVIDE "ON-OFF" SWITCH.
EF 2-6	MAINTENANCE BLDG. WORKROOM SIGNAL	1670	0.5"	705	1/4		115 V/1 PH/60 HZ	101	6.3	GREENHECK MODEL GB-180-4 OR EQUAL	INTERLOCK WITH LIGHT SWITCH OF ROOM SERVED
EF EF 2-8	MAINTENANCE BLDG. TRAFFIC SIGNAL SHOP	2360	0.5"	688	1/2	***************************************	115 V/1 PH/60 HZ	101	7.7	GREENHECK MODEL CUBE-200-5 OR EQUAL	PROVIDE "ON-OFF" SWITCH.
EF 2-9	MAINTENANCE BLDG. EMERG. TEL. ROOM	420	0.25"	624		584	115 V/1 PH/60 HZ	56	4.8	GREENHECK MODEL SP-260 OR EQUAL	INTERLOCK WITH LIGHT SWITCH OF ROOM SERVED
EF 2-10	MAINTENANCE BLDG. CONTROL ROOM	840	0.25"	950		584	115 V/1 PH/60 HZ	56	6.4	GREENHECK MODEL SP-260 OR EQUAL	INTERLOCK WITH LIGHT SWITCH OF ROOM SERVED
TEF TEF 3-1 3-2	MECH./BRIDGE SHOP BLDG. MEN, WOMEN	640	0.25"	781		285	115 V/1 PH/60 HZ	56	5.6	GREENHECK MODEL SP-260 OR EQUAL	INTERLOCK WITH LIGHT SWITCH OF ROOM SERVED
EF 3-1	MECH./BRIDGE SHOP BLDG. STORAGE	1700	0.5"	708	1/4	_	115 V/1 PH/60 HZ	101	6.5	GREENHECK MODEL GB-180-4 OR EQUAL	INTERLOCK WITH LIGHT SWITCH OF ROOM SERVED
EF EF 3-2 3-15	MECH./BRIDGE SHOP BLDG. TOOL STOR., WELDING SHOP	1000	0.25"	1095		798	115 V/1 PH/60 HZ	56	7	GREENHECK MODEL SP-262 OR EQUAL	INTERLOCK WITH LIGHT SWITCH OF ROOM SERVED
EF 3-3 TO 3-8	MECH./BRIDGE SHOP BLDG. SHOPS, SERVICE BAYS	5000	0.5"	471	3/4		460 V/3 PH/60 HZ	208	8.3	GREENHECK MODEL GB-300-7 OR EQUAL	PROVIDE "ON-OFF" SWITCH.
EF 3-9	MECH./BRIDGE SHOP BLDG. JANITOR	150	0.25"	1311		156	115 V/1 PH/60 HZ	15	3.0	GREENHECK MODEL SP-218 OR EQUAL	INTERLOCK WITH LIGHT SWITCH OF ROOM SERVED
3-10	MECH./BRIDGE SHOP BLDG. BATTERY STOR.	400	0.25"	614	_	584	115 V/1 PH/60 HZ	56	4.6	GREENHECK MODEL SP-260 OR EQUAL	INTERLOCK WITH LIGHT SWITCH OF ROOM SERVED
EF 3-11	MECH./BRIDGE SHOP BLDG. COMPRESSOR	1000	0.25"	1095	*************	798	115 V/1 PH/60 HZ	56	7	GREENHECK MODEL SP-262 OR EQUAL	INTERLOCK WITH SPACE THERMOSTAT.
EF 3–12	MECH./BRIDGE SHOP BLDG. TIRE STORAGE	1300	0.25"	1420		1032	115 V/1 PH/60 HZ	56	11.5	GREENHECK MODEL SP-265 OR EQUAL	INTERLOCK WITH LIGHT SWITCH OF ROOM SERVED
EF EF 3-13 3-14	MECH./BRIDGE SHOP BLDG. FLAMMABLE AND PARTS STORAGE	2300	0.5"	1015	1/2	***************************************	115 V/1 PH/60 HZ	65	11.9	GREENHECK MODEL CUBE-160-5 OR EQUAL	PROVIDE "ON-OFF" SWITCH.
TEP 4-1	MATERIAL TESTING BLDG. RESTROOM	200	0.25"	742	UPP-ANALONALA	224	115 V/1 PH/60 HZ	31	3.3	GREENHECK MODEL SP-250 OR EQUAL	INTERLOCK WITH LIGHT SWITCH OF ROOM SERVED

FED. ROAD DIST. NO. STATE PROJ. NO. FISCAL SHEET NO. SHEETS

HAWAII HAW. HWY-K-03-98 2001 125 150

EWH ELECTRIC WATER HEATER

1-1 30 GALLON CAPACITY, 4500 WATT ELEMENT (TWO HEATING ELEMENTS), 208 V/1 PH/60 HZ. COMPLY TO ASHRAE 90-1980.

STATE MODEL PV-30-10MS-K OR APPROVED EQUIVALENT. PROVIDE PRESSURE AND TEMPERATURE

RELIEF VALVE, VACUUM BREAKER, VALVES AND UNIONS. 111 LBS. SHIPPING WEIGHT.

EWH) ELECTRIC WATER HEATER

2-1 119 GALLON CAPACITY, 4500 WATT ELEMENT (TWO HEATING ELEMENTS), 208 V/1 PH/60 HZ. COMPLY TO ASHRAE 90-1980.

STATE MODEL PV-120-20RT OR APPROVED EQUIVALENT. PROVIDE PRESSURE AND TEMPERATURE

RELIEF VALVE, VACUUM BREAKER, VALVES AND UNIONS. 312 LBS. SHIPPING WEIGHT.

OMP AIR COMPRESSOR

1 TWO-STAGE, HORIZONTAL TANK MOUNTED AIR COMPRESSOR. 35 ACFM AT 100 PSIG.
10 HP, 460 V/3 PH/60 HZ. 120 GALLON STORAGE TANK. 835 LB. OPERATING WEIGHT.
MAX. 175 PSIG PRESSURE. PROVIDE STAINLESS STEEL CONTROL PANEL FOR AUTO CONTROLS.

RAD REFRIGERATED AIR DRYER:

1 35 SCFM AT 100 PSIG, 1/2 HP, 115 V/1 PH/60 HZ. 72 LBS. WEIGHT. 250 PSI MAX. WORKING PRESSURE. PROVIDE STAINLESS STEEL CONTROL CABINET.

EWC ELECTRIC WATER COOLER

1-1/8 GPH CAPACITY, FULLY RECESSED BARRIER-FREE WATER COOLER. 4.7 AMPS, 380 WATTS,
1/5 HP COMPRESSOR, 50 DEG F WATER AT 90 DEG F ROOM TEMP. AND 80 DEG F INLET WATER.
115V/1PH/60HZ. ELKAY EFRC-8 OR EQUAL.

PEWC ELECTRIC WATER COOLER

1-1 SAME AS EWC 1-1 EXCEPT FOR MOUNTING HEIGHT. SEE ARCHITECTURAL DRAWINGS FOR HEIGHTS.

EWC/PEWO ELECTRIC WATER COOLER

2-1 DUAL HEIGHT, 8 GPH CAPACITY, BARRIER-FREE WATER COOLER. 4.7 AMPS, 380 WATTS,

1/5 HP COMPRESSOR, 50 DEG F WATER AT 90 DEG F ROOM TEMP. AND 80 DEG F INLET WATER.

115V/1PH/60HZ. ELKAY EFRC-8 OR EQUAL.

AIR HANDLING UNITS/FAN COIL UNITS


ALL MOTORS SHALL BE HIGH EFFICIENCY TYPE. PROVIDE MIN. 3 FILTER CHANGES: DURING CONSTRUCTION, PRIOR TO TEST AND BALANCING AND ONE MONTH AFTER FINAL ACCEPTANCE OF THE PROJECT. TOTAL COOLING AT 95° F AMBIENT TEMPERATURE, 80° F DB/67° F WB ENTERING AIR.

UNIT NO.	LOCATION	USE WITH ACCU #	TOTAL COOLING (BTUH)	SENSIBLE COOLING (BTUH)	TONS	CFM	OA CFM	E.S.P.	FAN RPM	HP	FLA	V/PH/HZ	OPERATING WEIGHT (LBS)	SOUND POWER LEVEL (DBA)	MODEL NO.	REMARKS
AHU 1-1	ADMINISTRATION BLDG.	ACCU/1-1	600,000	450,000	50	20,000	2000	3.5"	675	20		460 V/3 PH/60 HZ			CARRIER 39T39 OR APPROVED EQUAL	
2-1	MAINTENANCE BLDG.	ACCU/2-1	102,000	76,500	8.5	3400	700	2.0"	675	2		208 V/3 PH/60 HZ			CARRIER 39LA08 OR APPROVED EQUAL	
	MAINTENANCE BLDG. OFFICE	ACCU/2-2	12,000	8,000	1	400	40	_	1040 (HI)	35 W	0.23	208 V/1 PH/60 HZ	42.9		CARRIER 40QNB 024 OR APPROVED EQUAL	
FCU FCU 3-1 3-2	MECHANIC/BRIDGE SHOP BLDG. SUP. OFFICE, MECH. OFFICE	ACCU/3-1 ACCU/3-2	12,000	8,000	1	400	40	****	1040 (HI)	35 W	0.23	208 V/1 PH/60 HZ	149		CARRIER 40QAB 048 OR APPROVED EQUAL	
/	MATERIAL TESTING BLDG. OFFICE	ACCU/4-1	24,000	18,000	2	800	40	менен	1470 (HI)	49 W	0.53	208 V/1 PH/60 HZ	24.2		CARRIER 40QNB 012 OR APPROVED EQUAL	
FCU\ 4-2	MATERIAL TESTING BLDG. MATERIAL TESTING	ACCU/4-2	48,000	36,000	4	1600	80		1435 (HI)	1/16	0.50	208 V/1 PH/60 HZ	24.2		CARRIER 40QNB 012 OR APPROVED EQUAL	

AIR COOLED CONDENSING UNITS

95° F CONDENSER ENTERING AIR TEMPERATURE, 40° F SATURATED SUCTION TEMPERATURE
PROVIDE SILOXANE COATING ON ENTIRE LINIT INSIDE AND OUTSIDE OF CASING

UNIT NO.	COMPRESSOR A		A COMPRESSOR B		FAN	V/PH/HZ	V/DU/U7 OPERATING		SOUND POWER	REMARKS
	LRA	RLA	LRA	RLA	FLA	V/111/11Z	WEIGHT (LBS)	MODEL NO.	LEVEL (BELS)	ILMAINS
ACCU 1-1	173	34.5	223	43.6	1.45	460 V/3 PH/60 HZ	3309	CARRIER 38AH054 OR APPROVED EQUAL		
ACCU 2-1	99	19.9	4-014000-0-0-0-0-0		1.4	460 V/3 PH/60 HZ	564	CARRIER 38AKS009 OR APPROVED EQUAL		
ÁCCÚ 2-2	30.0	5.5	AND COMPANIES AN		0.35	208 V/1 PH/60 HZ	62	CARRIER 38AN012 OR APPROVED EQUAL		
ACCU ACCU 3-1 3-2	30.0	5.5			0.35	208 V/1 PH/60 HZ	62	CARRIER 38AN012 OR APPROVED EQUAL		
ACCU 4-1	62.5	12.9			0.7	208 V/1 PH/60 HZ	154	CARRIER 38HD024 OR APPROVED EQUAL		10.7 EER
ACCU 4-2	129.0	26.4			1.45	208 V/1 PH/60 HZ	270	CARRIER 38HD048 OR APPROVED EQUAL		

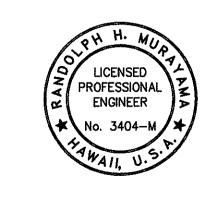

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DEPARTMENT OF HAWAII
DEPARTMENT OF TRANSPORTATION
HIGHWAYS DIVISION

CENTRALIZED DISTRICT OFFICE

AND BASEYARD COMPLEX
LIHUE, KAUAI
PROJECT NO. HWY-K-03-98

EQUIPMENT SCHEDULE

SCALE: AS NOTED


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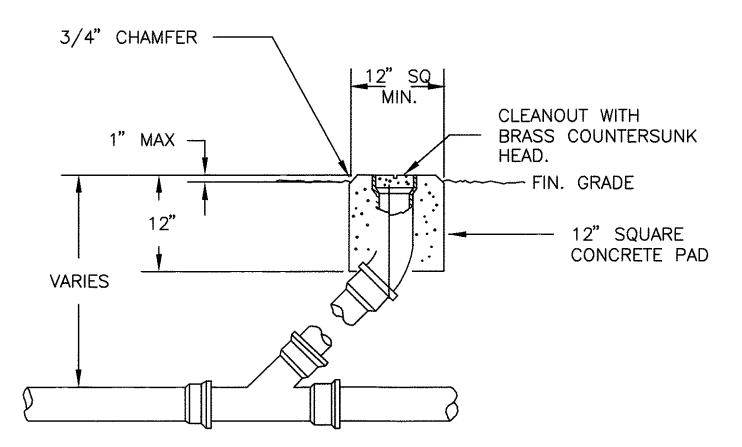
SHEET NO. M8.01 OF 150 SHEETS

# **General Conditions:**


- Conform to all requirements of the Building, Plumbing, and Electrical Codes of Kauai County, State of Hawaii Health Regulations, Fire Department's Regulations, and other applicable regulations.
- Installation shall be guaranteed to be free from defects for one year from final date of acceptance of the project as a whole.
- Contractor shall verify all field conditions prior to bid and construction.
- Coordinate all work with other trades to avoid interferences and delays.
- Pay for all permit fees and applications.
- Provide additional materials and labor for a complete operable system at no additional cost to the State.
- Provide dielectric unions or separations at all dissimilar metals.
- Caulk all roof and wall penetrations to the outside watertight.
- All duct dimensions are net dimensions.
- 10. All items shall be installed in accordance with manufacturer's recommendations.
- 11. Provide access panels for all items under this section requiring servicing, inspection, maintenance, and adjustment.
- 12. All steel shall be hot dipped galvanized. Steel exposed to weather shall have two extra coats of epoxy paint.
- 13. Provide all control wiring and power wiring to variable air volume boxes.

  All wiring shall be in conduit. No EMT outdoors.
- 14. Provide rebalancing within one year guarantee period to satisfy User's requirements. Rebalancing shall include changing of pulleys and sheaves.
- 15. Coordinate all switch locations with User/Architect to avoid interferences with furniture, equipment, pictures, etc.
- 16. Prepare six (6) sets of shop drawings, submitted to the engineer for approval prior to the start of work. No reproductions of any kind of the contract documents shall be acceptable as shop drawings. Provide one set of reproducible as—built drawings showing the actual installed conditions and submit to the Engineer upon completion of work.
- 17. Provide bell mouth taps at all round duct taps.
- 18. Provide air extractors at all rectangular duct taps.
- 19. Provide turning vanes in ducts at all changes in direction. Provide splitter damper with locking quardrant handle at all duct tees.
- 20. Provide flexible connections at intake and discharge of all mechanical equipment, including variable air boxes.



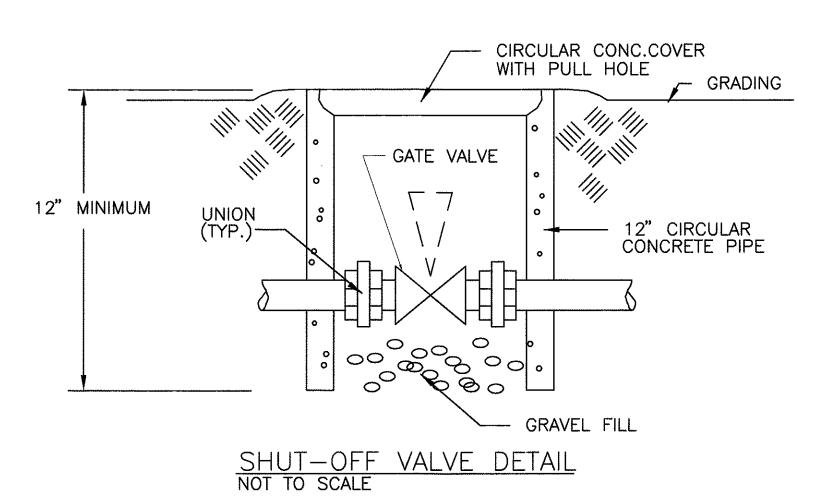


CLEANOUT TO GRADE DETAIL NOT TO SCALE

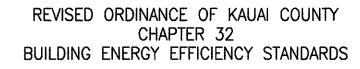



THE BUILDING ENERGY EFFICIENCY STANDARDS HAVE BEEN REVIEWED AND TO THE BEST OF MY KNOWLEDGE THIS DESIGN SUBSTANTIALLY CONFORMS TO THE MECHANICAL REQUIREMENTS OF SECTIONS 9.3, 10.3, 11.3, 12.3 OR 13.3

Randolph H. Murayama

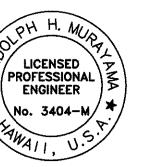


THE AIR CONDITIONING AND VENTILATION SYSTEM SHALL COMPLY WITH TITLE 11. ADMINISTRATIVE RULES, DEPARTMENT OF HEALTH, CHAPTER 39. AIR CONDITIONING AND VENTILATING REQUIREMENTS

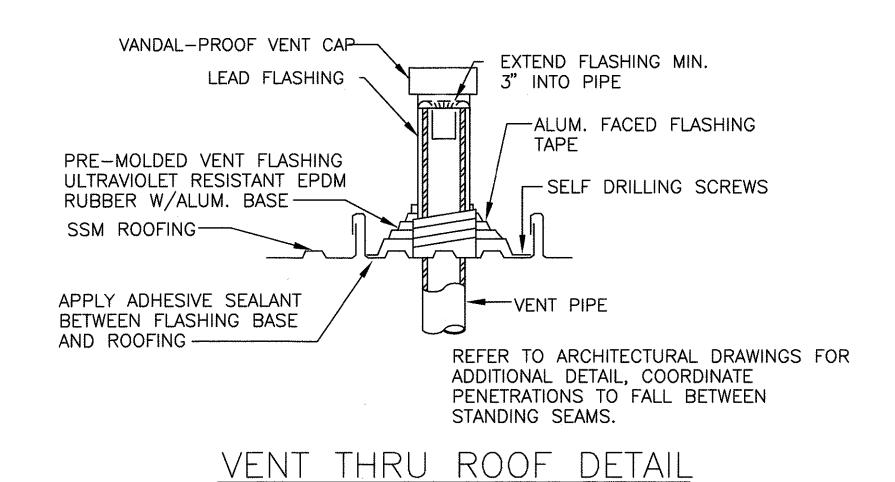

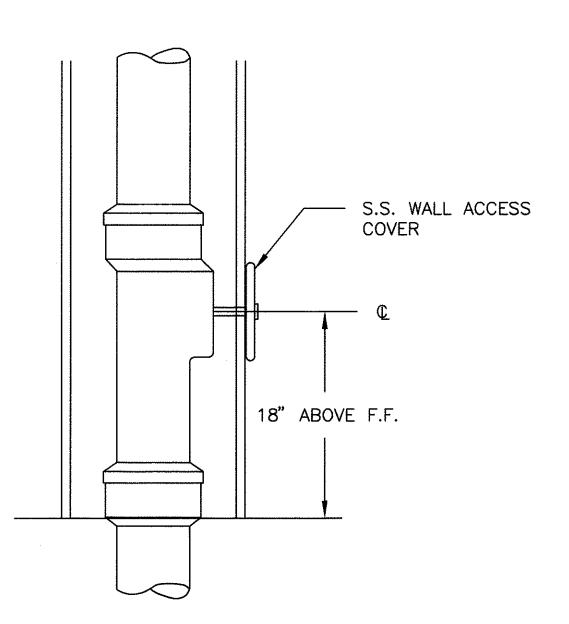

WALL CLEANOUT DETAIL NOT TO SCALE

NOT TO SCALE

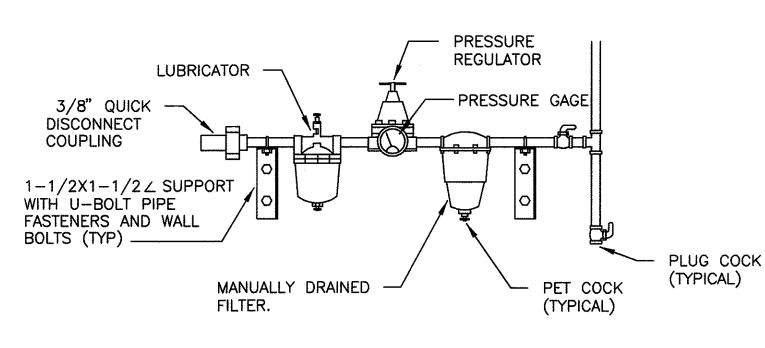

FED. ROAD DIST. NO.


HAWAII

STATE

PROJ. NO.

HAW. | HWY-K-03-98

TYPICAL AIR STATION DETAIL

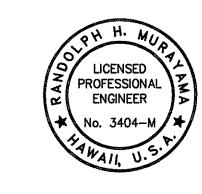

STATE OF HAWAII DEPARTMENT OF TRANSPORTATION HIGHWAYS DIVISION CENTRALIZED DISTRICT OFFICE

AND BASEYARD COMPLEX LIHUE, KAUAI PROJECT NO. HWY-K-03-98

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SIGNATURE

NOTES, DETAILS

SCALE: AS NOTED DATE: MARCH 30, 01 SHEET NO. M8.02 OF 150 SHEETS

126

FISCAL SHEET TOTAL YEAR NO. SHEETS

126

2001


SHEETS


VAV TERMINAL UNITS: FACTORY FABRICATED, ELECTRICALLY CONTROLLED, COMPLETE WITH REMOTE THERMOSTAT, ACTUATOR AND VOLUME CONTROL DAMPER. SYSTEM POWERED NOT ALLOWED. SET MINIMUM FLOW TO 20% OF DESIGN AIR VOLUME. MAXIMUM PRESSURE DIFFERENTIAL OF 0.4". NC 30 BASED ON 10 DB CEILING INSERTION LOSS AND 8 DB ROOM EFFECT AT 1" S.P. AT BOX INLET.

UNIT NO.	CFM RANGE
(VAV) A	0 – 350
(VAV) B	0 — 600
(VAV) C	0 - 1050
(VAV) D	0 - 2000
(VAV) E	0 – 3200


#### FLEXIBLE DUCT SIZES (PROVIDE REDUCING FITTINGS AS REQ'D)

DUCT DIA.	CFM RANGE
6"	0 - 100
8"	0 - 200
10"	0 – 300
12"	0 - 600

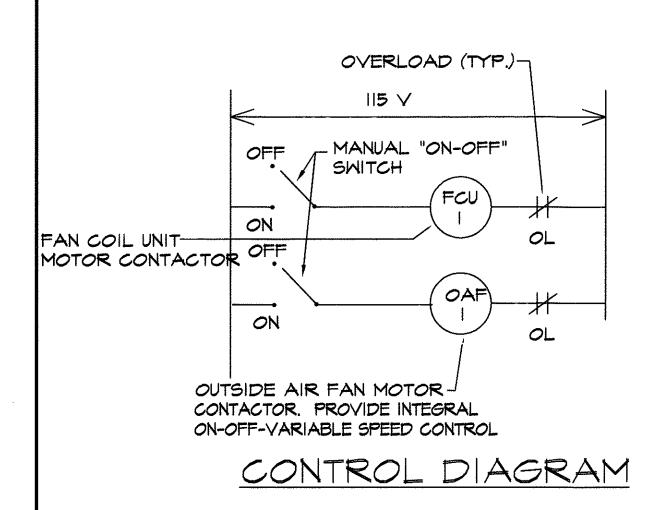

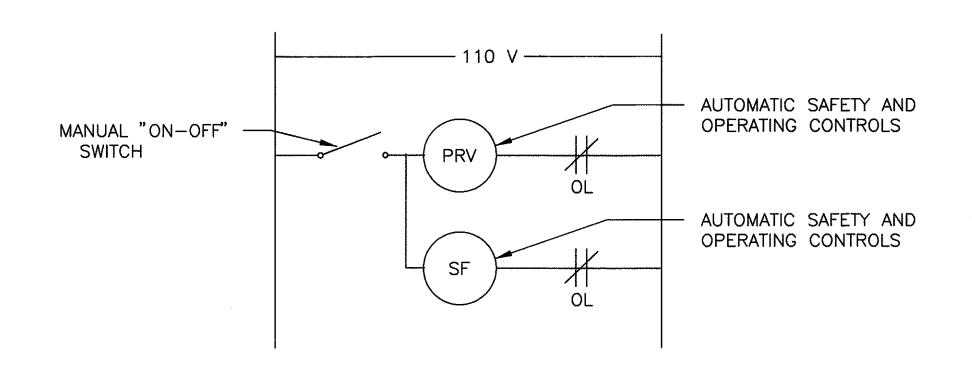


TYPICAL LOCAL PRV CONTROL DIAGRAM NOT TO SCALE

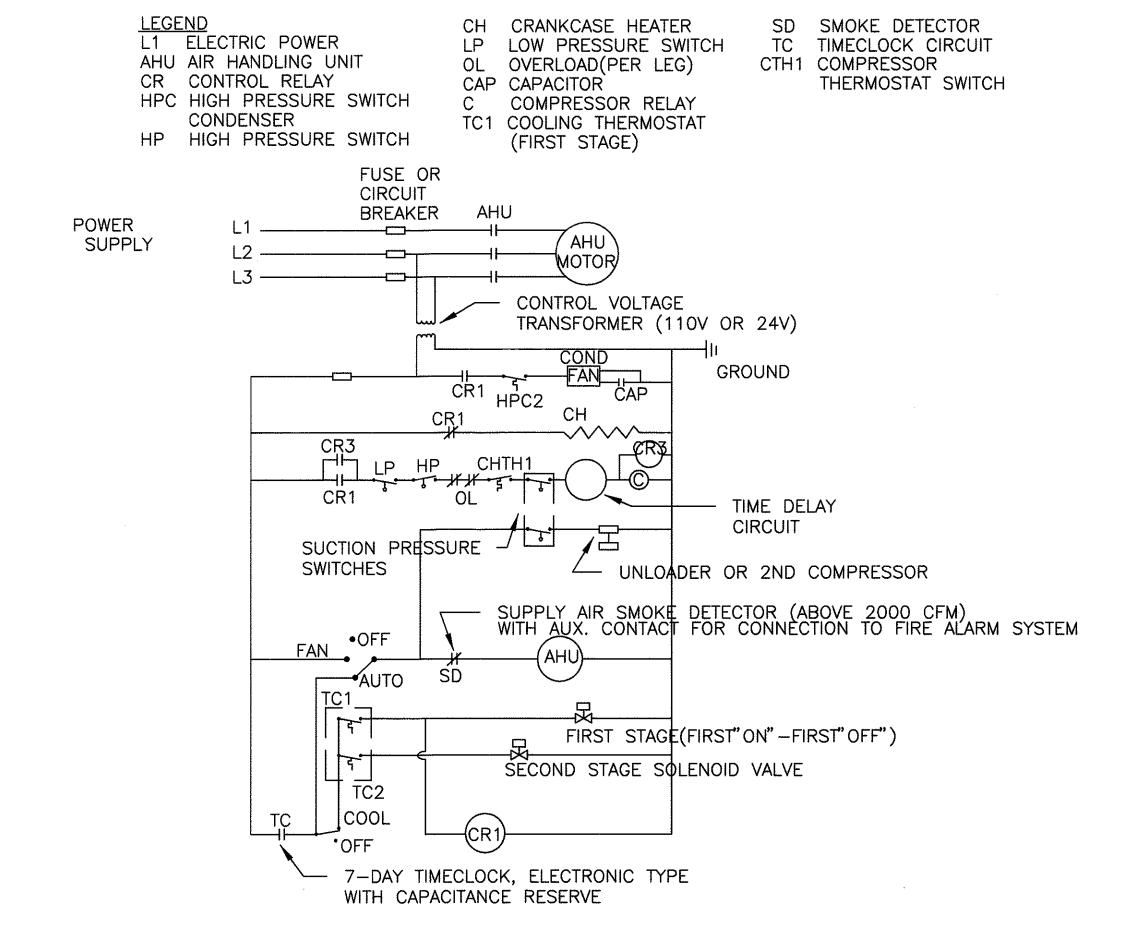


## TYPICAL AIR CONDITIONING CONTROLS-ABOVE 15 TONS PUMP OUT SYSTEM, ABOVE 15 TONS, THERMOSTAT MUST BE CALLING FOR COOLING BEFORE CONDENSING UNIT IS ACTIVATED.

SUCTION PRESSURE SWITCHES UNLOAD COMPRESSOR UNTIL CONDENSING UNIT SHUTS DOWN.

SHEET TOTAL NO. SHEETS FISCAL YEAR FED. ROAD DIST. NO. PROJ. NO. STATE SHEETS 2001 HWY-K-03-98 127 HAWAII

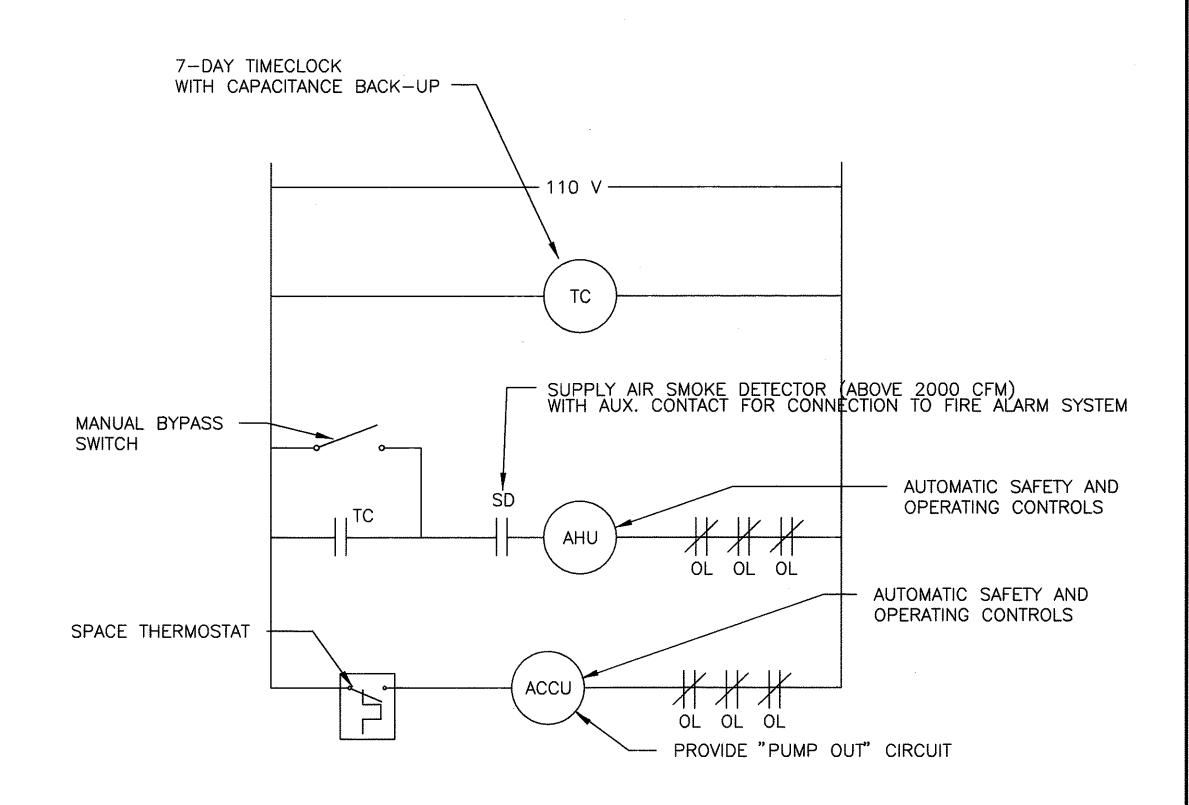

#### TYPICAL LOCAL AHU CONTROL DIAGRAM NOT TO SCALE

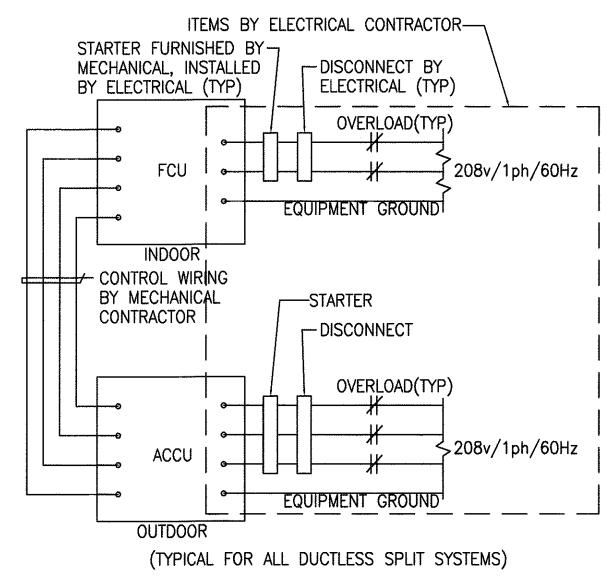

CONTROL DIAGRAM
NOT TO SCALE




CENTRALIZED DISTRICT OFFICE AND BASEYARD COMPLEX LIHUE, KAUAI PROJECT NO. HWY-K-03-98


DIAGRAMS, SCHEDULES THIS WORK WAS PREPARED BY ME OR UNDER MY SUPERVISION


SCALE: AS NOTED

DATE: MARCH 30, 0 SHEET NO. M8.03 OF 150 SHEETS


STATE OF HAWAII DEPARTMENT OF TRANSPORTATION HIGHWAYS DIVISION

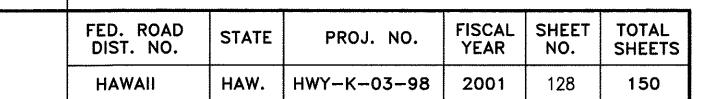

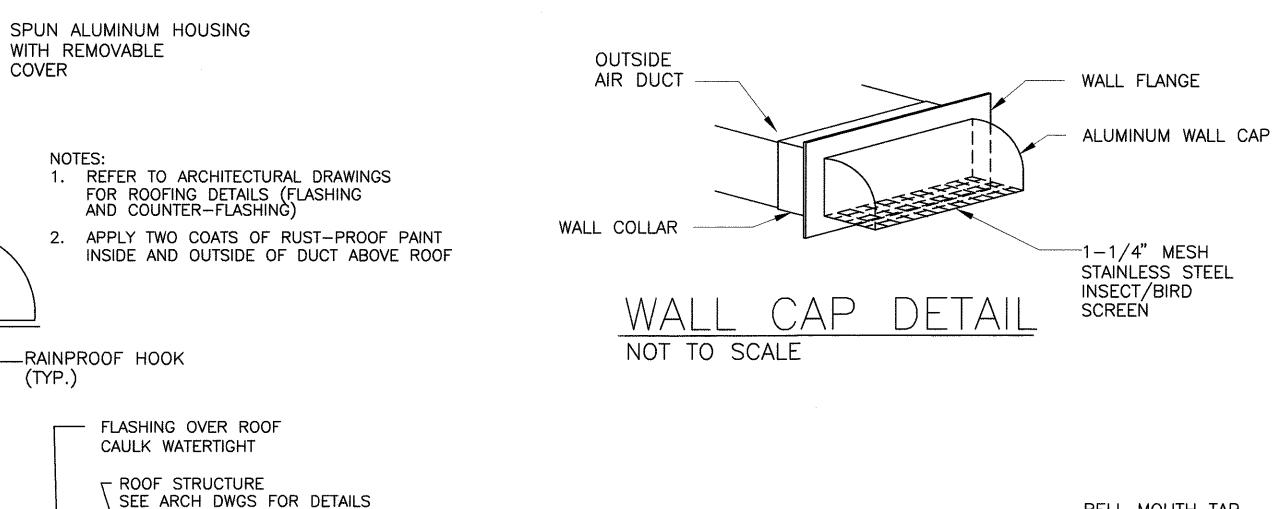

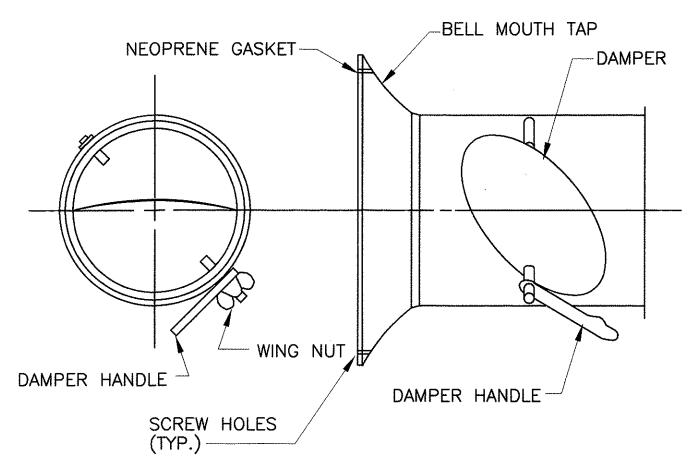

NOT TO SCALE

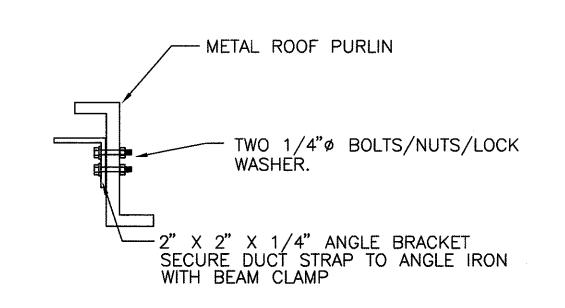

BELL MOUTH TAP FITTING DETAIL

DUCT STRAP SUPPORT DETAIL NOT TO SCALE

THIS WORK WAS PREPARED BY ME OR UNDER MY SUPERVISION

LICENSED PROFESSIONAL ENGINEER


SIGNATURE

STATE OF HAWAII DEPARTMENT OF TRANSPORTATION HIGHWAYS DIVISION CENTRALIZED DISTRICT OFFICE AND BASEYARD COMPLEX LIHUE, KAUAI PROJECT NO. HWY-K-03-98 **DETAILS** 

SCALE: AS NOTED DATE: MARCH 30, 01 SHEET NO. M8.04 OF 150 SHEETS

SEE ARCHITECTURAL DRAWINGS FOR CURB AND FLASHING DETAILS. - BELT DRIVE W/INTERCHANGEABLE **PULLEYS** ADJUSTABLE SHEAVE -SPUN ALUMINUM HOUSING W/ REMOVABLE MOTOR COVER . . FAN WHEEL GREASE TRAP CLEARANCE FLASHING OVER CURB CONCRETE ROOF -OPENING IN ROOF WELDED EXHAUST DUCT

POWER ROOF VENTILATOR DETAIL NOT TO SCALE

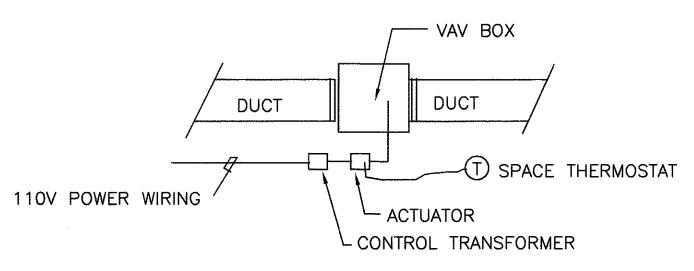


VAV BOX SCHEMATIC DIAGRAM

NOT TO SCALE

NOT TO SCALE

NOTE:

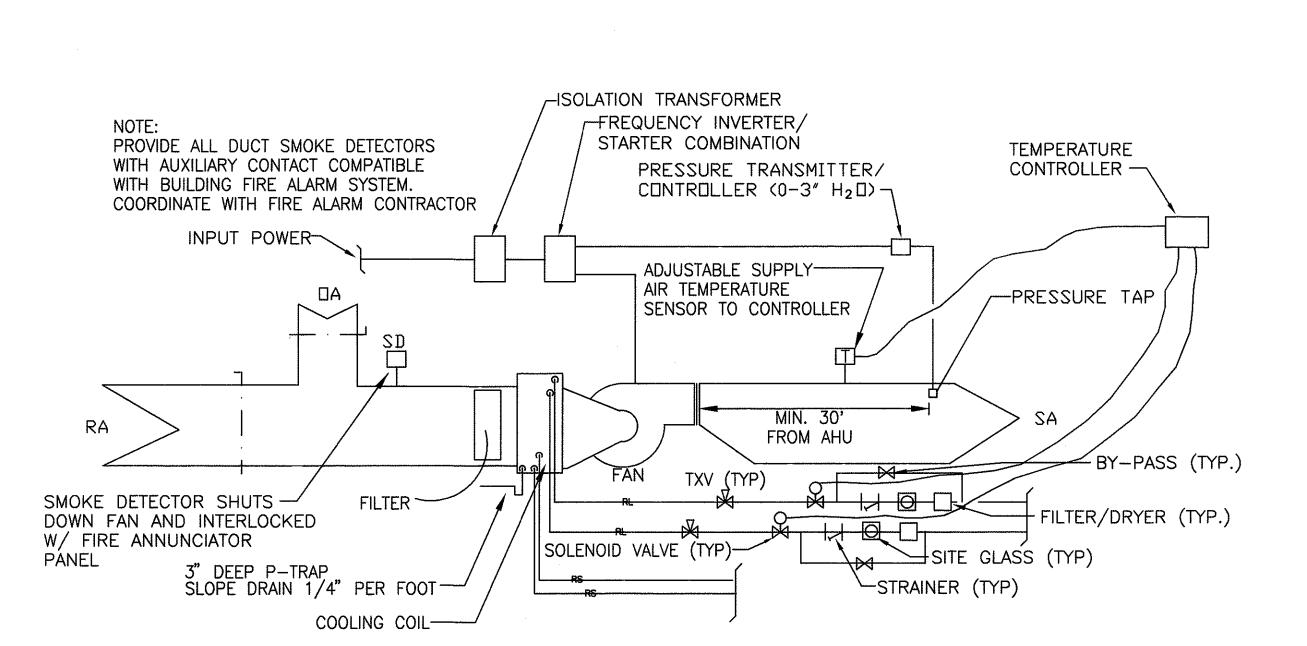

TYPICAL AHU CONTROL SCHEMATIC



CURB

FLASHING

EXHAUST/INTAKE DUCT —

CANT

WITH REMOVABLE


-RAINPROOF HOOK


(TYP.)

COVER


NOT TO SCALE

FISCAL SHEET TOTAL YEAR NO. SHEETS FED. ROAD DIST. NO. PROJ. NO. STATE 2001 HAW. | HWY-K-03-98 129 HAWAII

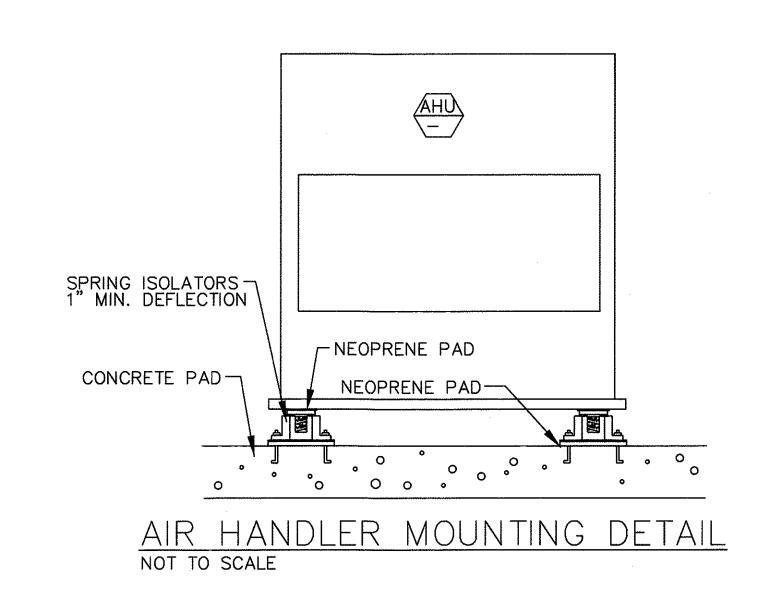

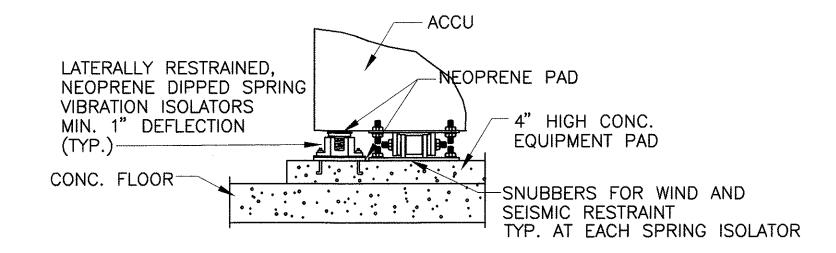


ACCU MOUNTING DETAIL NOT TO SCALE

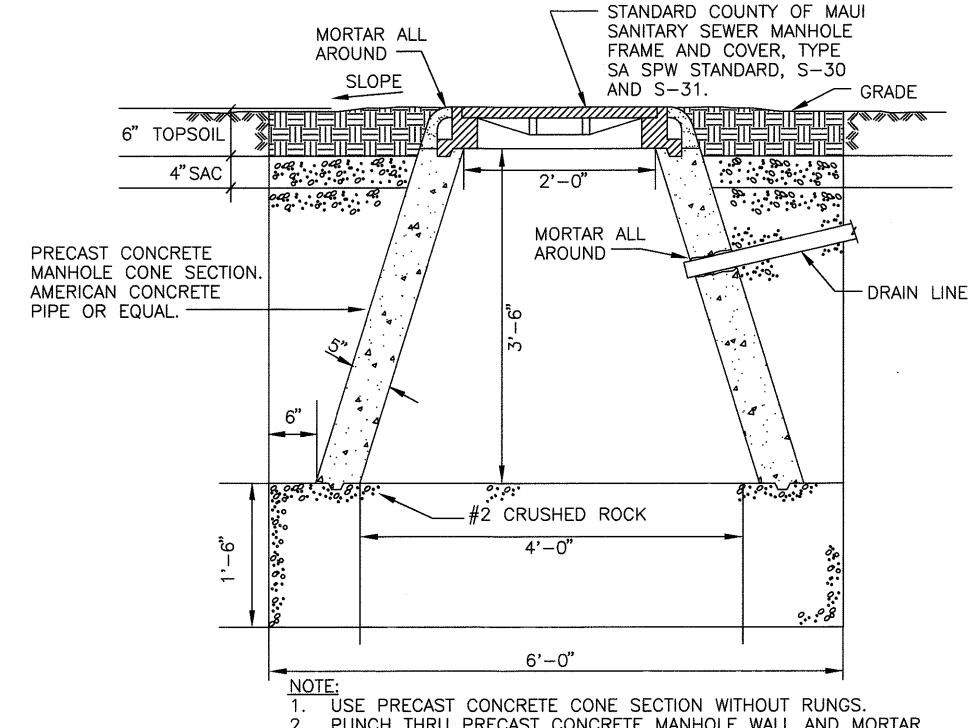

2. PUNCH THRU PRECAST CONCRETE MANHOLE WALL AND MORTAR AROUND DRAIN LINE.


DRYWELL DETAIL

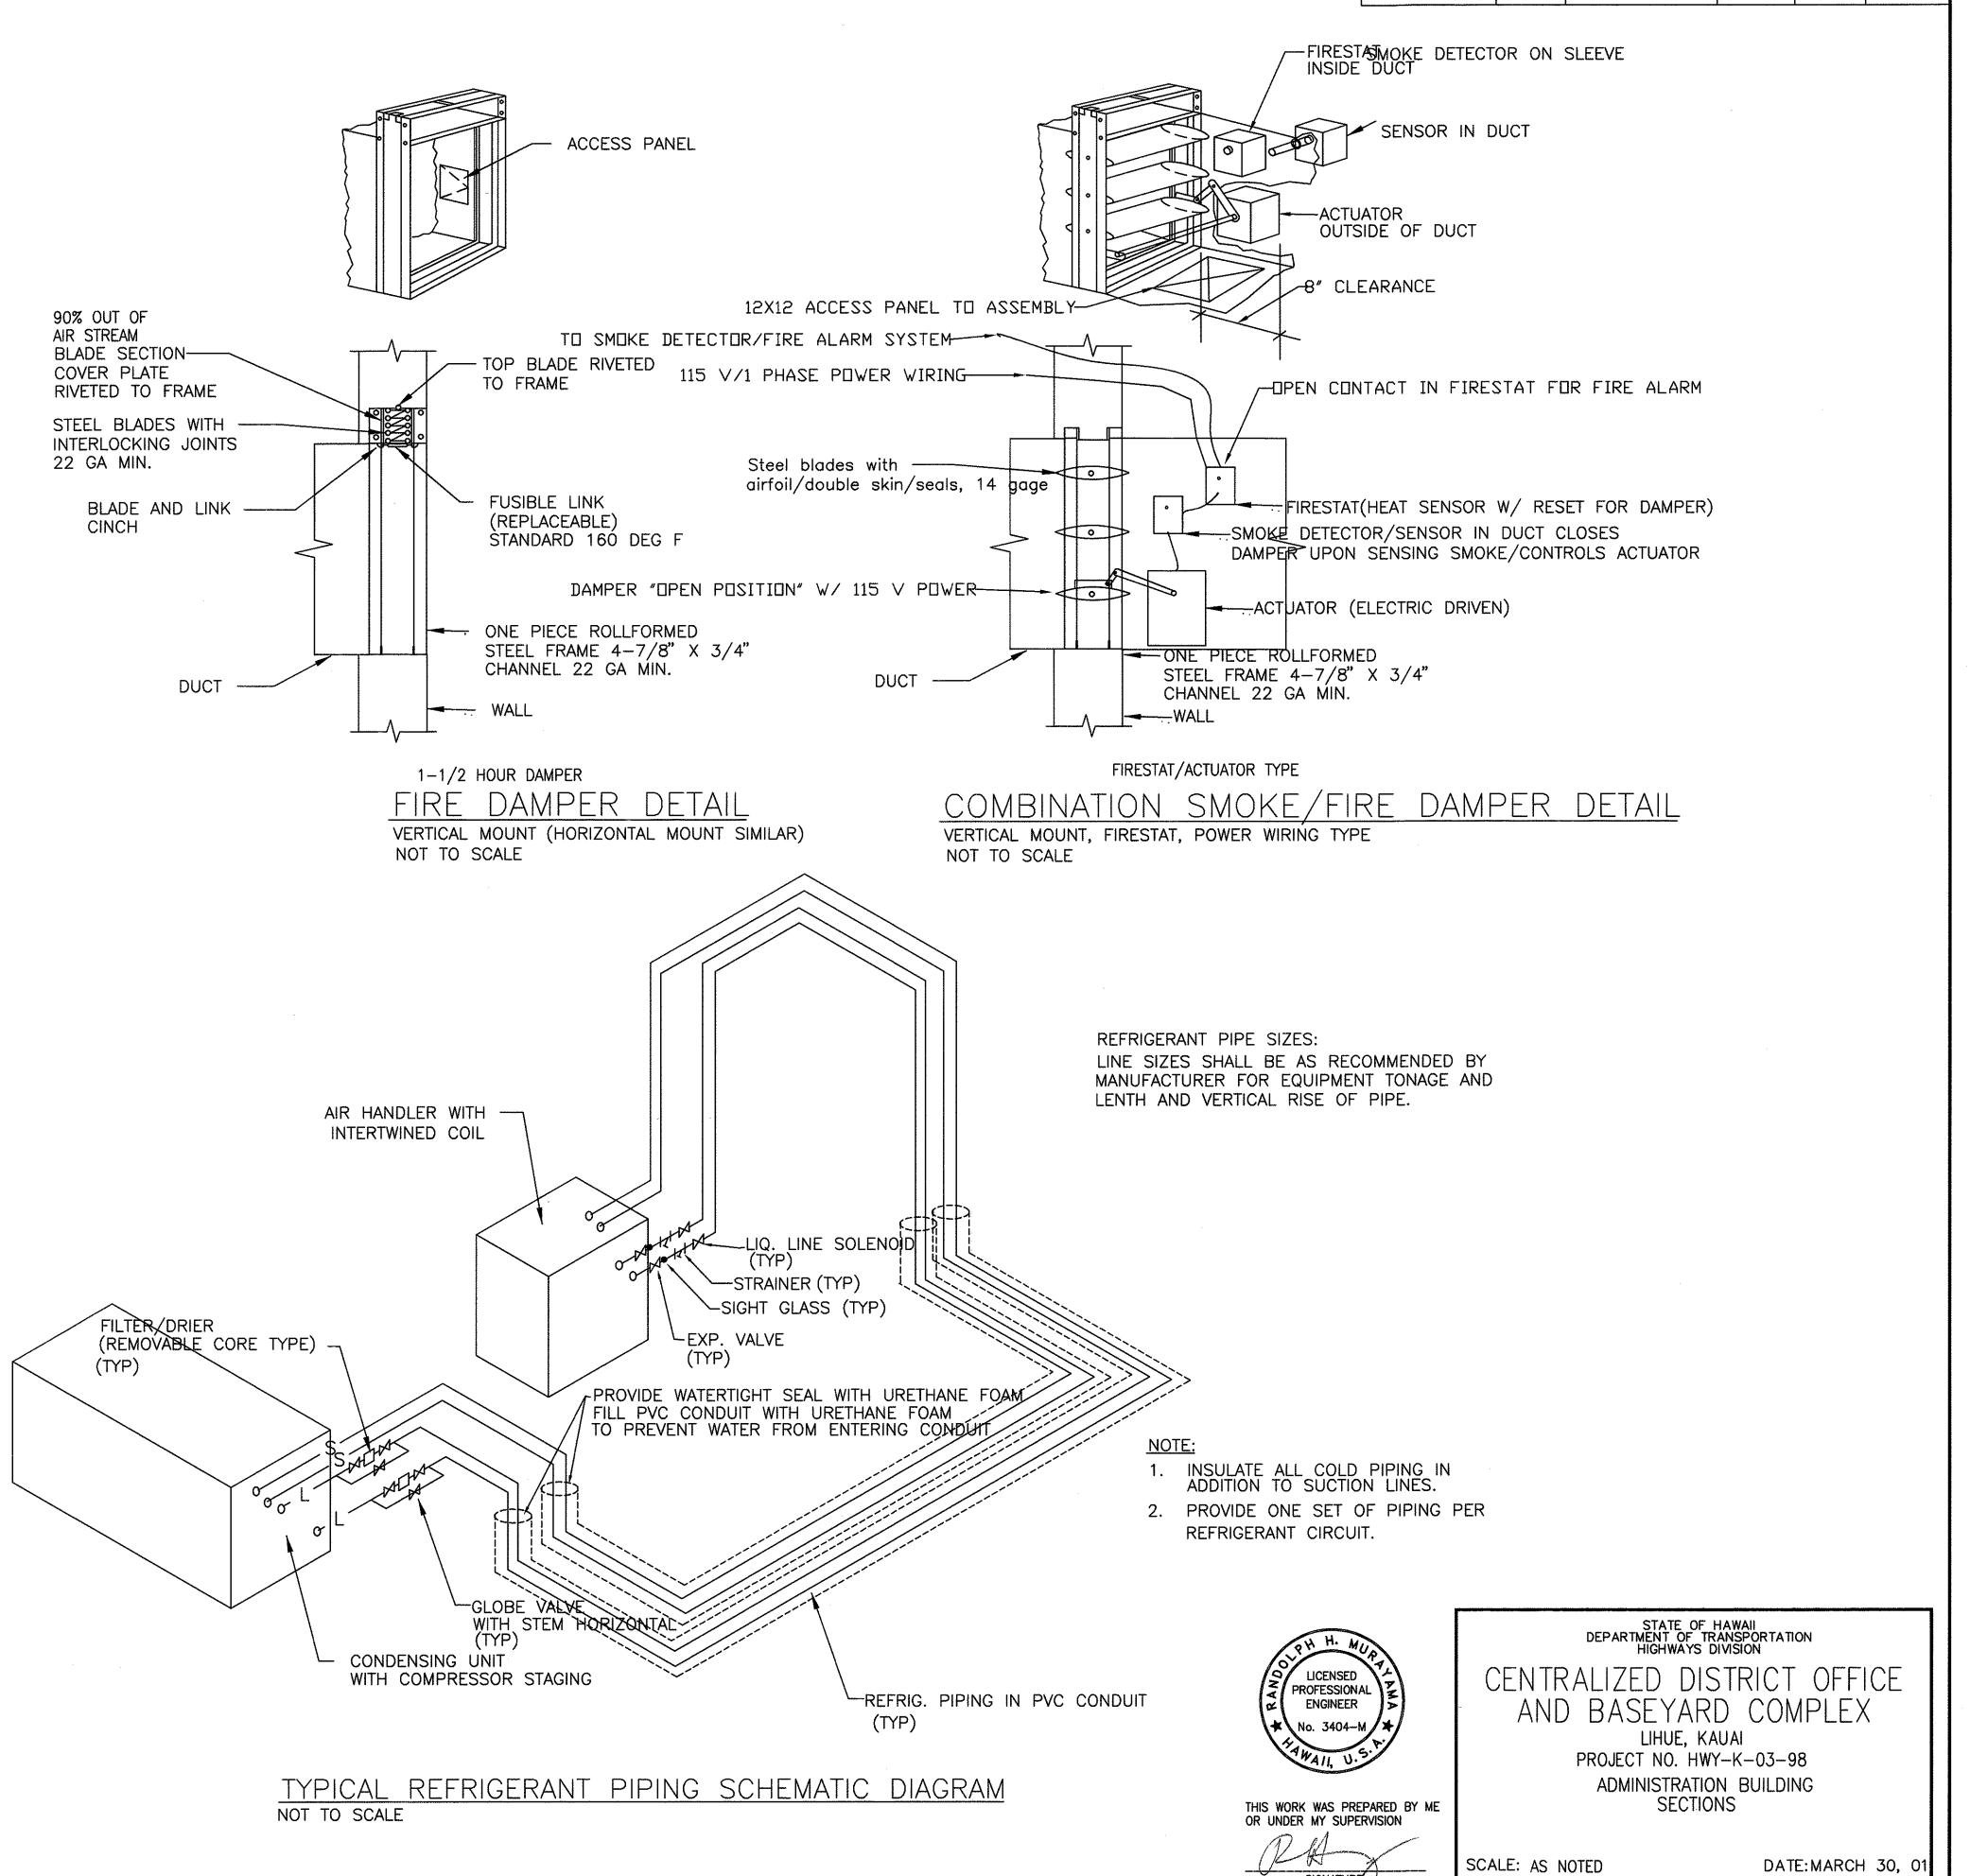


SHEET NO. M8.05 OF 150 SHEETS

FED. ROAD DIST. NO. STATE PROJ. NO. FISCAL SHEET NO. SHEETS


HAWAII HAW. HWY-K-03-98 2001 130 150

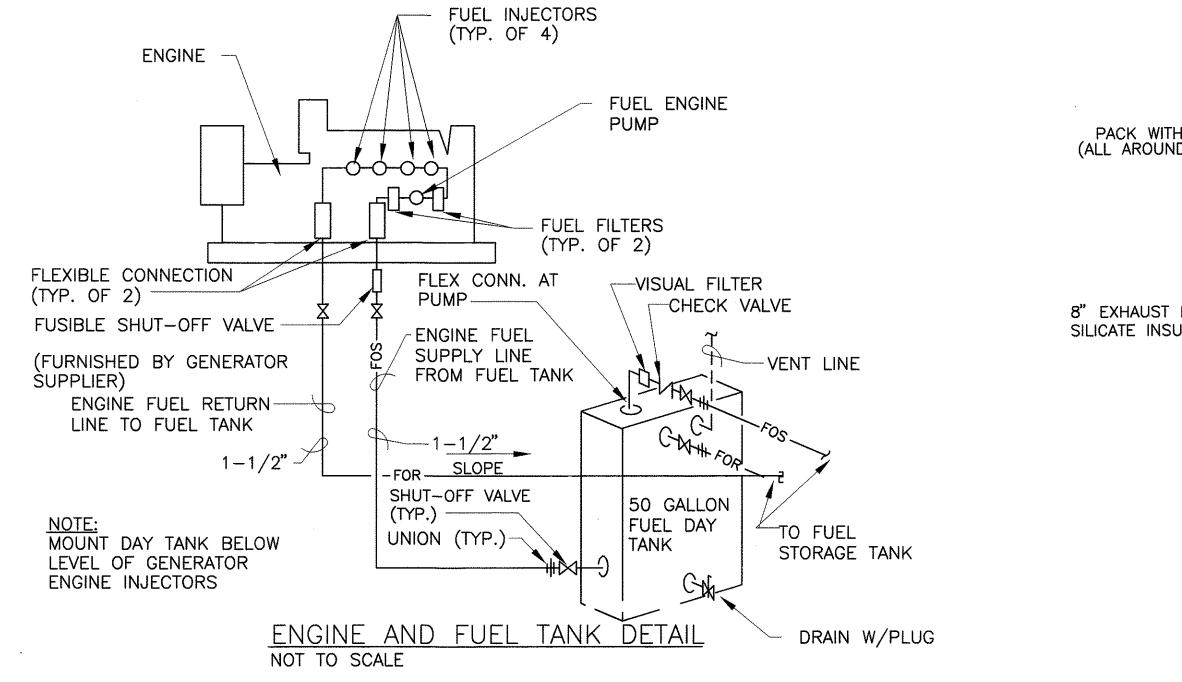


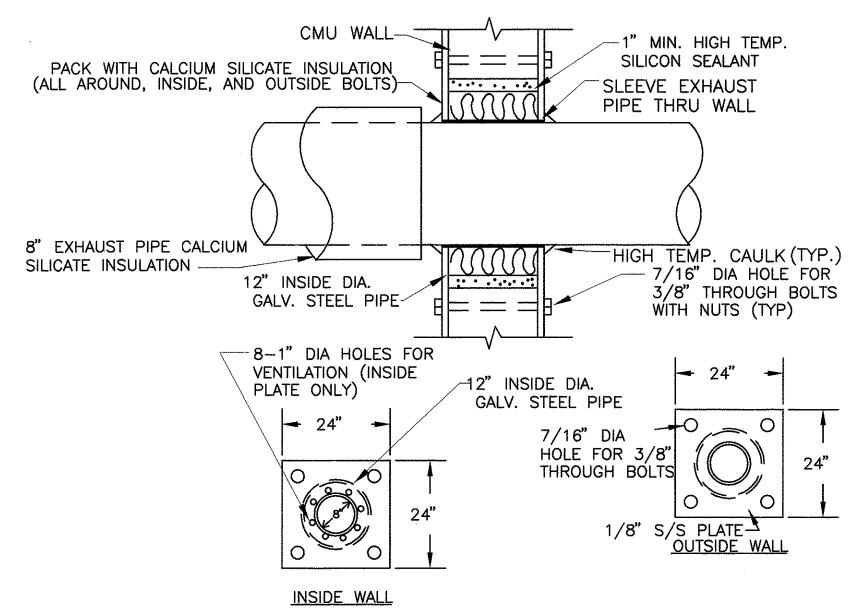

THIMBLE DETAIL

NOT TO SCALE

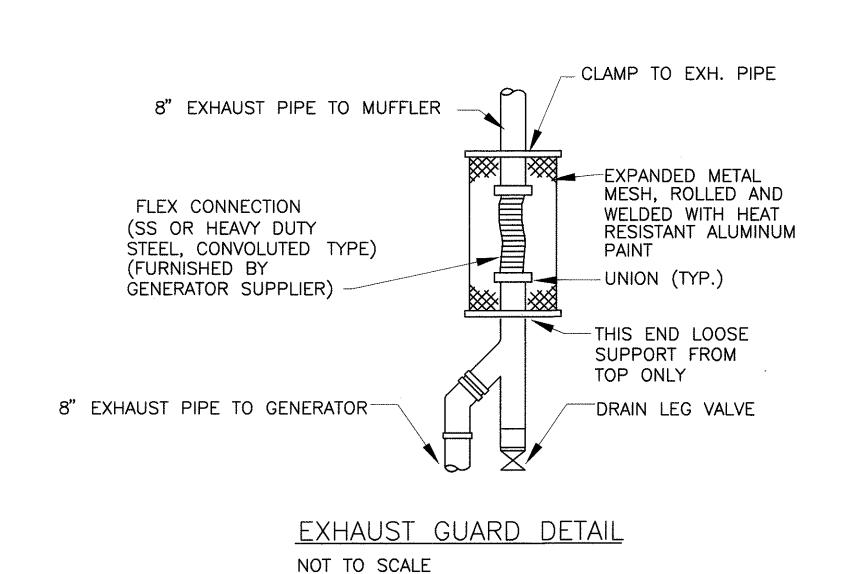

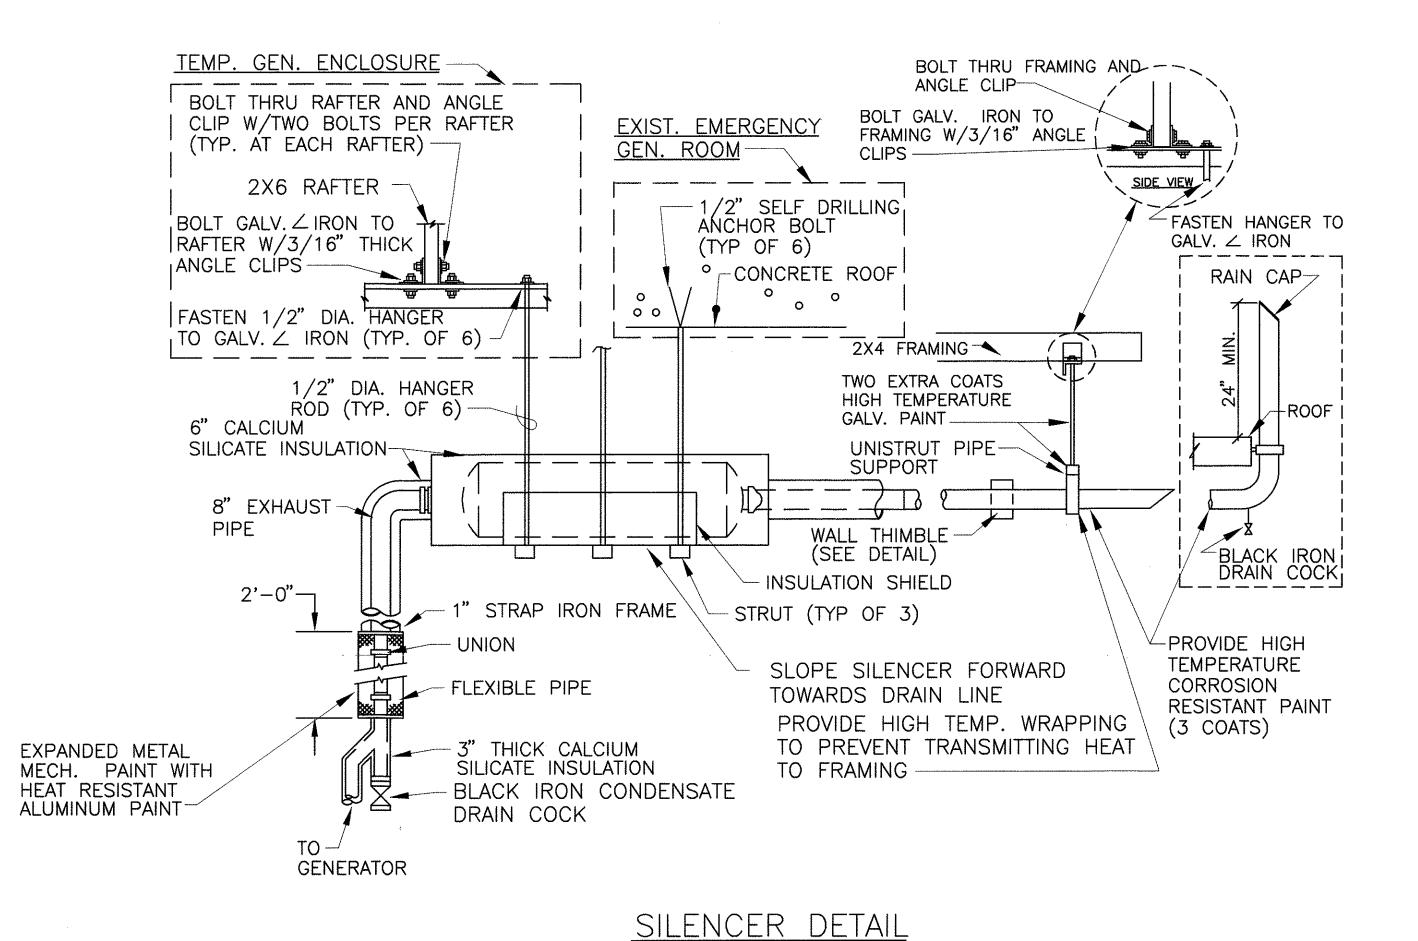

NOT TO SCALE



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STATE OF HAWAII DEPARTMENT OF TRANSPORTATION HIGHWAYS DIVISION


CENTRALIZED DISTRICT OFFICE AND BASEYARD COMPLEX LIHUE, KAUAI


PROJECT NO. HWY-K-03-98
GENERATOR DETAILS

SCALE: AS NOTED

DATE:MARCH 30, 01


SHEET NO. M8.06 OF 150 SHEETS

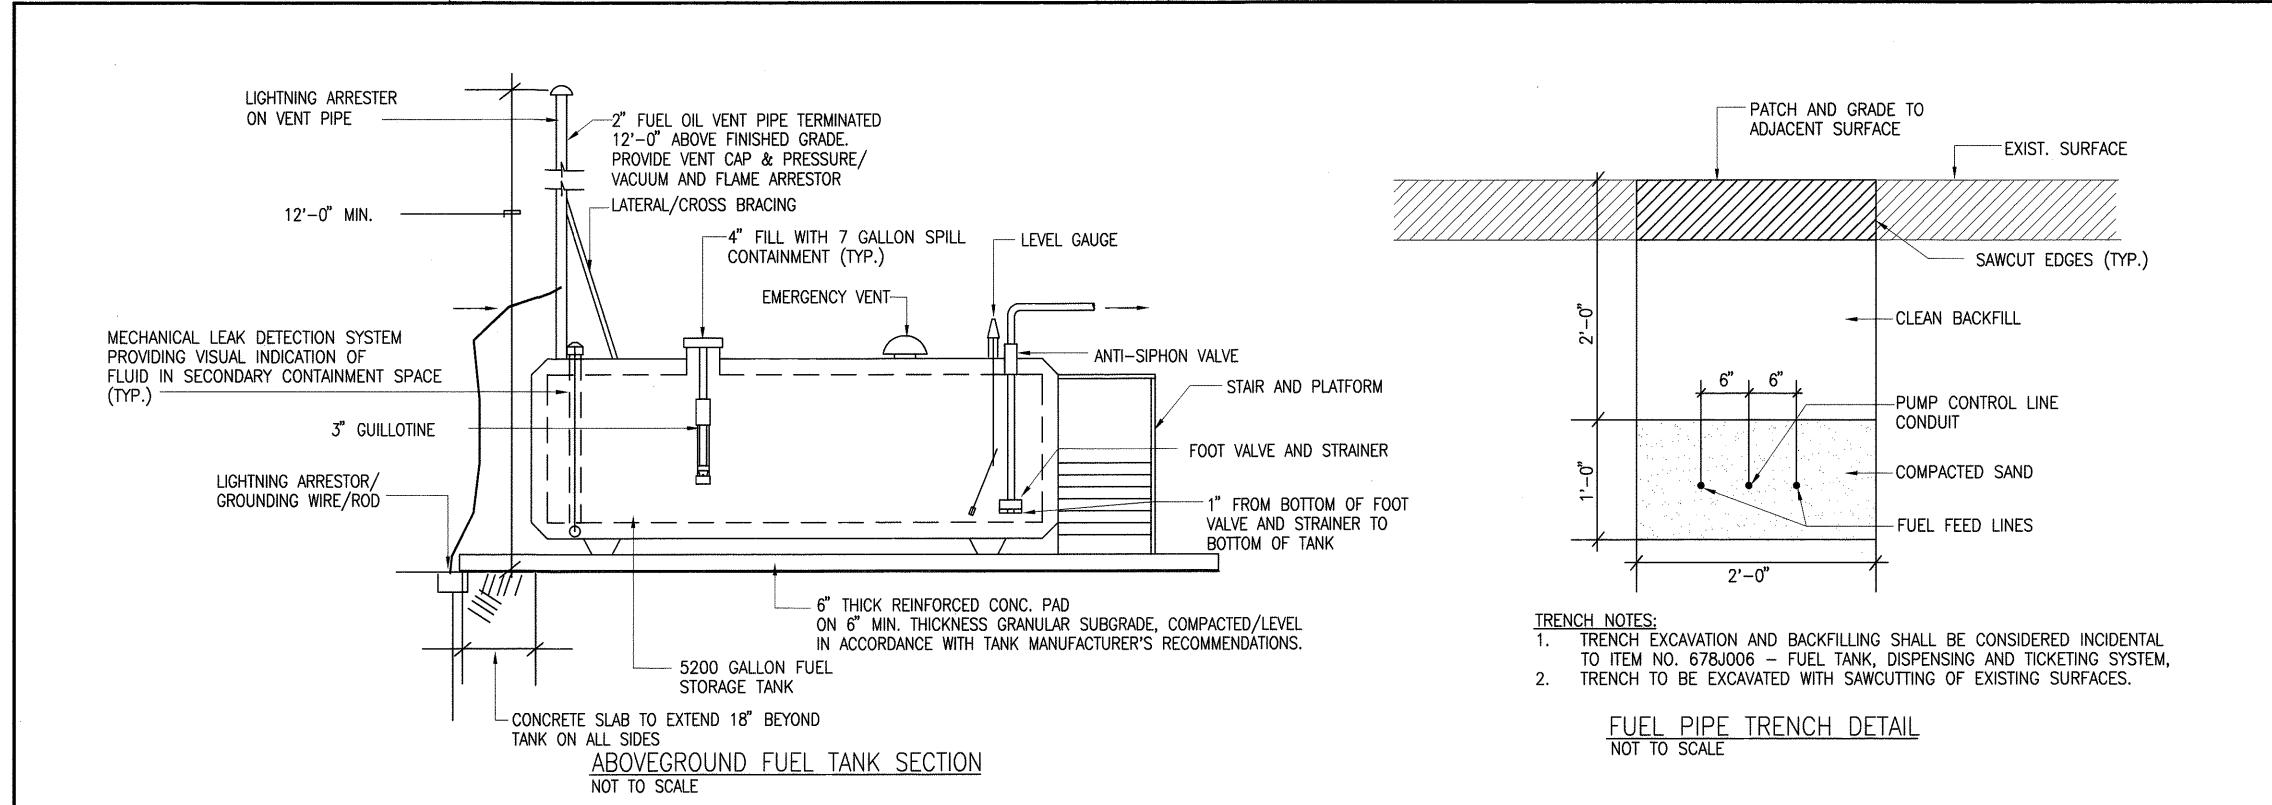

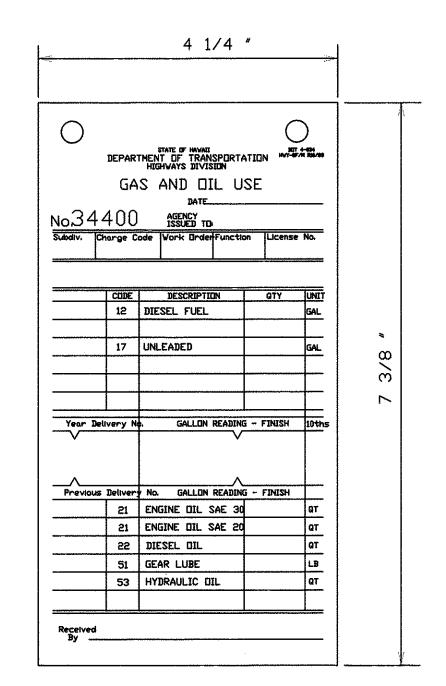

FUEL TICKET SCALE: NOT TO SCALE NOT REQUIRED FOR GENERATOR FUEL TANK WARNING AND SAFETY SIGNS:

- 1. <u>"DANGER FLAMMABLE LIQUIDS"</u> 3" H X 1/2" STROKE, RED ON WHITE, ON ALL APPROACHABLE SIDES OF TANK.
- 2. "NO SMOKING" 3"H X 1/2" STROKE, RED ON WHITE, ON ALL APPROACHABLE SIDES OF TANK
- 3. "STOP MOTOR" 3"H X 1/2" STROKE, RED ON WHITE, AT DISPENSING ENDS OF TANK.
- 4. "FILLING OF UNAPPROVED PORTABLE CONTAINERS IS PROHIBITED" 1"H X 3/16 STROKE, RED ON WHITE AT DISPENSING END.
- 5. NFPA 704 "IDENTIFICATION OF THE FIRE HAZARDS OF MATERIALS"

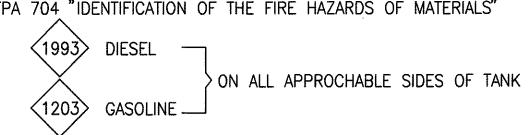


- 6. "SIMULTANEOUS STORAGE TANK FILLING AND FUEL DISPENSING IS PROHIBITED" 1"H X 3/16" STROKE, RED ON WHITE, NEXT TO TANK FILL.
- 7. INSTRUCTIONS FOR THE SAFETY OPERATION OF DISPENSING EQUIPMENT AT DISPENSER. (SAFETY INSTRUCTIONS WORDINGS SHALL BE PROVIDED BY THE EQUIPMENT MANUFACTURER) 1/2"H X 1/8" STROKE, RED ON WHITE.
- 8. "OWNER/OPERATOR: STATE OF HAWAII, DEPARTMENT OF TRANSPORTATION, HIGHWAYS DIVISION, TEL. 274-3111" 1"H X 3/16" STROKE, RED ON WHITE, ON TANK.
- 9. <u>IN CASE OF FIRE OR SPILL</u> 1. USE EMERGENCY PUMP SHUTOFF. 2. REPORT THE ACCIDENT FIRE DEPARTMENT NO. 911 LIHUE BASEYARD ADDRESS: XXXXXX LIHUE. HAWAII 967XX

1"H X 3/16" STROKE, RED ON WHITE, ON OR UNDER DISPENSER

- 10. "EMERGENCY FUEL PUMP SHUTOFF" 2"H X 1/4" STROKE, RED ON WHITE, OVER SHUT-OFF, 15' MINIMUM TO 75' MAXIMUM FROM DISPENSÉR. IF NOT VISIBLE FROM DISPENSER, ADDITIONAL SIGNS AND ARROWS ARE REQUIRED.
- 11. PRODUCT I.D. "GASOLINE", "DIESEL" ON DISPENSER. 1"H X 3/16" STROKE, RED ON WHITE.
- 12. STANDARD DECAL KIT, IF SUPPLIED WITH TANK, MAY BE USED SUBJECT TO APPROVAL BY THE ENGINEER.
- 13. ALL PROPOSED SIGNS AND DECALS SHALL BE SUBMITTED TO THE ENGINEER FOR REVIEW AND APPROVAL PRIOR TO INSTALLATION.


DANGER FLAMMABLE LIQUIDS **GASOLINE** NO SMOKING STOP MOTOR

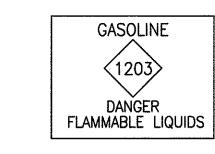

GASOLINE TANK SIDE VIEW

END VIEW

DANGER FLAMMABLE LIQUIDS DIESEL FUEL **(**1993**)** NO SMOKING STOP MOTOR

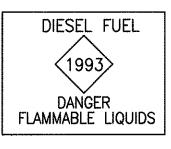

DIESEL TANK SIDE VIEW

END VIEW

SIGN INSTALLATION NOT TO SCALE



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STATE OF HAWAII DEPARTMENT OF TRANSPORTATION HIGHWAYS DIVISION CENTRALIZED DISTRICT OFFICE AND BASEYARD COMPLEX LIHUE, KAUAI

PROJECT NO. HWY-K-03-98 FUEL TANK DETAILS

SHEET NO. M8.07 OF 150 SHEETS

SCALE: AS NOTED

DATE: MARCH 30, 01

FISCAL SHEET TOTAL

131

SHEETS

NO.

YEAR

2001


PROJ. NO.


HAW. | HWY-K-03-98

FED. ROAD DIST. NO.

HAWAII

STATE

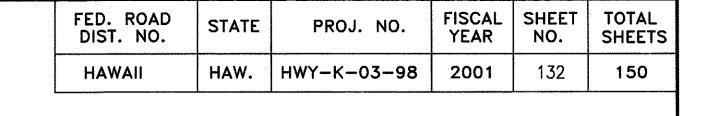

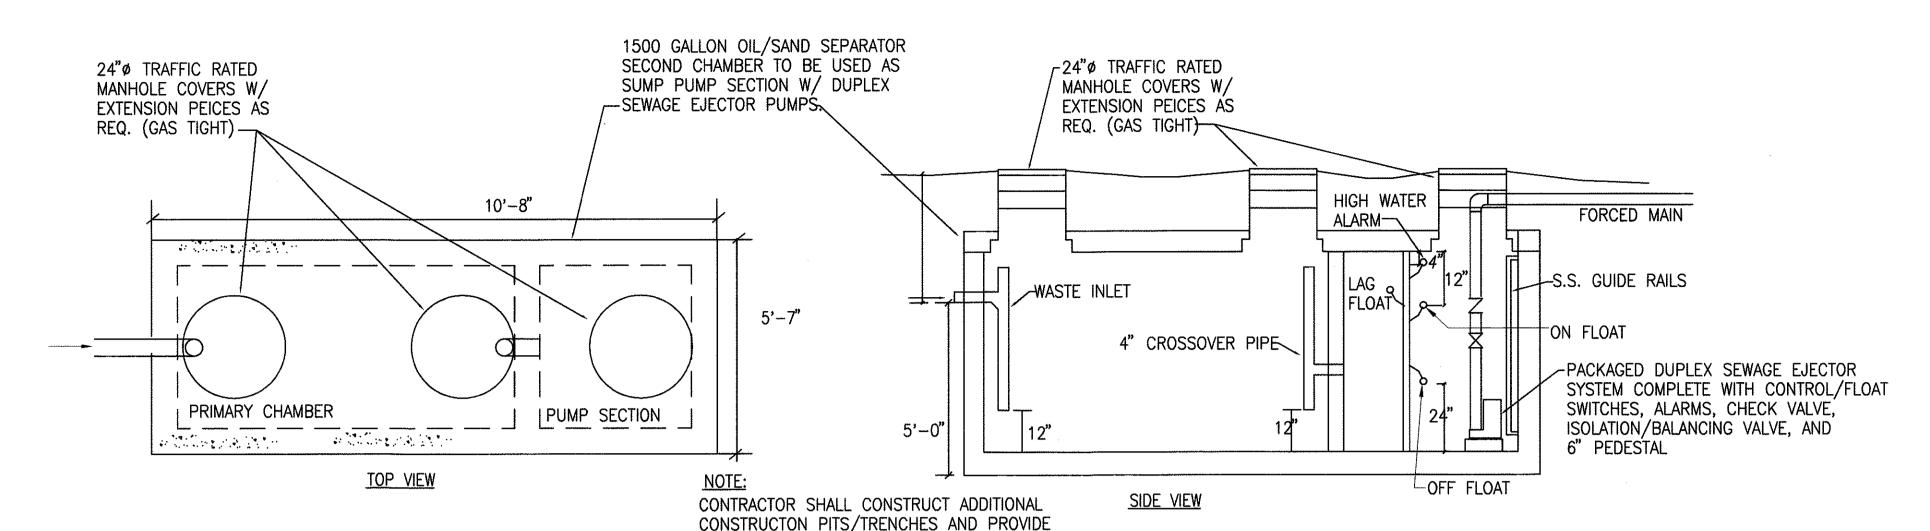

#### SAND/OIL SEPARATOR NOTES:

- 1) ALL CONCRETE SHALL DEVELOP A MINIMUM COMPRESSIVE STRENGTH OF 3000 PSI AT 28 DAYS.
- 2) CEMENT TO BE PORTLAND CEMENT CONFORMING TO ASTM C 150.
- 3) REINFORCING STEEL SHALL BE INTERMEDIATE GRADE, DEFORMED CONFORMING TO ASTM A-616 GRADE 40.
- 4) REINFORCING BARS SHALL BE IN LONG LENGTHS AND SHALL BE LAPPED A MINIMUM OF 15 INCHES, OR 40 BAR DIAMETERS.
- 5) ALL TANKS SHALL BE COATED ON THE INTERIOR AND EXTERIOR & SHALL BE APPLIED PER MANUFACTURER'S RECOMMENDATIONS.
- 6) TANKS SHALL BEAR ON UNDISTURED SOIL A MINIMUM OF 12" BELOW ORIGINAL GRADE ON A SOLID BED AND TO BE INSTALLED LEVEL.

- 7) IF TANK HOLE IS OVEREXCAVATED OR HAS A ROCKY UNLEVEL BOTTOM, 2" SAND-PEA GRAVEL 8" THICK SHALL BE ADDED TO LEVEL BOTTOM.
- 8) FILL TANK WITH WATER AFTER IT HAS BEEN SET IN PLACE AND THE SIDES BACKFILLED.

TEMPORARY DEWATERING PUMPS AS REQUIRED

- 9) ALL PIPES LEAVING/ENTERING TANKS SHALL BE SEALED WITH A NON-SHRINK GROUT MIX.
- 10) THE TANK MANUFACTURER SHALL SUBMIT TWO (2) SETS OF PLANS STAMPED BY A STRUCTURAL ENGINEER OF EACH TANK DRAWN TO SCALE TO THE WASTEWATER BRANCH, HAWAII DEPARTMENTS OF HEALTH AND THE DESIGN ENGINEER FOR APPROVAL BEFORE FABRICATION. THE PLANS SHALL COVER ALL OF THE AREA WITH AN APPROVED WATERPROOF COATING AND SHALL SHOW ALL DIMENSION, MANHOLES, TEES, BAFFELS, COMPARTMENT WALLS AND CLEANOUTS. MATERIAL SPECIFICATIONS, LIQUID AND WATER VOLUME CALCULATIONS, INSTALLATION AND MAINTENANCE INSTRUCTIONS AND MANUFACTURER'S NAME, ADDRESS AND PHONE NUMBER SHALL BE SUBMITTED UNDER SEPARATE COVER.

PRECAST CONCRETE PIT SHALL HAVE WATERPROOFING ON INTERIOR AND EXTERIOR. GROUND WATER TO BE PUMPED INTO SUMP AS SUMP BEING INSTALLED. WATER SHALL BE ALLOWED TO SETTLE PRIOR TO DISCHARGING.




THIS WORK WAS PREPARED BY ME OR UNDER MY SUPERVISION


STATE OF HAWAII DEPARTMENT OF TRANSPORTATION HIGHWAYS DIVISION

CENTRALIZED DISTRICT OFFICE AND BASEYARD COMPLEX LIHUE, KAUAI

PROJECT NO. HWY-K-03-98 OIL/WATER SEPARATOR DETAILS

SCALE: AS NOTED DATE: MARCH 30, 0° SHEET NO. M8.08 OF 150 SHEETS

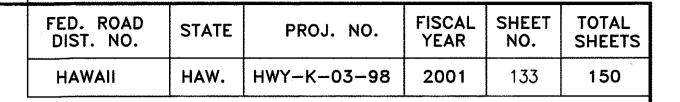

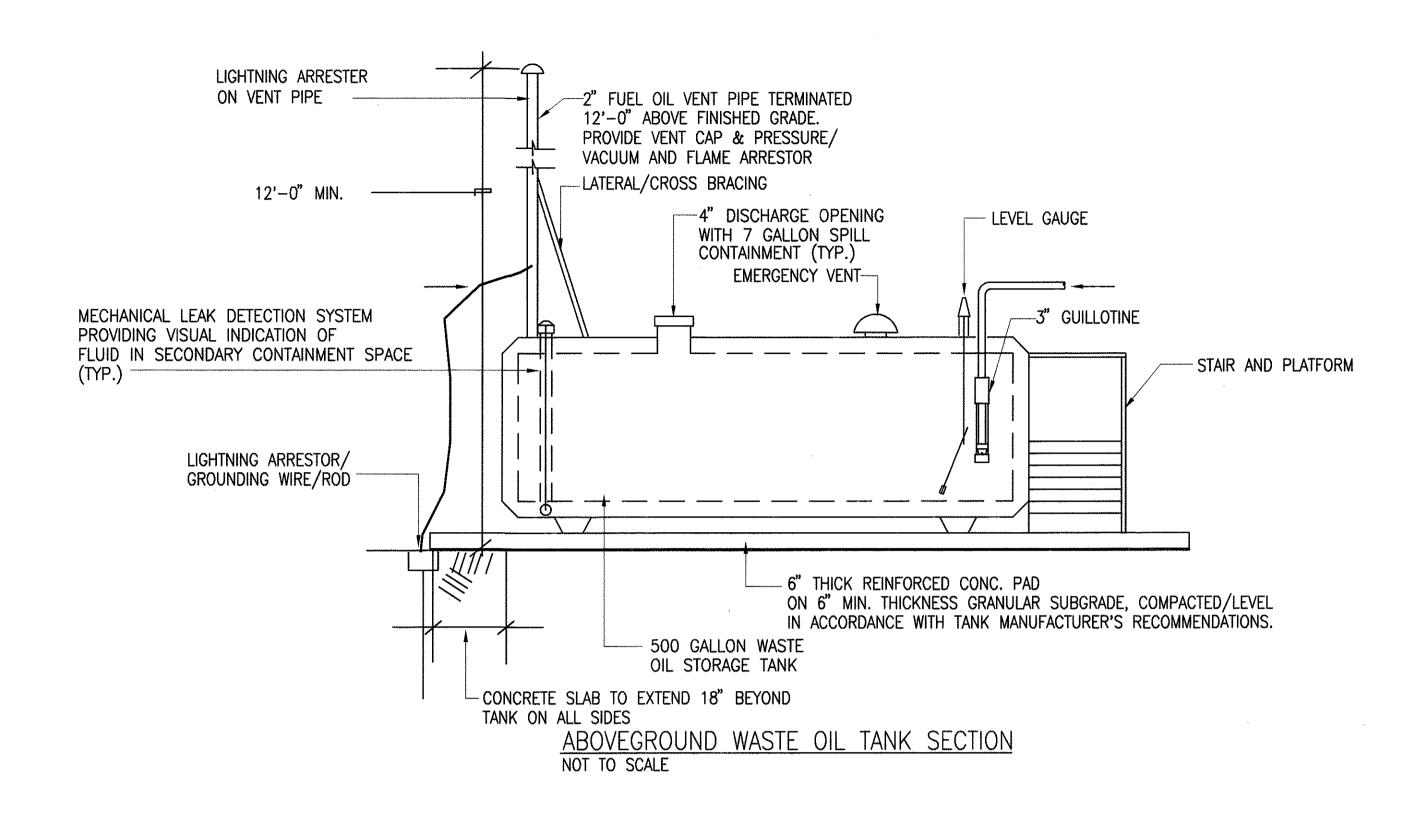

WARNING AND SAFETY SIGNS:

1. "DANGER — FLAMMABLE LIQUIDS"

3" H X 1/2" STROKE, RED ON WHITE, ON ALL APPROACHABLE SIDES OF TANK.

2. "NO SMOKING" 3"H X 1/2" STROKE, RED ON WHITE, ON ALL APPROACHABLE SIDES OF TANK

3. "STOP MOTOR"

3" H X 1/2" STROKE, RED ON WHITE, AT DISPENSING ENDS OF TANK.

4. "OWNER/OPERATOR: STATE OF HAWAII, DEPARTMENT OF TRANSPORTATION, HIGHWAYS DIVISION, TEL. 274—3111"
1"H X 3/16" STROKE, RED ON WHITE, ON TANK.

5. IN CASE OF FIRE OR SPILL

1. USE EMERGENCY PUMP SHUTOFF.

2. REPORT THE ACCIDENT
FIRE DEPARTMENT NO. 911
LIHUE BASEYARD ADDRESS: XXXXXX
LIHUE, HAWAII 967XX

1"H X 3/16" STROKE, RED ON WHITE, ON OR UNDER DISPENSER

- 6. PRODUCT I.D. "WASTE OIL" ON DISPENSER. 1"H X 3/16" STROKE, RED ON WHITE.
- 7. STANDARD DECAL KIT, IF SUPPLIED WITH TANK, MAY BE USED SUBJECT TO APPROVAL BY THE ENGINEER.
- 8. ALL PROPOSED SIGNS AND DECALS SHALL BE SUBMITTED TO THE ENGINEER FOR REVIEW AND APPROVAL PRIOR TO INSTALLATION.

DANGER FLAMMABLE LIQUIDS
WASTE OIL
NO SMOKING
STOP MOTOR


WASTE OIL

DANGER
FLAMMABLE LIQUIDS

WASTE OIL TANK SIDE VIEW

END VIEW

SIGN INSTALLATION NOT TO SCALE

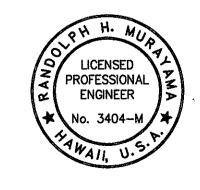

STATE OF HAWAII
DEPARTMENT OF TRANSPORTATION
HIGHWAYS DIVISION

TRAILITED DISTRICT C

CENTRALIZED DISTRICT OFFICE AND BASEYARD COMPLEX LIHUE, KAUAI

PROJECT NO. HWY-K-03-98
WASTE OIL TANK DETAILS

SCALE: AS NOTED

SHEET NO. M8.08 OF 150 SHEETS

177

DATE: MARCH 30, 01

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SIGNATURE

33