

GENERAL NOTES:

- 1. ALL ELECTRICAL ITEMS INDICATED ON THE DRAWINGS ARE NEW AND SHALL BE PROVIDED BY THE CONTRACTOR UNLESS INDICATED AS "EXISTING", OR AS OTHERWISE NOTED.
- 2. ALL LOCATIONS SHOWN ON THE DRAWING FOR ITEMS OF WORK TO BE FURNISHED AND/OR INSTALLED ARE APPROXIMATE. THE CONTRACTOR SHALL SELECT LOCATIONS TO SUIT FIELD CONDITIONS SUBJECT TO APPROVAL OF THE ENGINEER.
- 3. CONTRACTOR SHALL INDICATE ALL FINAL LOCATIONS ON THE "AS-BUILT" DRAWINGS WHERE THEY DIFFER FROM THAT SHOWN ON THE DRAWINGS.
- 4. CONTRACTOR SHALL BE RESPONSIBLE FOR COORDINATING THE WORK AMONG THE VARIOUS TRADES AS NECESSARY TO AVOID CONFLICTS AND TO INSURE THE INSTALLATION OF ALL WORK WITHIN THE AVAILABLE SPACE.
- 5. CONTRACTOR SHALL INVESTIGATE AND TONE AREA BEFORE DIGGING OR EXCAVATING. THE CONTRACTOR SHALL VERIFY THE EXACT LOCATION OF ALL BURIED SEWER, WATER AND GAS PIPING, DRAINAGE STRUCTURES, AND ALL OTHER BURIED ITEMS WITH THE APPROPRIATE AGENCIES PRIOR TO DOING ANY EXCAVATION WORK.
- 6. ALL ELECTRICAL EQUIPMENT SHALL BE NEW AND WARRANTED BY THE MANUFACTURER.
- 7. EXISTING CONDITIONS, MATERIALS, SIZES, LOCATIONS, AND DIMENSIONS SHOWN ON THESE DRAWINGS REPRESENT THE BEST AVAILABLE INFORMATION OBTAINED FROM FIELD INVESTIGATION. PRIOR TO ORDERING MATERIALS AND EQUIPMENT, THE CONTRACTOR SHALL VERIFY ALL EXISTING CONDITIONS, MATERIALS, SIZES, LOCATIONS, AND DIMENSIONS THAT AFFECT THE WORK OF THIS PROJECT. NOTIFY THE ENGINEER OF ALL QUESTIONS IN WRITING AND RESOLVE ALL CONTRACTOR'S QUESTIONS AND CONCERNS PRIOR TO PROCUREMENT AND BEFORE START OF CONSTRUCTION.
- 8. ALL ELECTRICAL INSTALLATION SHALL BE IN ACCORDANCE WITH THE NATIONAL ELECTRICAL CODE, NATIONAL ELECTRICAL SAFETY CODE, AND FEDERAL, STATE, AND COUNTY GOVERNMENT STANDARDS, REGULATIONS, AND ORDINANCES.
- 9. EXISTING UNDERGROUND WATER, SEWER, DRAINAGE, GAS, ETC. LINES NOT INDICATED OR KNOWN. CONTRACTOR SHALL PROVIDE FOR THE REQUIRED MAN-HOURS TO INVESTIGATE AND TONE ALL AFFECTED AREAS PRIOR TO DIGGING OR EXCAVATING. CONTRACTOR SHALL PROVIDE ALL NECESSARY MEANS TO LOCATE ALL EXISTING BURIED ITEMS INTERFERING WITH NEW WORK. CONTRACTOR SHALL REPAIR OR REPLACE ANY DAMAGED BURIED ITEM TO THE SATISFACTION AND ACCEPTANCE OF THE ENGINEER. TOPOGRAPHIC SURVEY NOT USED OR AVAILABLE TO INDICATE ABOVE GROUND FEATURES SUCH AS FENCES. SHRUBS, BUSHES, TREES, PLANTS ETC. CONTRACTOR SHALL FAMILIARIZE HIMSELF WITH THE SITE WORKING CONDITIONS AND PROVIDE THE REQUIRED MAN-HOURS TO REMOVE AND REPLACE AND/OR REPAIR ANY AND ALL EXISTING ABOVE GROUND FEATURES AFFECTED BY THE NEW WORK. REPLACEMENT/REPAIR SHALL MATCH EXISTING CONDITIONS AND SHALL BE DONE TO THE SATISFACTION OF THE ENGINEER.
- 10. ALL EXPOSED CONDUITS AND FITTINGS, AND METAL PORTIONS OF EQUIPMENT ENCLOSURE SHALL BE FIELD PAINTED FOR CORROSION PROTECTION.
- 11. ALL EQUIPMENT SHALL BE PROPERLY MOUNTED, ANCHORED, AND SUPPORTED BY APPROVED METHODS FOR SEISMIC RESTRAINT OF .3G FORCES.
- 12. THE CONTRACTOR SHALL VERIFY THE EXACT LOCATION OF ALL TRAFFIC SIGNAL STANDARDS, HANDHOLES, AND CONTROLLERS WITH THE ENGINEER. THE CONTRACTOR SHALL STAKE-OUT LOCATIONS FOR APPROVAL BY THE ENGINEER.
- 13. THE CONTRACTOR SHALL VERIFY LOCATION OF ALL OVERHEAD UTILITY LINES TO AVOID CONFLICTS DURING CONSTRUCTION. CONTRACTOR SHALL NOTE ALL POSSIBLE HAZARDS, HOWEVER REMOTE, AND SHALL TAKE ALL NECESSARY PRECAUTIONS AS REQUIRED TO AVOID ANY AND ALL HAZARDS.

NOTES TO CONTRACTOR -GTE H.T.CO. REQUIREMENTS

- 1. ALL WORK SHALL BE IN STRICT ACCORDANCE WITH SPECIFICATIONS AND REQUIREMENTS OF GTE H. T. CO. FOR THE FACILITIES WITHIN THEIR JURISDICTION.
- 2. THE CONTRACTOR SHALL CLOSELY COORDINATE ALL WORK WITH GTE H. T. CO. ALL TRENCHES MUST BE INSPECTED BY H. T. CO. PRIOR TO BACKFILLING THE CONCRETE ENCASING OPERATIONS. THE CONTRACTOR SHALL NOTIFY THE H.T.CO. INSPECTOR AT KONA TELEPHONE NUMBER 329-4756 AT LEAST 72 HOURS PRIOR TO POURING OF CONCRETE OR BACKFILLING.
- 3. UNLESS OTHERWISE INDICATED, ALL CONDUITS, SWEEPS, COUPLINGS, ADAPTERS, AND BELL ENDS SHALL BE CARLON GT42, 2-INCH OR 4-INCH PVC CONDUIT MEETING GTE SPECIFICATION GTS-8342.
- 4. STONES, ROCKS, ETC. SHALL NOT BE USED WITH BACKFILL MATERIAL, ONLY SELECT MATERIALS SHALL BE USED AS BACKFILL MATERIAL.
- 5. A 4-INCH WIDE WARNING TAPE ORANGE IN COLOR WITH A BLACK IMPRINTED MESSAGE "WARNING STOP DIGGING-CALL GTE, COMMUNICATIONS CABLE BURIED BELOW. FAILURE TO COMPLY COULD RESULT IN LEGAL ACTION" SHALL BE PLACED 12-INCHES BELOW THE SURFACE OVER THE DUCT OR CONCRETE JACKET FOR THE ENTIRE LENGTH OF DUCT INSTALLATIONS. SEE H. T. CO. STANDARD DRAWING 34028. RECOMMENDED TAPE IS (1-800-827-8467) PART NUMBERS DTOGTE-41 (1000-FT.) AND DTOGTE-46 (6000-FT.).
- MINIMUM 20 FOOT RADIUS CURVES.
- LESS THAN 12-INCHES LONG AND HAVING A DIAMETER OF ONE-FOURTH THROUGH EACH CONDUIT AFTER WHICH A BRUSH WITH STIFF BRISTLES EARTH, SAND, OR GRAVEL HAVE BEEN LEFT IN THE CONDUIT. RECOMMENDED 4-INCH MANDRELS/BRUSHES ARE MADE BY GENERAL MACHINE PRODUCTS CO. (GMP), TREVOSE, PA (215-357-5500). RECOMMENDED GMP PART NO. 81824R (TEST MANDREL FOR 4-INCH CONDUIT), AND GMP PART NO.17094 (BRUSH FOR 4-INCH CONDUIT). RECOMMENDED 2-INCH MANDRELS ROAD, MANKATO, MN 56001 (1-800-533-2077). RECOMMENDED CONDUX PART NO. 08013020 (TEST MANDREL FOR 2-INCH CONDUIT) AND PART NO.
- 08028900 (BRUSH FOR 2-INCH CONDUIT). 8. INSTALL NEPTCO WP1800P MULETAPE IN ALL NEW CONDUITS AND CAP ALL CONDUITS AFTER TESTING. THE NEPTCO MULETAPE IS AVAILABLE IN 3000 FT., 6500 FT., AND 10000 FT. REELS. THE NEPTCO MULETAPE IS PRE-LUBRICATED AND PRINTED WITH SEQUENTIAL FOOTAGE MARKINGS. USING THE NEPTCO MULETAPE, THE CONTRACTOR SHALL MEASURE AT LEAST ONE CONDUIT OF A COMMON DUCT RUN. THE DISTANCE SHALL BE MARKED ON THE RECORD PRINTS AND SUBMITTED TO THE H. T. CO. INSPECTOR FOR RECORD KEEPING.
- 9. ALL CONDUITS SHALL ENTER PULLBOXES/MANHOLES AT 90 DEGREE ANGLE AND FLUSH WITH FLARED OR BELL ENDS TO PREVENT CABLE DAMAGE.
- 10. PROVIDE A 5/8 INCH X 8-FT. GALVANIZED GROUND ROD IN ALL OTHER H. T. CO. PULL BOXES AND MANHOLES.
- 11. THE TOP OF ALL UTILITY BOXES SHALL BE 1-INCH ABOVE FINISH GRADE IN NON-PAVED SHOULDERS UNLESS OTHERWISE NOTED.
- 12. ALL DUCTS ASSOCIATED WITH PULLBOXES OR MANHOLES SHALL BE INSTALLED WITH ADEQUATE DRAINAGE TOWARD THE PULLBOXES OR MANHOLES. (MINIMUM ONE-FOURTH PERCENT UNLESS OTHERWISE NOTED).
- 13. ALL CONDUITS SHALL CONNECT TO PULLBOXES AND MANHOLES AT ENDS ONLY. NO CONNECTION TO SIDES WILL BE ALLOWED.

NOTES TO CONTRACTOR -HELCO REQUIREMENTS:

HAWAII HAW. 2000E-0.1-00 2000 48 60	FED. ROAD DIST. NO.	STATE	PROJ. NO.	FISCAL YEAR	SHEET NO.	TOTAL SHEETS
· · · · · · · · · · · · · · · · · · ·	HAWAII	HAW.	2000E-01-00	2000	48	60

- 1. ALL WORK SHALL COMPLY WITH THE SERVING UTILITY COMPANY'S REQUIREMENTS, SERVICE INSTALLATION MANUALS, AND RULES AND REGULATIONS.
- 2. RESOLVE ANY DISCREPANCY OR QUESTION WITH THE ENGINEER PRIOR TO START OF ANY WORK.
- 3. THE CONTRACTOR SHALL OBTAIN ALL REQUIRED STANDARD DRAWINGS AND INSTALLATION DETAILS FROM THE SERVING UTILITY COMPANIES. THE CONTRACT DRAWINGS DO NOT IN ANY WAY DUPLICATE THE STANDARDS OF THE UTILITY COMPANIES.
- 4. DO ALL NECESSARY EXCAVATION AND BACKFILLING OF DUCTLINES AS PER THE HELCO SPECIFICATION NO. CS-7001 AND CS-7004. PROVIDE WARNING TAPE PER H.T.CO. STANDARD DRAWING 34028.
- 5. FURNISH AND INSTALL SCH 40 PVC DUCTS AS INDICATED ON THE DRAWINGS WITH 3" CONCRETE ENCASEMENT AS INDICATED.
- 6. FURNISH AND INSTALL ALL HANDHOLES AS NOTED ON THE DRAWINGS.
- 7. ALL ELECTRIC DUCT LINES SHALL CONTAIN A POLYOLEFIN PULL LINE (JET LINE CAT. NO. 232 OR EQUIVALENT). (200 LB. MINIMUM TEST STRENGTH)
- 8. ALL WORK SHALL BE SUBJECT TO HELCO INSPECTION. CONTRACTOR SHALL GIVE HELCO 3 WORKING DAYS INSPECTION NOTICE PRIOR TO POURING OF CONCRETE, OR FOR ANY OTHER INSPECTION SERVICES.
- MANUFACTURED BY THOR ENTERPRISES, INC., SUN PRAIRIE, WE 53590 9. ALL ELECTRIC CONDUITS SHALL BE REAMED WITH A MANDREL 1/2" SMALLER IN DIAMETER THAN THE CONDUIT, DUCTS SHALL BE SWABBED AND CLEARED OF ALL BURRS AND FOREIGN MATERIAL.
- 6. MAIN DUCT RUNS EXCEPT RISER CONDUITS SHALL BE CONSTRUCTED WITH 10. REFER TO HELCO SERVICE DRAWINGS FOR SPECIFIC AND STANDARD DETAIL DRAWINGS.
- 7. AFTER THE CONDUITS ARE INSTALLED, A ROUND SOLID TEST MANDREL NOT 11. ALL BENDS DUE TO CHANGE IN GRADE SHALL HAVE A RADIUS BEND OF NOT LESS THAN 20'-0" (HORIZONTAL OR VERTICAL CHANGE).
 - INCH LESS THAN THE DIAMETER OF THE CONDUIT SHALL BE PULLED 12. ALL STREET LIGHT AND OTHER ELECTRICAL CONNECTION POINTS SHALL BE THOSE DESIGNATED BY HELCO.
 - SHALL BE PULLED THROUGH TO MAKE CERTAIN THAT NO PARTICLES OF 13. ANY QUESTIONS AS TO THE RESPONSIBILITY OF ANY WORK NOT SPECIFICALLY COVERED IN THESE NOTES AND ON THE DRAWINGS SHALL BE CLARIFIED WITH HELCO'S AND JSL'S ENGINEERING DEPARTMENT.
 - 14. ALL HANDHOLES, PULLBOXES, AND MANHOLES WITHIN THE ROAD R/W SHALL BE PLACED WITH TOPS FLUSH WITH FINAL GRADE, PAVEMENT, OR SIDEWALK AS APPLICABLE.
 - AND BRUSHES ARE MADE BY CONDUX INTERNATIONAL, INC., 145 KINGSWOOD 15. ELECTRICAL SERVICE INSTALLATION SHALL COMPLY WITH REQUIREMENTS. CONTRACTOR SHALL OBTAIN HELCO'S DRAWING NO. AND PROVIDE ELECTRICAL SERVICES AS INDICATED. CONTRACTOR SHALL CONSULT WITH ENGINEER WHERE HELCO'S DRAWING DIFFERS AND RESOLVE ALL QUESTIONS PRIOR TO START OF ANY ELECTRICAL SERVICE WORK.

(* - NOT AVAILABLE PRIOR TO BIDDING)



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STATE OF HAWAII DEPARTMENT OF TRANSPORTATION HIGHWAYS DIVISION


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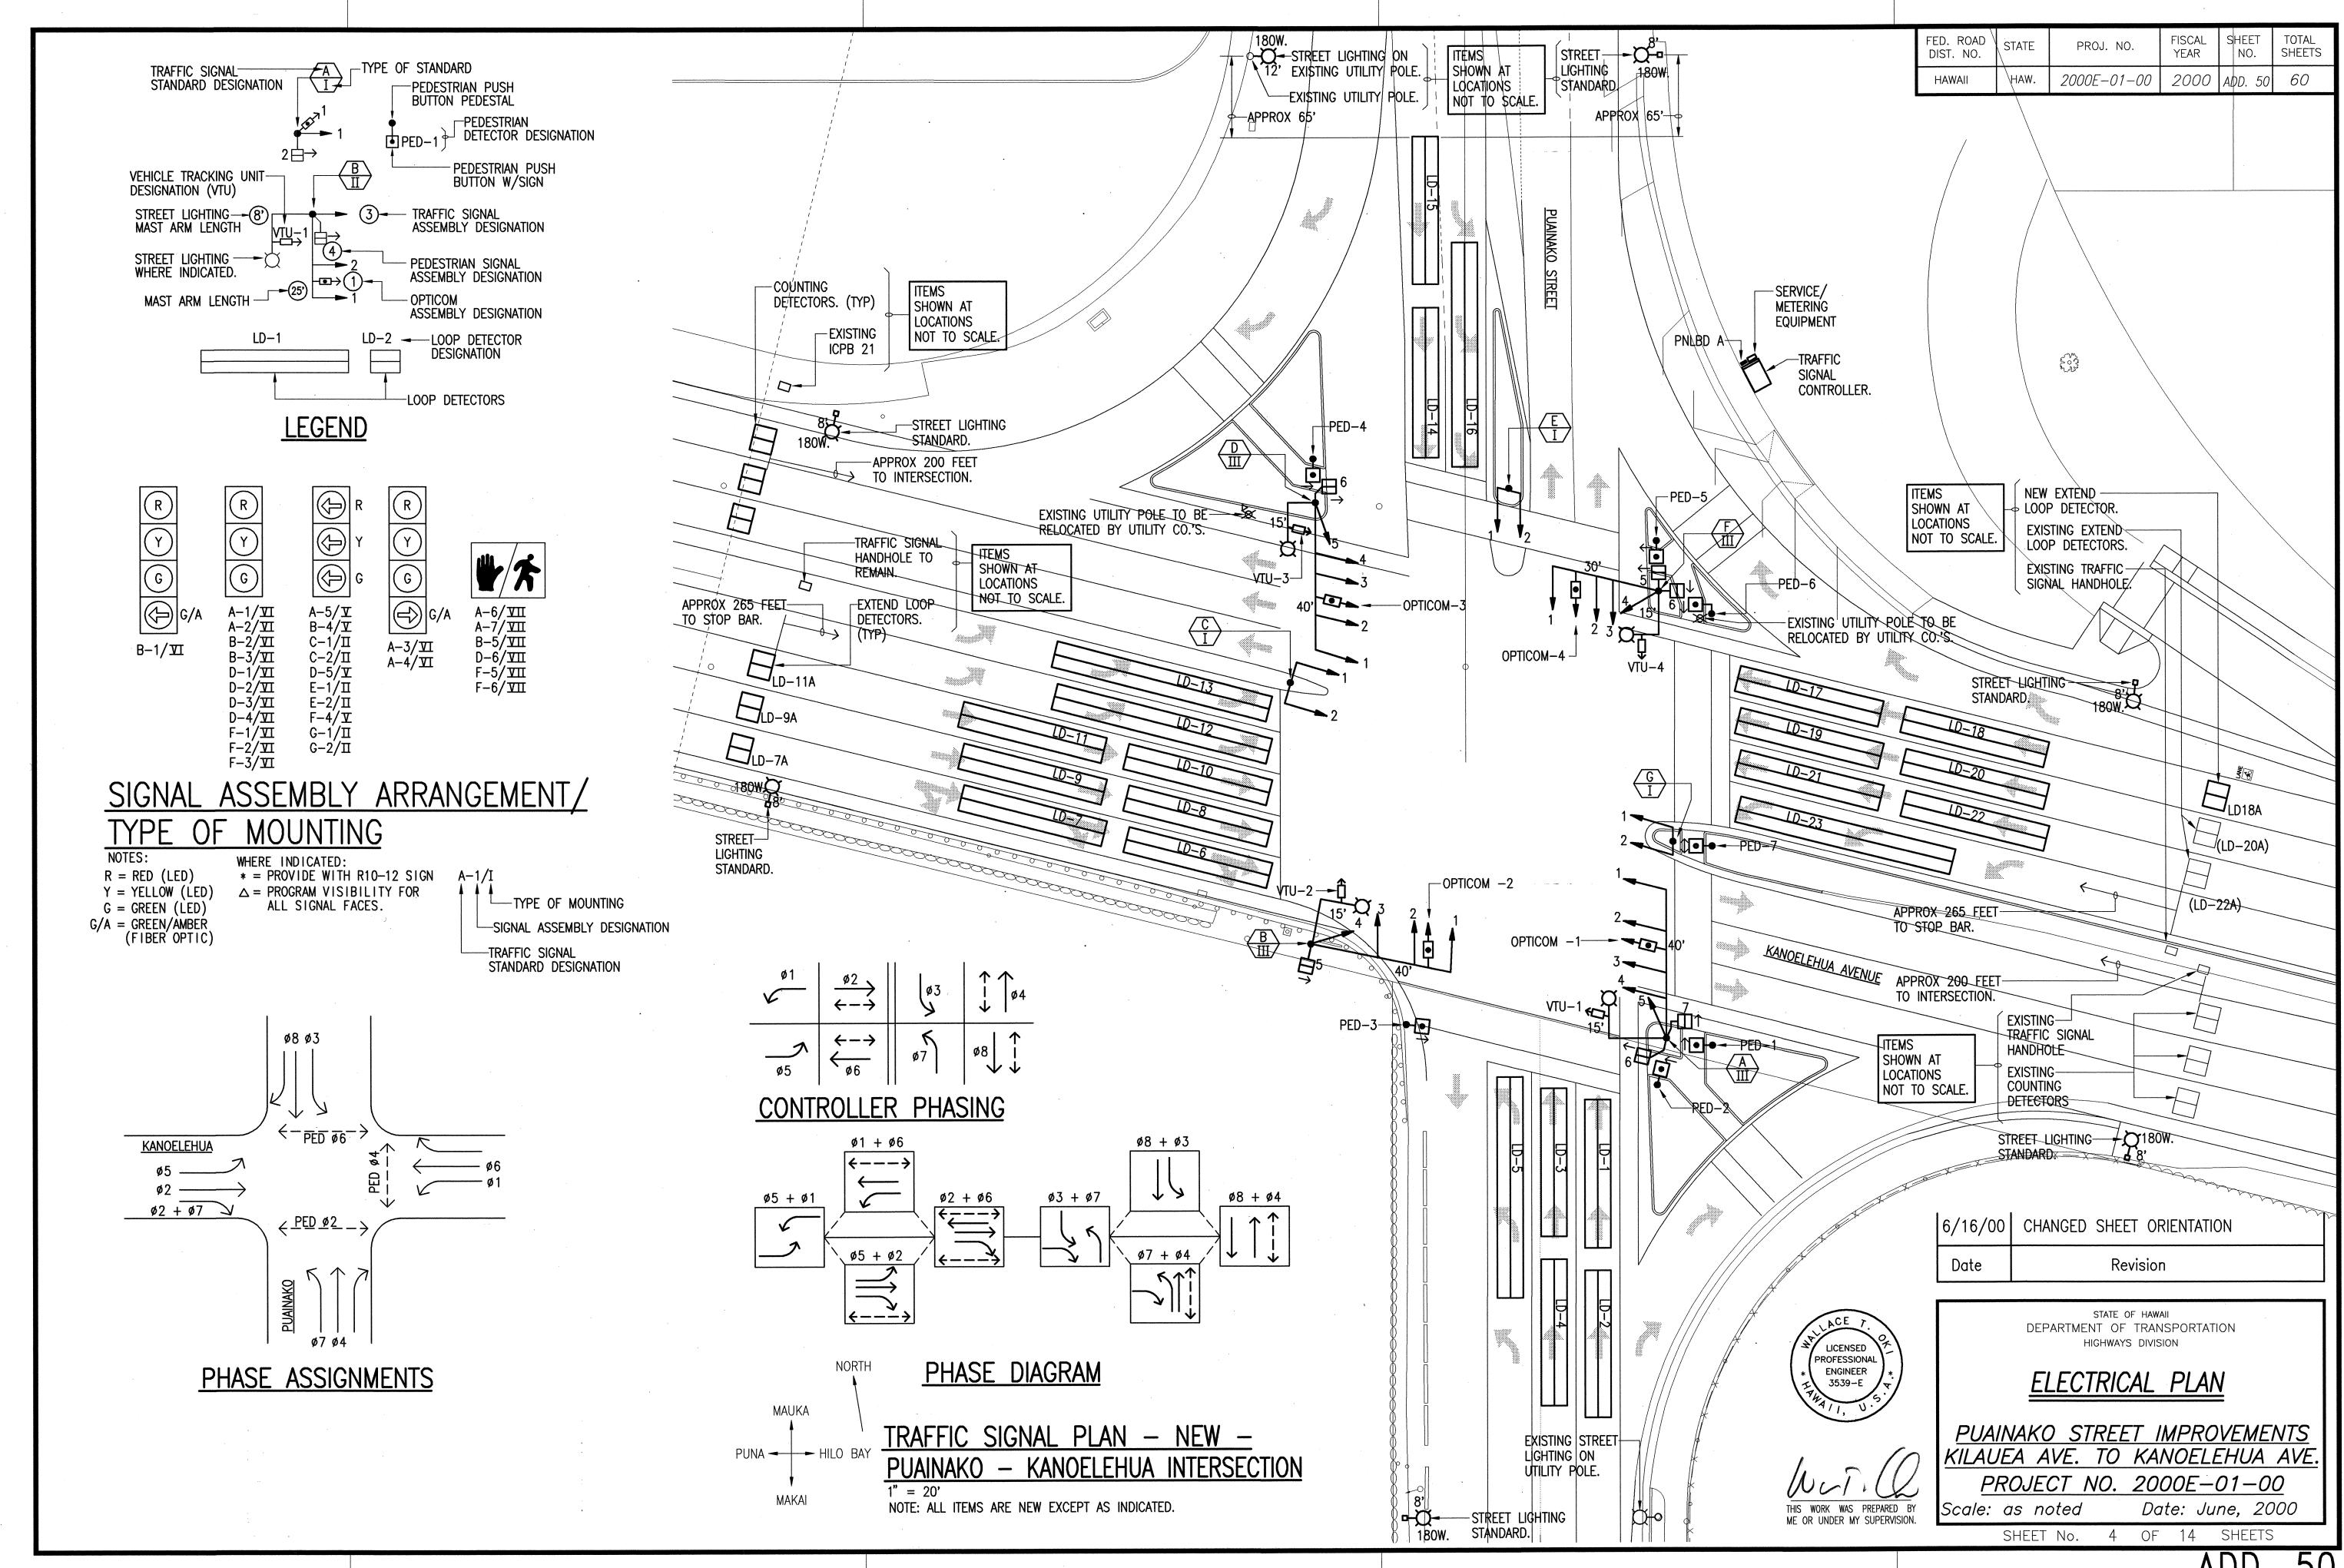
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Scale: as noted


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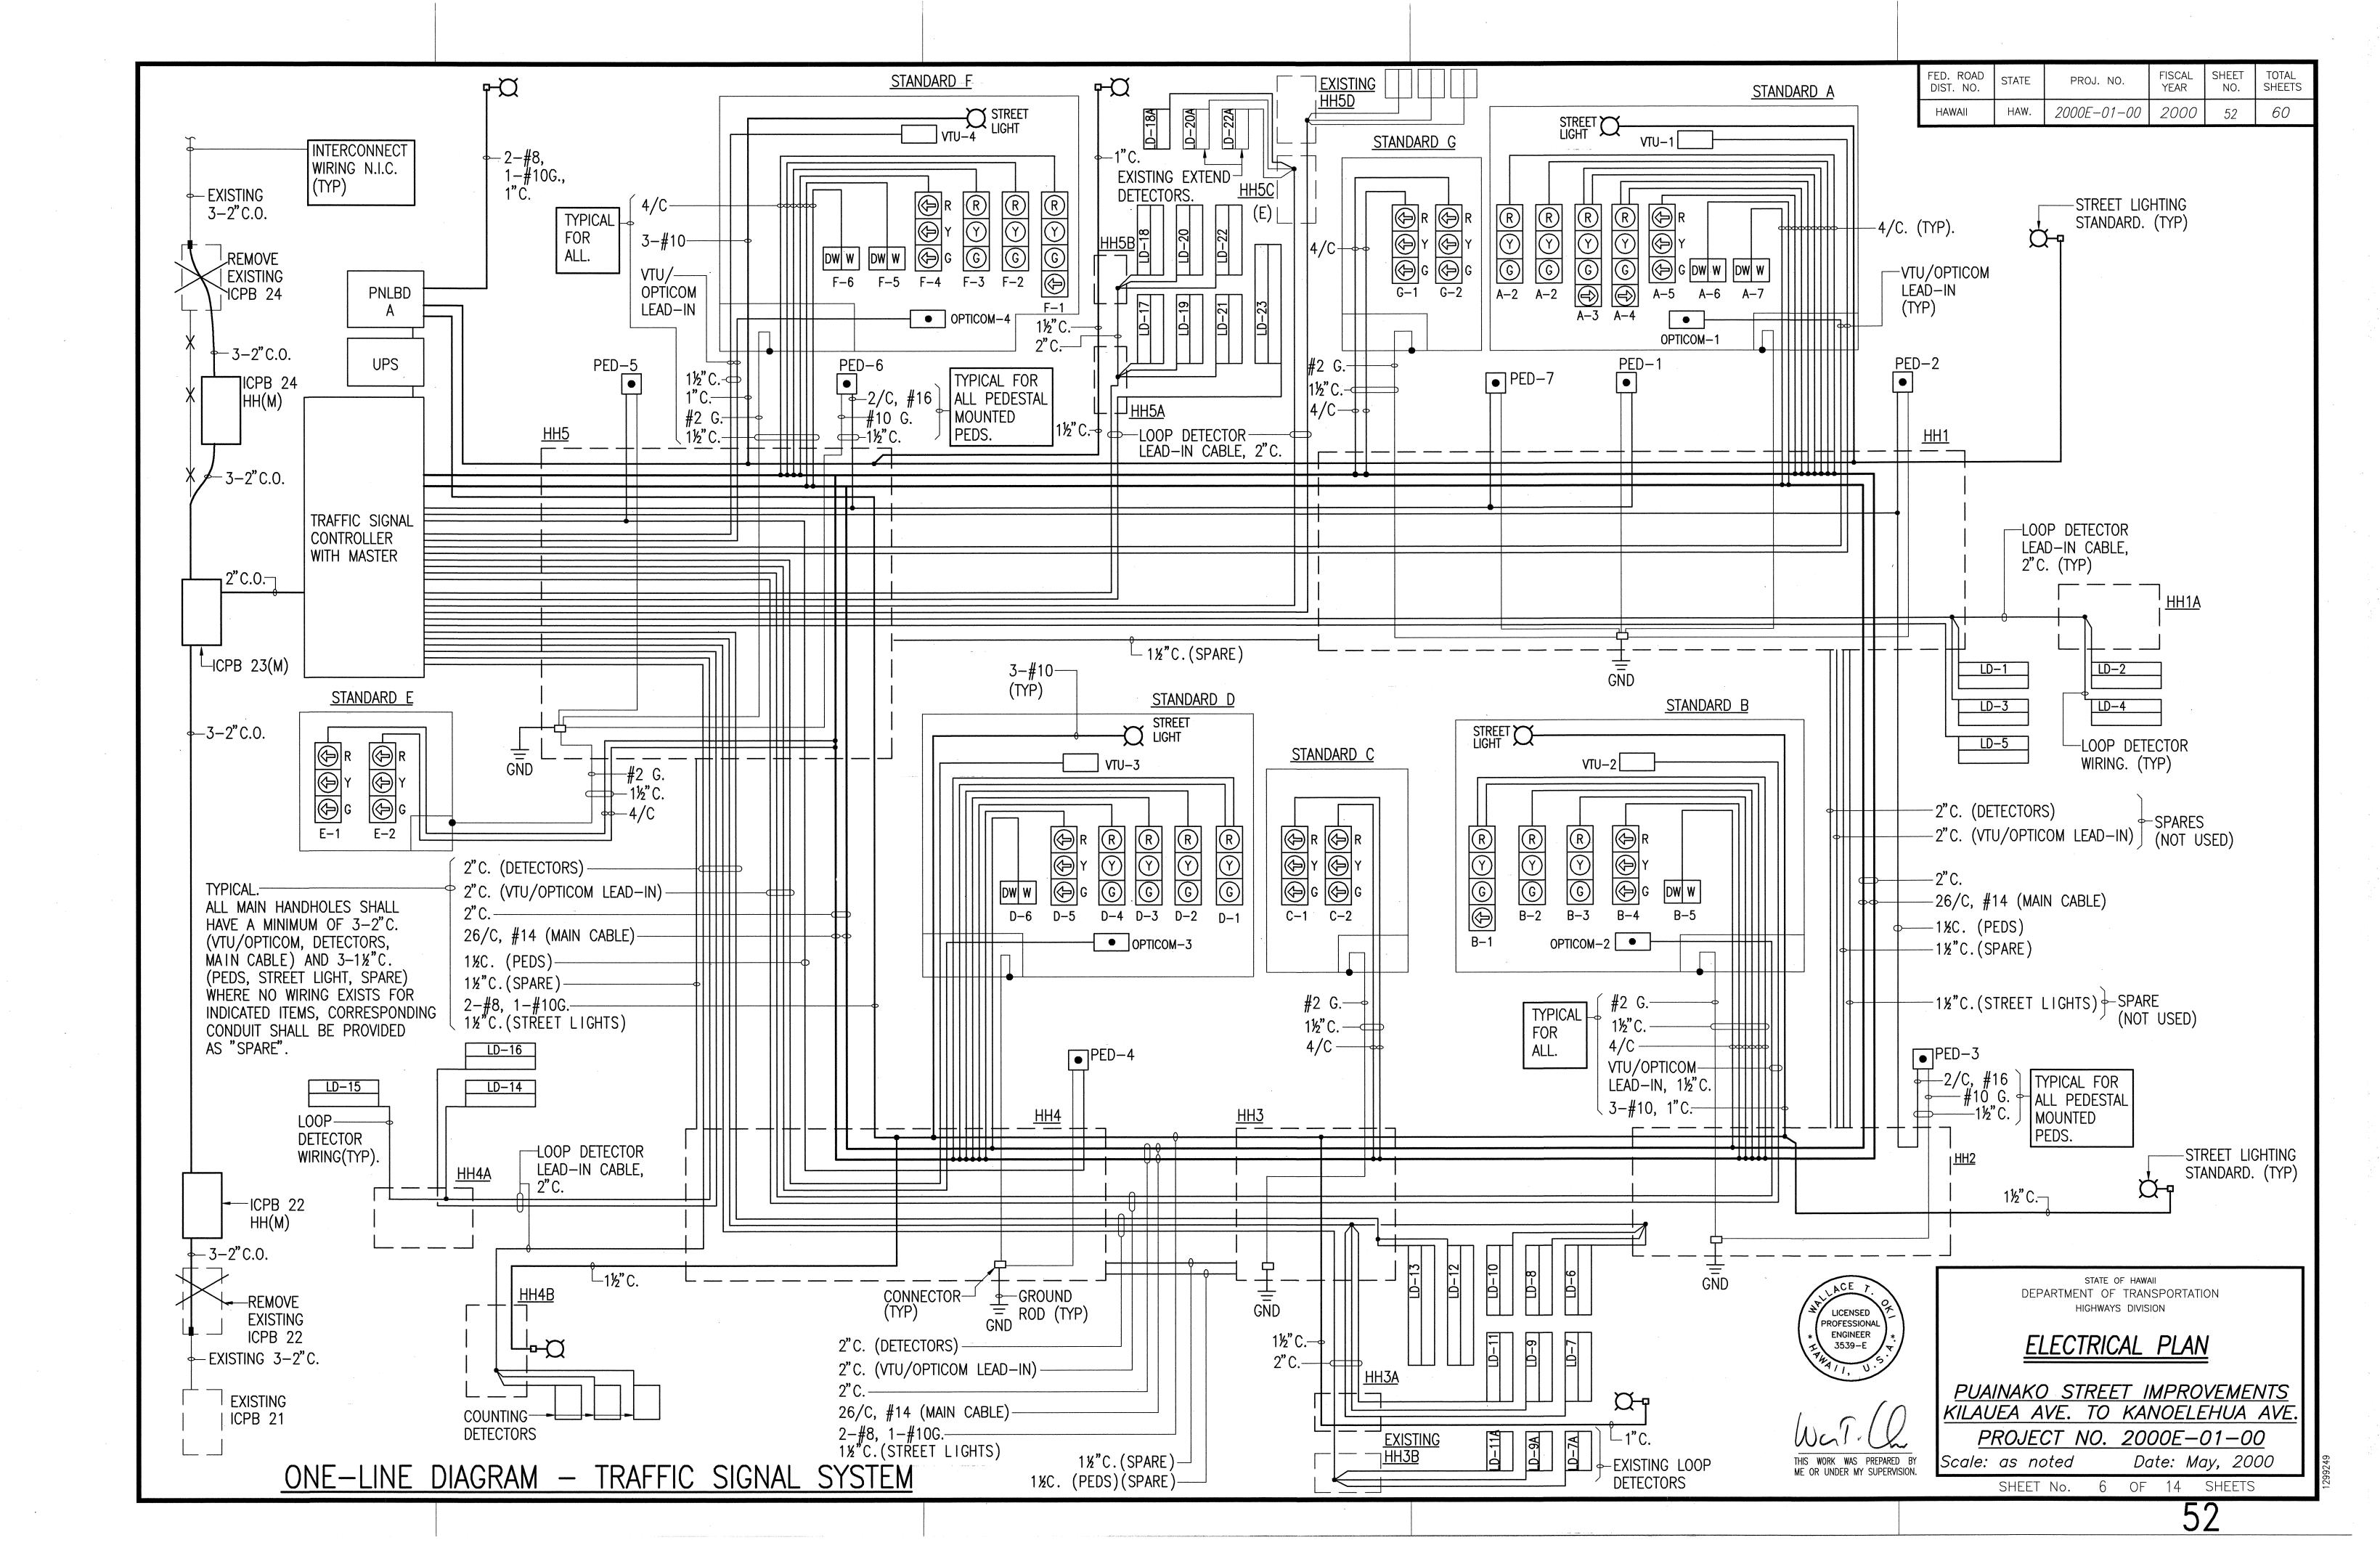
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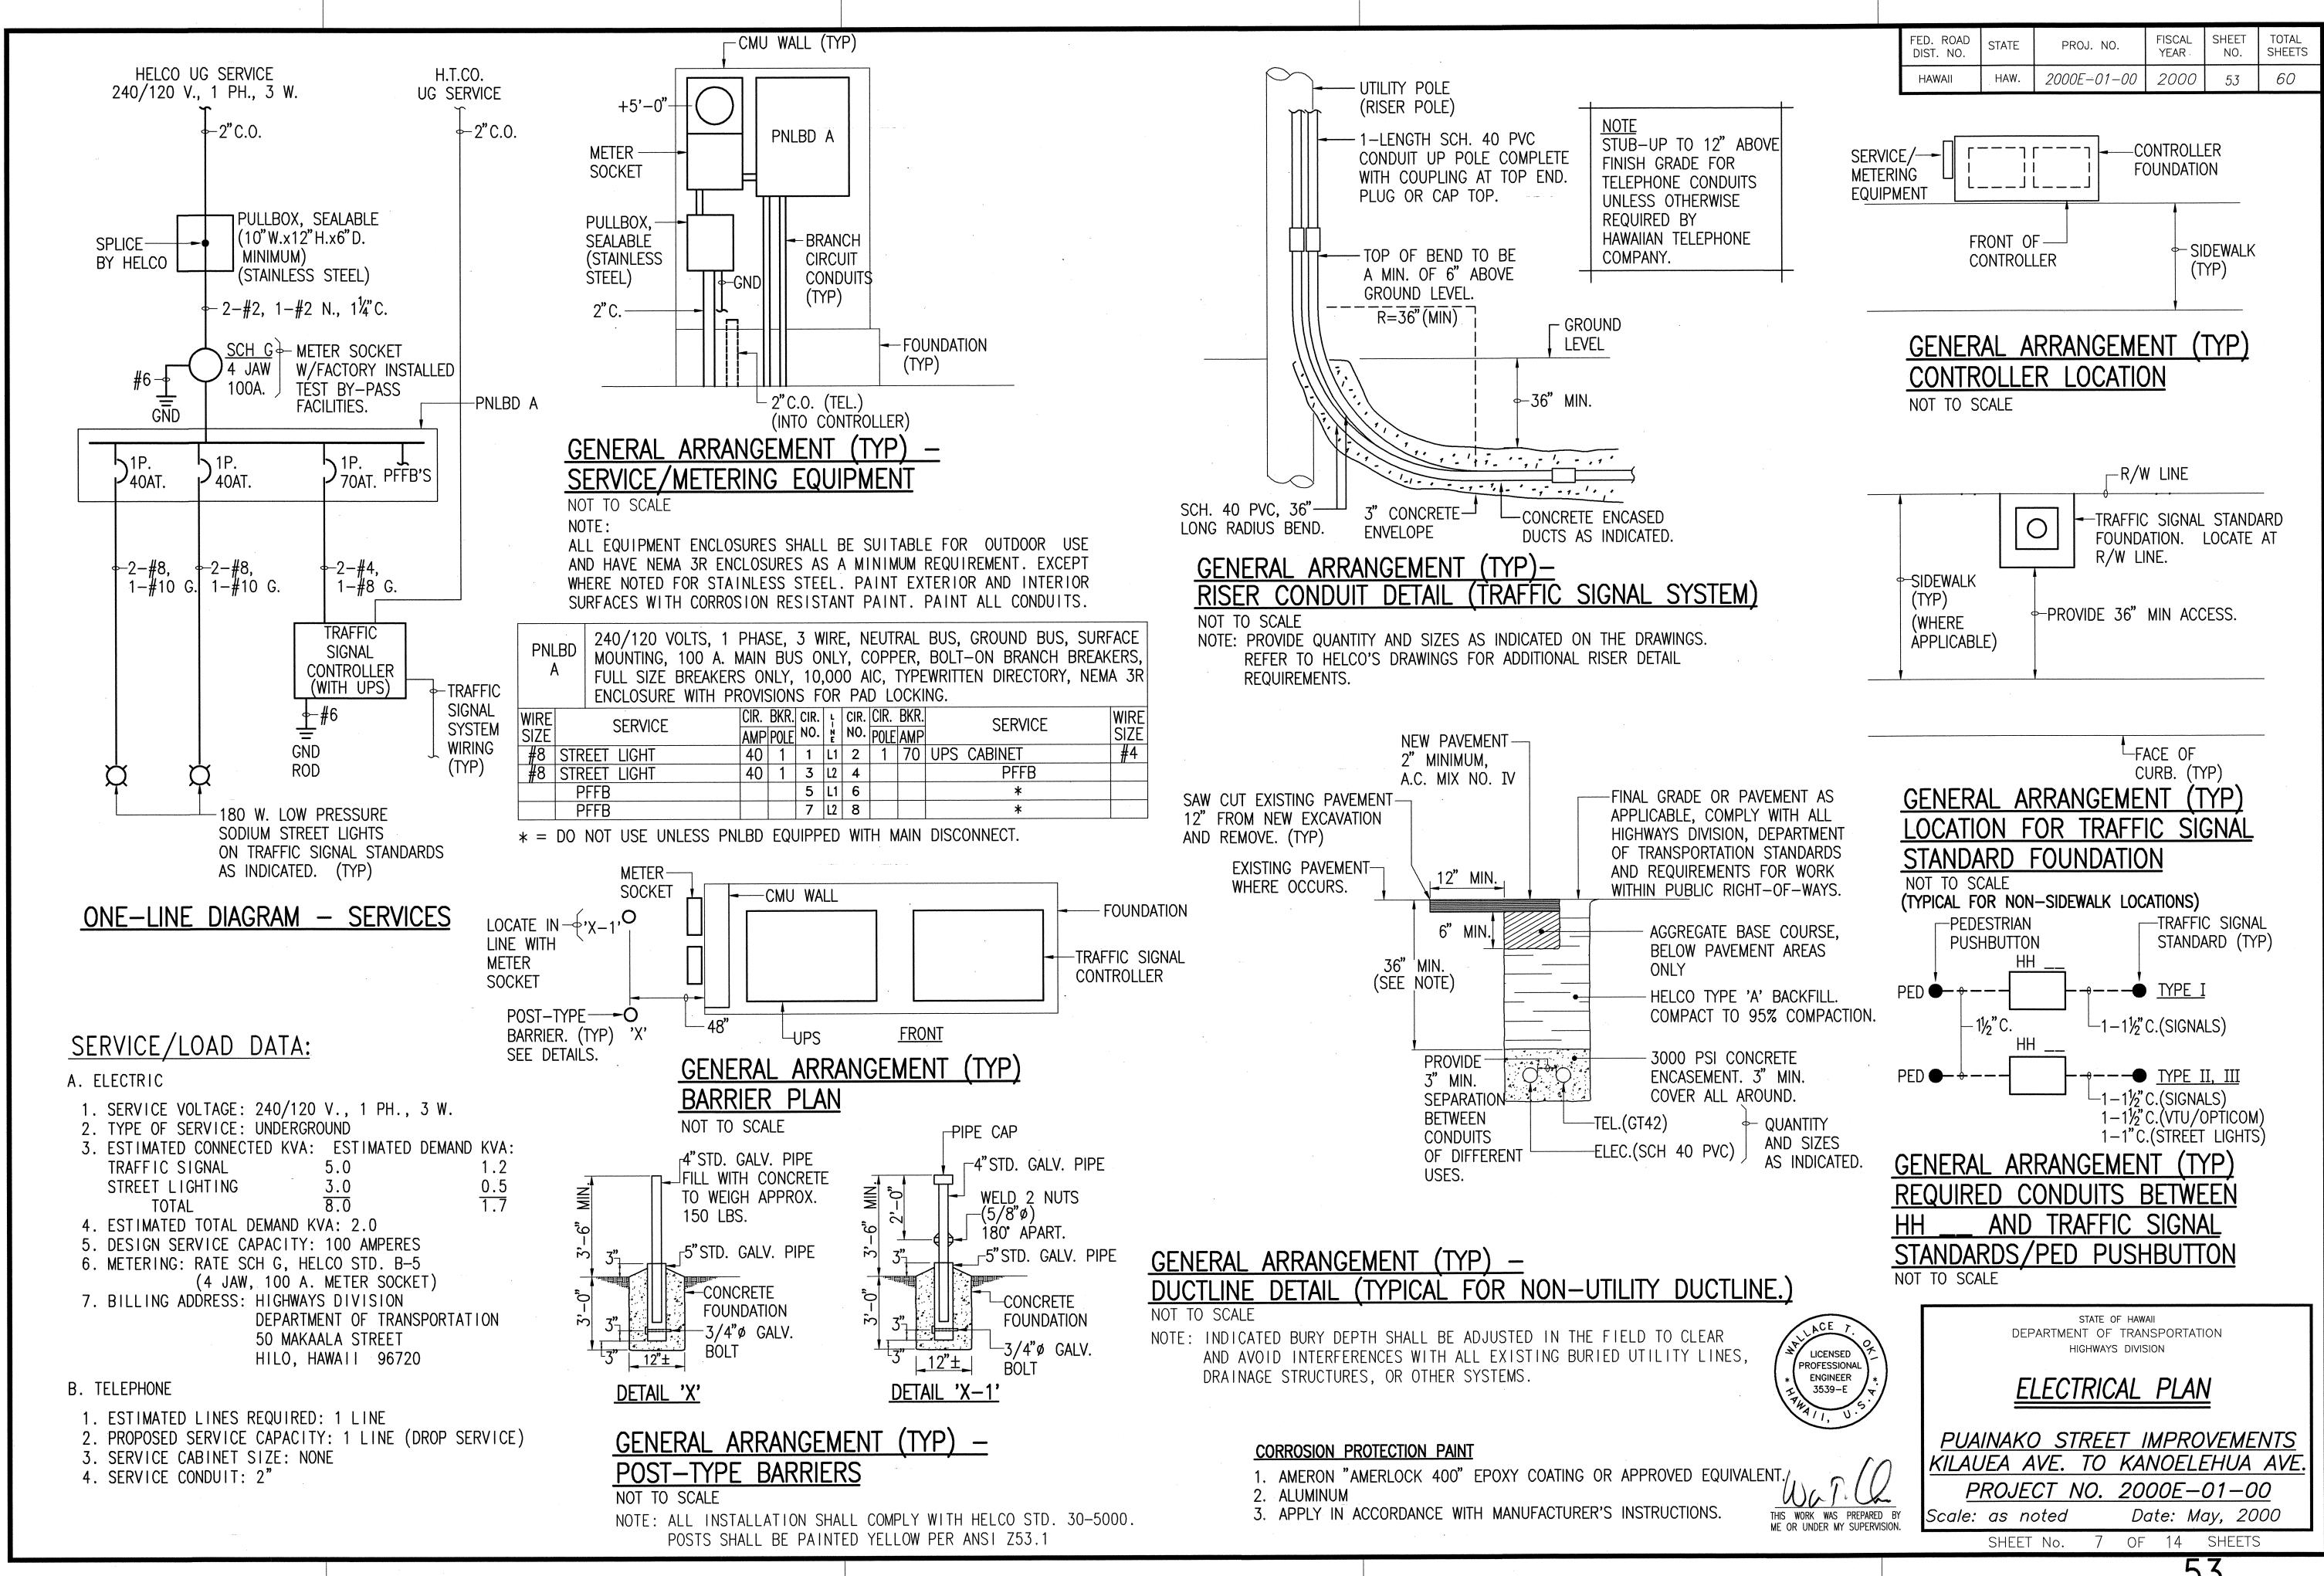





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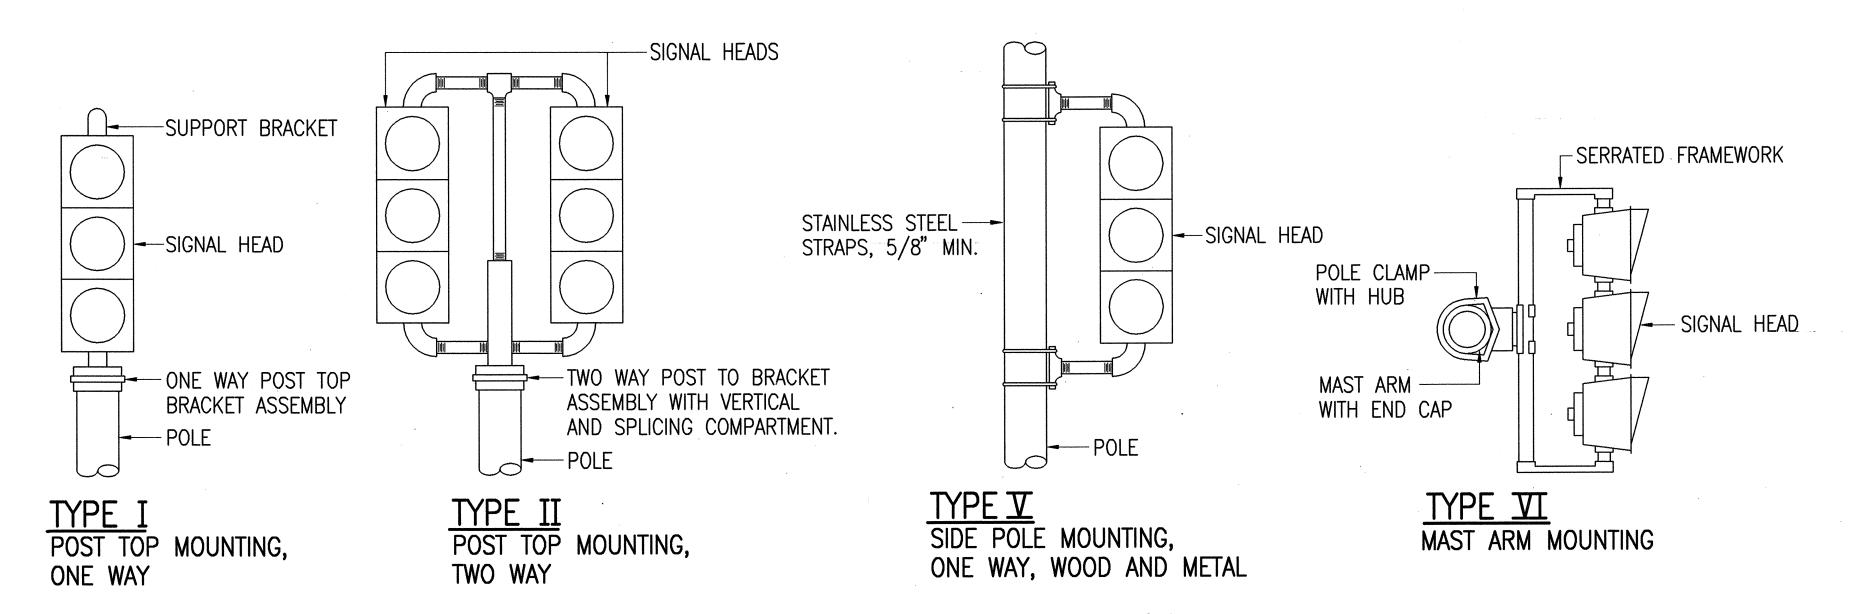




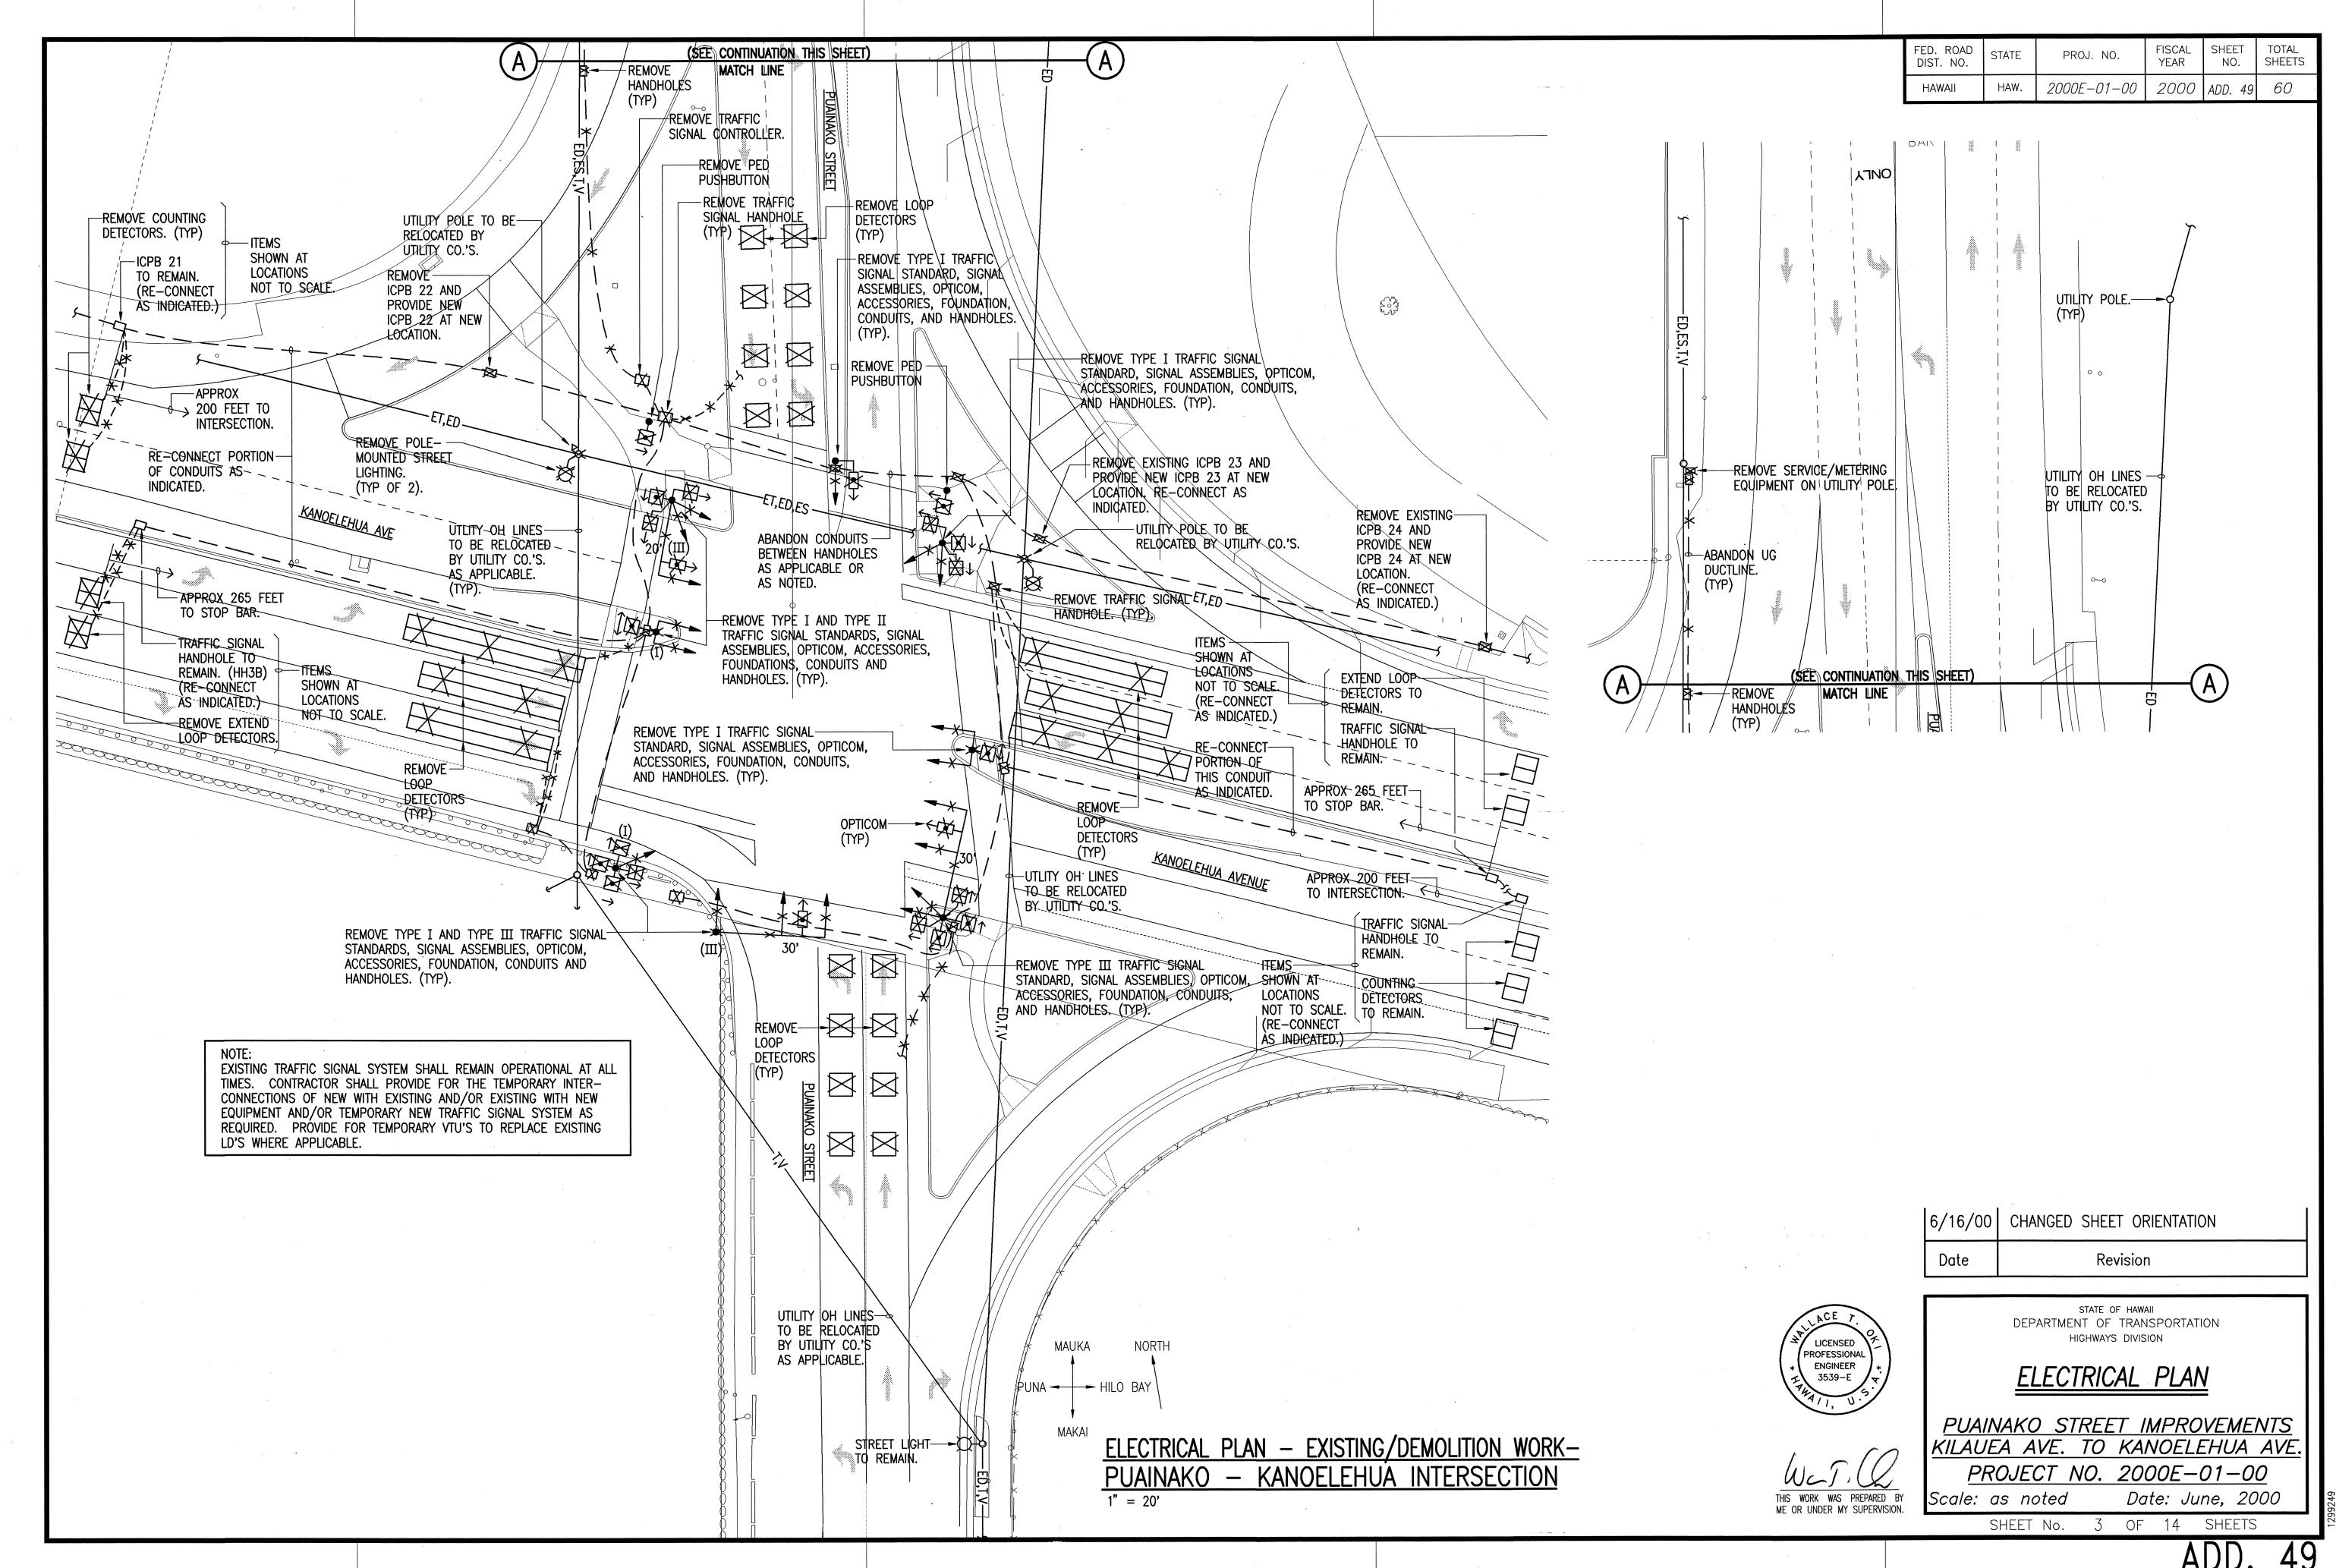

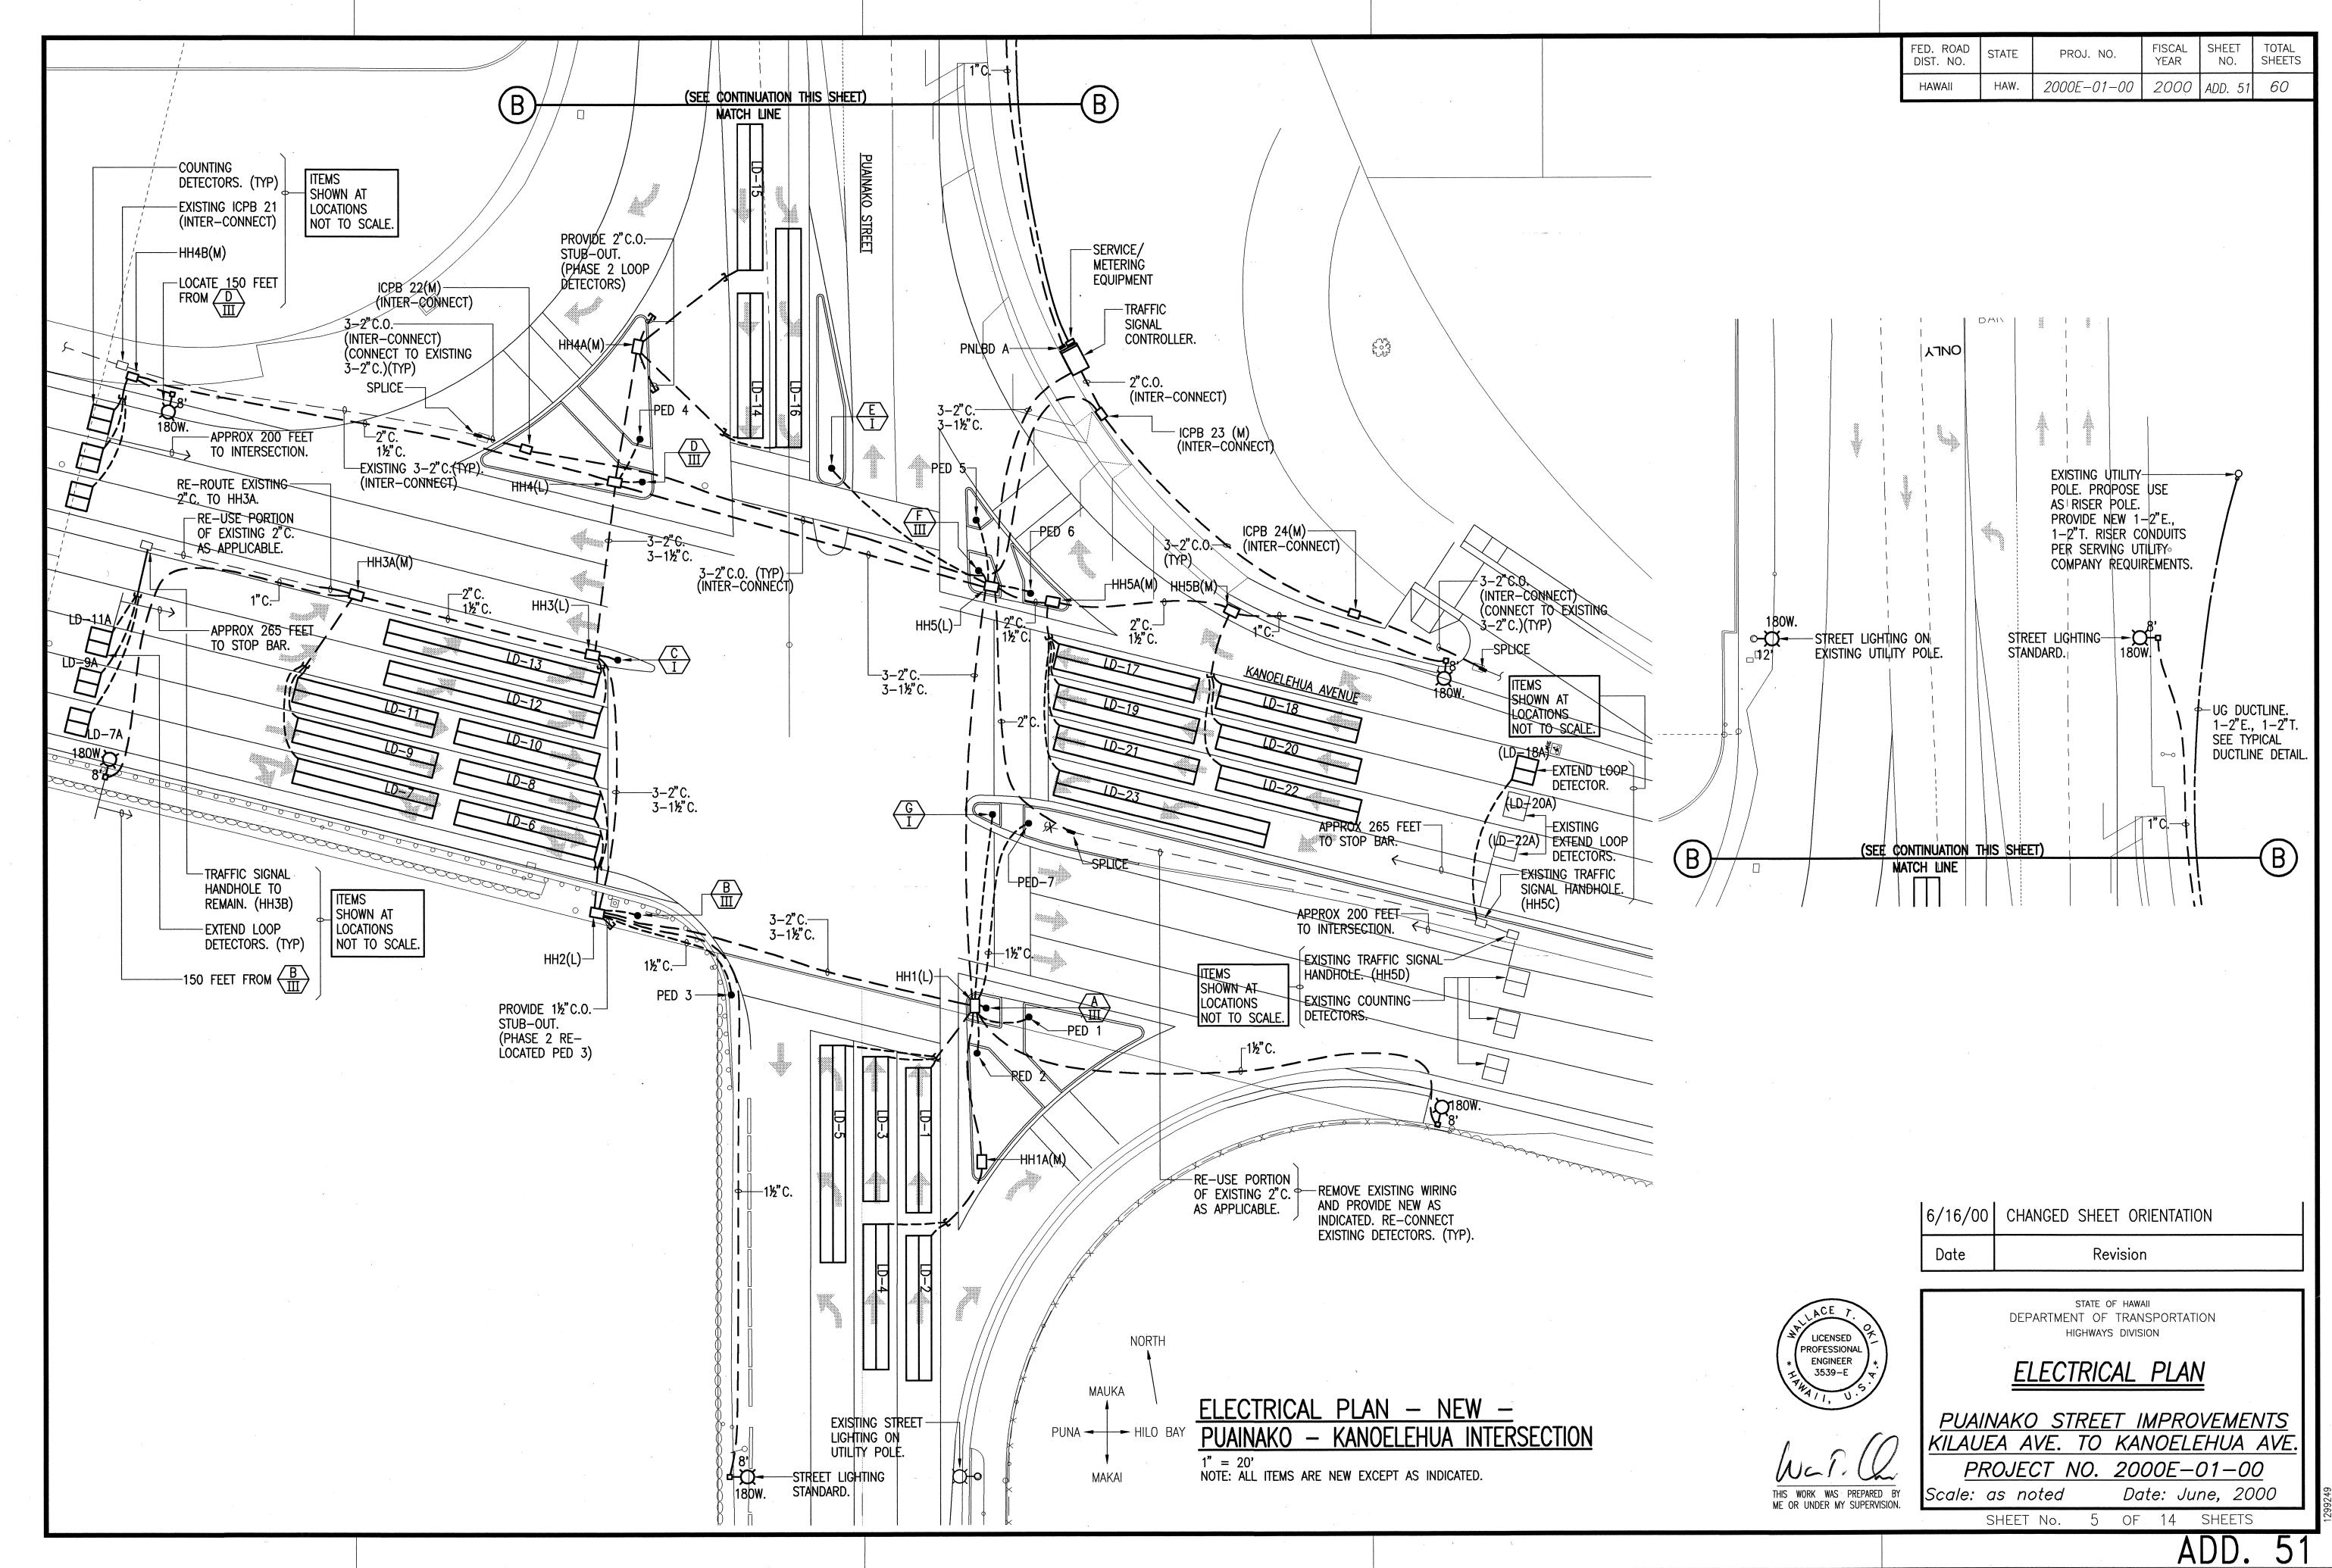

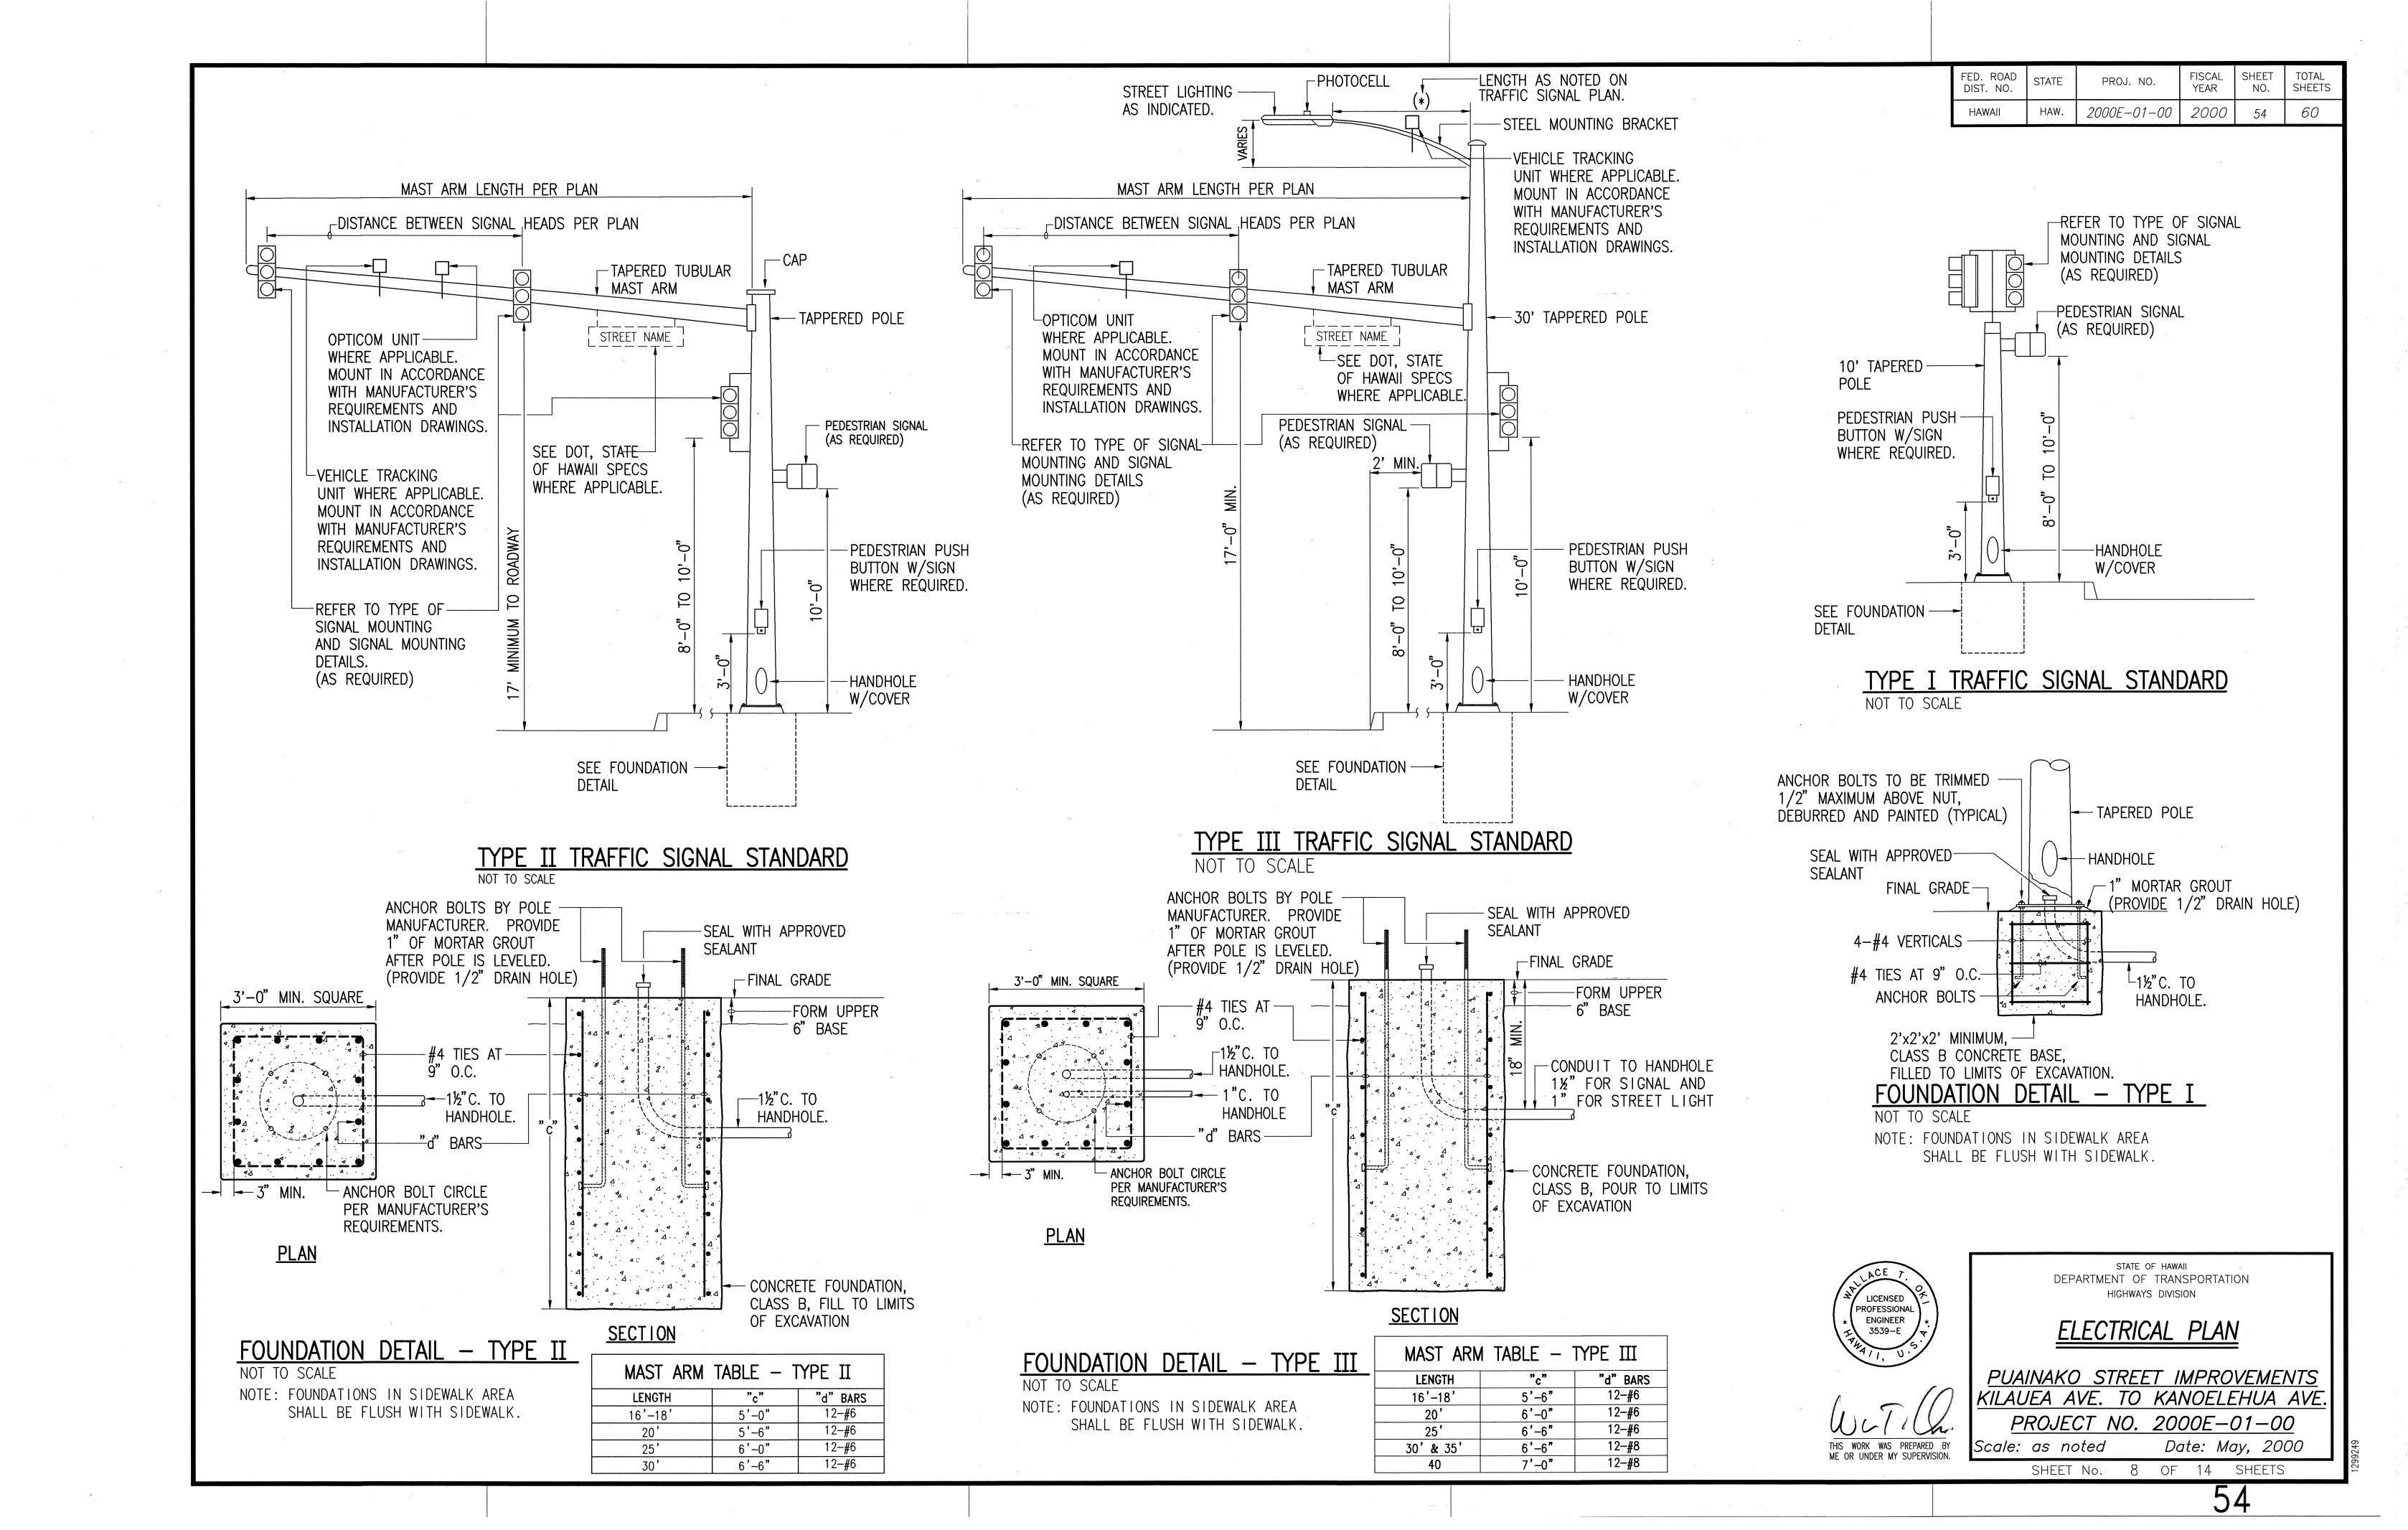FED. ROAD DIST. NO.	STATE	PROJ. NO.	FISCAL YEAR	SHEET NO.	TOTAL SHEETS
HAWAII	HAW.	2000E-01-00	2000	55	60



SIGNAL ASSEMBLY MOUNTING

NOT TO SCALE

NOTES:

INTERNATIONAL.

WITH CROSSING

ARROW TO BE-

LEFT OR RIGHT OR BOTH AS REQUIRED.

NOT TO SCALE

R10-4a(L), R10-4a(R)

OR R10-4a(L & R)

PEDESTRIAN PUSH BUTTON ASSEMBLY

ARROW.

WALK MAN SYMBOL

- 1. ALL THREADED ITEMS, i.e. BOLTS, FITTINGS, SCREWS, ETC., TO BE COATED WITH AN APPROVED ANTI-SEIZE COMPOUND PRIOR TO ASSEMBLY OR INSTALLATION.
- 2. ALL CIRCULAR SIGNAL HEADS (EXCEPT FIBEROPTIC AND PROGRAMABLE) SHALL HAVE APPROVED GLASS LENSES.


POLE.


TAP POLE


SCREWS

REQUIREMENTS.

-STAINLESS STEEL

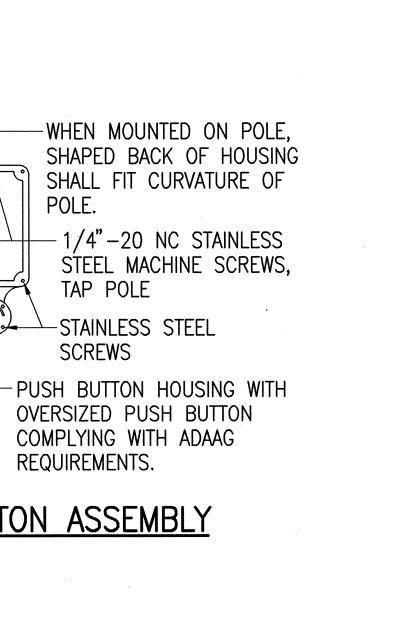

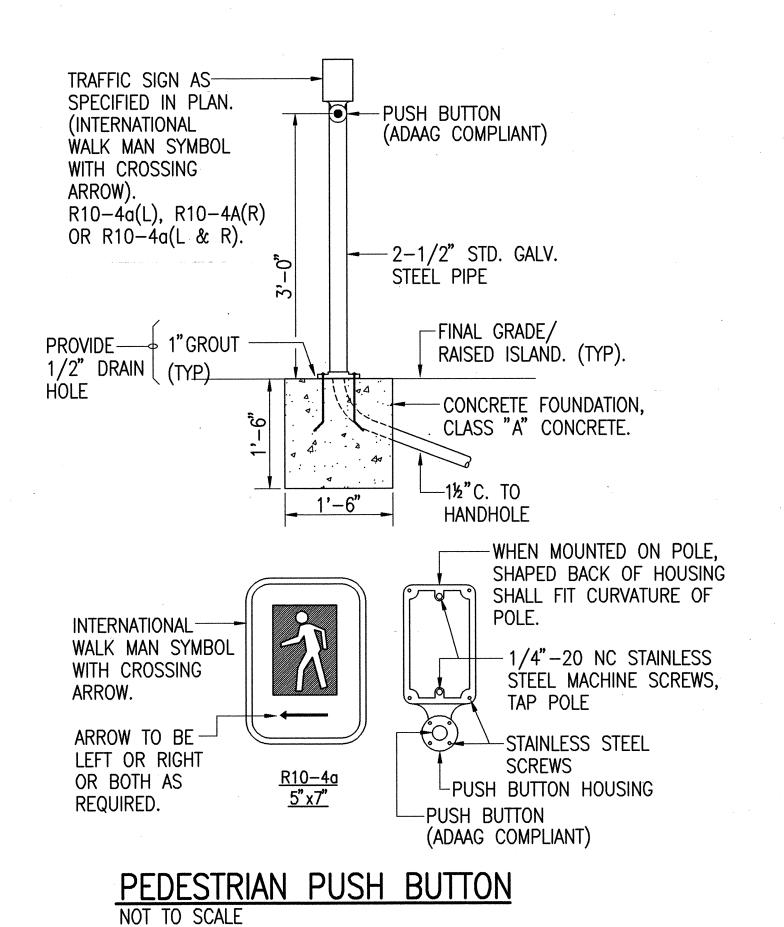

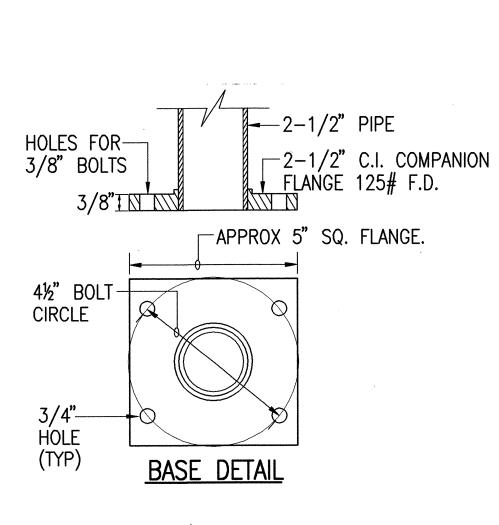

PEDESTRIAN PUSH-BUTTON MOUNTING NOT TO SCALE



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ELECTRICAL PLAN PUAINAKO STREET IMPROVEMENTS

KILAUEA AVE. TO KANOELEHUA AVE. PROJECT NO. 2000E-01-00

Scale: as noted Date: May, 2000


STATE OF HAWAII
DEPARTMENT OF TRANSPORTATION

HIGHWAYS DIVISION

OF 14 SHEETS SHEET No.


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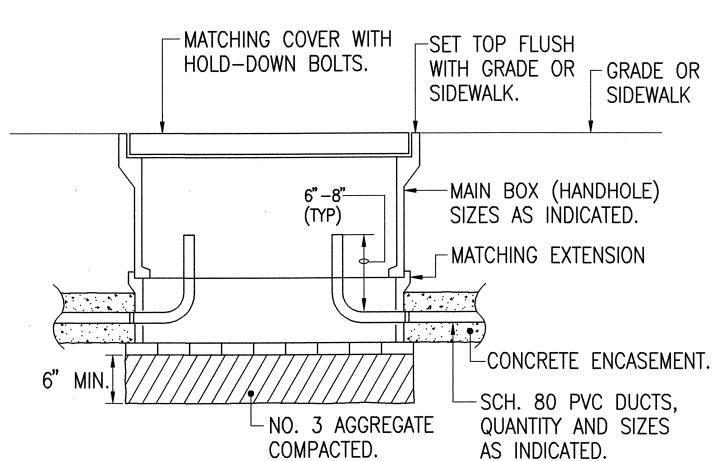
FED. ROAD DIST. NO.	STATE	PROJ. NO.	FISCAL YEAR	SHEET NO.	TOTAL SHEETS
HAWAII	HAW.	2000E-01-00	2000	56	60

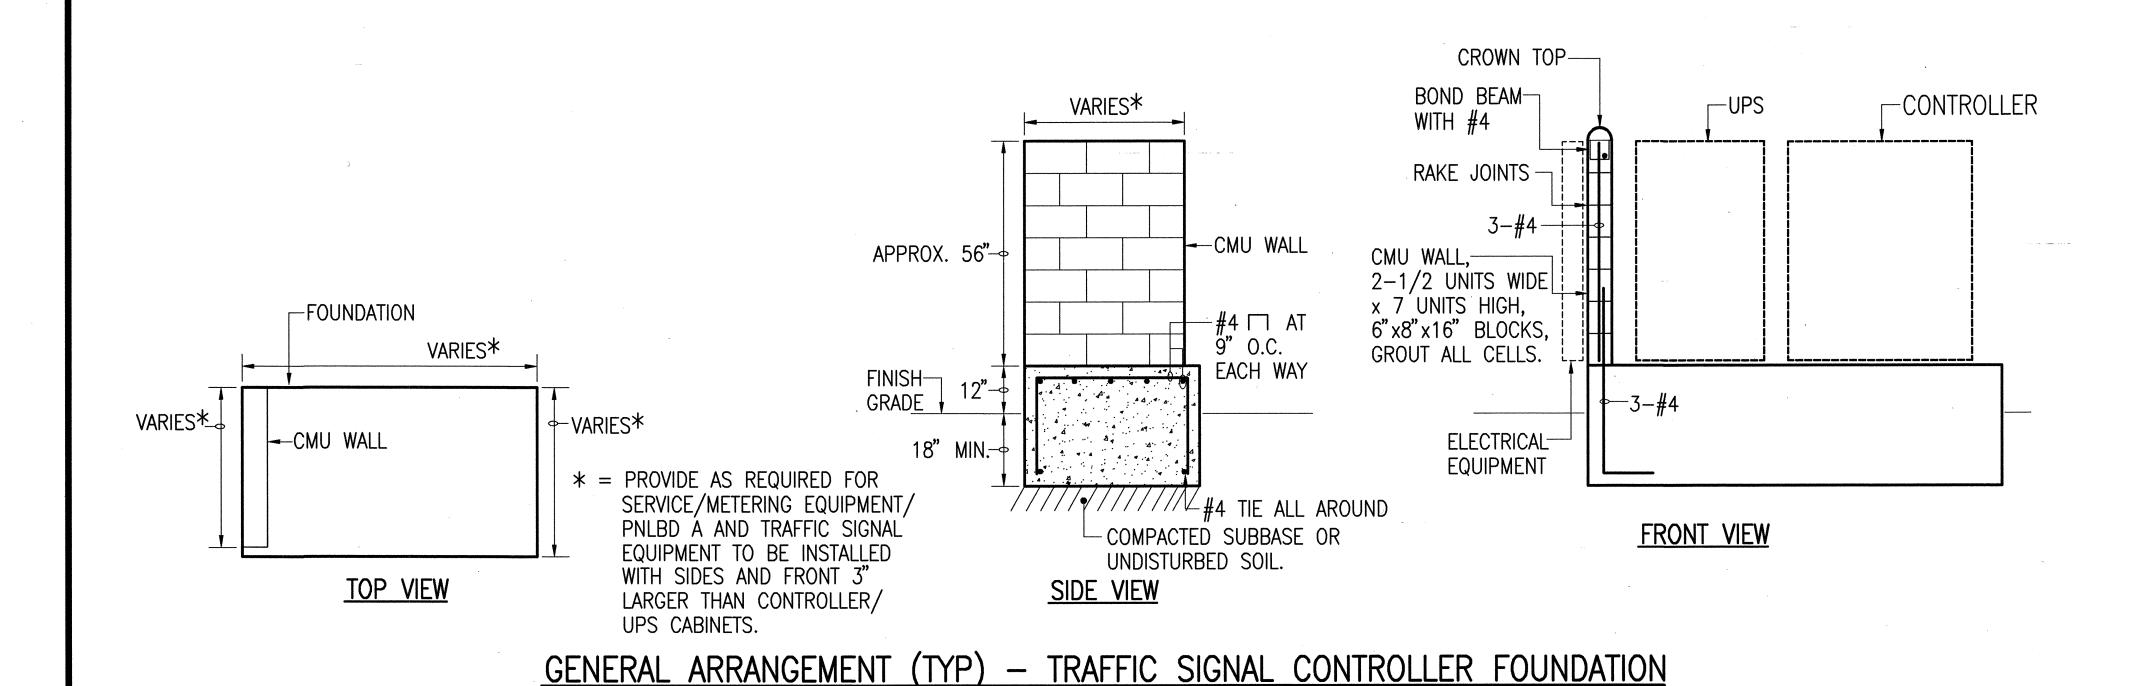

NOT TO SCALE

NOT TO SCALE



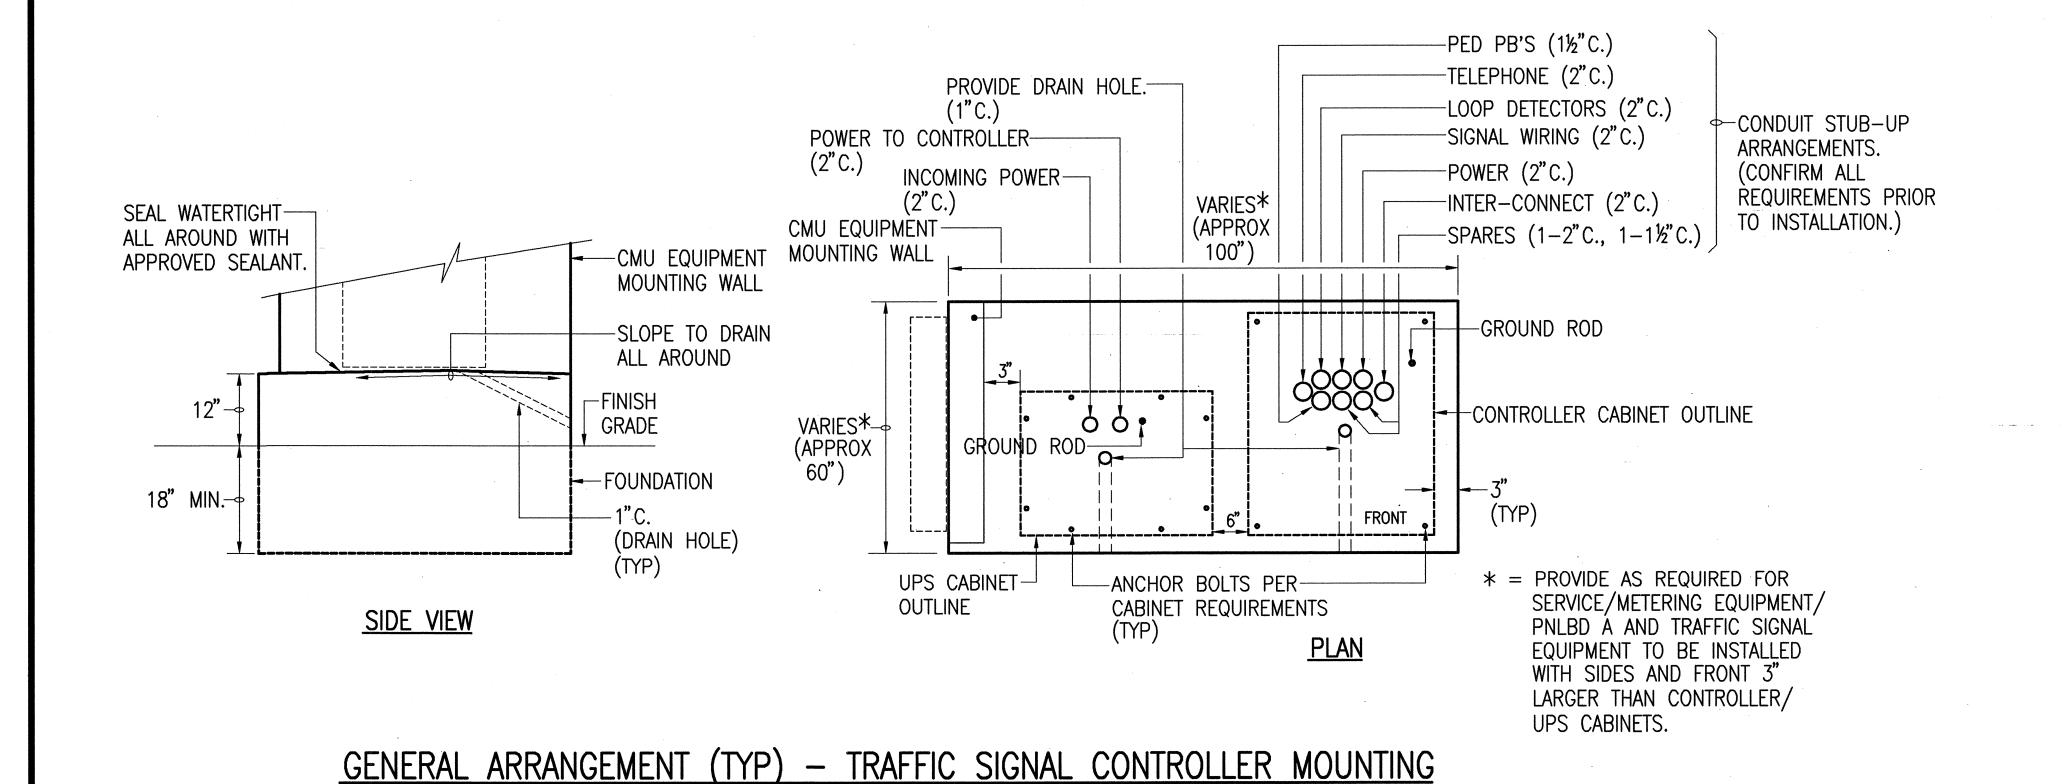

GENERAL ARRANGEMENT (TYP) — HANDHOLE (HH) DETAILS NOT TO SCALE NOTES:

- 1. ALL COVERS SHALL BE HEAVY DUTY AND MARKED WITH "TRAFFIC".
- 2. <u>SIZES</u>
 (S) TYPE "A"
 (M) TYPE "B"
 (L) TYPE "C"
 - SEE SHEET NO. 57




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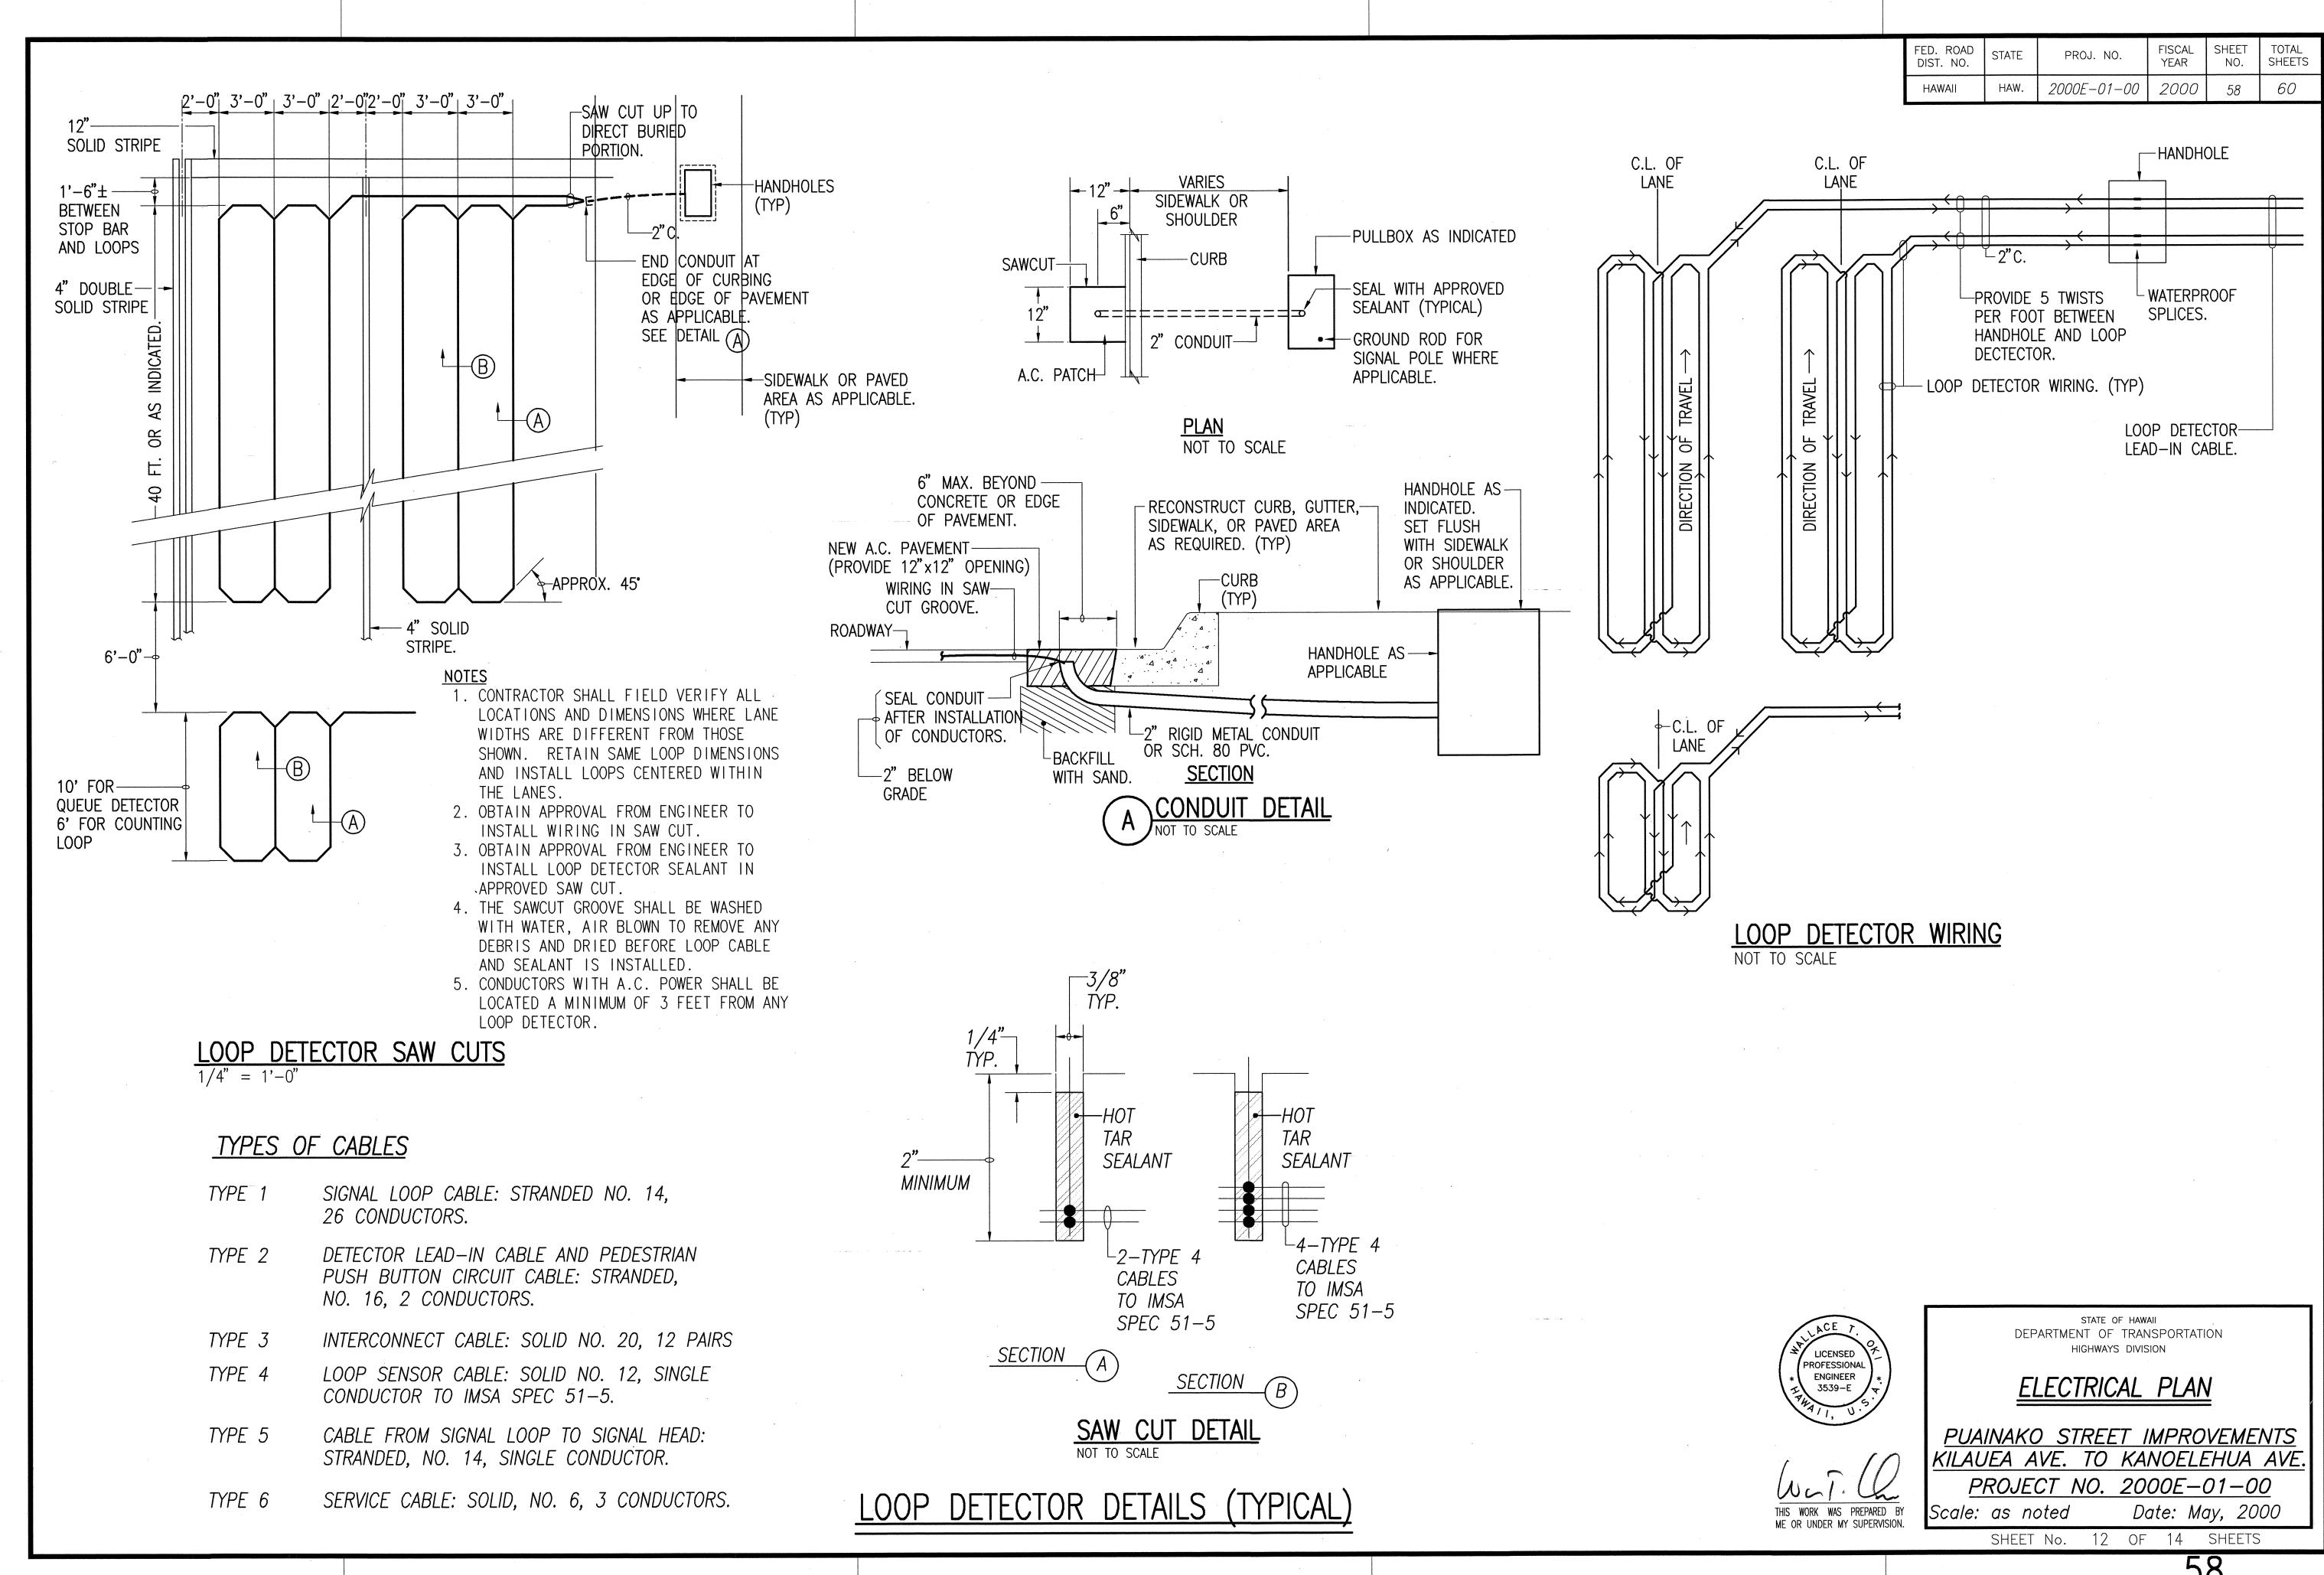
STATE OF HAWAII
DEPARTMENT OF TRANSPORTATION
HIGHWAYS DIVISION


ELECTRICAL PLAN


PUAINAKO STREET IMPROVEMENTS
KILAUEA AVE. TO KANOELEHUA AVE.
PROJECT NO. 2000E-01-00
Scale: as noted Date: May, 2000


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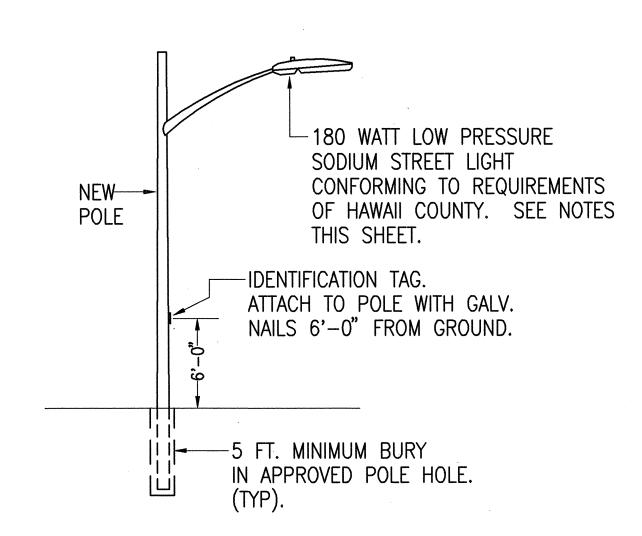


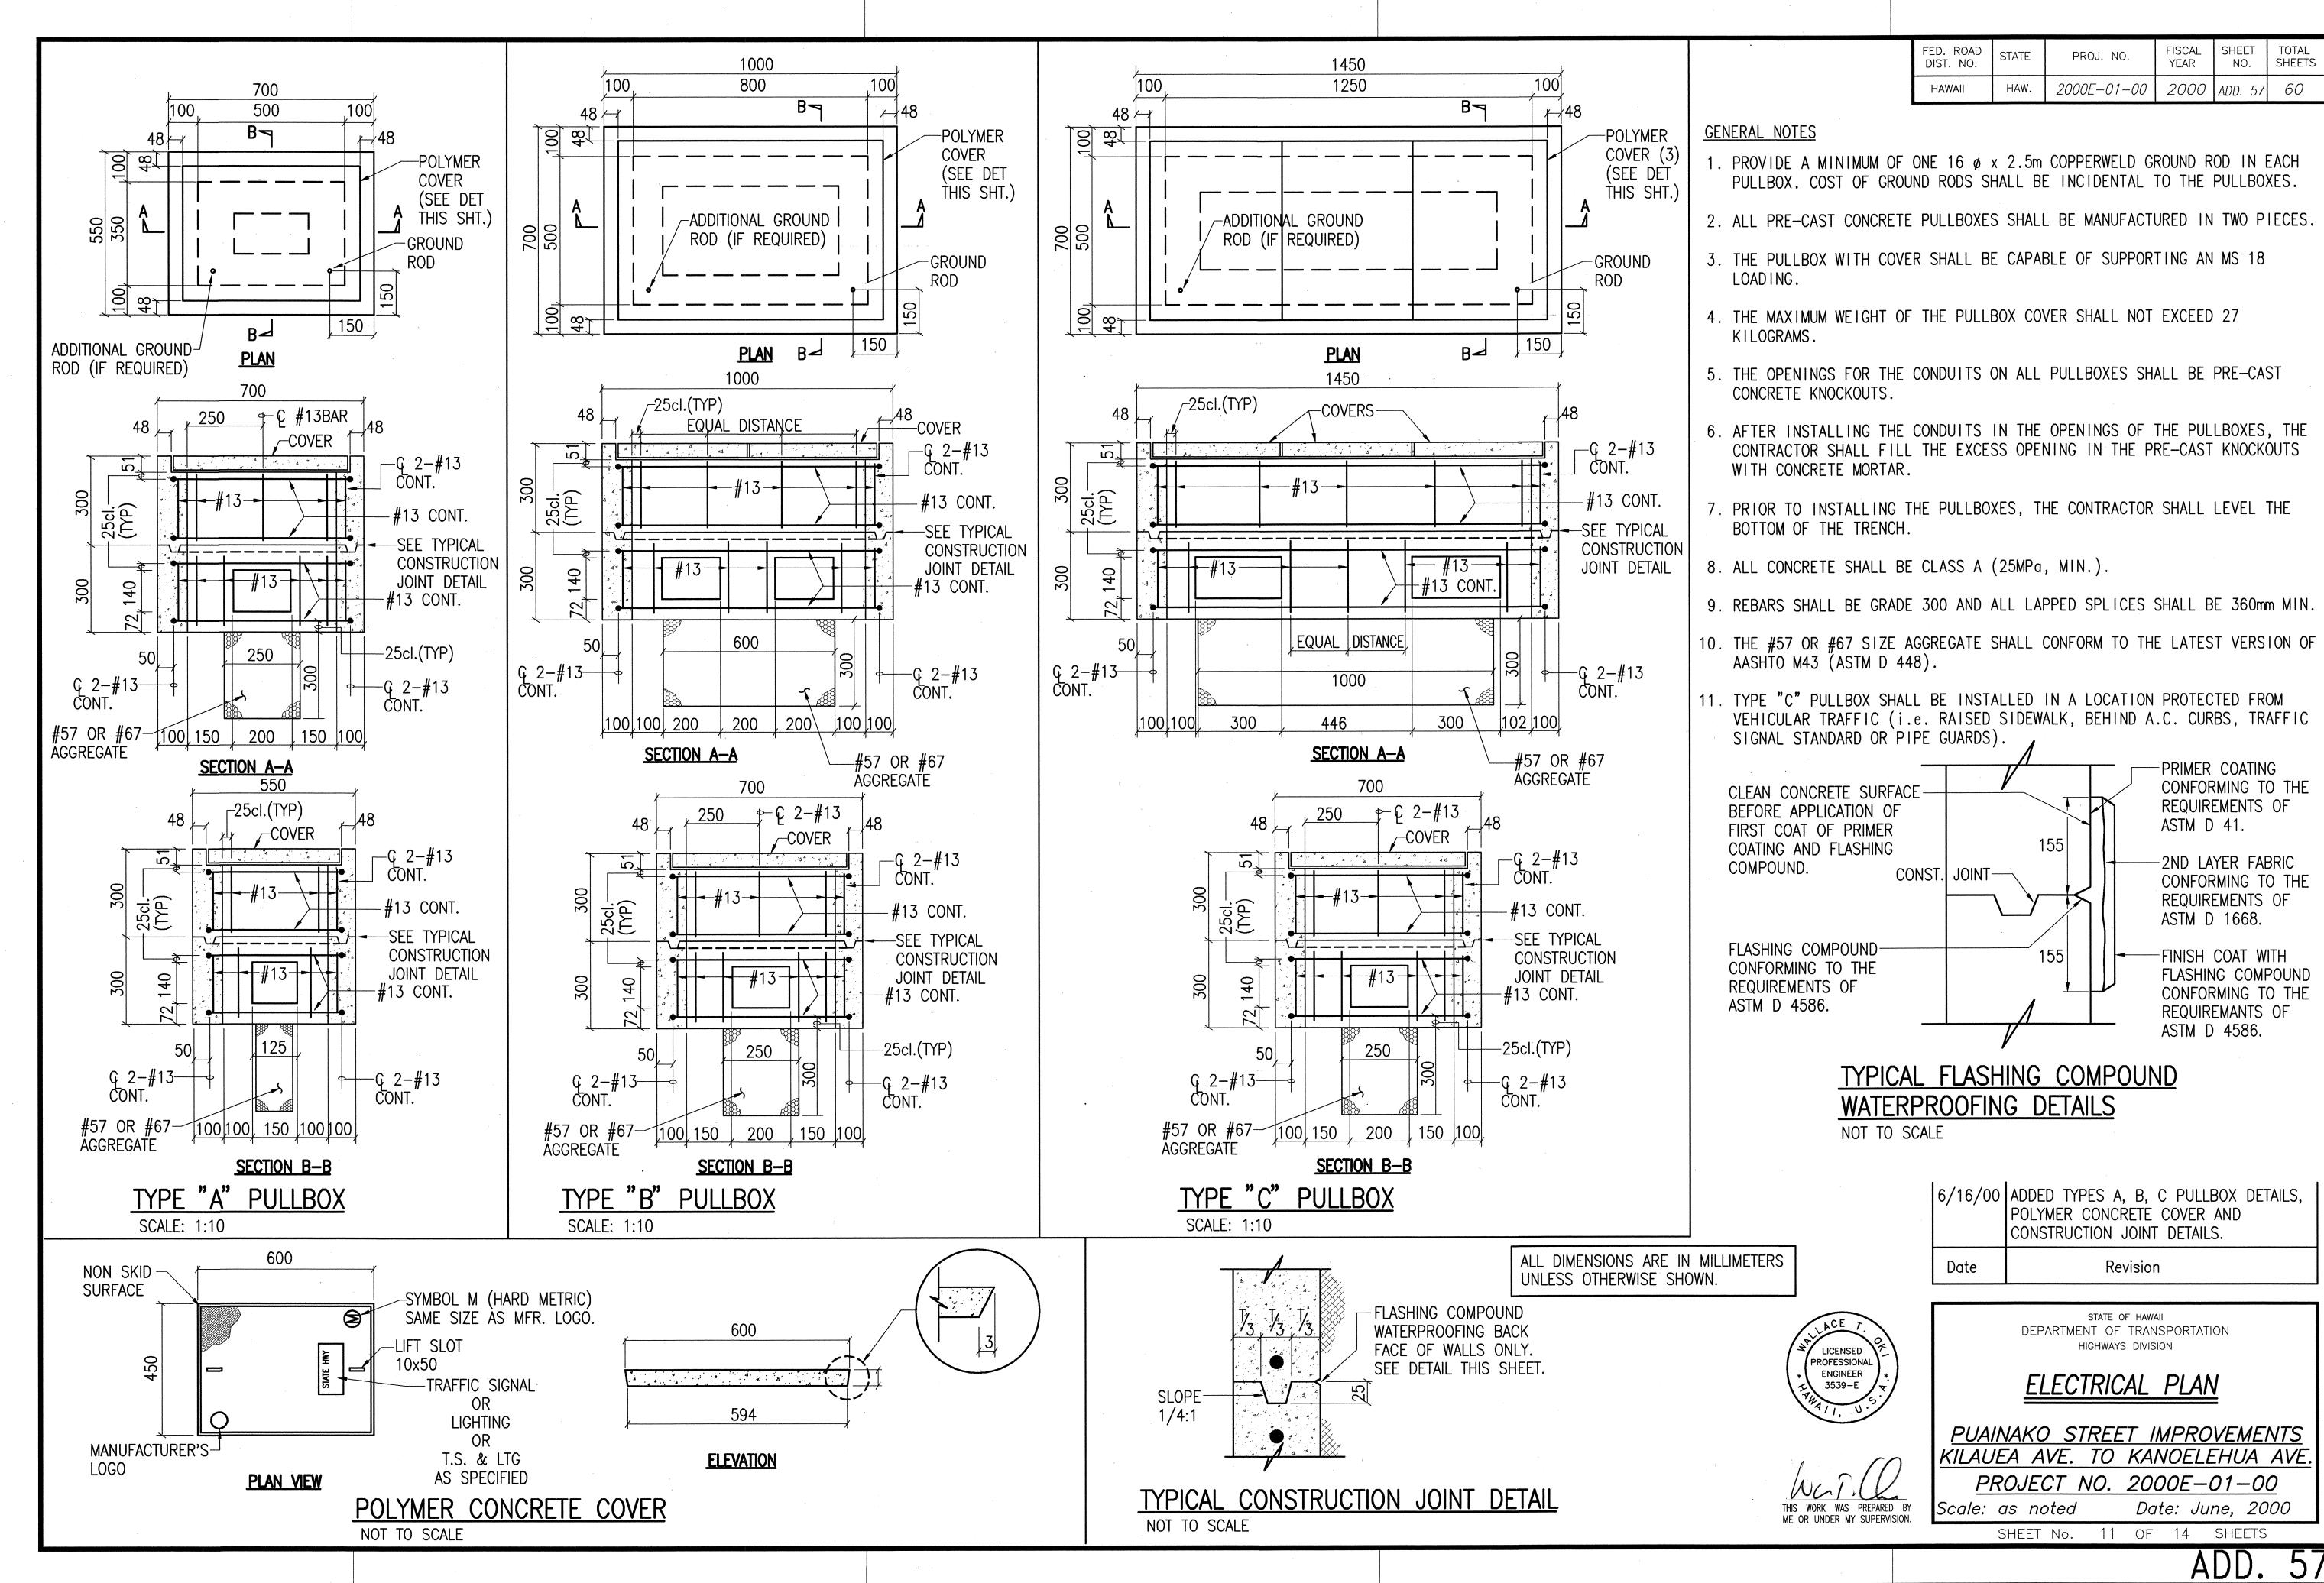


NEW STREET LIGHT ON EXISTING POLE

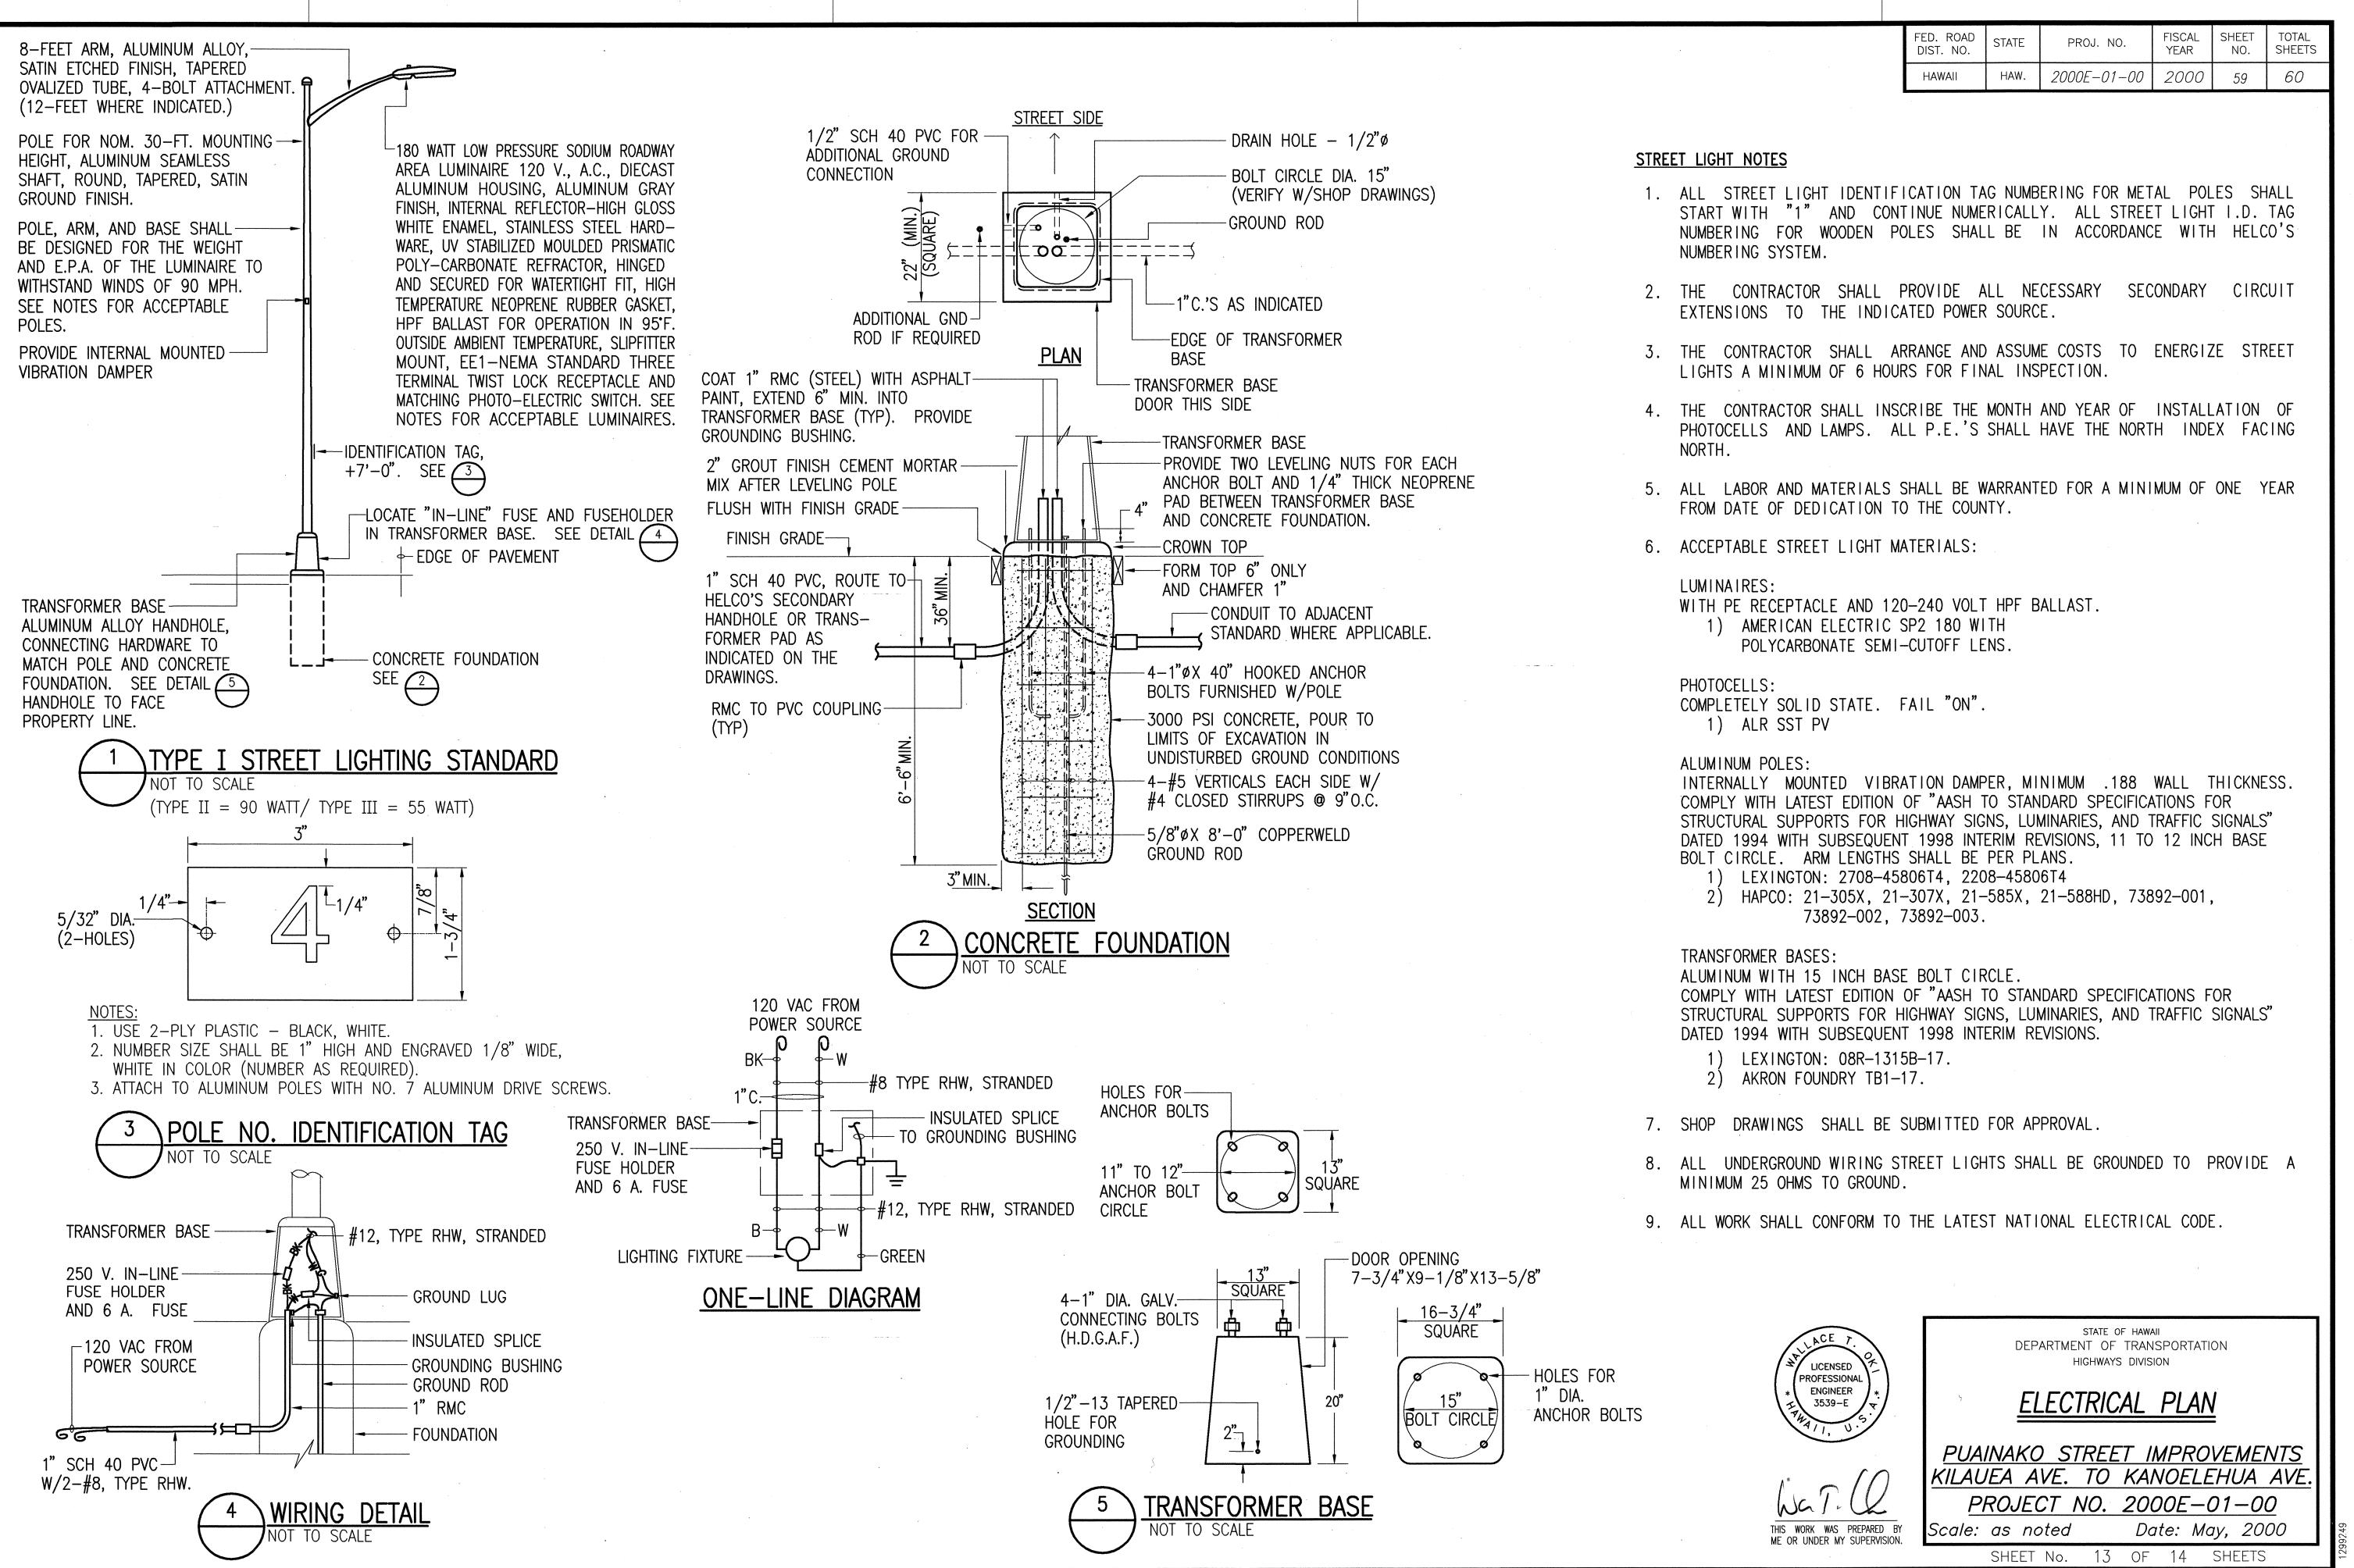NOT TO SCALE

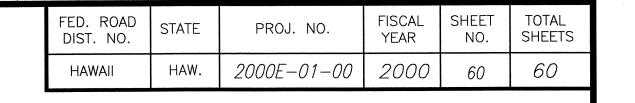NOTE:
CONTRACTOR SHALL PROVIDE PAYMENT OF \$1500
EACH TO TRAFFIC DIVISION, DEPARTMENT OF PUBLIC
WORKS, COUNTY OF HAWAII, TO PROVIDE NEW
STREET LIGHT ON EXISTING UTILITY POLE.

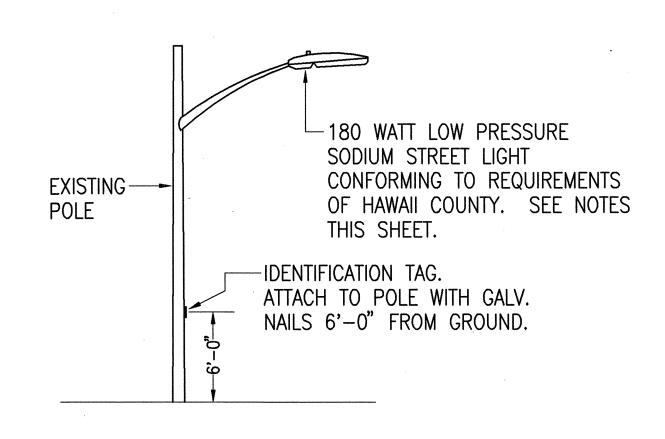

NEW STREET LIGHT ON NEW POLE NOT TO SCALE

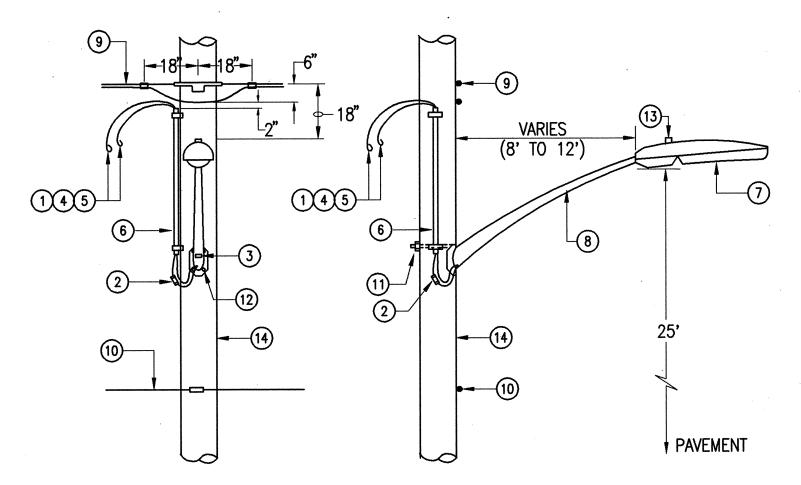

NEW STREET LIGHT ON UTILITY POLE

NOT TO SCALE

NOTES 1. JOINT POLE SHARES SHALL BE PAID BY THE CONTRACTOR.

2. SUBMIT SKETCH TO TRAFFIC DIVISION INDICATING TOTAL POLE HEIGHT, CONTACT HEIGHTS FOR H.T.CO., CATV, NEUTRALS, SECONDARY, PRIMARY, AND STREET LIGHT, AS APPLICABLE, PRIOR TO INSTALLATION. SUBMIT LETTER CONFIRMING THAT JOINT POLE SHARES HAVE BEEN PAID FOR BY THE CONTRACTOR.

NOTES

1 NO. 12 AWG-RHW, BLACK AND WHITE COPPER WIRE

② IN-LINE FUSE HOLDER AND FUSE (7 AMP) FOR NO. 12 AWG COPPER WIRE ON LOAD SIDE.

3 2" X 2" REFLECTORIZED GREEN STICKER, SIGNIFYING THAT STREET LIGHTS ARE BONDED.

4 NO. 12 AWG-RHW BLACK, SINGLE CONDUCTOR COPPER WIRE. MINIMUM 3'.

(5) NO. 12 AWG-RHW WHITE, SINGLE CONDUCTOR COPPER WIRE. MINIMUM 3'.

6 3/4" SCHEDULE 80 PVC WITH CONDUIT STRAPS

① LÚMINAIRE, 180 WATT LOW PRESSURE SODIUM AS INDICATED.

(8) TAPERED ELLIPTICAL ALUMINUM MOUNTING BRACKET, LENGTH AS INDICATED.

9 SECONDARY BY HELCO, EXISTING OR NEW AS APPLICABLE.

10 H.T.CO. LINES (WHERE APPLICABLE)

MACHINE BOLT, 5/8" X REQUIRED LENGTH. (1-REQ'D.)

1 LAG SCREW, 1/2"X 4".

13 PHOTOCELL

14 UTILITY POLE, NEW OR EXISTING AS INDICATED.

FINAL CONNECTIONS TO BE MADE BY HAWAII ELECTRIC LIGHT COMPANY.



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STATE OF HAWAII
DEPARTMENT OF TRANSPORTATION
HIGHWAYS DIVISION

ELECTRICAL PLAN

PUAINAKO STREET IMPROVEMENTS
KILAUEA AVE. TO KANOELEHUA AVE.
PROJECT NO. 2000E-01-00
Scale: as noted Date: May, 2000

SHEET No. 14 OF 14 SHEETS