



JOINING TWO ADJACENT SILT FENCE SECTIONS

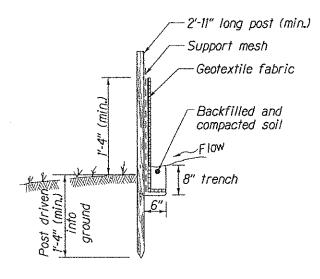


<u>POST AND FABRIC</u> <u>INSTALLATION DETAIL</u>


NOTE:

Alternate pre-assembled silt fence options will be allowed as long as specified dimensions are satisfied. Follow manufacturer's information for installation procedures. Inform CO for approval.

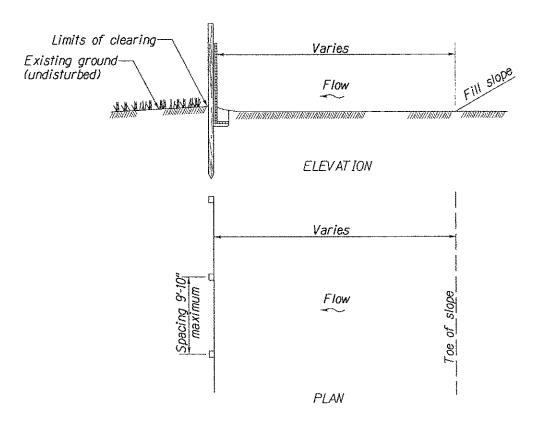


SILT FENCE INSTALLATION AT TOE OF FILL

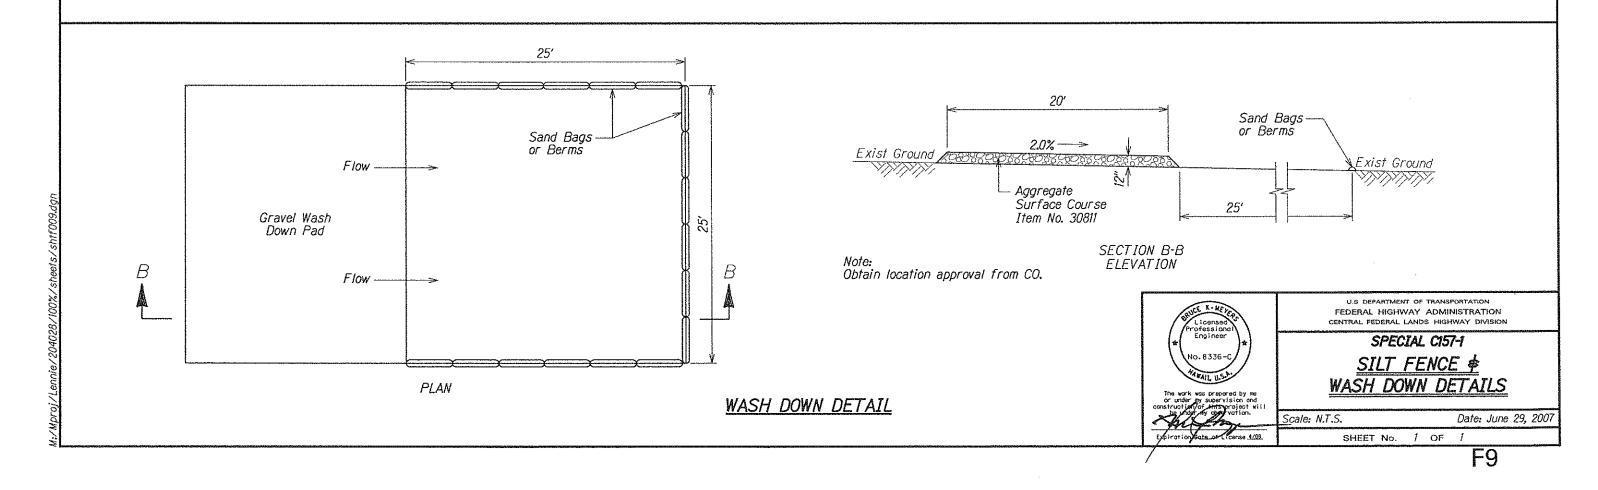

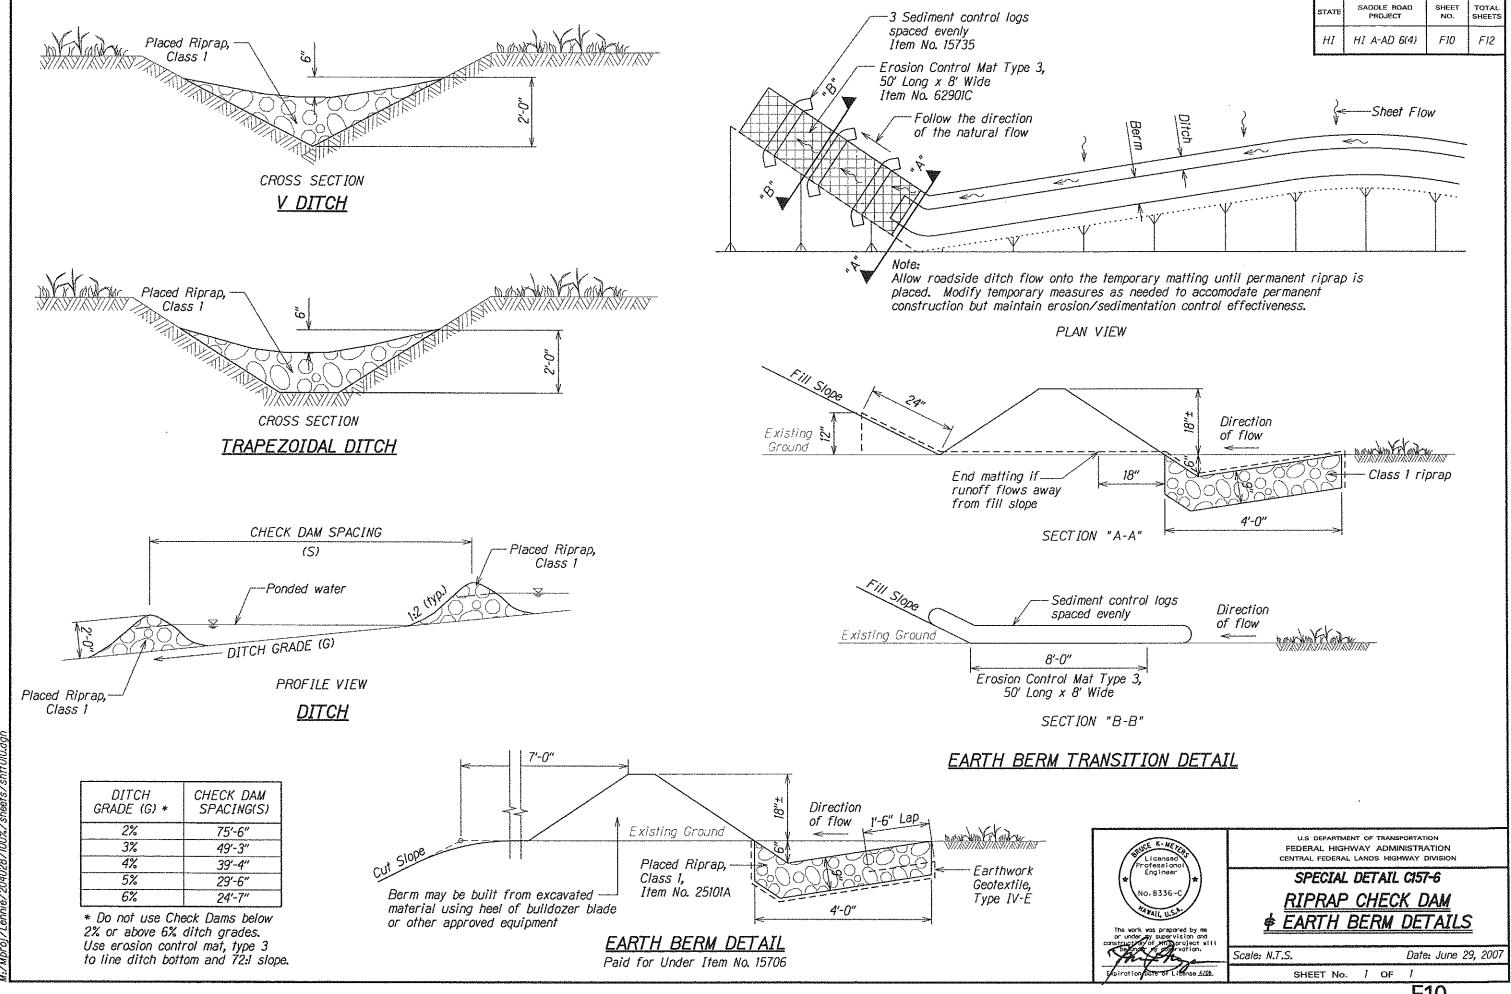


STATE	SADDLE ROAD PROJECT	SHEET NO.	TOTAL SHEETS
ΗI	HI A-AD 6(4)	F11	F12 ·

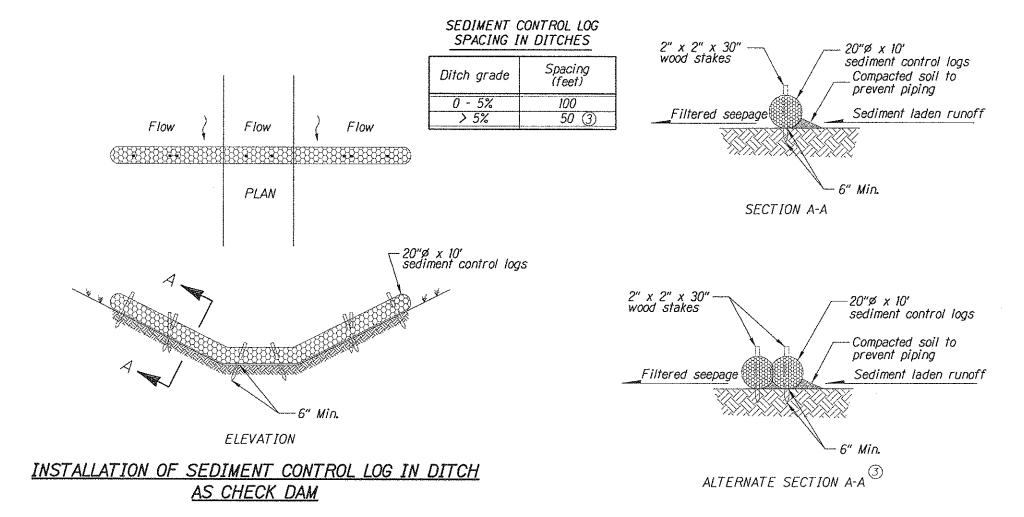


NOTE:

- 1. Stake sediment logs in place with 2"x2"x30" wood stakes spaced no less than 24" apart unless otherwise noted. Drive stakes into ground a minimum of 6".
- 2. Install sediment control logs directly on ground making sure bottom of log is in full contact with ground. Tamp soil backfill against upstream side of log to assure storm water is forced to flow through log rather than under it.
- ③ Sediment control logs can be spaced every 100' in ditches with slopes > 5% when two logs are placed directly next to each other as shown Alternate Section A-A.

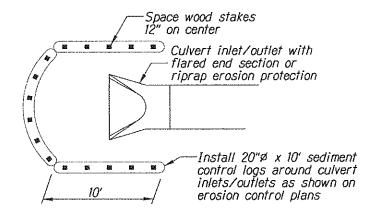



CULVERT INLET/OUTLET SEDIMENT BARRIER

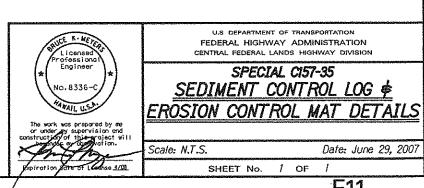

Longitudinal ditch grades below 2% or above 6% use erosion control mat, type 3 (item no. 62901C) to line 72:1 slope, ditch bottom, and a portion of 10' the backslope. Future' Ditch Existing Ground Firebreak, **Bottom** Shoulder Erosion Control Mat, Slope Staking Limits Type 3 Îfem No. 62901C 0:1 72:1 50:1 Hinge Point Bottom of Future 6:1 Foreslope (solid line on P¢P shts)

> EROSION CONTROL MAT PLACEMENT IN DITCH BOTTOM

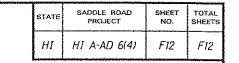

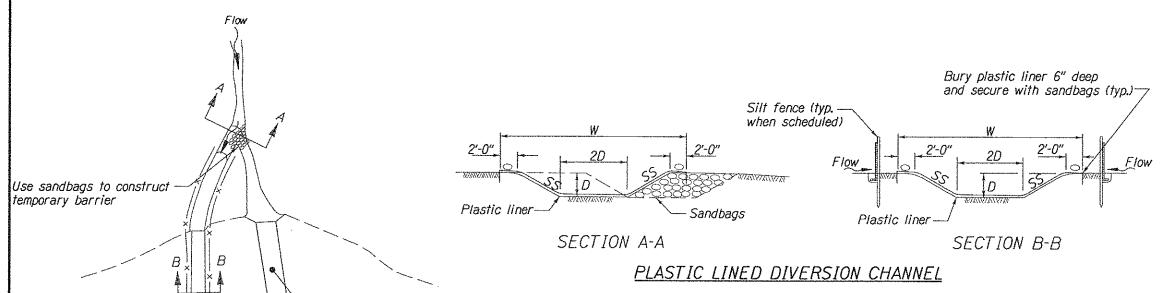

-Permanent culvert

PLAN

DIVERSION CHANNEL

(Item No. 15725)

Silt fence or temporary culvert

> Temporary diversion channel with plastic liner or riprap,

item no. 15725

Roadway &

Riprap lining,-

class 2

Limits of earthwork


Permanent natural channel

Use sandbags to prevent

backflow into natural channel

NOTE:

- 1. Use plastic liner or riprap along the entire length and width of the temporary diversion channel.
- 2. Construct channel at a minimum grade of 0.5 percent.
- 3. Do not construct with longitudinal joints if using a plastic liner. Bury the upstream edge of the liner a minimum of 6 inches deep and secure with riprap or sandbags.
- 4. Compact temporary culvert backfill using one of the methods listed in specification 204.11(a).
- 5. Plastic liner shall conform to section 725.19 of the specifications.

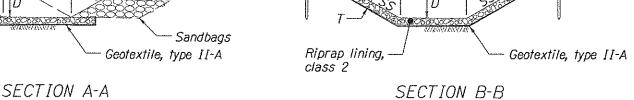

RIPRAP LINED DIVERSION CHANNEL

SS = 2:1 maximum slope


Silt fence (typ. when scheduled)

D = size of temporary pipe
W = width of temporary channel, varies
T = thickness of riprap, class 2 (12")

Subgrade -Temporary culvert backfill Roadway /embankment Roadway embankment/, Bedding-Natural ground — TASTIKSHIASTI ANTIKSHIKSHIKSHIKSHIKSHIKSHIK

SECTION B-B

TEMPORARY CULVERT

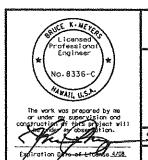

U.S DEPARTMENT OF TRANSPORTATION FEDERAL HIGHWAY ADMINISTRATION CENTRAL FEDERAL LANDS HIGHWAY DIVISION

SPECIAL DETAIL C157-5 TEMPORARY DIVERSION CHANNEL DETAILS

Scale: N.T.S.

Date: June 29, 2007

SHEET No. / OF

F12