



Δ=8°19′08**.**06″ See Note 5, Typ.-∆/2=4°09′34**.**03″ 488<u>T.M.K.: 1-5-15:181</u> -R=850**.**00' 325°09′45**.**64″ 94.5' Roundabout T.M.K.: ¥-5-15:171 T=61**.**82' See Note Inscribed Ø, Typ.--<u>20.00'</u> \_C=123.31' KEAAU-PAHOA RD. 4, Typ. Az.=334°40′24.19″ - EP \*Lc=12*,3.41' (STATE) 118+ U.p. #120= L=47**.**25′ r/WES D #119 W.5fn 488 1. 486 0.7.7 120+00 MON. -120+00**0** MAGIL 186-U.p. / A.l. #132 pp #1316 120+16.97 T.M.K.: 1-6-09: 155 PP = =-486' r/w-30° -291 123+ T.M.K.: 1-6-09: 157 T.M.K.: 1-6-09: 156 T.M.K.: 1-6-09: 153 Sta. Keaau-Pahoa Rd & Sta. 123+84.22 Sta. 490 See Note <u>= Ainaloa Blvd. & Sta. 0+00.00</u> J U 6, Тур.— Center of Roundabout  $\mathcal{O}$ Ĺ Γd T.M.K.: 1-6-09: 158 SDW #10ά Ainaloa Blvd. ¢ See Plan and <u>KEAAU-PAHOA RD. & PLAN</u> Profile Sht. Scale: 1" = 40' ADD.27 123+25.00 491.08 Sta. 119+00.00 Elev. 486.83 Sta. Elev. Limit Round Inscri 1.00% w12″ ≬ exist. ground · w1.25″ at grade control, typ. -KEAAU-PAHOA RD. & PROFILE THIS OR U CONS WILL Scale: Horiz. 1" = 40' Vert. 1" = 8' Rolmi SIGNATURE 119+00 120+00 121+00 122+00 123+00 "AS-BUI]

			FED. RC DIST. N		STATE	FED. PROJ		FISCAL YEAR	SHEET NO.	TOTAL SHEETS
	z.=330°00′20.3 47.25′	2"	HAWA	All	HAW.	STP-01	130(27)	2020	ADD.25	50
23-84.22 1-23+84.22	Az.=323°03'0 L=397.11' 490- 490- To Pahoa To Pahoa ticktor to Pahoa Dele		MI & Sta, 125+00	2. 2. 3. 3. 7. 5.	Sht. See to Al Keaa For locat for to Fi Stand Adju and Field exist	design 21. Roadwa DD.32 T U-Paho new st ions, s new ar insh G dard F st all f WMs to Uocate ing wa LEG <u>BUI</u>	ay Pla for de pa Rd. reet li ee elec nd adj Frade, Plan D DWS e DWS e DWS e Sand ter se ENI LT I Squi	ns Sh tailed ight po ctrical usted see H -07. exist. V sh Gra verify ervice D F( <u>POS</u> ggly	' plans. monum DOT NMHs, ade. all lateral	D.28 of ments WVs S. <u>GS</u> for
	Grac <i>T.M.K.: 1-6-99: 0</i>	dew			-100.0	<del>()</del>			ine fo delet	
Alnaloa Blvd.				R	oadw	ray		for	as-b	
Gra Rou * * * * * * * * * * * * * * * * * * *	1.13% I.1480-C I.1480-C I.1480-C I.1480-C I.1480-C I.1480-C I.1480-C I.1480-C I.15% I.1480-C I.15% I.1	NOUTE		2/16/ DAT			ed Note	e #2	Λ/	520 510 500 490 480 470
124+00	OF THE LICE	<u>NSE</u> 125+		11		T No.			SHEET	 S
Γ.Τ''					JULL	_				-
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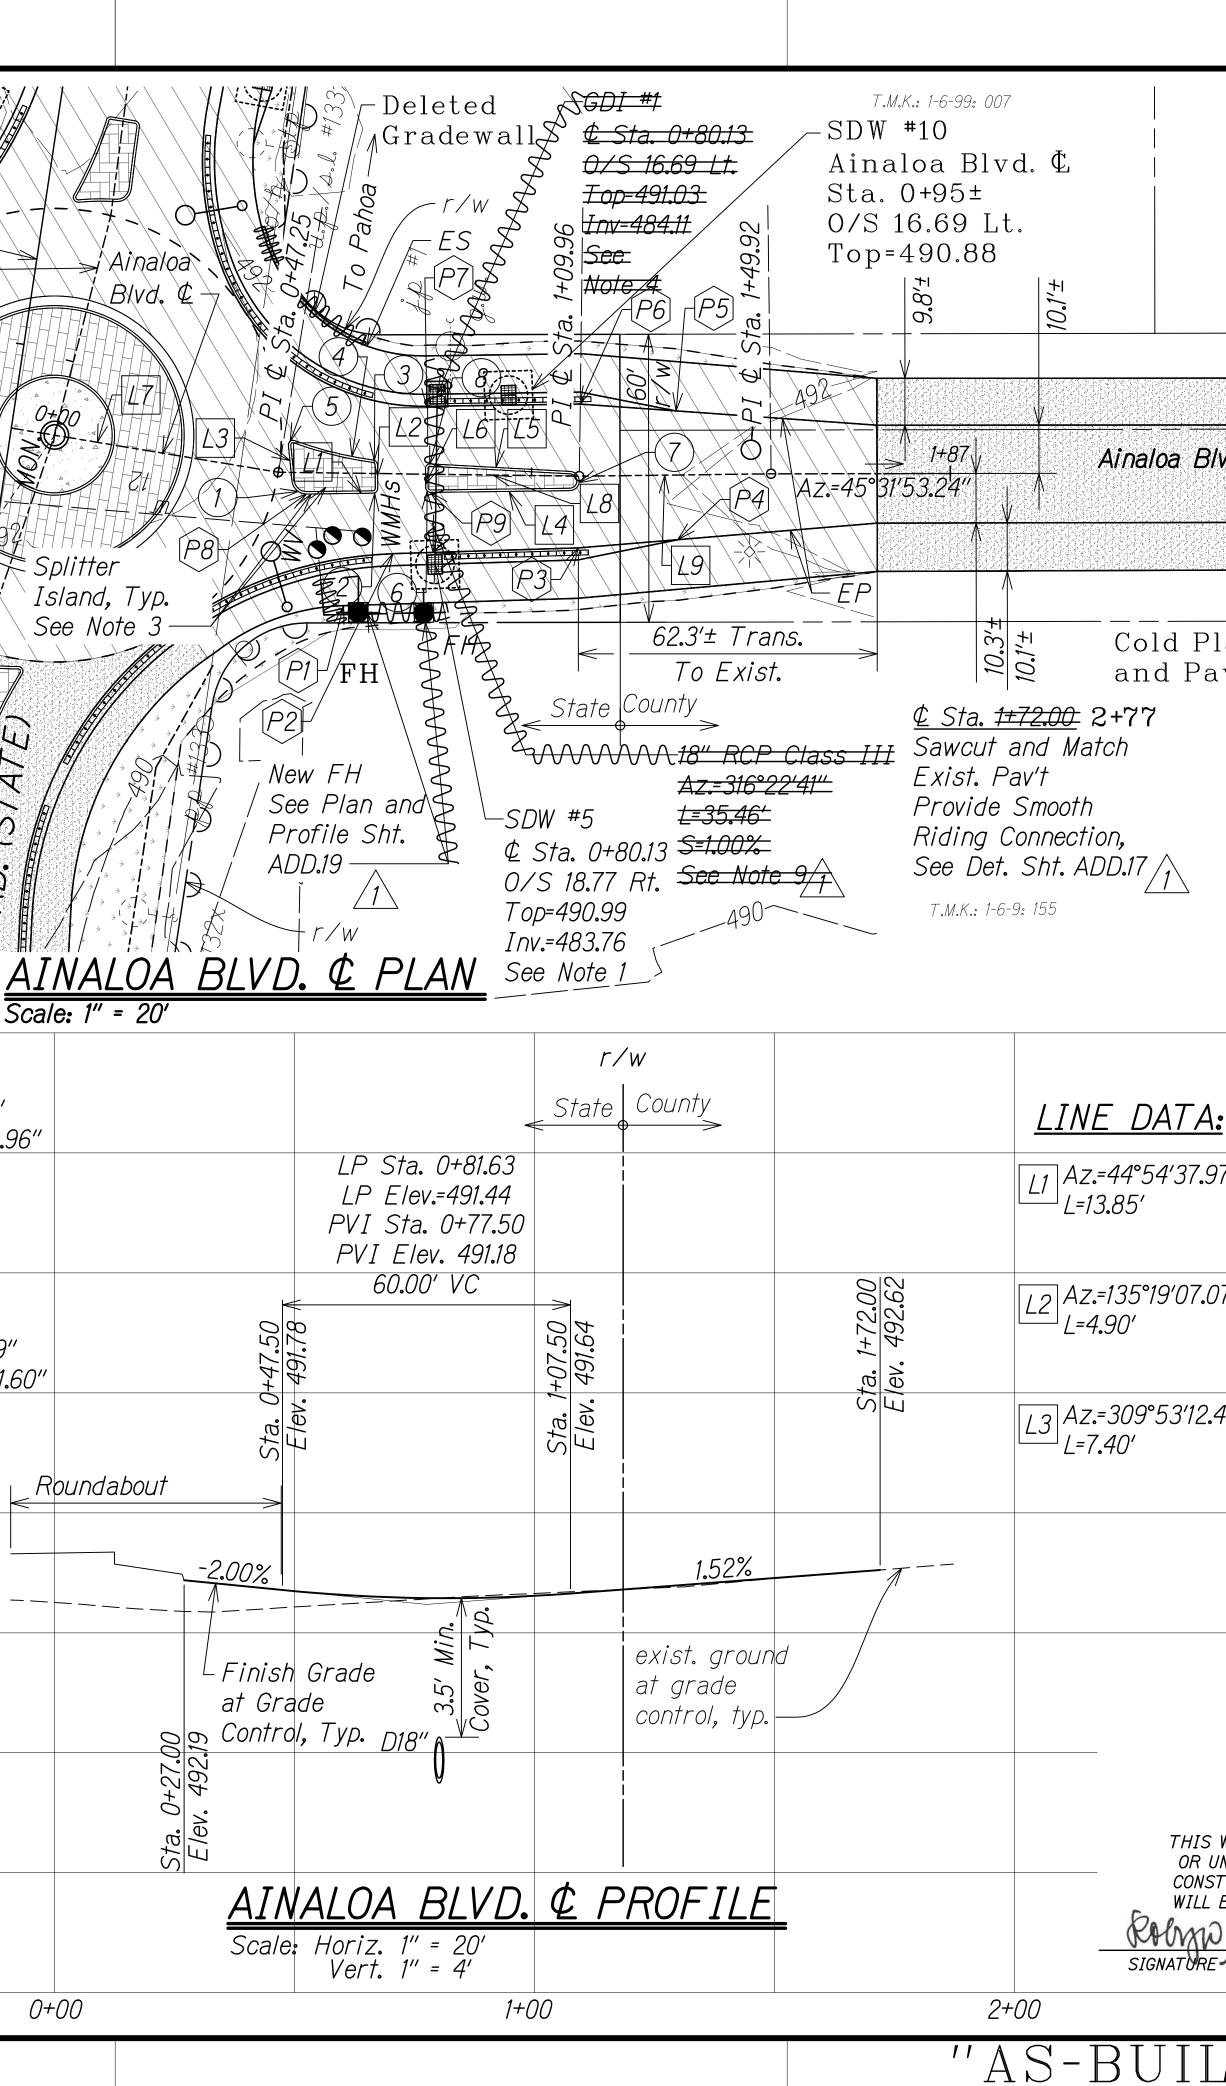


														D. ROAD		FEDAID PROJ. NO.		R NO.	TOTAL SHEETS
TMK			/	\										HAWAII	HAW.	STP-0130(2	11 2020	)  ADD.26	50
T.M.K.: 1-5-15:184							١					<u>NOTE</u> . 1. Fol		ign su	perelev	vation, see	Sht. 2	1.	
		T.M.K .: 1-5-	-15:185		=353°07′ 80.88′ 13	3+55	\ \				1	2. See	e Roa	dway F	Plans (	Sht. ADD.2 aau-Pahoa	28 to A		or
Plxr/w~	Trav.				<u>Sta. <del>130</del>-</u>	<u>+45.00</u> nd Match	Fxist.		<				r new	-		pole loca		ee elect	rical
- A96 - 498	MAKH.p. +	#122	- O-h Pgp	\ Pa	v't and	Provide S , See Def	Smooth I	- / \	S ALK	NOP>						ed monume andard Pl			
	130+00 INV		WMHWV	#1370 P	P #122x			e Note 5	T.M.K.	T-5-15:187		-	just a ish gl		S exist	t. WMHs, V	VVs and	1 WMs 1	0
	MOB: 13	State of the second state of the			EP 5	X Q Q Q			/, / yp.				eld loc erals.		nd veri	fy all exi	sting w	rater sei	rvice
2 turm j.p.									- Popo	<u></u>									
U.p. #13	6 0 496- 6 0 496-			ten o		$\sim$	To Pah			723 Xes				T	,EG	END F	'OR		
496 6, Typ.		S – C							T.							T POS		<u>GS</u>	
129+90.34 (BK) =		ee Note 4, <sup>T.M.K.: 1-6-04</sup> .						4.0	A					$\mathcal{M}$		Squiggl as-built			
38.29 (AH)	49	)8— — —			-04: 031			#138	e					-100.00		Double as-built			
				I.	Ŷ	END P	ROJE	CT					Ro	oadwa	ay [	Text for	r as-b		
HOA RD.	<u>¢</u> plan	/				FAP NO.	STP-013	30(27)							]	posting			
		_																	
	00.00 83	<u>45.00</u>  1± 'ist.																	520
	130+00. . 497.83	130+45. . 498.1± ch Exist																	
	Sta. Elev.	Sta. Elev. Matci	е	xist. gro	und														510
			a	t grade ontrol, ty															
	0.50	)%																	500
	" ( <i>AH</i> ) = ₩	6″		• w1.25″															10.0
	0.34 (																		490
	129+90.34 129+88.29																		480
	Sta. Sta.										D No								400
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	EG.										* ENGINEER NO. 13480-0 MAII,US								770
AHOA RD.	¢ PRO	FILE									K WAS PREP R MY SUPER	ARED BY M							
" = 40' " = 8'									G	CONSTRUC WILL BE (	TION OF TH INDER MY OE	IS PROJECT SERVATION	7 V.	12/16/	/19 /1	∖ Revised ∧	lote #2		
									SIG	NATURE	Kinner	04/30/20 PIRATION L THE LICE	DATE	DAT			REVISI	ON	
29+00	130+00		131+00		132	2+00	, ,	133+00	₩ → ₩		+00			1	SHEET	ΓΝο. 2		SHEET	S
							//	AS-	-Bſ	┘╷╷╷╵	<i>וו</i> ר					AD	D.2	6	

FED. ROAD DIST. NO.	STATE	FEDAID PROJ. NO.	FISCAL YEAR	SHEET NO.	TOTAL SHEETS
HAWAII	HAW.	STP-0130(27)	2020	ADD <b>.</b> 26	50

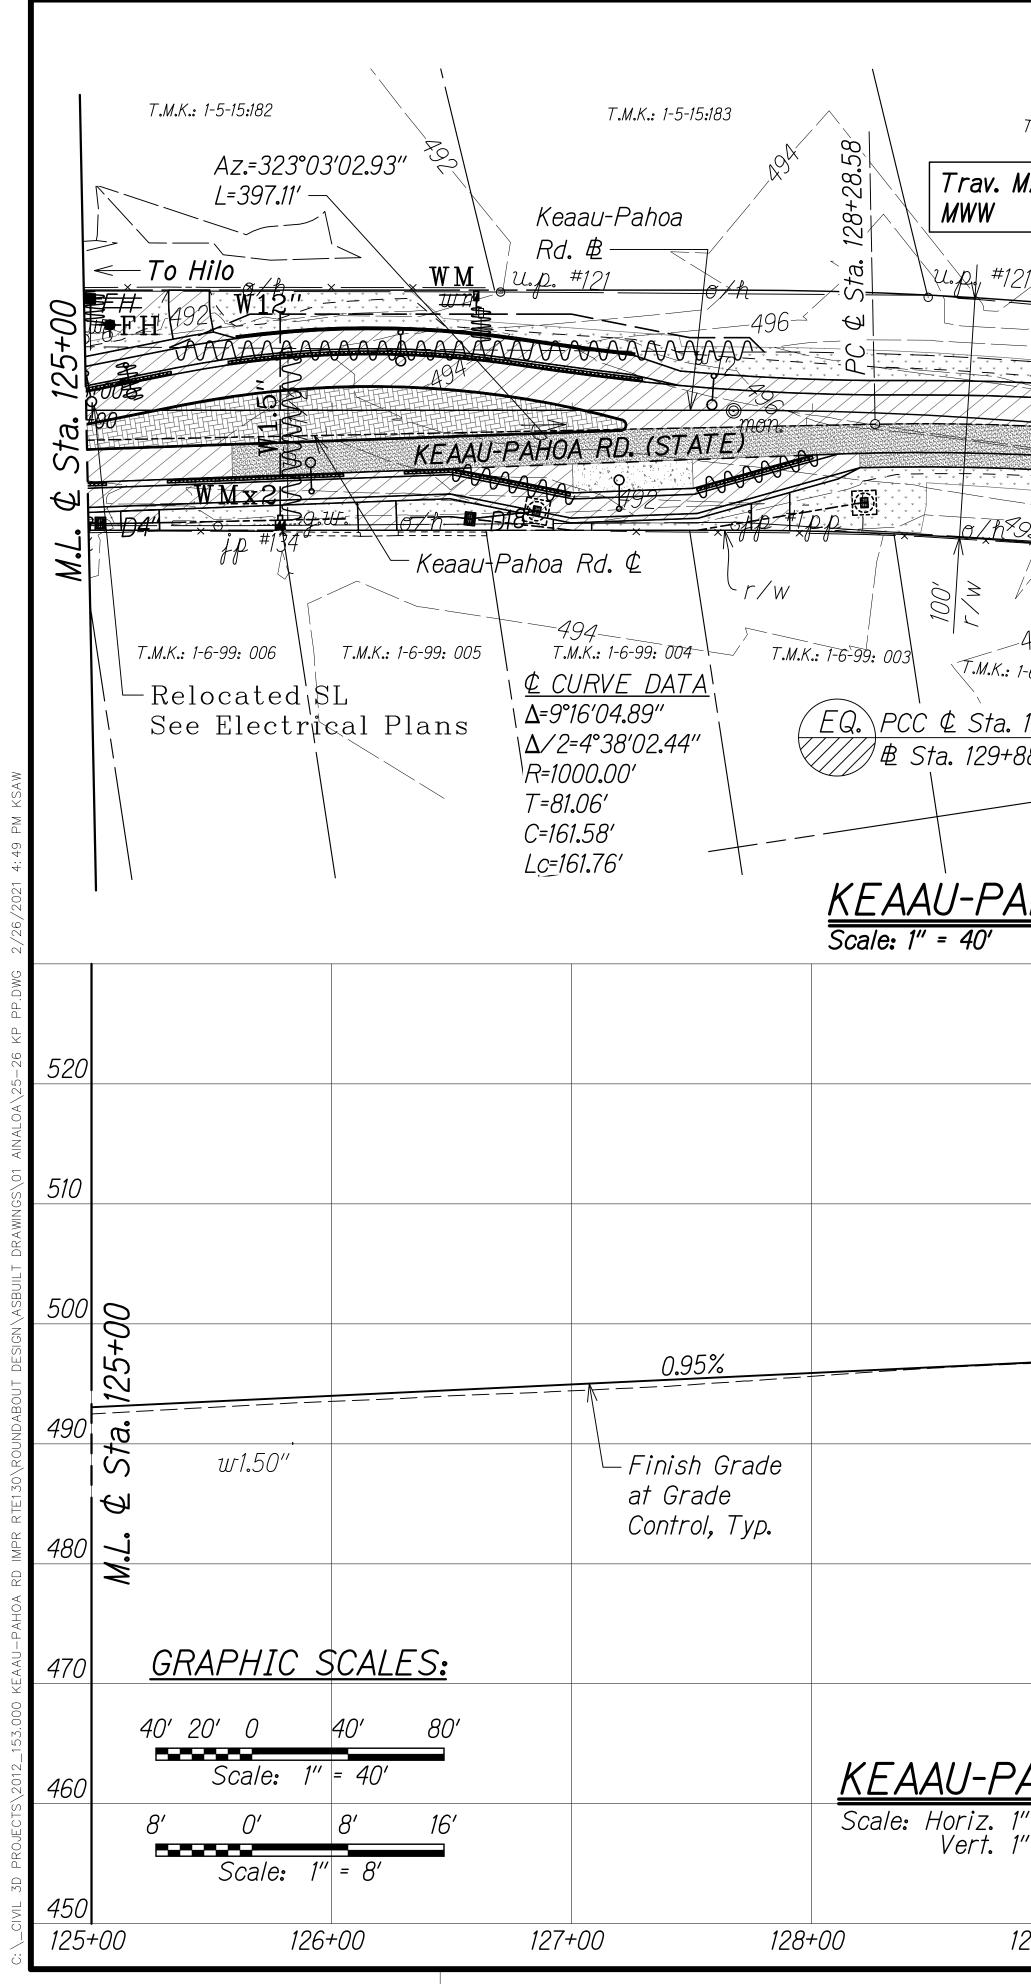

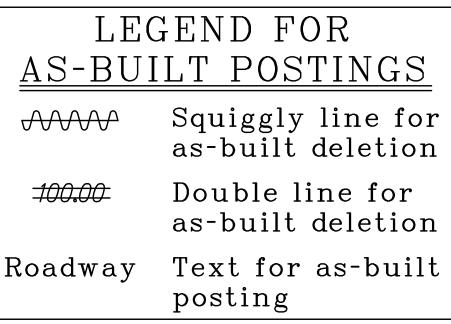
See Note 8, Typ. Keaau-Pahoa Rd. 思 Keaau-Pahoa Rd. ⊄ Şee Plan and Profile Shts. ADD.25 to ADD.26-<u>Kea'au-Pahoa Rd. ¢</u> <u>Sta. 123+84.22</u> <u>=Ainaloa Blvd. ¢</u> <u>Sta. 0+00.00</u> Center of Roundabout/ See Note 6 See Note 2, Typ.-94.5' Roundabout Inscribed Ø, Typ. Az.=350°24'42.38' KEAAU-PAHO L=90**.**85′ T.M.K.: 1-5-15: 181 ISTA7 **GRAPHIC SCALES:** r/w-20' 10' 0 20' Trav. MAK4 Scale: 1" = 20' Ĝ. MWWW 4' 3' 2' 1' 0 Scale: 1" = 4' CURVE DATA:  $\underbrace{1}_{510} \Delta^{=84^{\circ}58'34.46''}_{\Delta/2=42^{\circ}29'17.23''} \underbrace{2}_{\Delta/2=44^{\circ}47'45.45''}^{\Delta=89^{\circ}35'30.89''}_{\Delta/2=40^{\circ}54'17.83''} \underbrace{4}_{\Delta/2=5^{\circ}58'30.96''}^{\Delta=11^{\circ}57'01.92''}_{\Delta/2=5^{\circ}58'30.96''}$ R=3.00' R=1.00' R=1.00' R=81.00' *T=0.87′* T=2**.**75′ T=0**.**99' T=8.48' C=4.05′ C=1.31′ C=16.86' C=1.41′ Lc=4**.**45′ Lc=1.56′ Lc=16.89' Lc=1**.**43′  $\Delta = 176^{\circ} 11'27.70'' \\ \Delta / 2 = 88^{\circ} 05' 43.85'' \\ 8 \Delta / 2 = 46^{\circ} 42' 01.60''$  $500 \begin{array}{r} 5 \\ 5 \\ 5 \\ \Delta 2 = 57^{\circ} 47' 10.45'' \end{array} \begin{array}{r} 6 \\ 6 \end{array}$ Δ=176°11′27**.**70″ \ **Δ=90°24′29.11**'' <sup>)</sup> ∆/2=45°12′14**.**55″ R=1.00' R=2.00' R=1.00' R=1.00' T=1.59' T=60**.**15' T=1.01' T=1.06' C=4.00' C=1.69' C=1.42′ C=1.46' Lc=6**.**15′ Lc=1.63′ Lc=1.58′ Lc=2.02' POINT DATA: 490 P2 € Sta. 0+71.29 0/S 16.66' Rt. ₽3 <sup>©</sup> Sta. 1+09.96 0/S 14.95' Rt. PT ES PT EP PI EP Begin Tuff Curb Trans. € Sta. 1+10.33 P6 0/S 15.01' Lt. ₽4 ¢ Sta. 1+30.30 0/S 13.48' Rt. ₽5 ¢ Sta. 1+30.30 0/S 13.35' Lt. End Tuff Curb PI EP End Tuff Curb Begin Tuff Curb Trans. 480 P9 & Sta. 0+79.01 0/S 3.79' Rt. *P*7 *€* Sta. 0+77.99 0/S 14.13' Lt. *P8 © Sta. 0+53.17 0/S 4.45' Rt.* PC EP Splitter Island Splitter Island




	FED. ROAD DIST. NO.	STATE	FEDAID PROJ. NO.	FISCAL YEAR	SHEET NO.	TOTAL SHEETS
	HAWAII	HAW.	STP-0130(27)	2020	ADD.27	50
	NOT	<u>ES:</u>				
	1.		Shallow Dryw	vell De	tails, S	See
S ep	2.	Adjus	ADD.18,/1 st all DWS e. VMs to Finis		•	NVs
	3.	Provi	de Type 2D	Curb µ	ber HD	ЮT
			lard Plan D- er Islands.	05 ard	DUNA	^
lvd.	<u>4.</u>	1211212	t grale shal 1P. See Det.	Sht. A	DD.18	and
	5.	Unles	<del>Std. Plans</del> s otherwise ons are along	noted,	all	15.— d. ¢.
	6.	For r	new ¢ monun	nents,		
ave <i>ep</i>	7.	For s	lard Plan D- street light p sical plans.		cations,	, see
es –	8.	Field	locate and v service late		all exi	sting
	9.		Drainline Tre		estora	tion

/1 Detail, See Sht. ADD.17.

<u>1:</u>						510
97″	L4 Az.=224°54′37.9 L=29.01′	7"[	L7 Az.=55°02′23 L=47.25′	.28″		
07″	L5 Az.=48°43′10.26′ L=29.11′		L8 Az.=46°22′45. L=62.71′	68″		500
2.42″	L6 Az.=135°19′07.07 L=3.93′		L9 Az <b>.</b> =44°56′35 L=39 <b>.</b> 96′	.32″		
			<u>LEC</u> <u>AS-BUI</u>	END F LT POS	<u>or</u> Stings	490
· /	BYN R. MCKINH			y line for deletion		
	* LICENSED PROFESSIONAL ENGINEER NO. 13480-C * * *	-	-100.00-	Double as-built	line for deletion	
UNDEF	K WAS PREPARED BY ME R MY SUPERVISION AND		Roadway	Text for posting	• as-built	480
	TION OF THIS PROJECT INDER MY OBSERVATION.		12/16/19	Revised Shee Note 9	t References; Ac	lded
E <sup>7</sup>	J ÉXPIRATION DAT OF THE LICENS		DATE	REV	ISION	
	۲. ۲.		SHEET		8 SHEETS	
				ADD	.27	

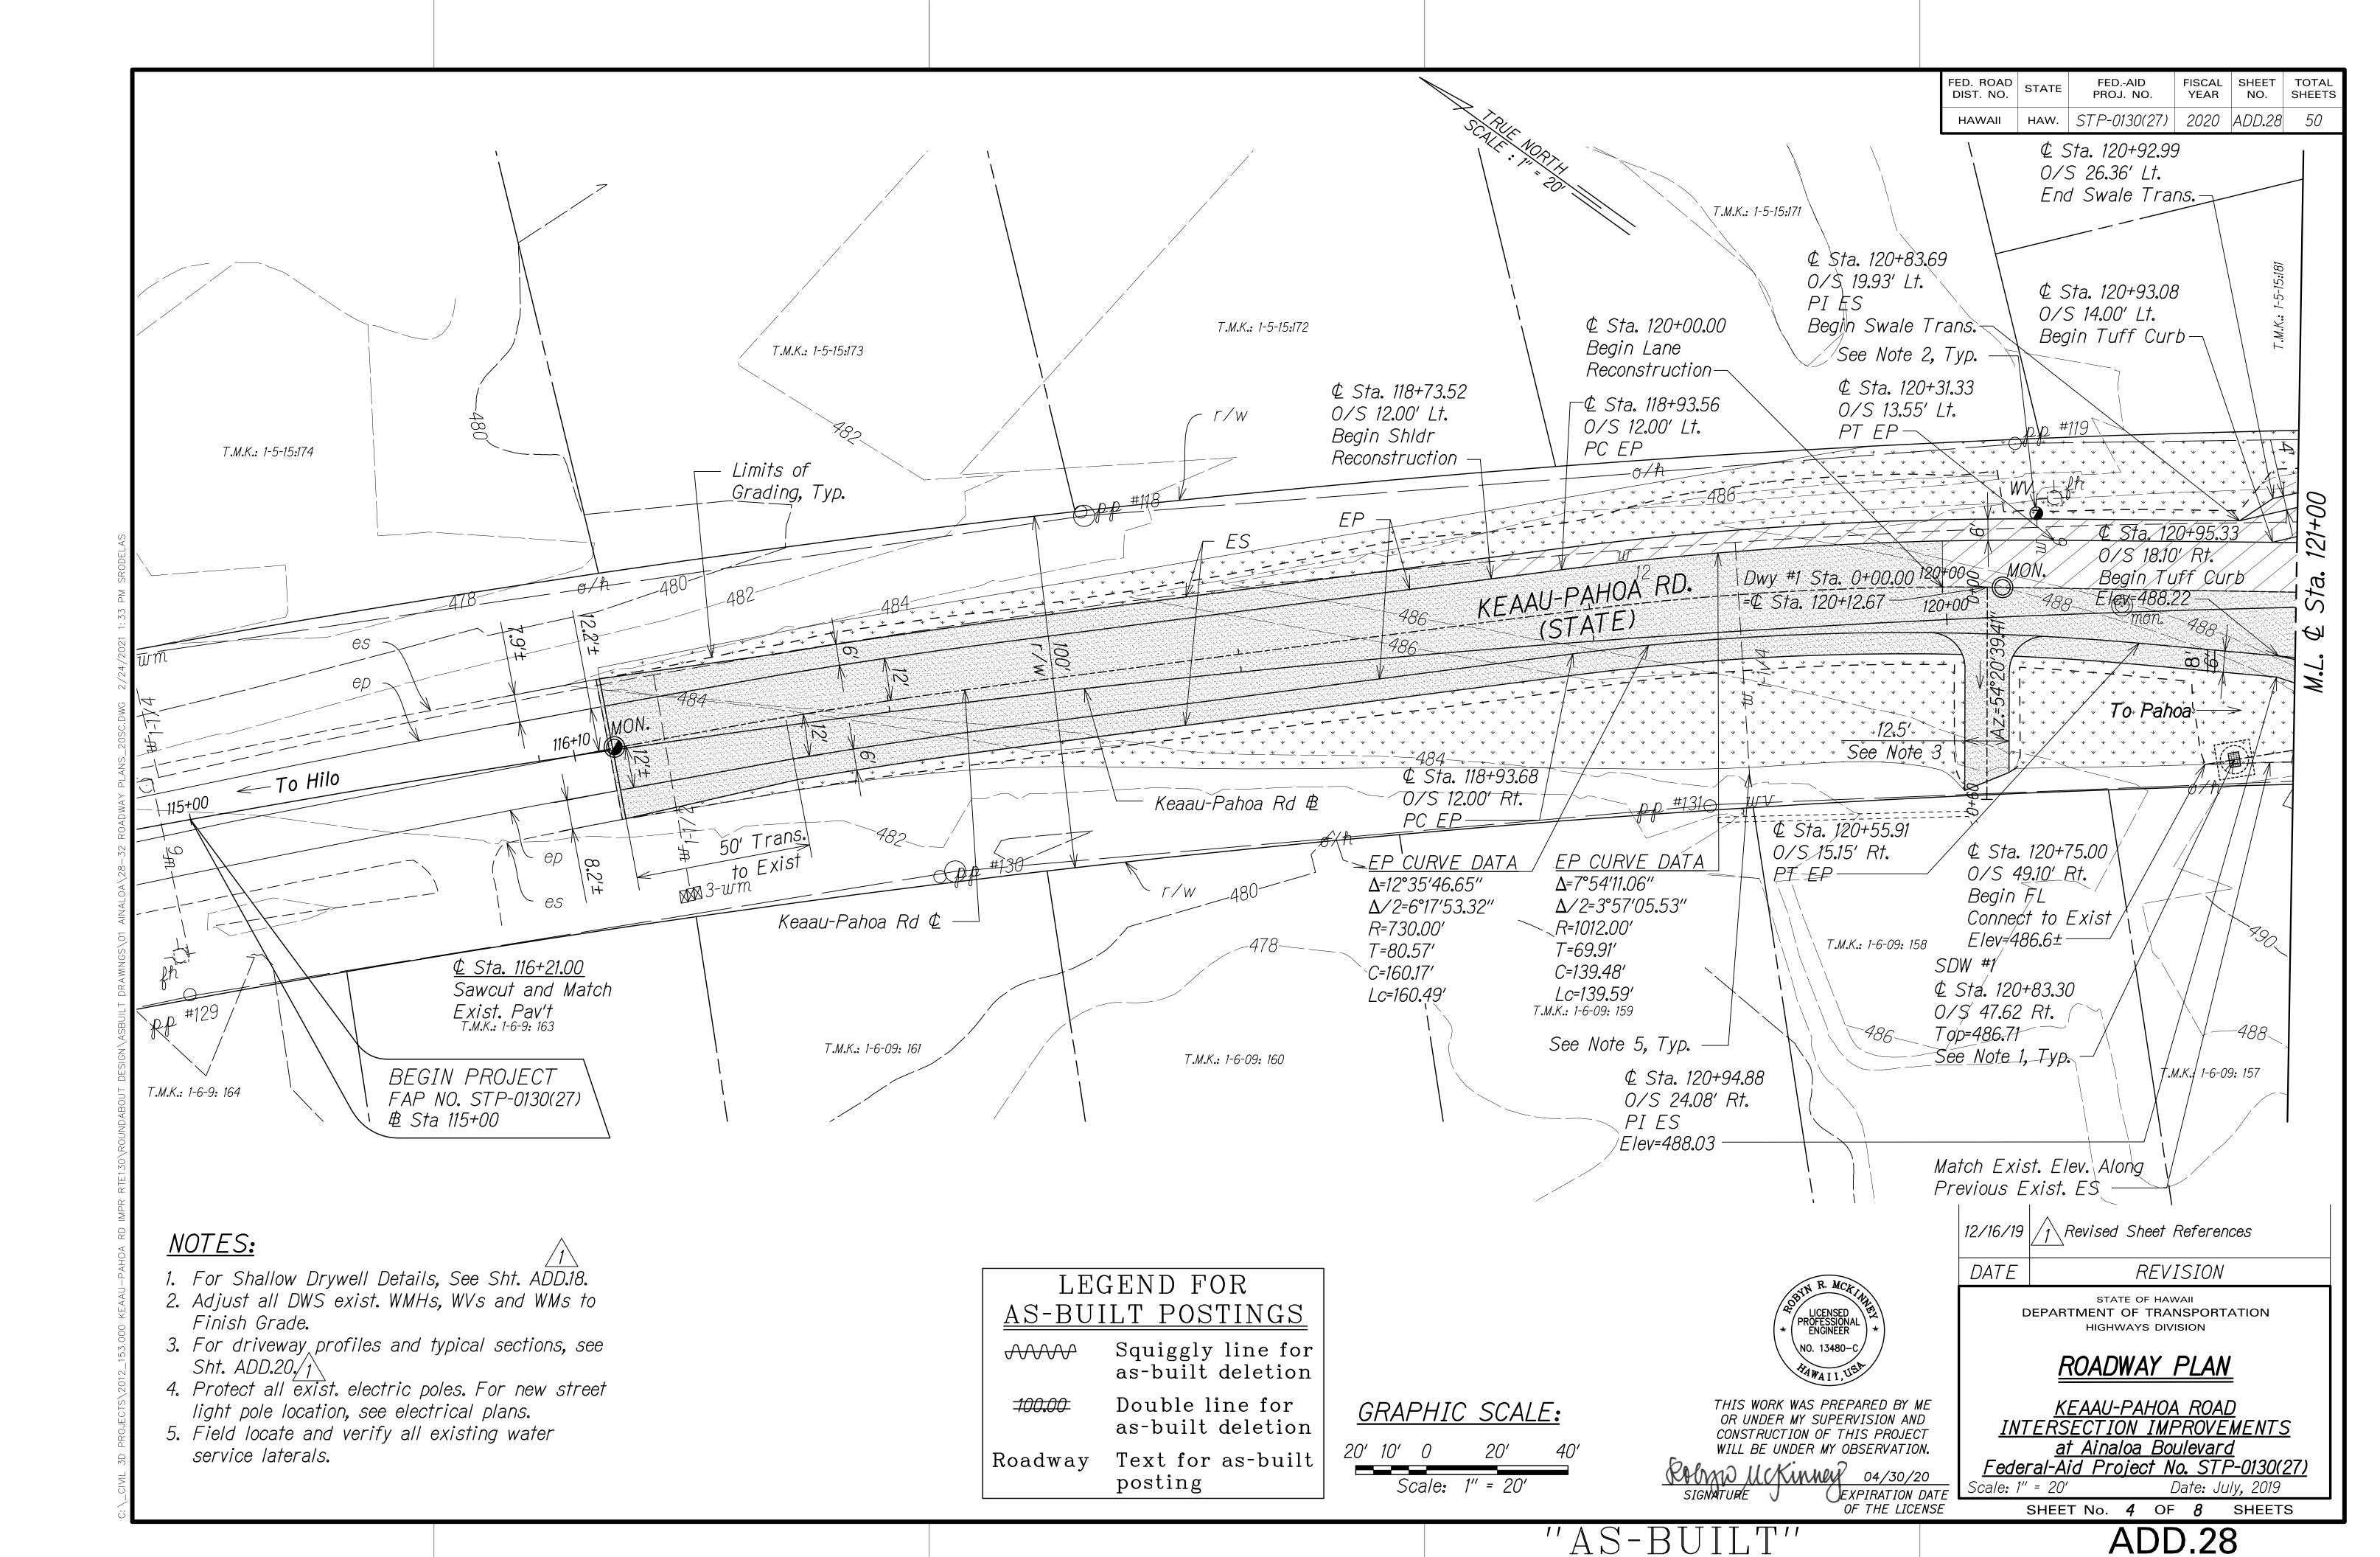

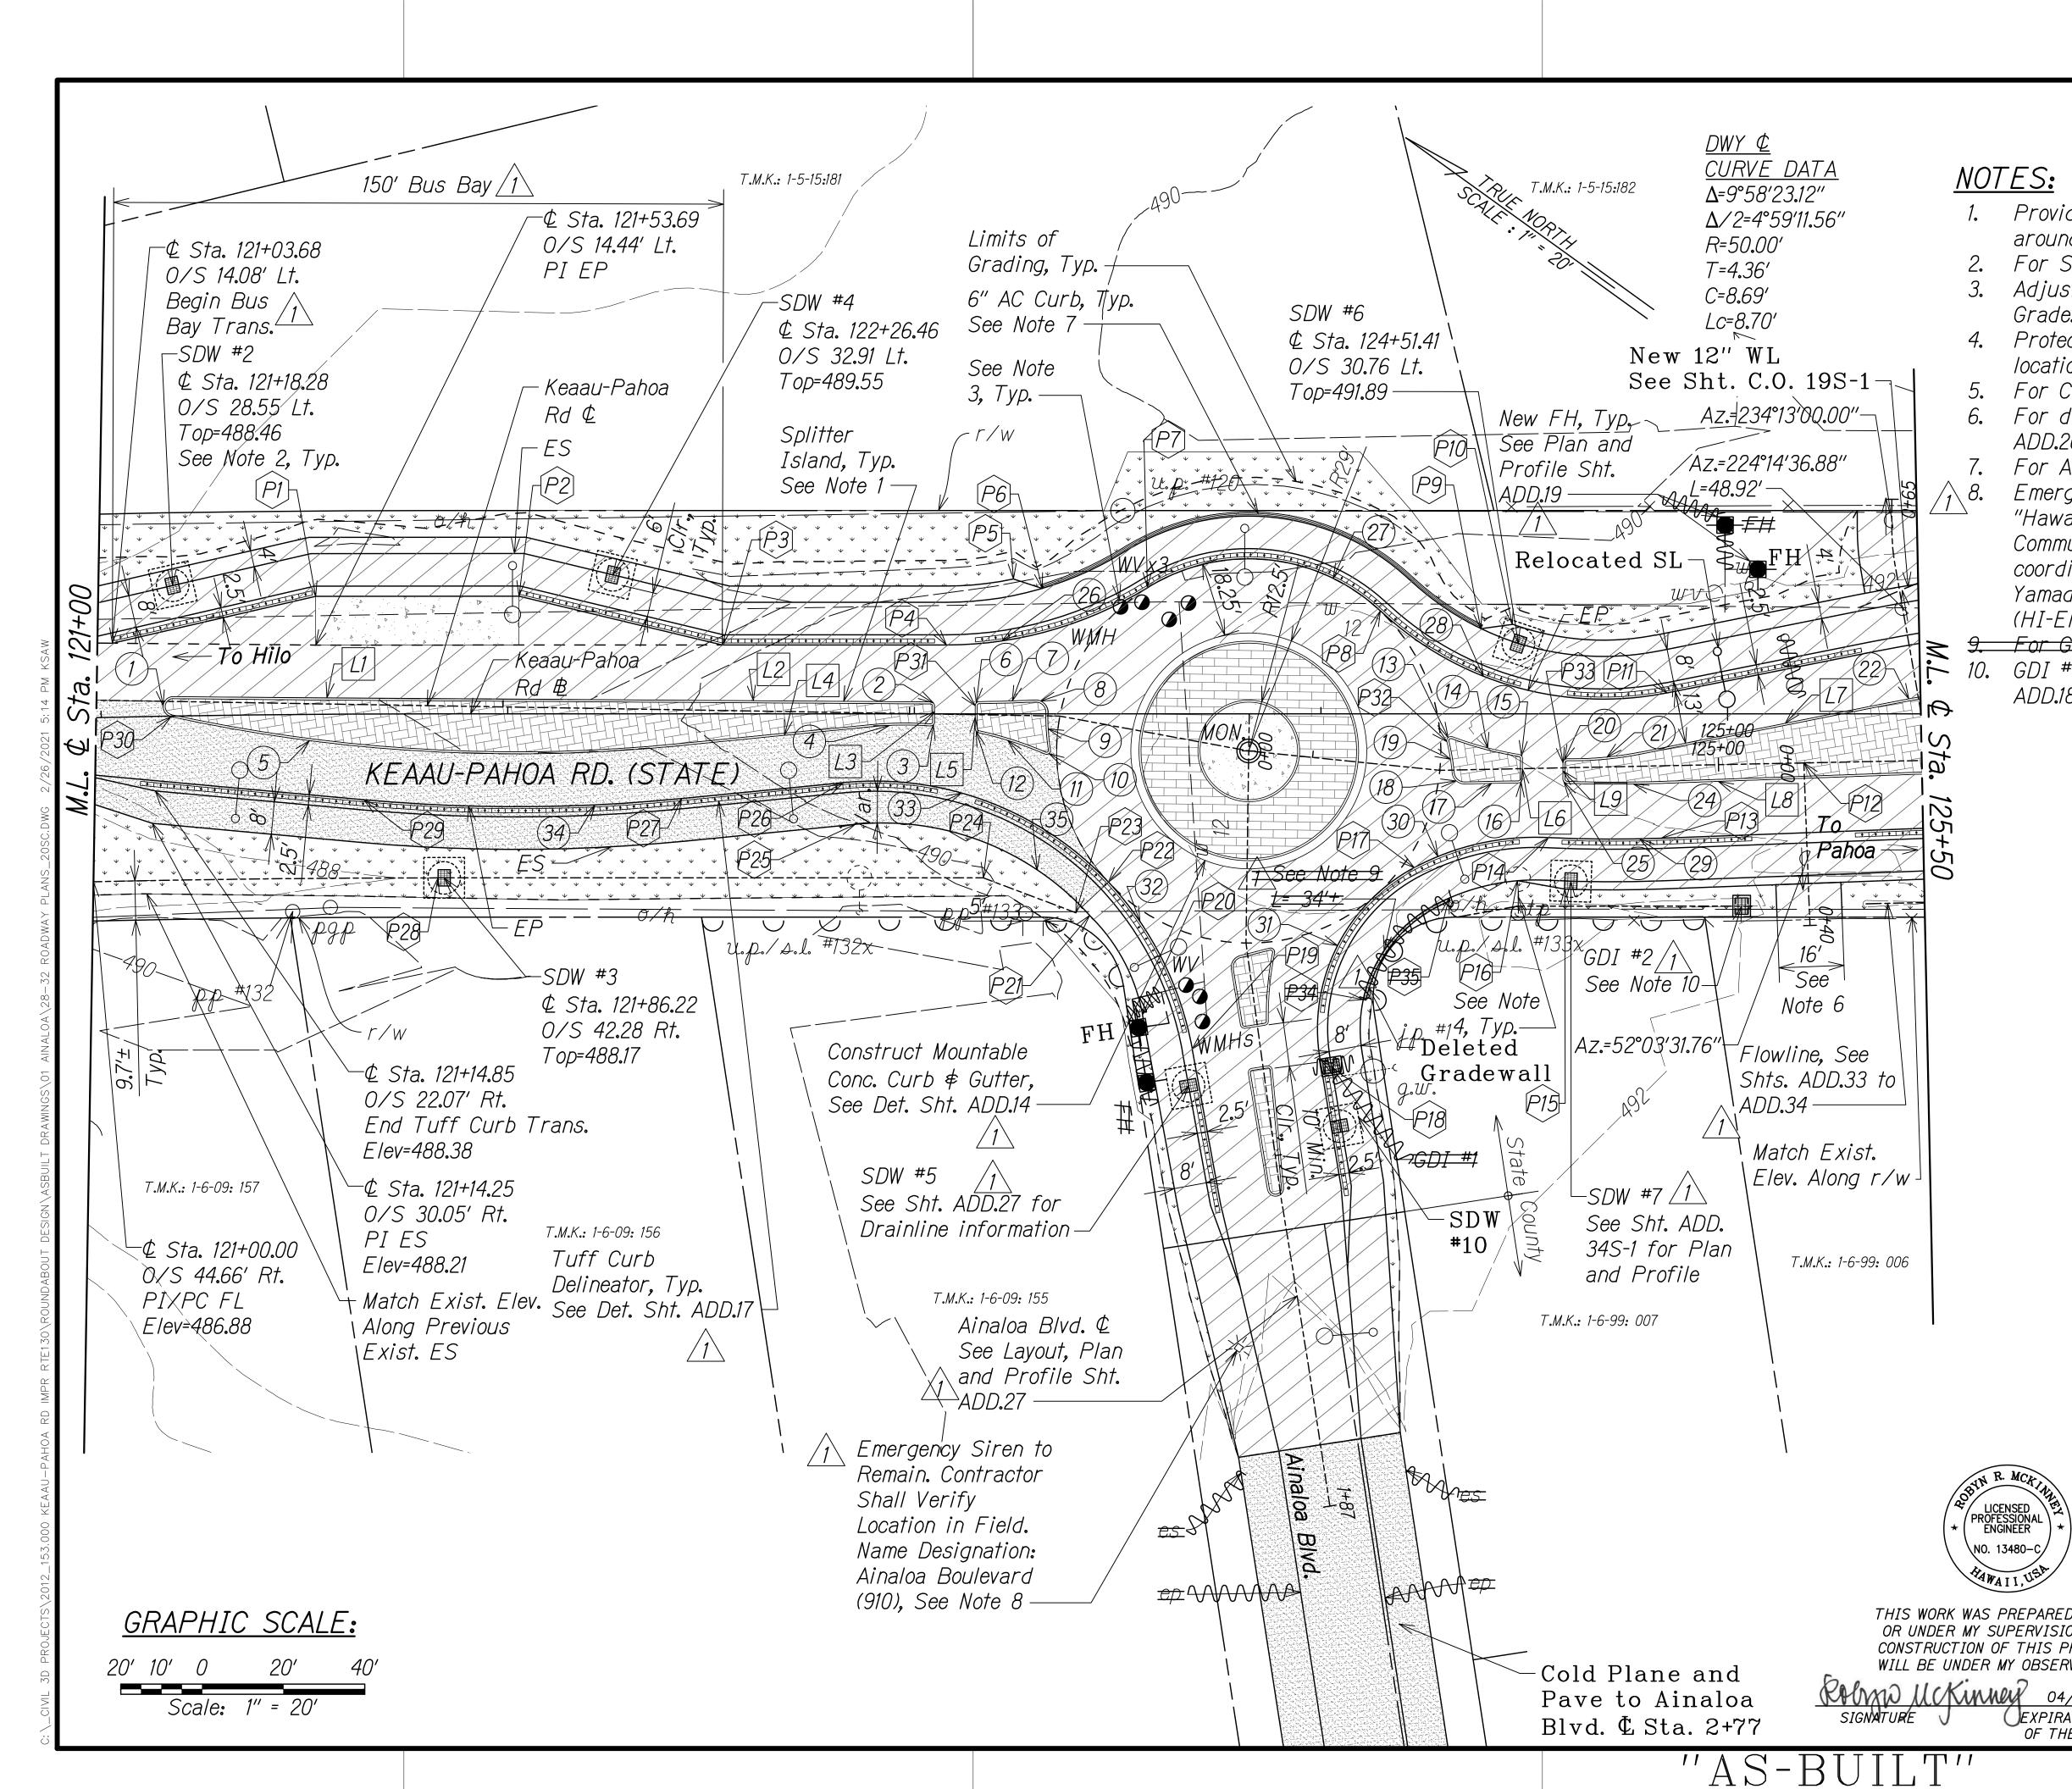

	FED. ROAD DIST. NO.	STATE	FEDAID PROJ. NO.	FISCAL YEAR	SHEET NO.	TOTAL SHEETS
	HAWAII	HAW.	STP-0130(27)	2020	ADD <b>.</b> 29	50
NATES.						

## <u>NUTES:</u>

LICENSED PROFESSIONAL ENGINEER

∖NO. 13480-C/

HAWAII,UT


- 1. Provide Type 2D Curb per HDOT Standard Plan D-05 around Splitter Islands.
- 2. For Shallow Drywell Details, See Sht. ADD.18.
- 3. Adjust all DWS exist. WMHs, WVs and WMs to Finish Grade.
- 4. Protect all exist. electric poles. For street light pole location, see electrical plans.
- 5. For Curve, Line and Point Data, See Sht. ADD.32.
- 6. For driveway profiles and typical sections, see Sht. ADD.20./1

7. For AC curb detail, see HDOT Standard Plan D-05. / 8. Emergency Siren Replacement is part of HI-EMA project "Hawaii Emergency Management Agency Disaster Warning Communication System Devices". For questions and coordination regarding emergency siren, contact David Yamada, Ryan Hirae or Albert Chong at (808) 733-4300 (HI-EMA) and reference the above titled project. 9. For Gradewall detail. See Sht. ADD.15./1

GDI #2 grate shall be a modified 1211214P. See Det. Sht. 10. ADD.18 and HDOT Std. Plans H-12 and H-15.  $\wedge$ 

LEG	END FOR
<u>AS-BUI</u>	LT POSTINGS
	Squiggly line for as-built deletion
-100.00-	Double line for as-built deletion
Roadway	Text for as-built posting

	12/16/19	Revised Grading Limits & Bus Pad callouts; Revised Sheet References; Revised Note #2, #5 and #6; Added Note #8, #9 and #10
P. Ma	DATE	REVISION
R. MCKINH CENSED FESSIONAL VGINEER *	C	STATE OF HAWAII EPARTMENT OF TRANSPORTATION HIGHWAYS DIVISION
13480-C AII, UEA		<u>Roadway plan</u>
PREPARED BY ME SUPERVISION AND OF THIS PROJECT MY OBSERVATION.	<u>IN7</u>	<u>KEAAU-PAHOA ROAD</u> ERSECTION IMPROVEMENTS <u>at Ainaloa Boulevard</u>
04/30/20 EXPIRATION DATE	<u>Feder</u> Scale: 1"	<b>al-Aid Project No. STP-0130(27)</b> = 20' Date: July, 2019
OF THE LICENSE	,	SHEET No. 5 OF 8 SHEETS
		ADD.29

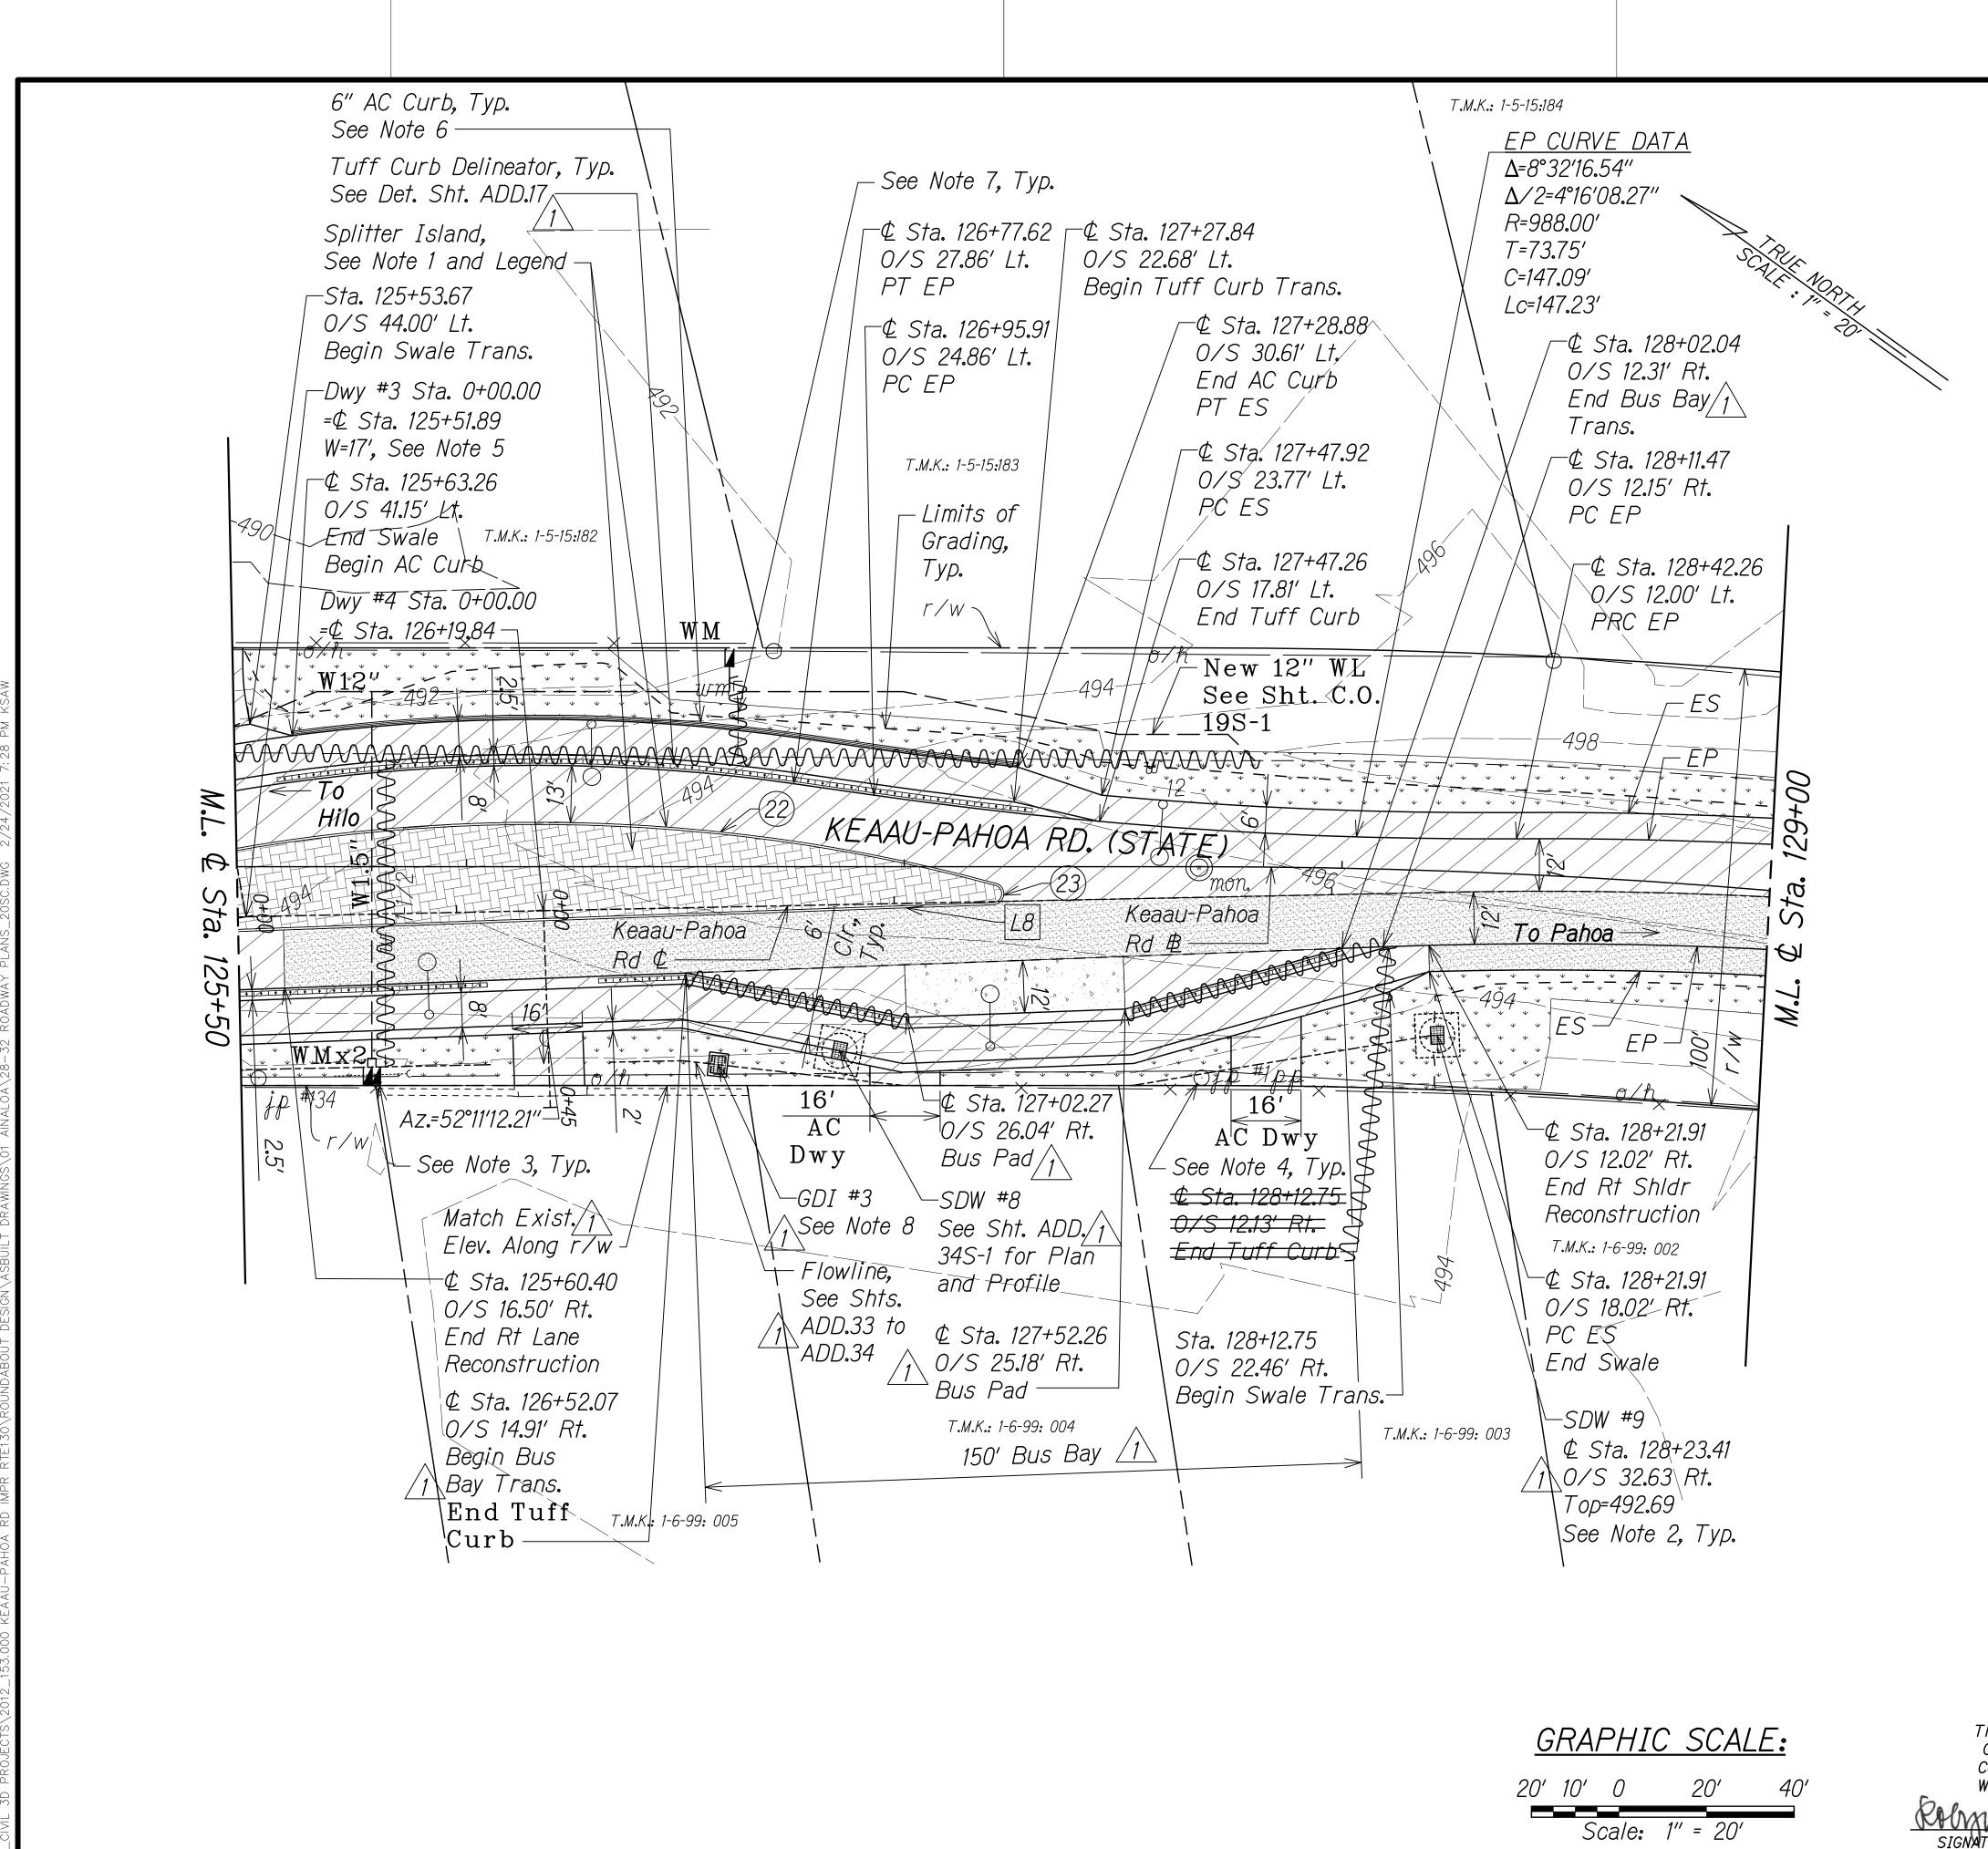


<u>G</u>	RA	PHI	<u>C SCAL</u>	<u>E:</u>	THI OR
0'	10'	0	20'	40'	CON WIL
	S	cale:	1'' = 20'		SIGNATUR


FED. ROAD DIST. NO.	STATE	FEDAID PROJ. NO.	FISCAL YEAR	SHEET NO.	TOTAL SHEETS
HAWAII	HAW.	STP-0130(27)	2020	ADD <b>.</b> 30	50


NOTES:

- 1. Provide Type 2D Curb per HDOT Standard Plan D-05 around Splitter Islands.
- 2. For Shallow Drywell Details, See Sht. ADD.18.
- 1 3. Adjust all DWS exist. WMHs, WVs and WMs to Finish Grade.
  - 4. Protect all exist. electric poles. For new street light pole location, see electrical plans.
- /16.
- 5. For driveway profiles and typical sections, see Sht. ADD.20. For AC curb detail, see HDOT Standard
  - Plan D-05.
  - 7. Field locate and verify all existing water service laterals.

 $/1 \ 8$ . GDI#3 grate shall be a modified 1211214P. See Det. Sht ADD.18 and HDOT Std. Plans H-12 and H-15.

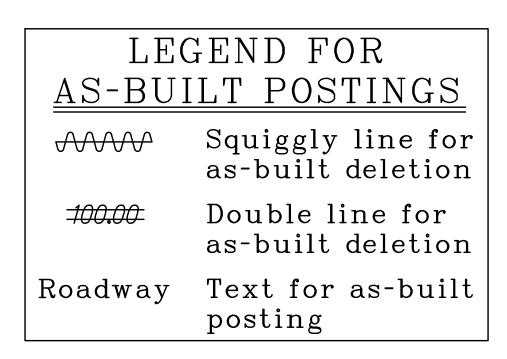

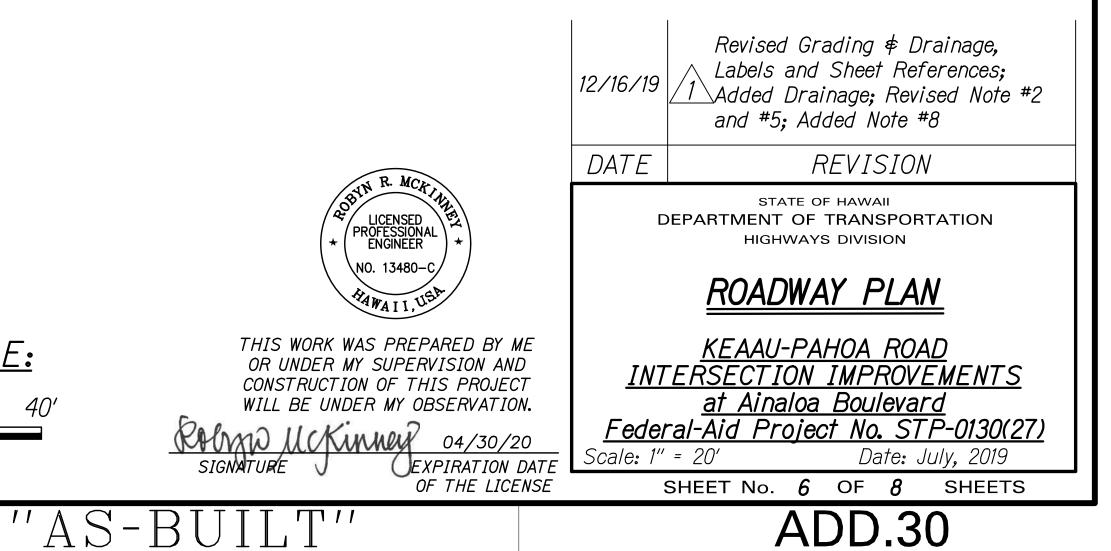

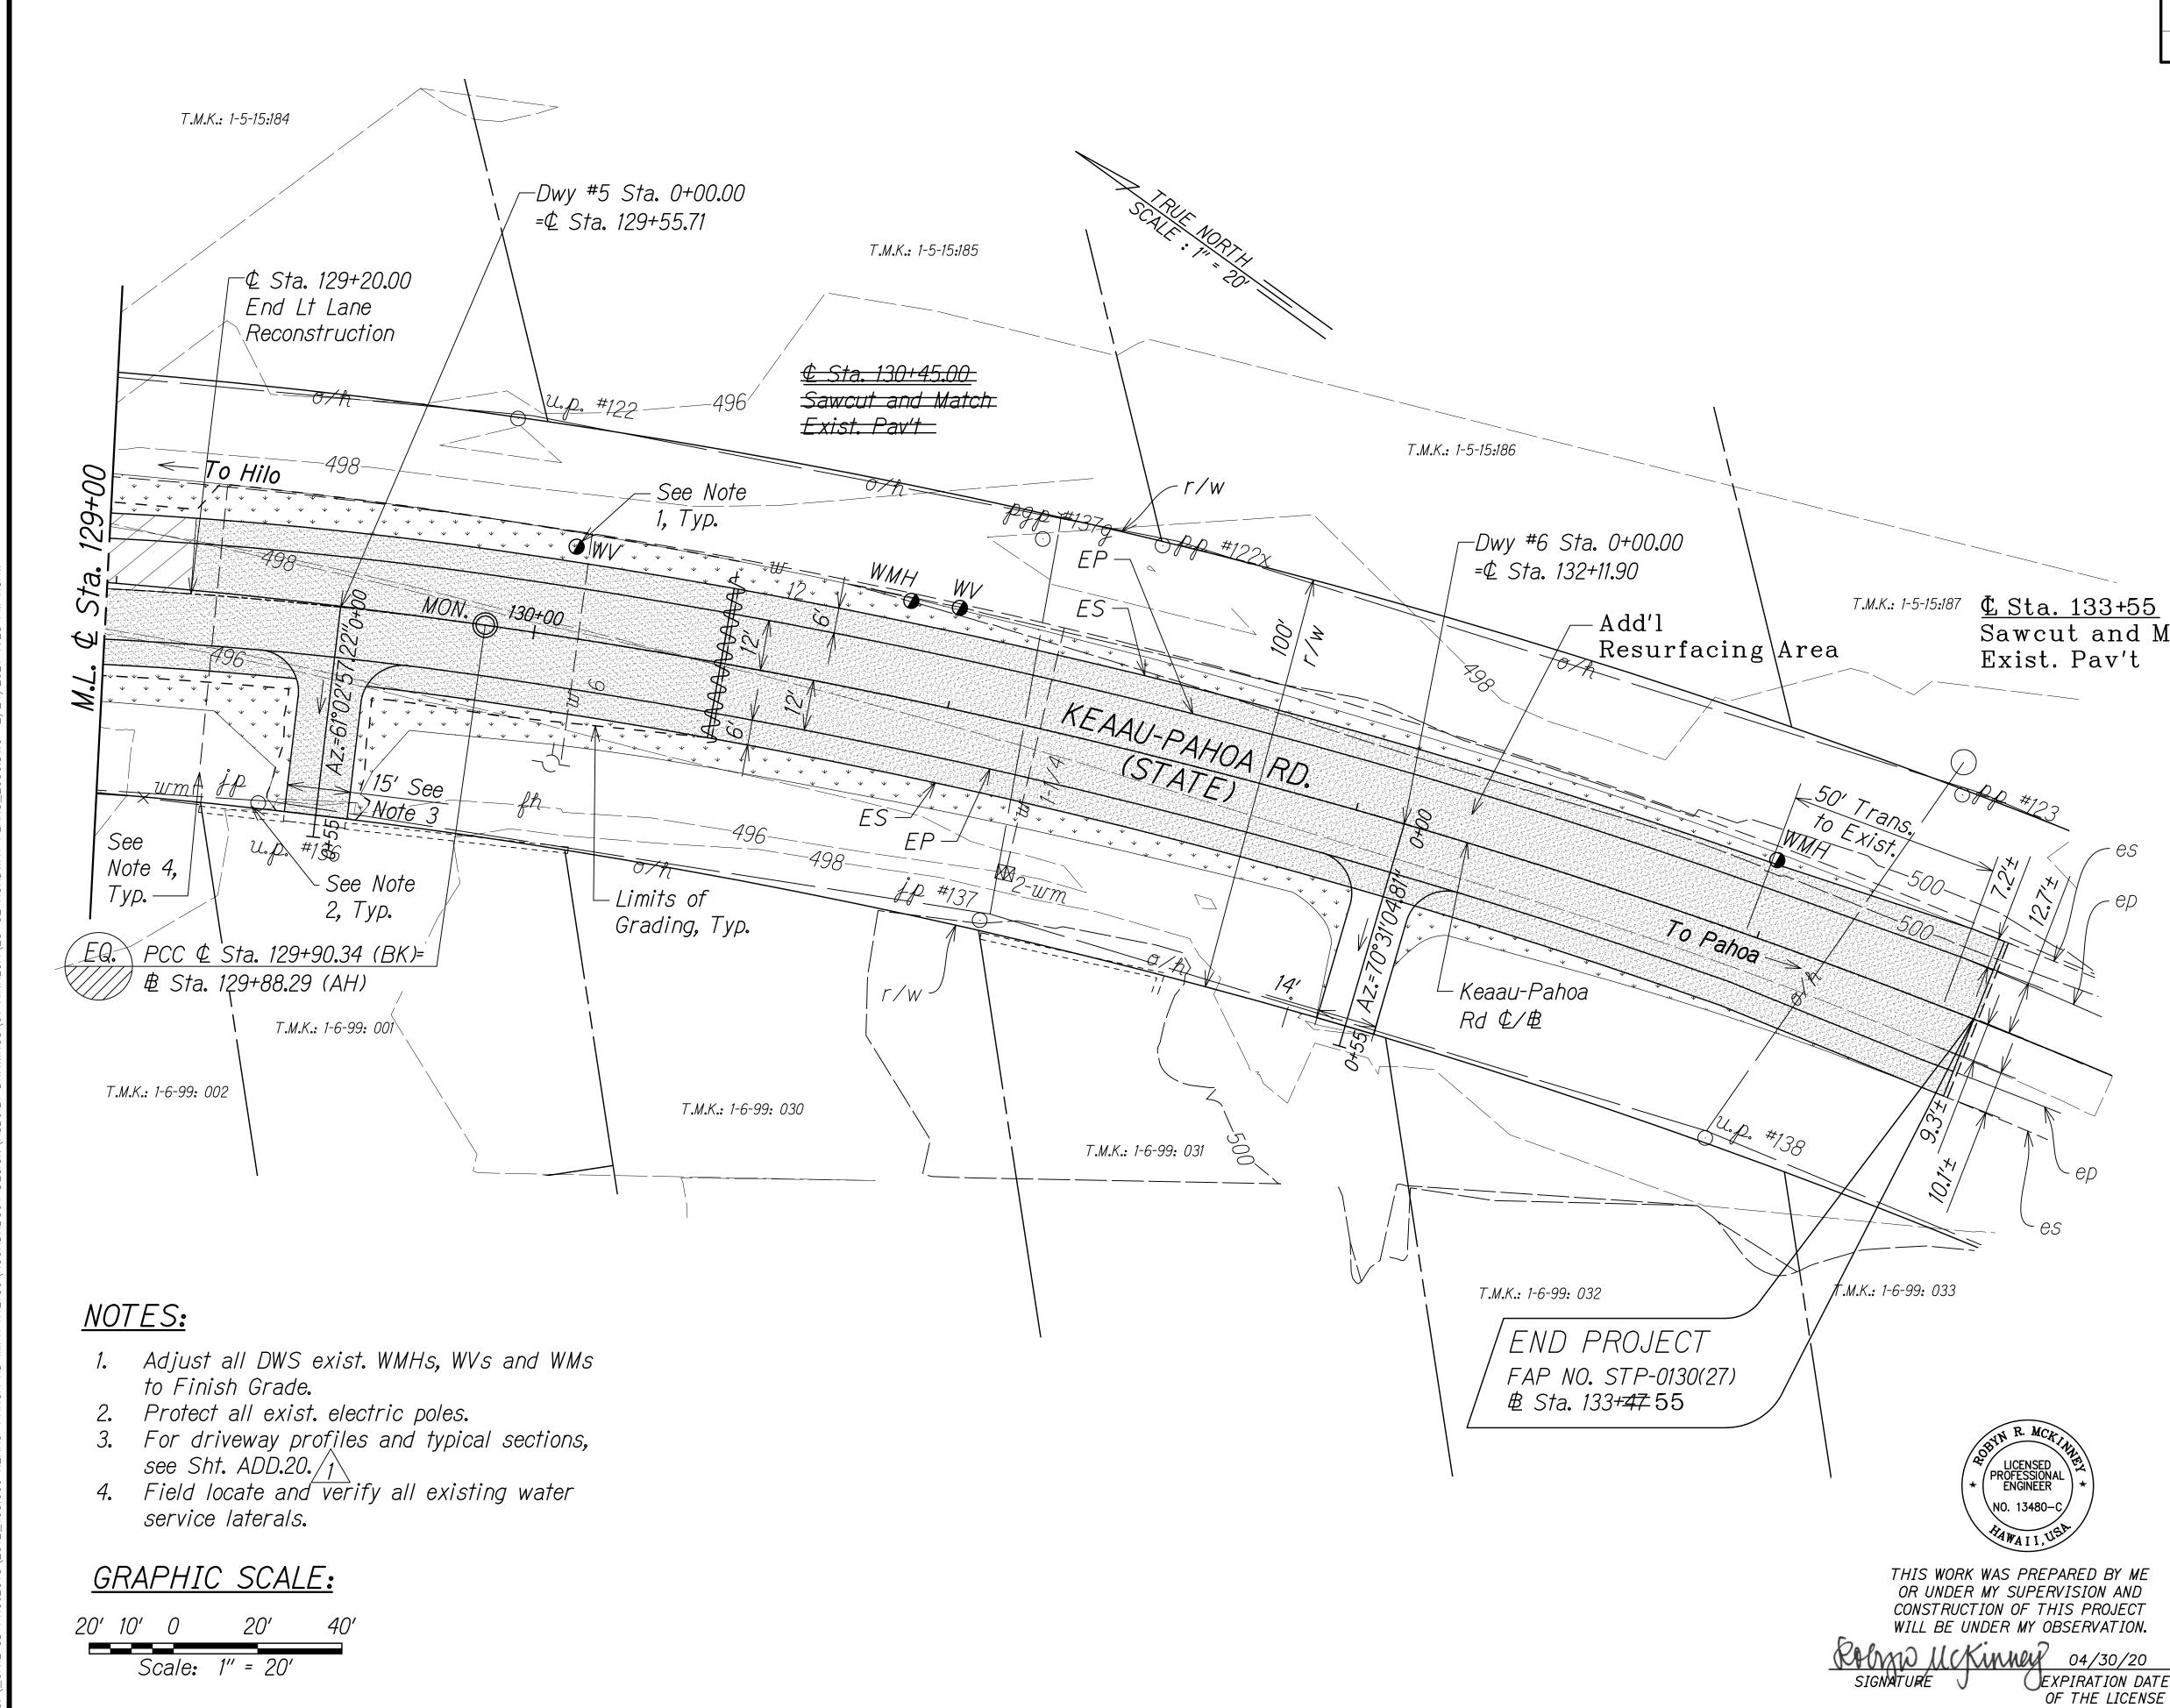



FED. ROAD DIST. NO.STATEFEDAID PROJ. NO.FISCAL YEARSHEET NO.TOTAL SHEETSHANMANHANMANCTD.0120(077)20200ADD.21E0						
		STATE				
HAWAII HAW. 57 P-0130(27) 2020 ADD.31 50	HAWAII	HAW.	STP-0130(27)	2020	ADD.31	50

15 <b>:</b> 187	<u>⊈ Sta. 133+55</u> Sawcut and Match Exist. Pav't

E UNL	DER MY OB	SERVATION.
K	inner	04/30/20
J	()EX	PIRATION DATE

LEGEND FOR							
<u>AS-BUI</u>	LT POSTINGS						
$\sim$	Squiggly line for as-built deletion						
-100.00-	Double line for as-built deletion						
Roadway	Text for as-built posting						

12/16/19	Revised Note #3					
DATE	REVISION					
STATE OF HAWAII DEPARTMENT OF TRANSPORTATION HIGHWAYS DIVISION						
<u>ROADWAY PLAN</u>						
<u>IN7</u>	<u>KEAAU-PAHOA ROAD</u> ERSECTION IMPROVEMENTS					
<u>at Ainaloa Boulevard</u> <u>Federal-Aid Project No. STP-0130(27)</u> Scale: 1" = 20' Date: July, 2019						
	SHEET No. 7 OF 8 SHEETS					
	ADD.31					

LINE	DATA:

LINE	L1	L2	L3	L4	L5	L6	L7	<i>L8</i>	L9
Az	324°44′48.64″	324°34′52 <b>.</b> 09″	54°09′24.80″	138°34′30 <b>.</b> 14″	234°09′24 <b>.</b> 80″	55°00′25 <b>.</b> 47″	312°55′56.91″	142°11′12 <b>.</b> 21″	235°00′25.47″
Distance	34.94′	151.30'	3.93′	48.10′	5.66′	4.99′	60.67′	237.27′	4.02'

## <u>CURVE DATA:</u>

OUTIL															
CURVE		(2)	3	(4)	(5)	6	(7)	8	(9)	(10)	(11)	(12)	(13)	(14)	(15)
$\triangle$	168°15′46.95″	89°34′32.71″	94°07′12.30″	9°42′06 <b>.</b> 96″	17°54′31.55″	89°11′28.85″	1°34′37 <b>.</b> 38″	93°48′02 <b>.</b> 69″	10°26′04.77″	122°33′05 <b>.</b> 25″	11°25′20 <b>.</b> 99″	77°53′26.35″	124°43′31.50″	11°37′38.09″	81°42′27 <b>.</b> 18″
$\Delta/2$	84°07′53 <b>.</b> 48″	44°47′16 <b>.</b> 36″	47°03′36 <b>.</b> 15″	4°51′03 <b>.</b> 48″	8°57′15.77″	44°35'44 <b>.</b> 42″	0°47′18 <b>.</b> 69″	46°54′01 <b>.</b> 34″	5°13′02 <b>.</b> 39″	61°16′32.63″	5°42′40 <b>.</b> 49″	38°56′43 <b>.</b> 17″	62°21′45.75″	5°48′49 <b>.</b> 04″	40°51′13 <b>.</b> 59″
R	2.50'	1.00′	1.00'	86.00'	400.00'	1.00'	500.00'	3.00'	50.25′	1.00'	86.00′	1.00'	1.00'	84.00′	1.00'
Tan.	24.32'	0.99′	1.07'	7.30'	63.03'	0.99'	6.88′	3.21′	4.59′	1.82'	8.60′	0.81′	1.91′	8.55′	0.86'
С	4.97′	1.41′	1.46'	14.55′	124.52′	1.40'	13.76′	4.38'	9.14′	1.75′	17.12′	1.26'	1.77′	17.02′	1.31'
Lc	7.34′	1.56′	1.64'	14.56′	125.03′	1.56'	13.76′	4.91′	9.15′	2.14'	17.14′	1.36'	2.18'	17.05′	1.43'
CURVE	(16)	(17)	(18)	(19)	(20)	(21)	(22)	(23)	(24)	(25)	(26)	(27)	(28)	(29)	(30)
$\triangle$	88°48′19 <b>.</b> 12″	1°30′31 <b>.</b> 79″	86°49′02 <b>.</b> 24″	8°55′10 <b>.</b> 16″	90°10′28 <b>.</b> 97″	12°14′57.54″	26°27′43.38″	162°47′31.93″	4°14′56 <b>.</b> 19″	88°34′17 <b>.</b> 06″	31°47′47 <b>.</b> 73″	75°02′23.36″	54°31′08.01″	4°57′57.74″	30°53′49 <b>.</b> 24″
$\Delta/2$	44°24′09 <b>.</b> 56″	0°45′15 <b>.</b> 90″	43°24′31.12″	4°27′35 <b>.</b> 08″	45°05′14 <b>.</b> 49″	6°07′28.77″	13°13′51 <b>.</b> 69″	81°23′45 <b>.</b> 97″	2°07′28.10″	44°17′08.53″	15°53′53 <b>.</b> 86″	37°31′11 <b>.</b> 68″	27°15′34.00″	2°28′58 <b>.</b> 87″	15°26′54.62″
R	1.00'	500.00′	3.00'	50.25′	1.00'	84.00'	400.00'	2.50'	307.00′	1.00'	93.86′	47.25′	80.00'	320.00′	63.50′
Tan.	0.98′	6.58′	2.84′	3.92′	1.00'	9.01'	94.05′	16.52′	11.39′	0.98′	26.73′	36.28′	41.22'	13.88′	17.55′
С	1.40'	13.17′	4.12'	7.81′	1.42'	17.92′	183.10'	4.94′	22.76′	1.40'	51.42′	57.55'	73.28′	27.73′	33.83'
Lc	1.55′	13.17′	4.55'	7.82′	1.57'	17.96′	184.74′	7.10'	22.77′	1.55′	52.09′	61.88′	76.12′	27.74′	34.24′
						- -									
CURVE	(31)	(32)	(33)	(34)	(35)										
$\triangle$	71°20′14.58″	32°34′31 <b>.</b> 17″	52°26′25 <b>.</b> 43″	10°51′54 <b>.</b> 09″	53°48′04 <b>.</b> 26″										
$\Delta/2$	35°40′07 <b>.</b> 29″	16°17′15.59″	26°13′12 <b>.</b> 72″	5°25′57 <b>.</b> 04″	26°54′02 <b>.</b> 13″	]									
R	45.00'	81.91′	78.82′	413.00′	68.32′										
Tan.	32.30'	23.93′	38.82′	39.28′	34.66′										

## POINT DATA:

С

LC

*P1 € Sta. 121+53.49 0/S 26.44' Lt.* Bus Pad

52.48′

56.03'

- PRC EP
- PT EP
- PT EP
- PC ES
- Splitter Island

P2 € Sta. 122+03.48 0/S 27.27' Lt. Bus Pad

69.65'

72.14'

45.94'

46.57'

- PRC EP
- PRC EP
- PT ES
- ₽26 ¢ Sta. 122+83.99 0/S 17.24' Rt. PC EP
- P32 € Sta. 124+33.32 0/S 7.03' Lt. Splitter Island

P3 & Sta. 122+53.67 0/S 16.11' Lt. End Bus Bay Trans.

61.82'


64.15'

/1\

78.20'

78.32'

- P9 ¢ Sta. 124+42.22 0/S 34.62' Lt. End AC Curb Begin Swale
- ₽15 ¢ Sta. 124+61.59 0/S 29.83' Rt. End Swale Trans.
- PCC ES
- € Sta. 122+44.32 0/S 21.82' Rt. PT EP
- P33 & Sta. 124+61.80 0/S 1.22' Lt. Splitter Island

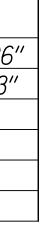

- PC EP
- P10 & Sta. 124+50.00 0/S 35.54' Lt. End Swale Trans.

P16 Sta. 124+50.00 0/S 27.53' Rt. Begin Swale

PCC EP Begin Reconstruction

₽28 ¢ Sta. 121+84.72 0/S 42.31' Rt. PT FL Elev=488**.**15

E34 - Sta. 124+18.42 → <del>0/S 57.98' Rt. /1</del> Begin Gradewall

- P5 Sta. 123+25.00 0/S 33.53' Lt. Begin Swale Trans.
- *P11* ∉ Sta. 124+87.65 0/S 17.88' Lt. PT EP


€ Sta. 124+27.62 0/S 24.45' Rt. PCC EP

P23 & Sta. 123+49.63 0/S 46.84' Rt. End FL Elev=491**.**49

€ Sta. 121+66.14 0/S 23.40' Rt. PC EP

€35 0/S 31.49' Rt. /1 End Gradewall

- *P6 € Sta. 123+32.15 0/S 31.32' Lt.* End Swale Begin AC Curb
- P12 Dwy #2 Sta. 0+00.00 =© Sta. 125+21.00
- PC EP
- ₽24 ¢ Sta. 123+18.82 0/S 40.09' Rt. PI FL Elev=489**.**80
- Splitter Island

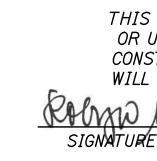

"AS-BUI]

FED. ROAD DIST. NO.	STATE	FEDAID PROJ. NO.	FISCAL YEAR	SHEET NO.	TOTAL SHEETS
HAWAII	HAW.	STP-0130(27)	2020	ADD.32	50

LEGEND FOR						
AS-BUI	LT POSTINGS					
	Squiggly line for as-built deletion					
-100.00	Double line for as-built deletion					
Roadway	Text for as-built posting					

	12/16/19	Added Gradewall Data; Revised				
N. R. MCL	DATE	REVISION				
+ (ENGINEER) +	STATE OF HAWAII DEPARTMENT OF TRANSPORTATION HIGHWAYS DIVISION					
NO. 13480-C		<u>CURVE DATA</u>				
WORK WAS PREPARED BY ME INDER MY SUPERVISION AND TRUCTION OF THIS PROJECT BE UNDER MY OBSERVATION.	<u>IN7</u>	<u>KEAAU-PAHOA ROAD</u> ERSECTION IMPROVEMENTS <u>at Ainaloa Boulevard</u>				
EXPIRATION DATE OF THE LICENSE	Scale: 1"	r <u>al-Aid Project No. STP-0130(27)</u> = 20' Date: July, 2019 SHEET No. <b>8</b> OF <b>8</b> SHEETS				
T''		ADD.32				