
# GENERAL NOTES - ELECTRICAL:

- The scope of work for this project shall consist of installing new highway lighting, disconnecting and removal of existing street lighting systems, and provide power to EVČ.
- The Contractor is reminded of the requirements of State of Hawaii Department of Transportation 2005 Standard Subsection 105.16 - Subcontracts, which requires him/her to perform work accounting to not less than 30 percent of the total contract cost less deductible items. Non-compliance with this subsection may be grounds for rejection of bid.
- The Contractor's attention is directed to the following sections of State of Hawaii Department of Transportation 2005 standard:
  - a. Subsection 104.11 Utilities and Services
  - b. Subsection 107.06 Contractor Duty Regarding Public Convenience
  - c. Section 645 Work Zone Traffic Control
- All necessary permits shall be obtained by the Contractor at his/her own cost.
- The Contractor shall comply with the State of Hawaii's Occupational Safety and Health Law (DOSH).
- Locations of existing underground structures and utilities such as pipelines, conduits, cables, manholes, monuments and structures shown on the plans are approximate only. It is not the intent of these plans to show the exact location of all underground utilities and structures. It is the responsibility of the Contractor to verify the locations of existing utilities with the respective owners. Existing utilities damaged by the Contractor shall be repaired by the Contractor at his own cost. Prior to any excavation work contractor shall call 'Hawaii One Call Center" at ph. 811 or ph. 1-866-423-7287.
- All work shall be constructed in accordance with the following construction standards and specifications:
  - a. Construction Standards of Department of Transportation, State of Hawaii.
  - b. Current Standard Specifications for Road and Bridge Construction, State of Hawaii.
  - c. Standard Details for Public Works Construction, Department of Public Works, County of Hawaii.
  - d. Current Standard Specifications for Public Works Construction, Department of Public Works, City and County of Honolulu.
  - e. Construction Standards and Specifications of the Hawaii Electric Light Company.
- It is not the intent of these plans and specifications to indicate all existing utilities. The information on the existing utilities are based on available plans and a limited amount of field work. The locations are approximate only and the Contractor shall verify the location and depth of the facilities and exercise proper care in excavating in this area. All existing utilities whether or not shown on the plans shall be protected at all times by the contractor unless specified on the plans to be abandoned or demolished. The Contractor shall be responsible for any damages to the facilities whether shown or not shown on plans. Any repair work shall be provided at no additional cost to this project.
- The Contractor shall exercise proper care when excavating in areas with existing underground facilities, damages to the existing facilities shall be immediately reported to the respective utility companies, county or state agency. The repair work shall be provided at no additional cost to this project.
- Contractor shall install 3 /16" polypropylene fish rope in all empty ducts. Plug all empty ducts with non-corrodible plugs manufactured for this purpose.
- Refer to County of Hawaii, Department of Public Works, Traffic Division Street Light Standards, dated October 15, 2019 for additional street light notes and details.

# ELECTRICAL SYMBOL LIST / MOUNTING HEIGHT SCHEDULE


Mounting Height From Floor to			(Special Mounting Heights Indicated on Plan)			
		Floor	Symbol		Description	
T	ор	Ç	Existing	New		
			——		Underground Duct Line, See Duct Section Indicator and Schedule	
			( <del>)</del>	<b>○</b>	Pole Light Assembly, Single Luminaire per Pole (Luminaire and Pole per DOT Standards)	
				1	Duct Section Indicator	

DUCT SCHEDULE							
No.	Description	Cables					
S	3" PVC Schedule 40 with Pullstring	Provided by HELCO					
1	2" PVC Schedule 40	See One Line Diagram					
2	2" PVC Schedule 40 (Spare)	With Pullstring					
3	Not Used	-					
4	Not Used	_					
5	Not Used	_					
6	Not Used	-					
7	Not Used	_					
8	Not Used	-					

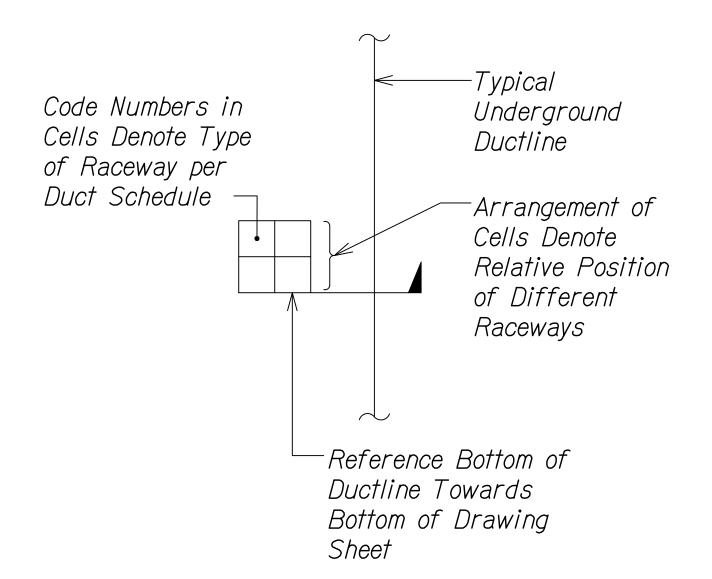

DUCT SECTION FLAG CODE

E-1 Not to Scale

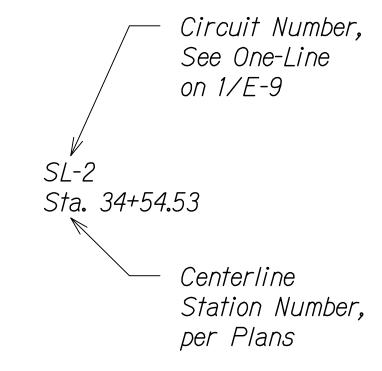





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Humto 04/30/22 EXPIRATION DATE OF THE LICENSE

Scale: As Noted

STATE OF HAWAII DEPARTMENT OF TRANSPORTATION ELECTRICAL GENERAL NOTES AND SYMBOL LIST

KEAAU-PAHOA ROAD INTERSECTION IMPROVEMENTS at Orchidland Drive \$ Makuu Drive Federal-Aid Project No. STP-0130(27) Date: Sept 2020

> OF *10* SHEETS SHEET No. 1

90

FISCAL SHEET TOTAL YEAR NO. SHEETS

90

2021

FED.-AID

STP-0130(27)

ABBREVIATIONS

| AASHTO | Highway and Transportation |

Concrete Masonry Unit

Classification System

Hawaiian Electric Light

Hawaii Department of

National Electric Code

Outside Diameter

Stainless Steel

Tax Map Key

Weatherproof

Transformer

P.S.I. Pounds per Square Inch

Load and Resistance Factor

Transporataion

*Identification* 

Enhanced Vehicle

Foot Candle

Officials

Circuit

Ground

Handhole

Company

Design

Maximum

Minimum

Matchline

Mounted

Number

Road

Station

Typical

With

American Association of State

Americans with Disabilities Act

PROJ. NO.

FED. ROAD

DIST. NO.

HAWAII

FC

Gnd

**HELCO** 

HDOT

*LRFD* 

Max

Rd.

Sta.


T.M.K.


Тур.

Xfmr

STATE

HAW.

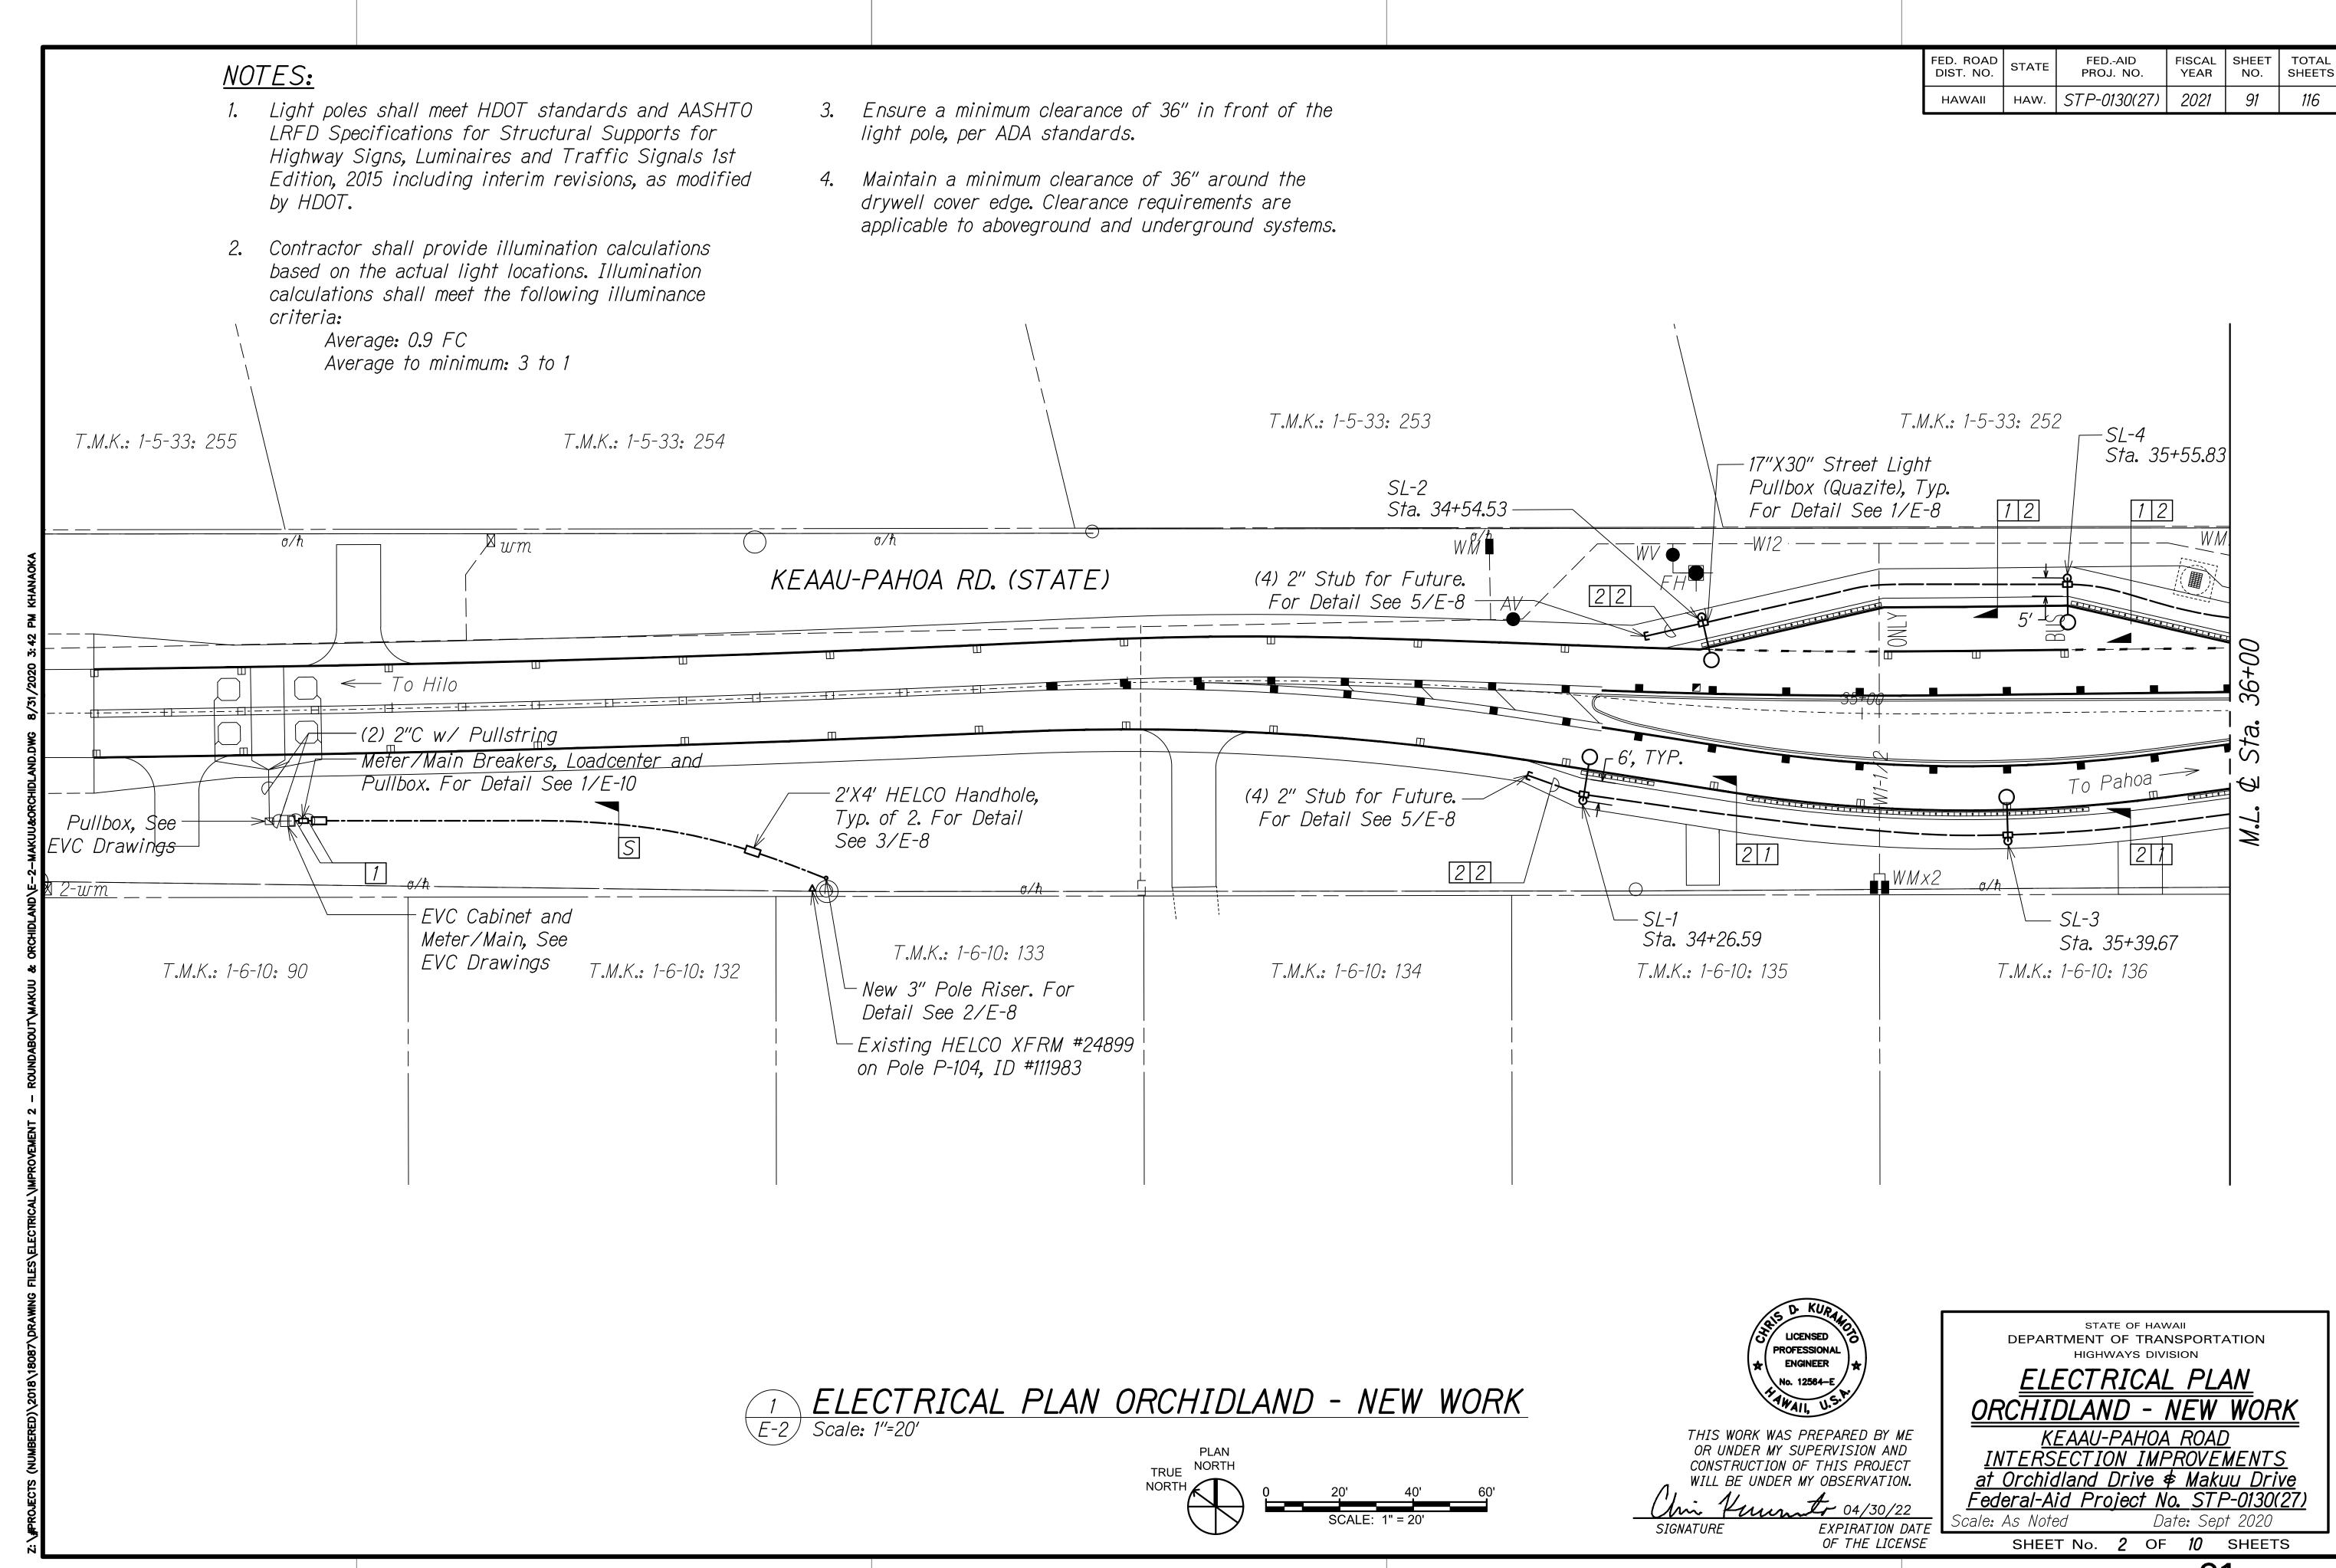

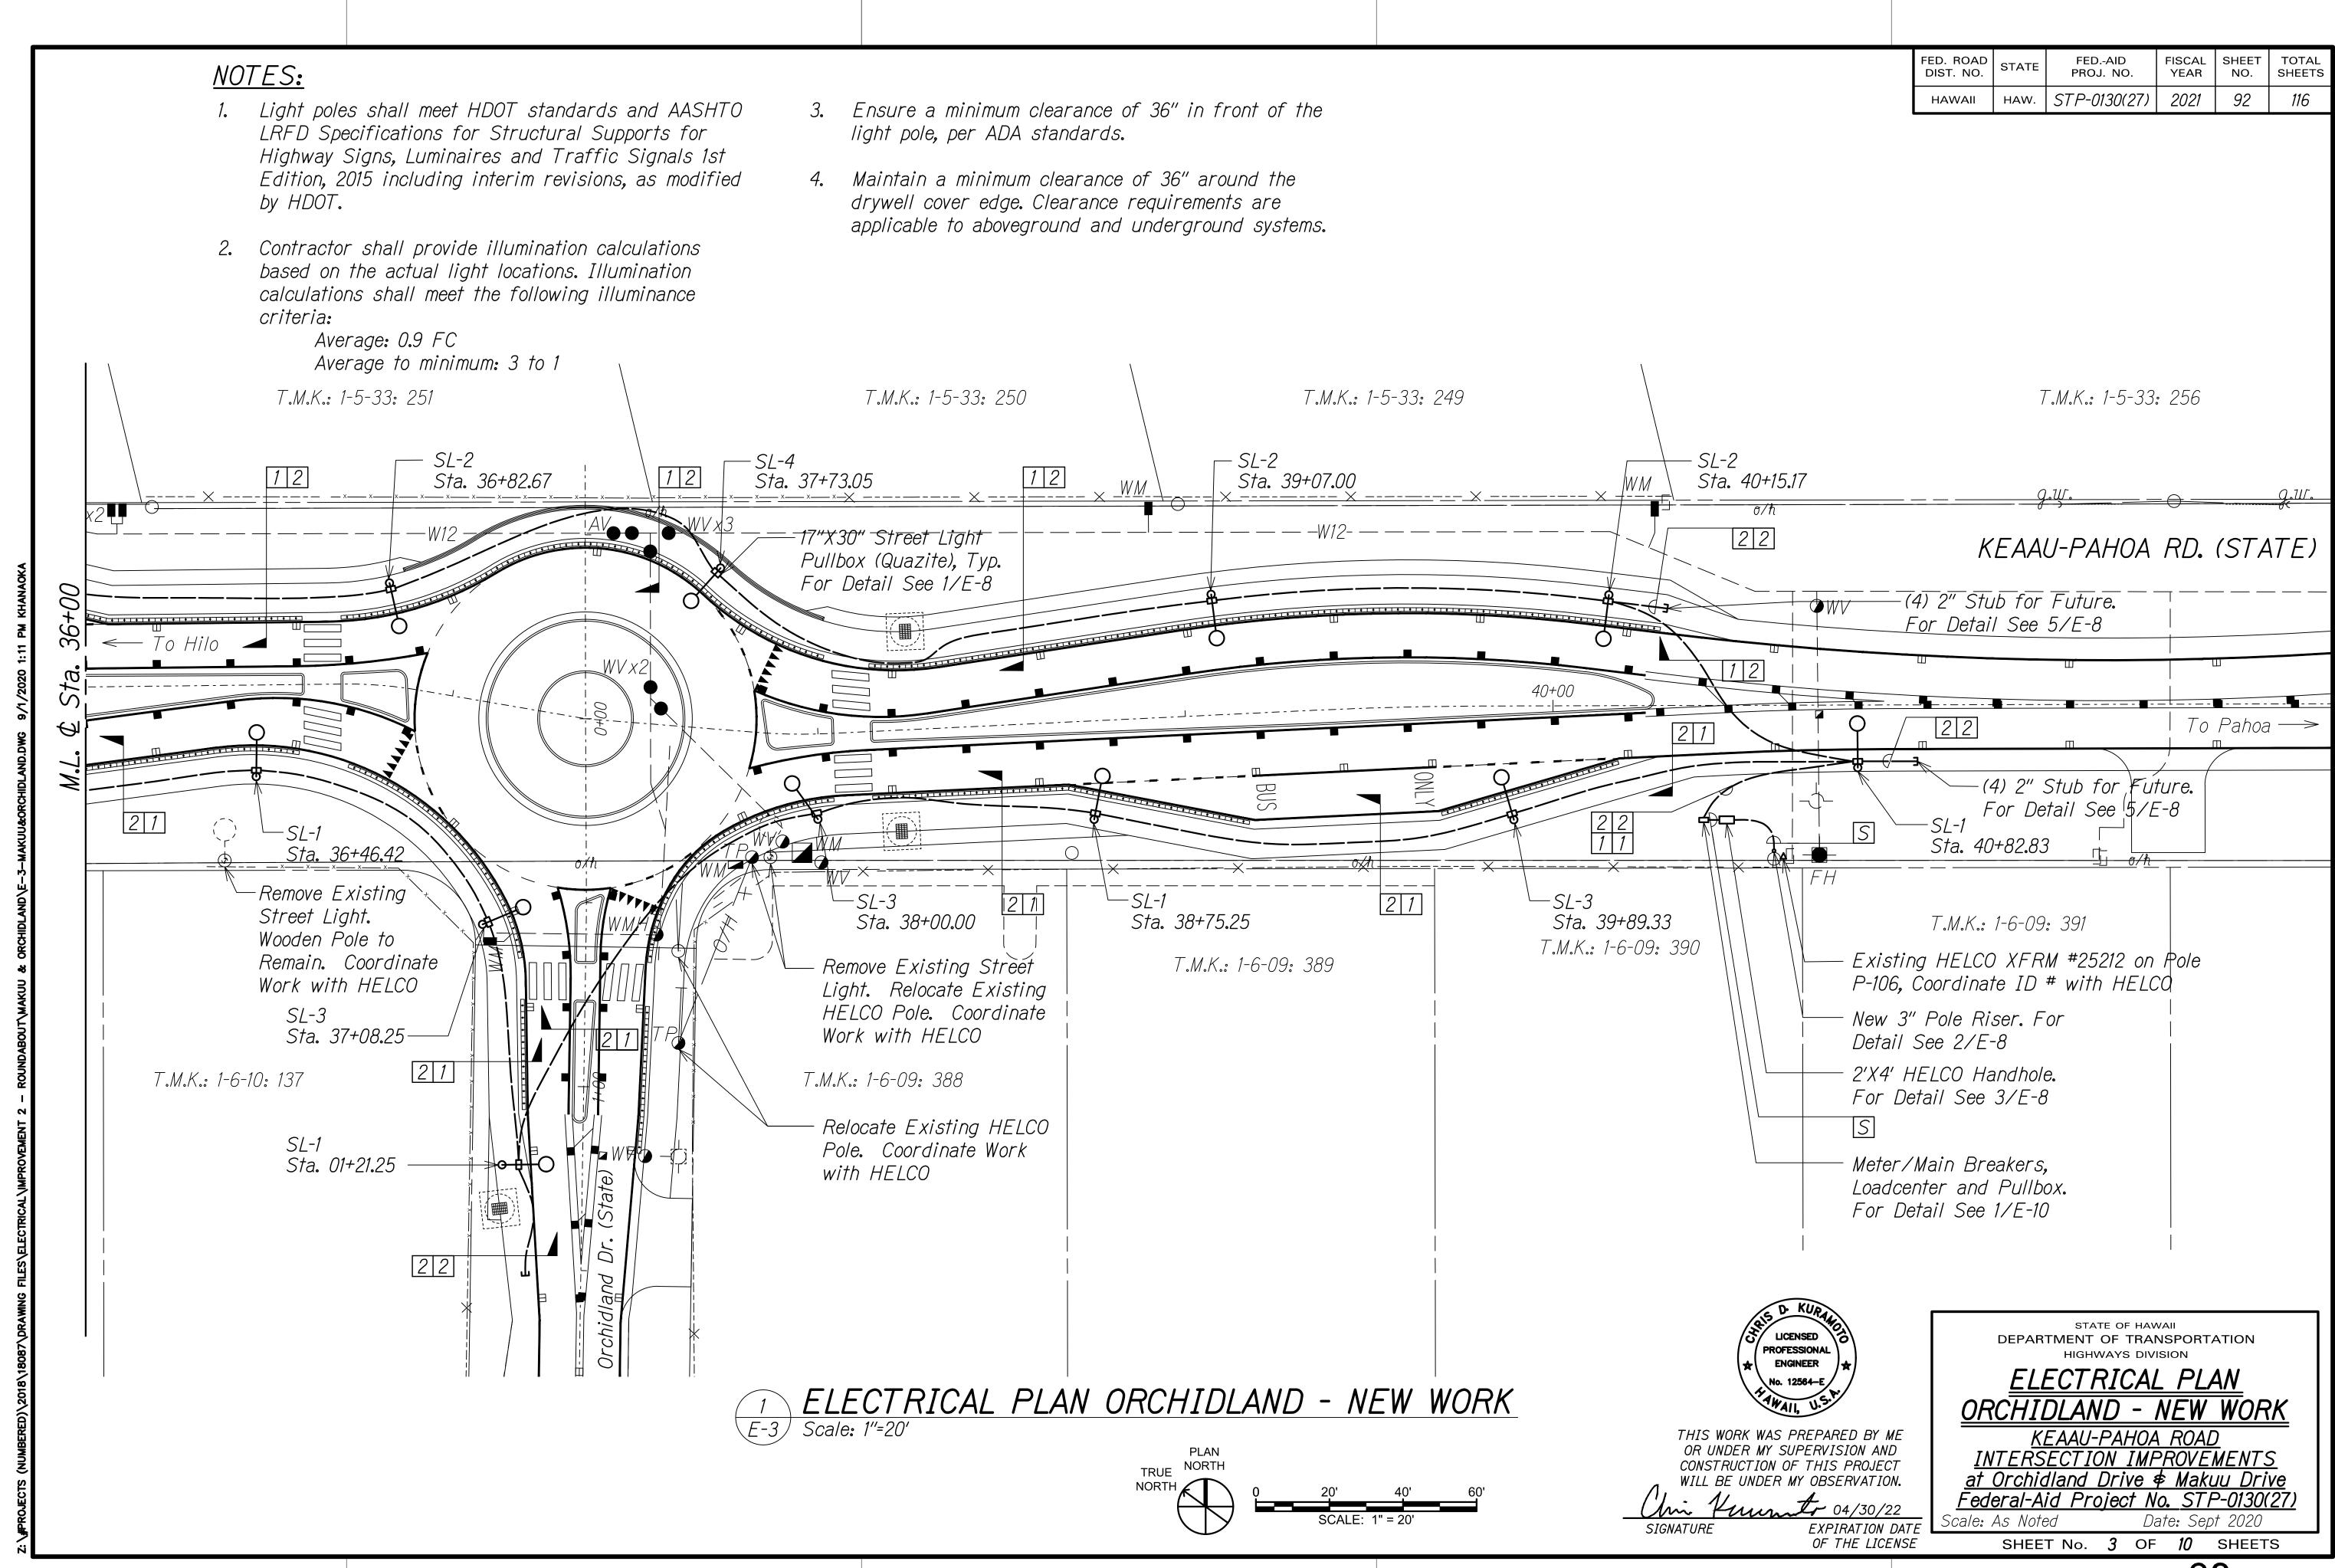


# NOTES:


- 1. Light poles shall meet HDOT standards and AASHTO LRFD Specifications for Structural Supports for Highway Signs, Luminaires and Traffic Signals 1st Edition, 2015 including interim revisions, as modified by HDOT.
- 2. Contractor shall provide illumination calculations based on the actual light locations. Illumination calculations shall meet the following illuminance criteria:

Average: 0.9 FC Average to minimum: 3 to 1

- 3. Ensure a minimum clearance of 36" in front of the light pole, per ADA standards.
- 4. Maintain a minimum clearance of 36" around the drywell cover edge. Clearance requirements are applicable to aboveground and underground systems.

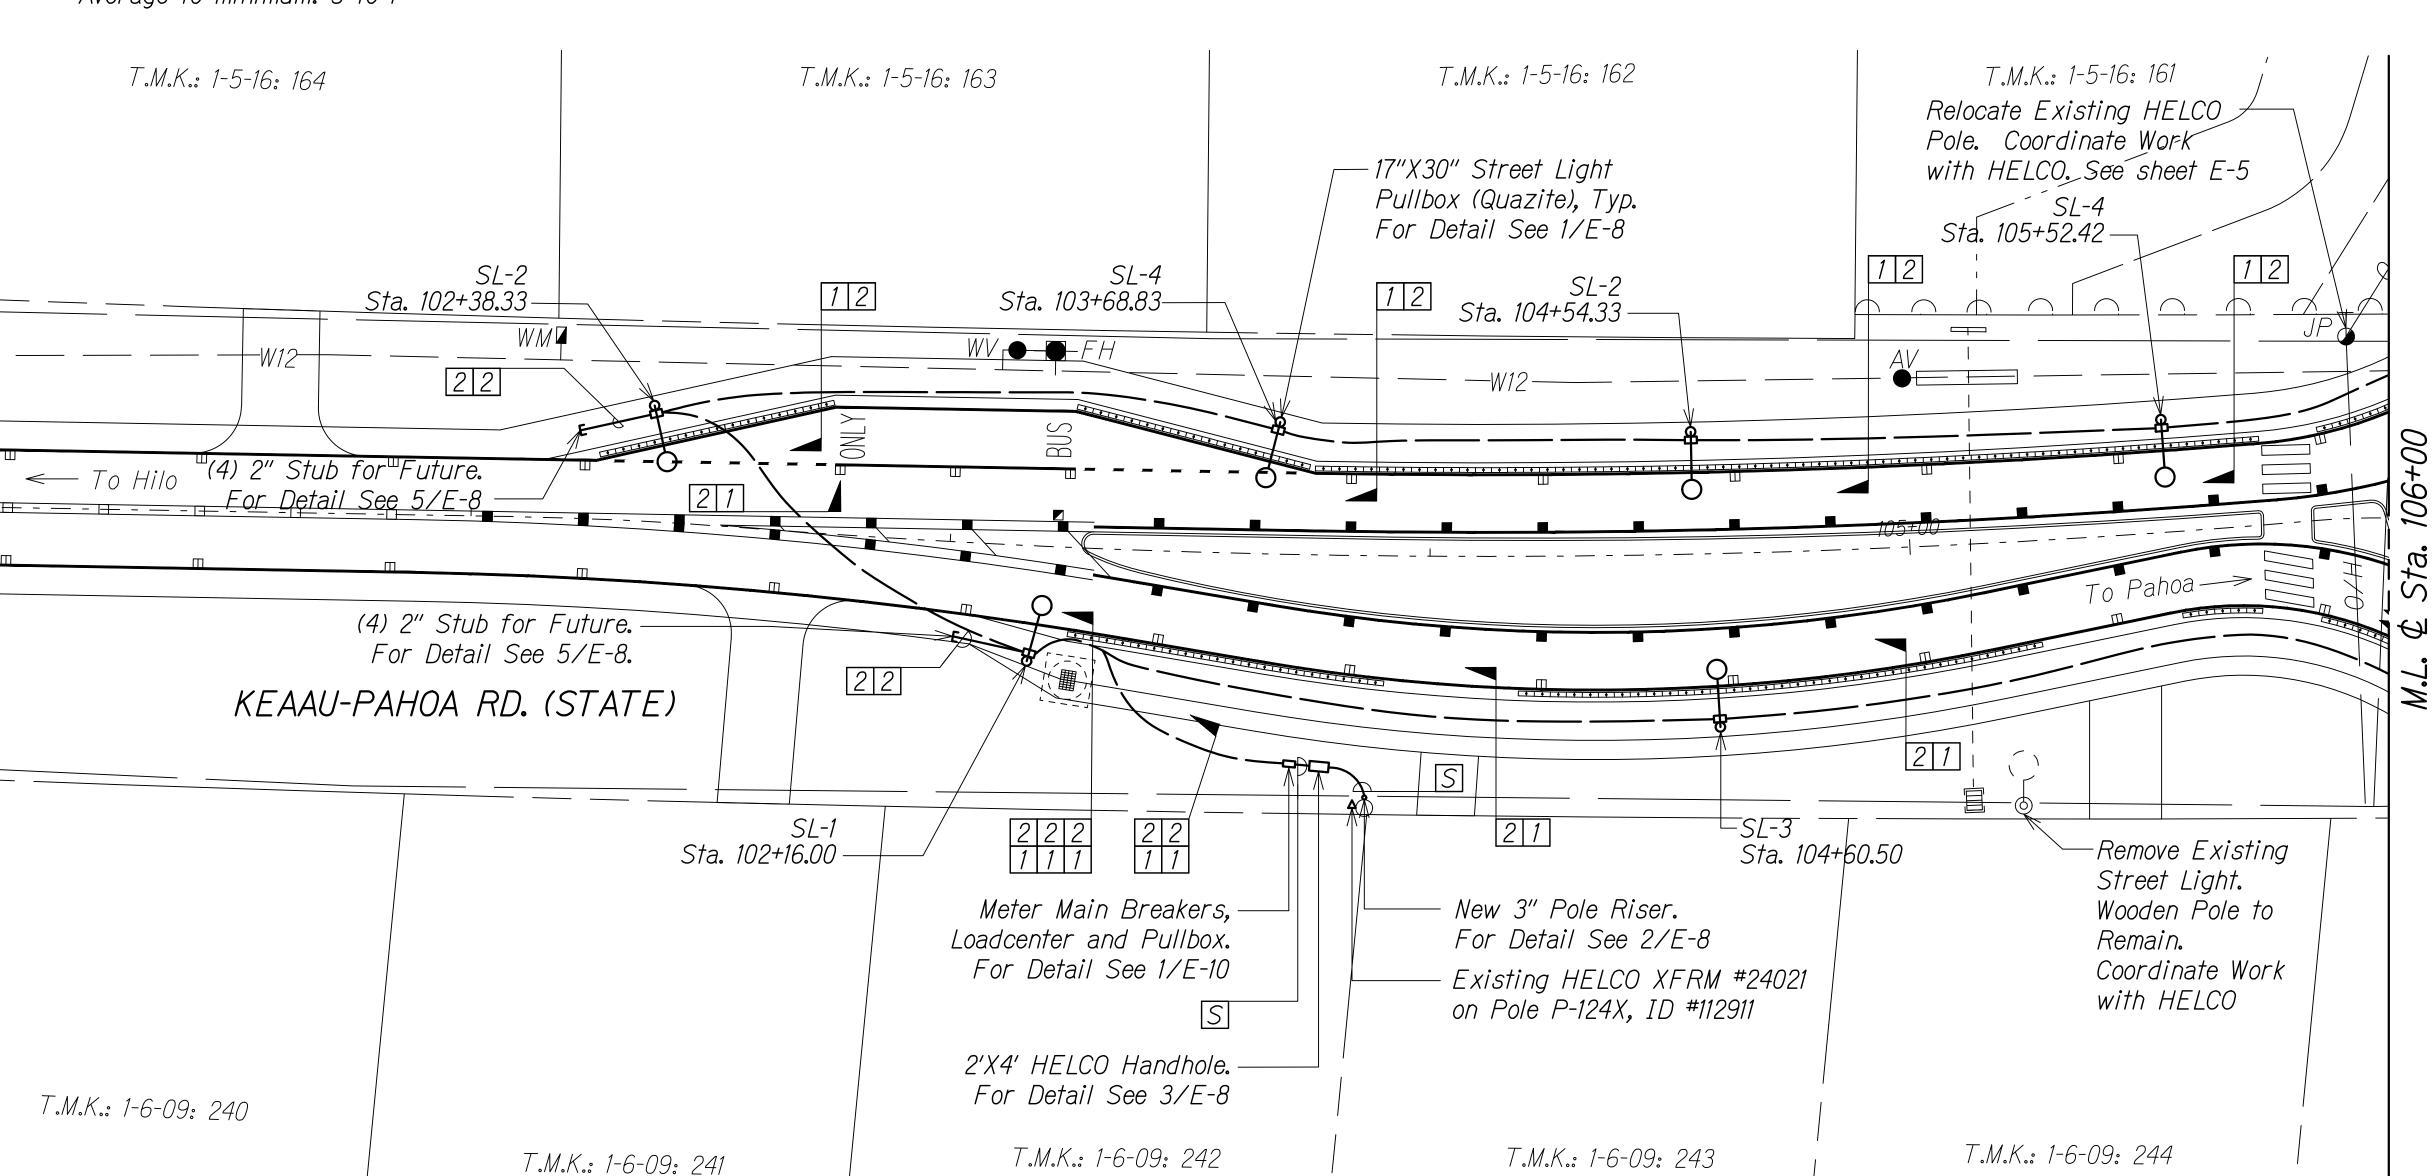



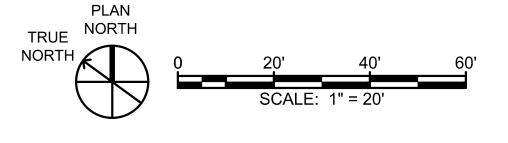

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O4/30/22

SIGNATURE

EXPIRATION DATE

OF THE LICENSE

**PROFESSIONAL** 

DEPARTMENT OF TRANSPORTATION
HIGHWAYS DIVISION

ELECTRICAL PLAN
MAKUU - NEW WORK

KEAAU-PAHOA ROAD

FED. ROAD DIST. NO.

STATE

HAW.

FISCAL YEAR

2021

SHEET TOTAL NO. SHEETS

93

FED.-AID PROJ. NO.

STP-0130(27)


<u>KEAAU-PAHUA RUAD</u>


<u>INTERSECTION IMPROVEMENTS</u>

<u>at Orchidland Drive \$ Makuu Drive</u>

<u>Federal-Aid Project No. STP-0130(27)</u>

As Noted Date: Sept 2020
SHEET No. 4 OF 10 SHEETS

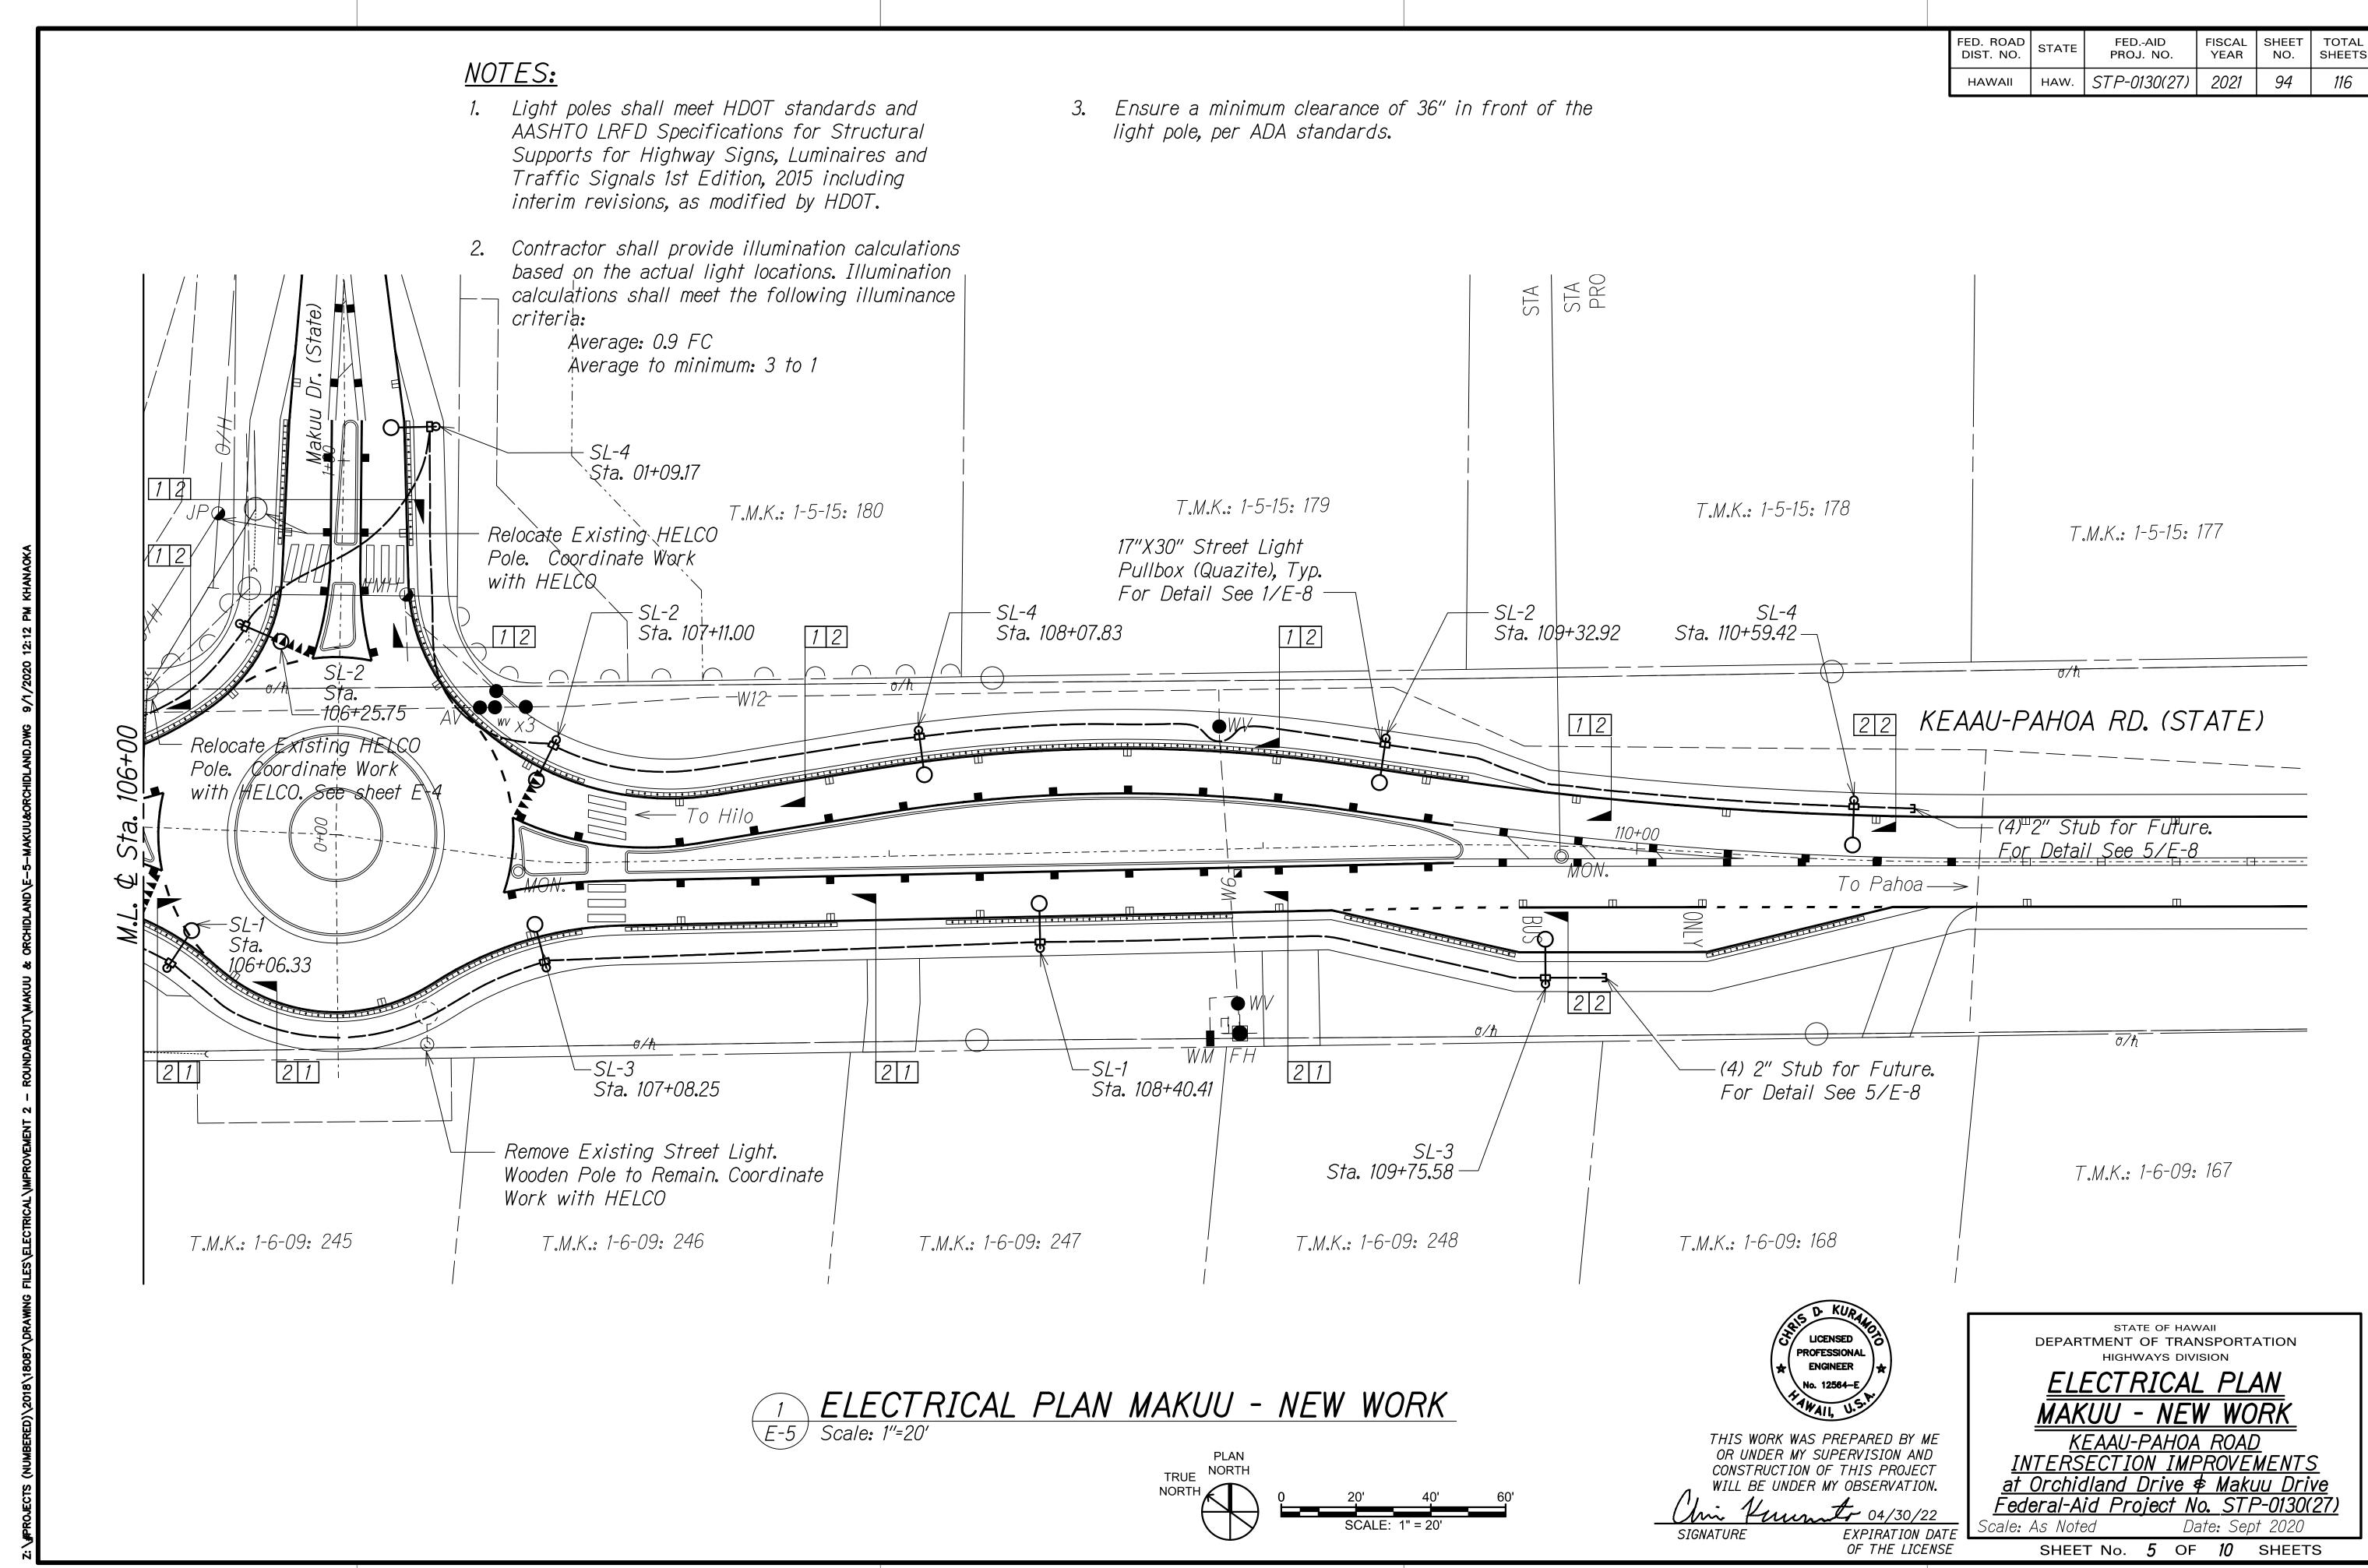

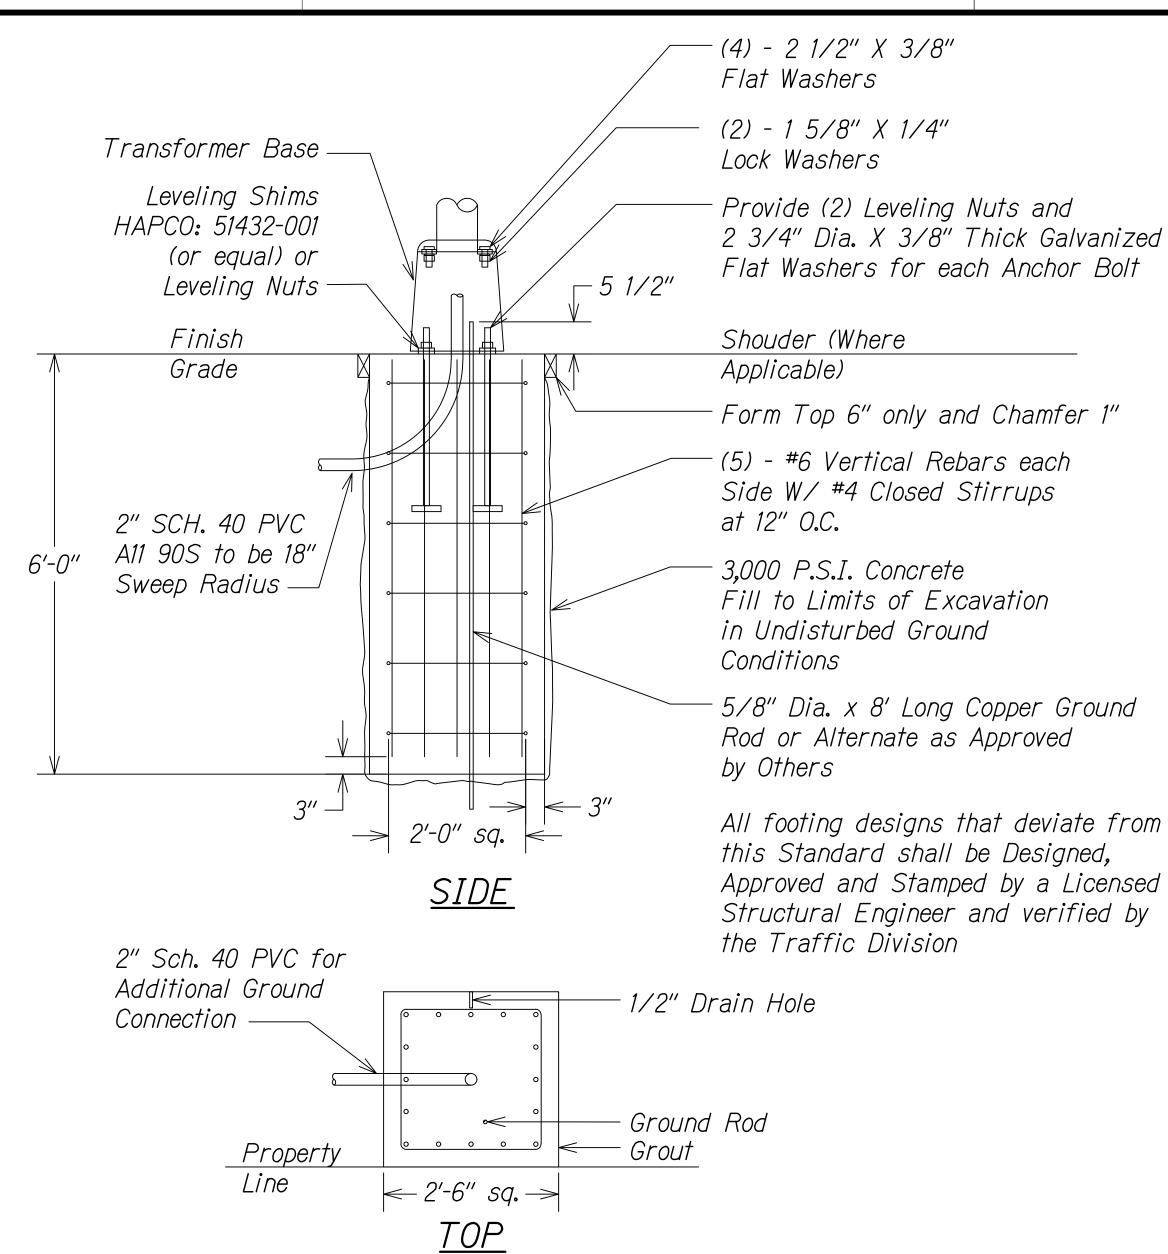

# NOTES:

- If foundations are precast, manufacturer and materials suppliers shall be in compliance with the most current Edition of the Hawaii Standard. Specifications for Road, Bridge and Public Works Construction and where applicable the National Precast Concrete Association.
- 3,000 P.S.I. 28-day compression strength concrete shall be used.
- Each foundation shall not be handled or transported until at least 80% of the 28-day concrete compression strength has been reached.
- Each foundation shall not be installed until the 28-day concrete compression strength has been achieved.
- CLSM or equivalent shall be use to backfill around each foundation (cast-in-place or precast).
- For inspections, contact the Traffic Division at 808-961-8341 and plan for 3-day minimum lead time.

27'-2" Ground Provision: 1'-5" — 1/4"-20NC and 1/2"-13NC Tapped Holes. ←O = E2 Lighting/LED Hawaii 85W LED Luminaire, #E2-H150-ST-85W-7PD-SF

12'-0" Long Tapered Aluminum Tube (3 1/2" O.D.) 0.125" Wall

Alloy 6063-T6 (ASTM B221) 2 3/8" x 4 3/8" Elliptical Section — 2" NPS Slipfitter Pole Cap with S.S. Screws— 30'-0" Mounting Height √ (to Ground Line) 2'-6" Wire Hole with 1" I.D. Rubber Grommet. — Pole Plate Alloy 6063-T6 with 1'-9'' -1/2"-13NC Stainless Steel Hardware - Pole Bonds Alloy 6063-T6 with 1/2"-13NC Stainless Steel Hardware Tapered Aluminum 22'-6" Tube 0.250" Wall Internal Damper (installed) Tapered Alloy 6063-T6 Tapered Aluminum Tube 0.250" Wall Alloy (ASTM B221) Satin 6063-T6 (ASTM B221) Satin Ground Finish Ground Finish. -Galvanized Steel Connecting Hardware.

(4) 1"-8NC x 3 3/4" Long Hex. Heavy Duty Bolts

1"-8NC Hex. Heavy Duty Nuts

1" Lockwashers

1" Flat Washers

1" Heavy Washers (2 3/4" O.D. x 1/2" Thick

Base Flange (81992) (11"-12" B.C., Mounts to Top of T-Base) Alloy 356-T6 (ASTM B108) with Bolt Covers and S.S. Hex. Heavy Duty Screws

Breakaway Transformer Base (70500) Alloy 356-T6 with Door, S.S Hex. Heavy Duty Screw

NOTE:

LED Luminaire: Full Cutoff Electronic Fixture With <2%

- 3 1/2"

3'-0"

Blue Light Content.

**NOTES:** 

FED. ROAD DIST. NO.

STATE

HAW.

NOTES:

1. Font style: Standard Highway.

2. Font size: 3" (height).

3. Machine cut on black adhesive Scotchlite (or equal) sheeting.

4. Affix number to clean surface of pole 3'-0" above finished grade.

5. Street light number to face street.

POLE IDENTIFICATION E-6 / Not to Scale



TYPICAL STREET LIGHT STANDARD

6" Thread

LICENSED **PROFESSIONAL ENGINEER** 

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Vumto 04/30/22

ELECTRICAL STREET LIGHT **DETAIL** 

KEAAU-PAHOA ROAD INTERSECTION IMPROVEMENTS at Orchidland Drive \$ Makuu Drive Federal-Aid Project No. STP-0130(27)

STATE OF HAWAII

DEPARTMENT OF TRANSPORTATION

Date: Sept 2020

SHEET No. 6 OF 10 SHEETS

STREET LIGHT FOUNDATION (E-6) Not to Scale

(E-6) Not to Scale

8" O.D. ->

*15 3/8" Square* → ←

or Approved Equal

(4) 1"-8NC S.S. Anchor Bolts, (86518)

Type 316 Per ASTM A193 Grade B8M

(4) 1" Galvanized Steel Heavy Washers

(2 3/4" O.D. x 1/2" Thick)

Class 1 (30KSI Min Yield).

(8) 1"-8NC S.S. Hex. Nuts

(4) 1" S.S. Lockwashers

(4) 1" S.S. Flatwashers

14" Dia. Anchor Bolt

T-base Mounts Here)

Circle (Bottom of

EXPIRATION DATE OF THE LICENSE

FISCAL SHEET TOTAL YEAR NO. SHEETS

95

2021

FED.-AID PROJ. NO.

STP-0130(27)

approved equal.

approved equal.

plan TE-15.

Pole type: HAPCO part #RTA30D8BFT1\*-GC or

Photoelectric cells: Fisher

Pierce FP-7790B-SPS or


Provide a Type II post

mounted object marker on

each light pole, per standard

#### NOTES:

- All conduit shall be PVC schedule 80 for direct buried and PVC schedule 40 for concrete encasement, unless otherwise noted.
- 2. Backfill over concrete duct sections shall be Type "A" per backfill type notes.
- 3. Backfill over direct buried conduits shall be Type "B" per backfill type notes.
- 4. If the normal material in the bottom of a trench containing a direct burrial conduit is not Type "B" an additional 3" shall be excavated and Type "B" backfill provided.
- 5. Concrete for ducts shall be 3000 P.S.I. in 28 days.
- 6. All conductor sizes shall be copper conductors.

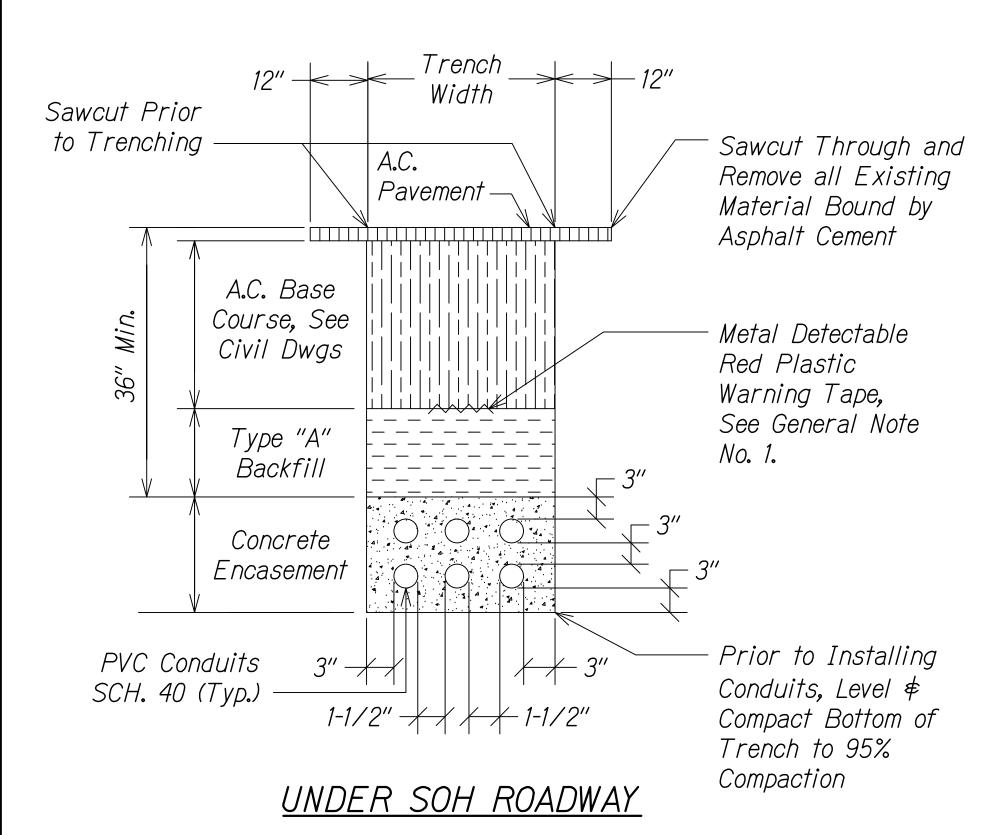

TYPICAL DUCT SECTION (CONCRETE ENCASED DUCTS)


Not to Scale

# BACKFILL TYPES ARE:

Beach Sand, Earth or Earth and Gravel. If Earth and Gravel Used, the Maximum Rock Size Shall be 1" and the Mixture Shall Contain Not More Than 50% By Volume of Rock Particles.


Type "B"

Beach Sand, Earth or Earth and Gravel. If Earth and Gravel Used, Mixture Must Pass a 1/2" Mesh Screen and Contain Not More Than 20% By Volume of Rock Particles.

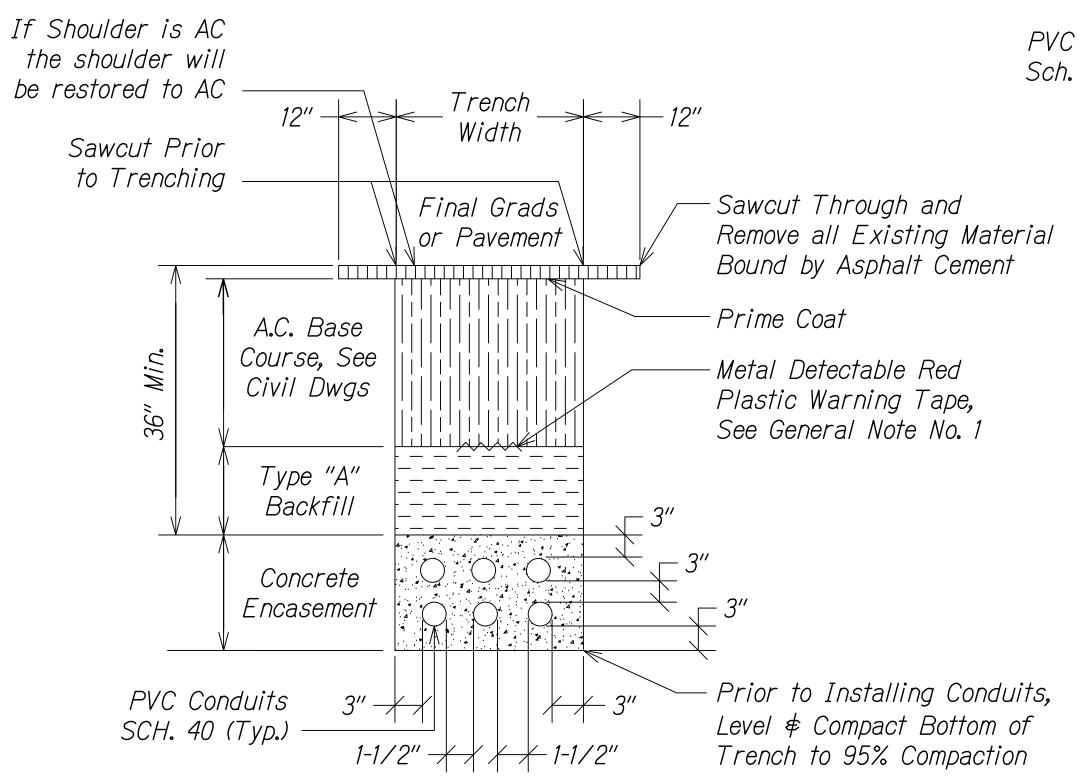

# WITHIN SOH SHOULDER


FED. ROAD DIST. NO. FED.-AID PROJ. NO. FISCAL YEAR SHEET STATE NO. STP-0130(27) 2021 96 HAW.

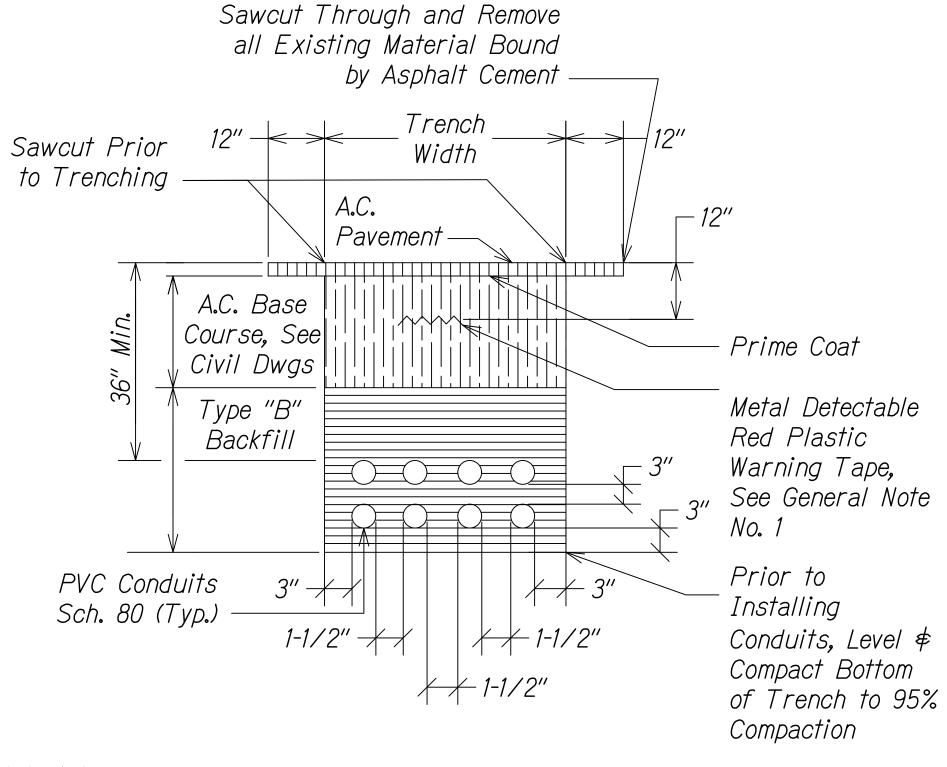

# TYPICAL DUCT SECTION (DIRECT BURIED DUCTS)

**GENERAL NOTE:** 

The metal detectable red plastic warning tape shall be a minimum 5 mils thick and 4" wide with a continuous metallic backing and corrosion resistant 1± mil thick foil core. The message on the tape shall read, "Caution - State Traffic Signal and/or Hwy Lighting Buried Below," utilizing 1-1/2 inches series "C" black lettering. The message will be repeated with a 4-1/4" spacing between top line of message and start of next text.

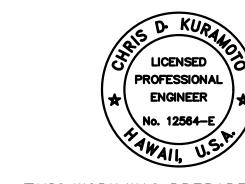

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Furnto 04/30/22 EXPIRATION DATE OF THE LICENSE


**DEPARTMENT OF TRANSPORTATION** ELECTRICAL STREET LIGHT

STATE OF HAWAII

**DETAIL** KEAAU-PAHOA ROAD INTERSECTION IMPROVEMENTS at Orchidland Drive \$ Makuu Drive Federal-Aid Project No. STP-0130(27)

> Date: Sept 2020 SHEET No. 7 OF 10 SHEETS

96

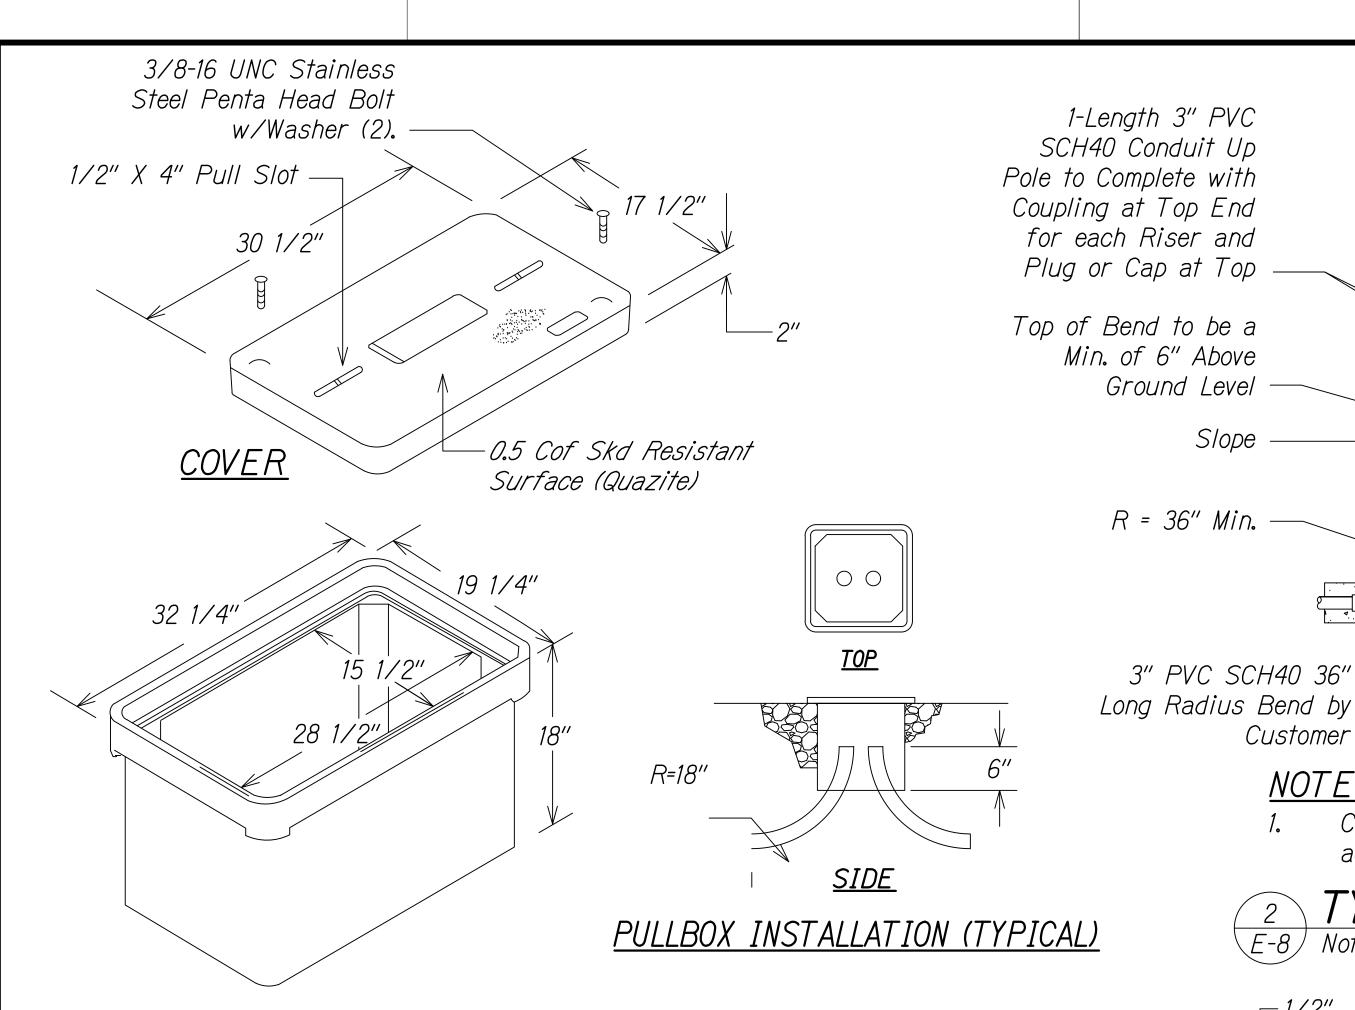

# HEAVY DUTY PULL BOX (OPEN BOTTOM)

# **NOTE:**

Provide 6 inch minimum 3/4" crushed gravel base course, well compacted.

Equivalency Reference: Concrete Box, Part #PG1730BA18

#### NOTES:

- All conduits shall enter vertically at the bottom of the pullboxes.
- All dimensions and lines are approximate.
- Field-adjust pullbox locations and conduit clearances as required.
- 4. Conduit 90 degree bend radii shall be a minimum of 18".
- 5. Pullbox covers shall be labeled "Traffic Signals" or "Street lights" as appropriate.
- Pullbox covers shall use penta head bolts.
- Install one ground rod in each pullbox.
- All pullboxes shall be quazite with tier 22 rating.
- For more information, contact Traffic Division at 808-961-8341.

17" x 30" x 18"D STREETLIGHT PULLBOX E-8 Not to Scale

Quazite Precast Polymer

# **NOTES:**

1/2"

2 1/2"

Slope

Customer -


*NOTE:* 

Not to Scale

*– 5/8′* 

- Use 3-ply laminated flexible plastic, Black-White-Black. Thickness: 0.010"-Black Cap Sheet 0.052"-White Base Sheet. 0.010"-Black Base Sheet.
- 2. Attach to meter socket using scotch 3M brand very high bond (VHB) double coated acrylic foam tape or equivalent.
- 3. Letters/numbers shall be 1/16" stroke, (white in color).
- Letters/numbers area inscribed by cutting through "Black Cap Sheet" to expose white letters/numbers.

METER I.D. TAG E-8 Not to Scale

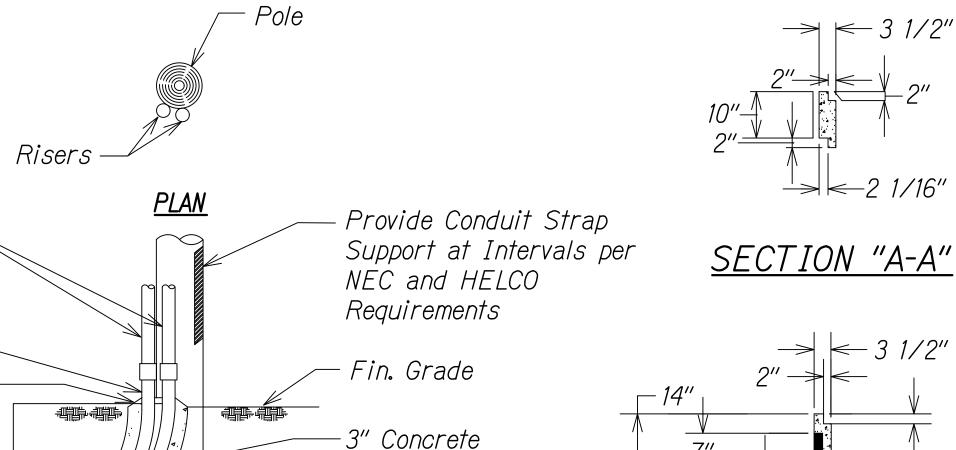

Encasement


Pole


**ELEVATION** 

Coordinate and provide riser detail in

accordance with HELCO requirements.

TYPICAL RISER DETAIL

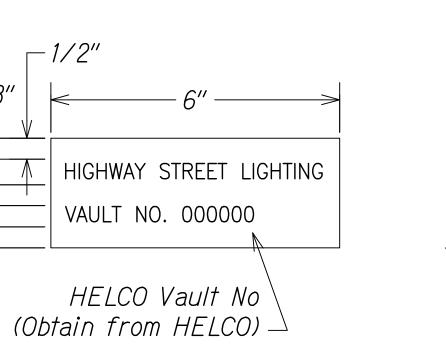

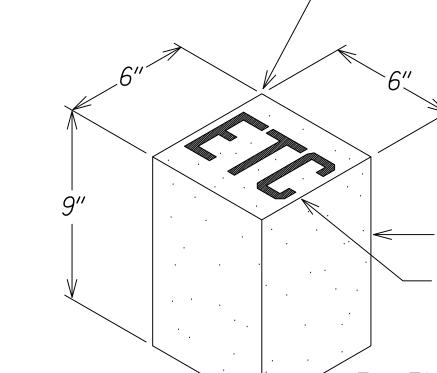



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OF THE LICENSE

Kumtr 04/30/22 EXPIRATION DATE

ELECTRICAL STREET LIGHT

**DETAIL** KEAAU-PAHOA ROAD INTERSECTION IMPROVEMENTS at Orchidland Drive \$ Makuu Drive

<u>Federal-Aid Project No. STP-0130(27)</u> Date: Sept 2020 SHEET No. 8 OF 10 SHEETS

WT.=483 LBS SECTION "B-B" **NOTE:** Coordinate and provide pullbox detail in accordance with HELCO requirements. 2' x 4' ELECTRIC PULLBOX ASSEMBLY E-8 Not to Scale Finish Grade 1/4" Above Finish Grade Relative Location of Concrete Marker Concrete Jacket Conduit - Cement Duct Plug ■ ■ - Concrete Coupling - 2" High Letters Engraved in Duct Marker Cement Duct E = Electric Plug T = Telephone Tapered Plug C = Communications CONCRETE MARKER STUB-OUT DETAIL STUB OUT CONCRETE MARKER DETAIL E-8 Not to Scale STATE OF HAWAII **DEPARTMENT OF TRANSPORTATION** 

FED. ROAD DIST. NO.

HAWAII

WT.=483 LBS

STATE

HAW.

FED.-AID PROJ. NO.

STP-0130(27)


FISCAL YEAR

2021

SHEET NO.

97

97

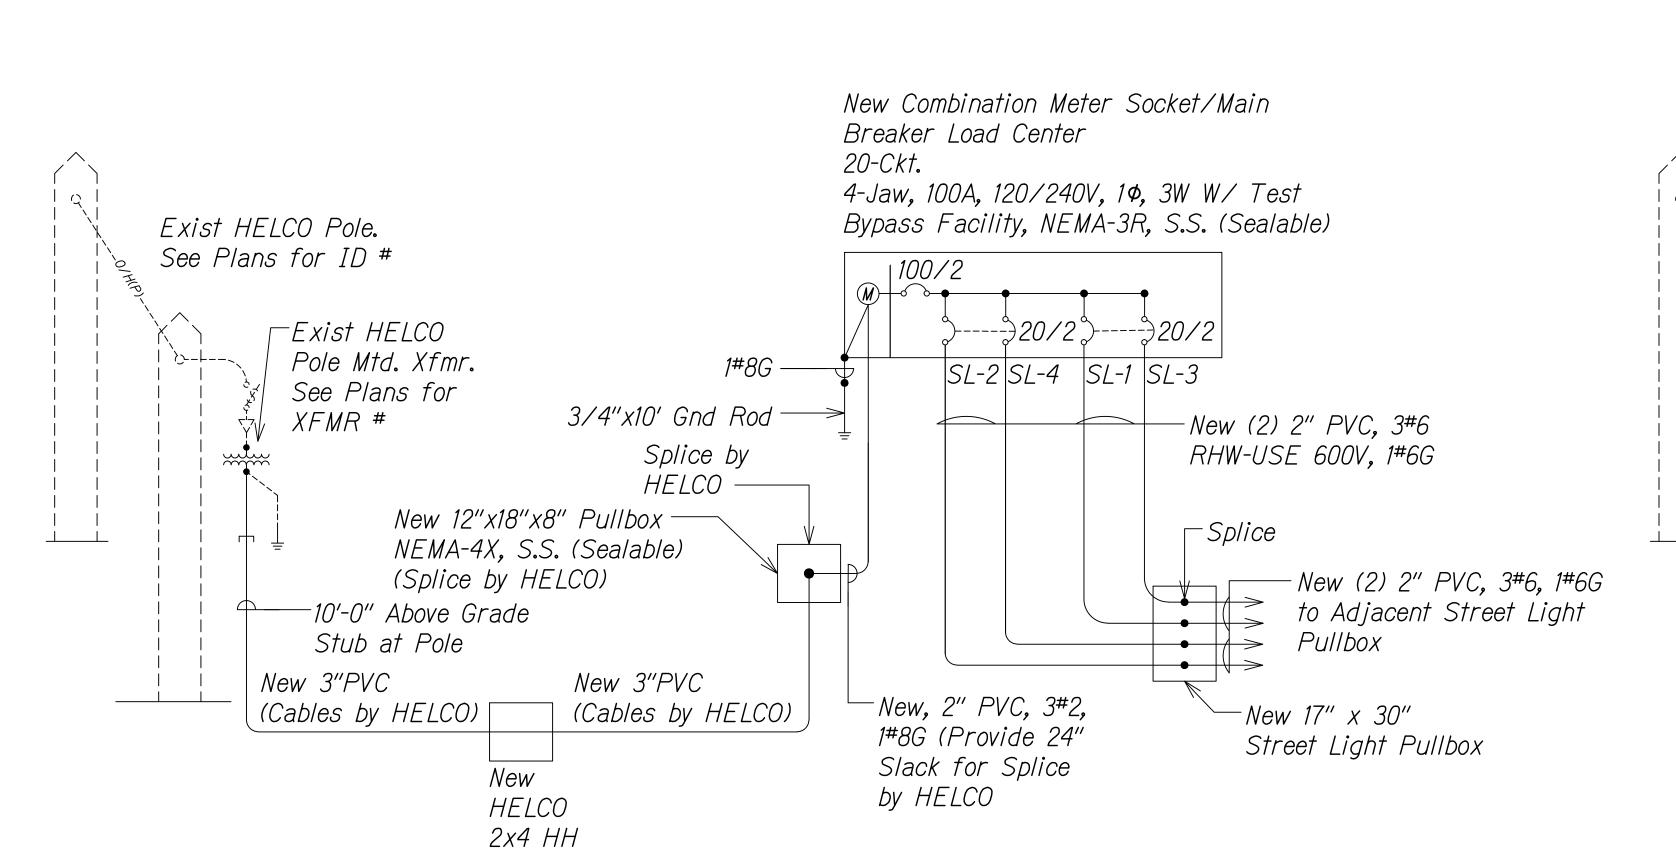


1. Phase work to maintain existing traffic signals and street lights in operation as required.


2. All new conductors shall be copper.

NOTES:


# MAKUU AND ORCHIDLAND ONE-LINE DIAGRAM Not to Scale

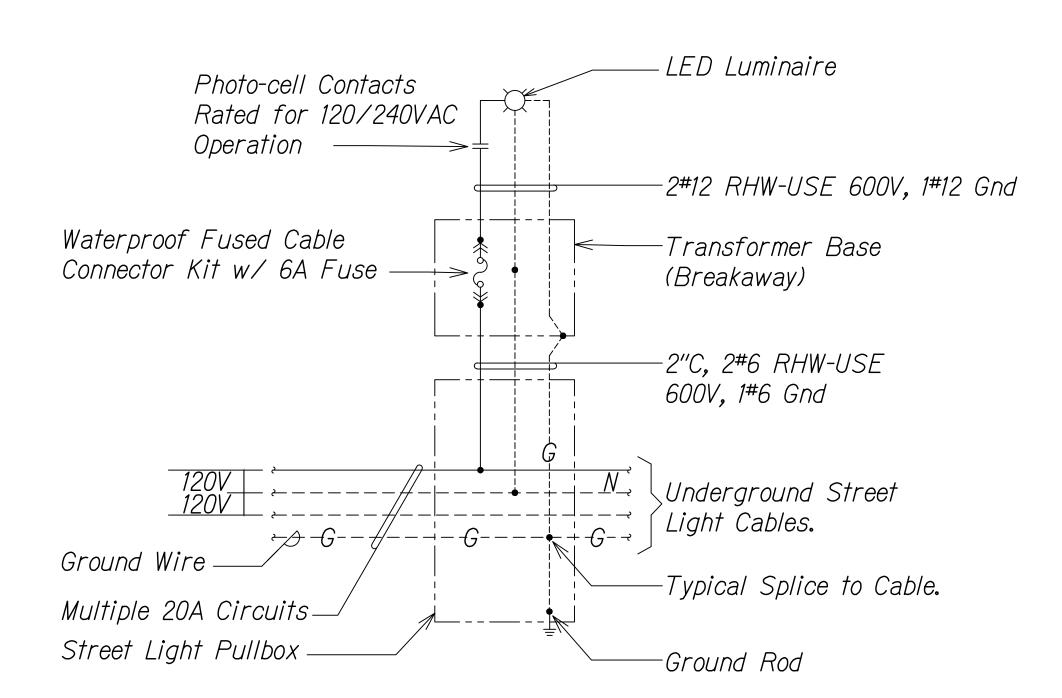



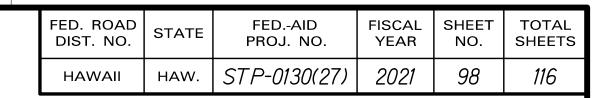


New Combination Meter Socket/Main

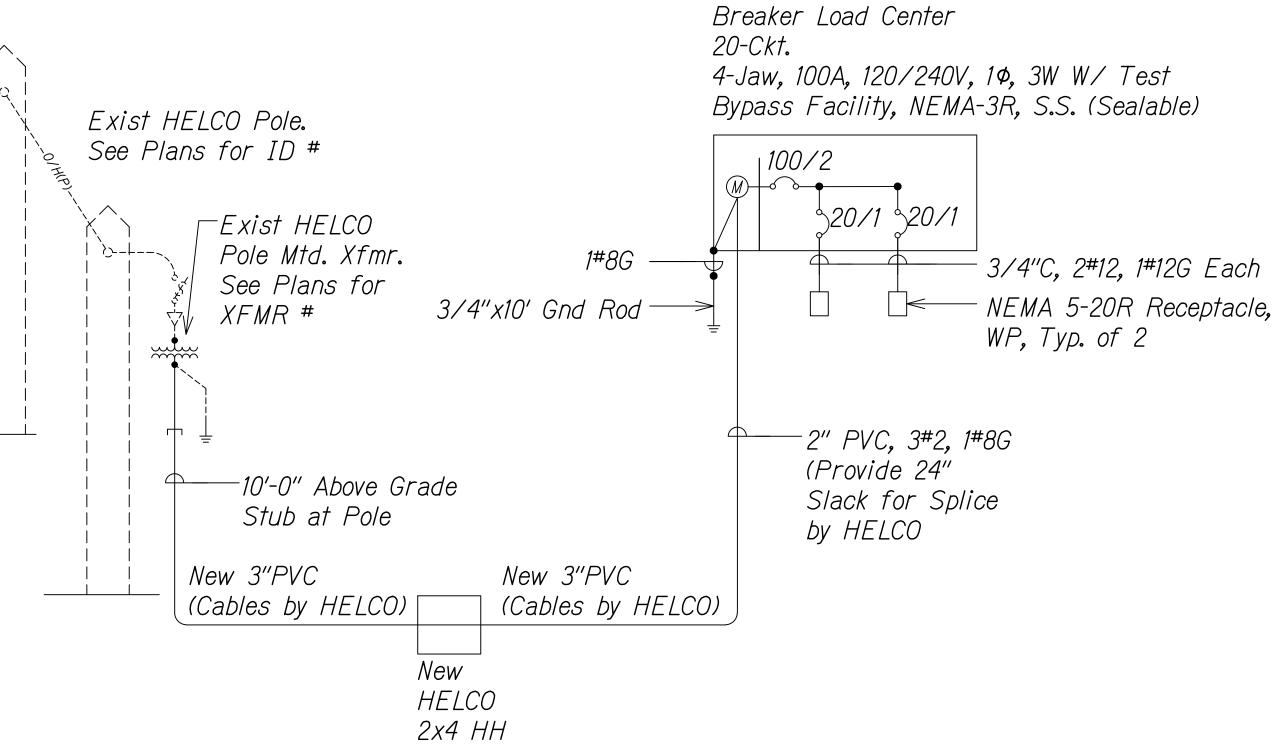

# NOTES:

- 1. Phase work to maintain existing traffic signals and street lights in operation as required.
- 2. All new conductors shall be copper.



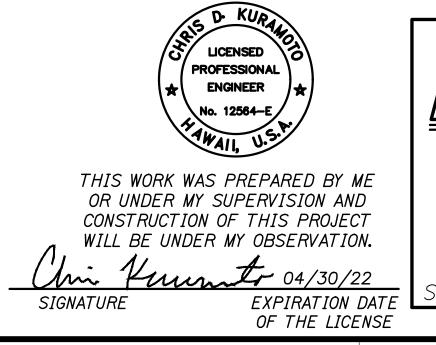

DEPARTMENT OF TRANSPORTATION
HIGHWAYS DIVISION

ELECTRICAL STREET LIGHT

<u>DETAIL</u>


<u>KEAAU-PAHOA ROAD</u>

INTERSECTION IMPROVEMENTS
at Orchidland Drive & Makuu Drive
Federal-Aid Project No. STP-0130(27)


SHEET No. 9 OF 10 SHEETS

Date: Sept 2020

SHEET TOTAL NO. SHEETS FED. ROAD DIST. NO. FISCAL YEAR FED.-AID PROJ. NO. STATE STP-0130(27) 2021 99

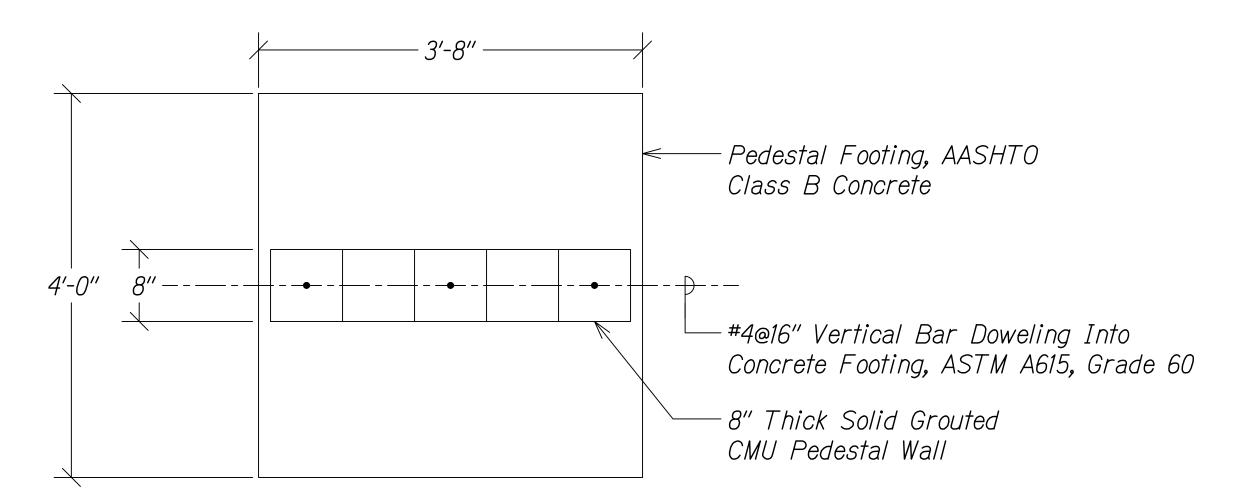


# SECTION A-A

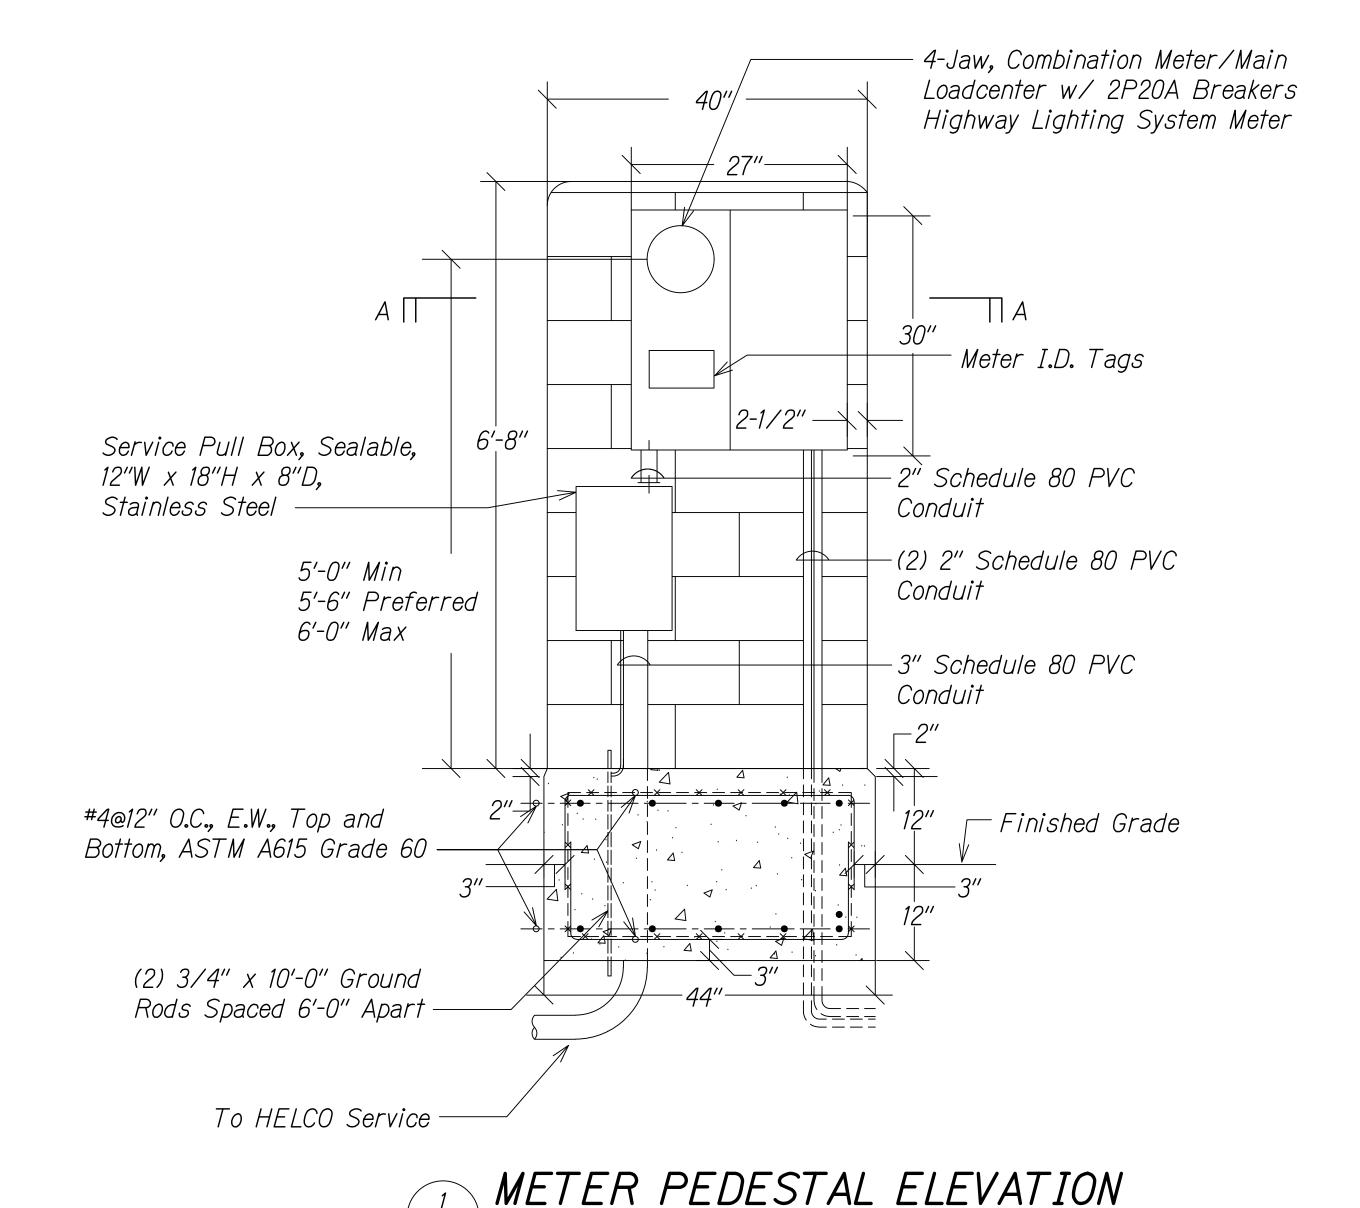

E-10 Not to Scale

# NOTES:

- Contractor shall verify all conduit requirements prior to installation.
- Confirm location of conduits with actual cabinets.
- Concrete encased electrode (underground), per Section 250-50(C) of the National Electrical Code.
- Controller cabinet shall be located so that personnel facing the front door of the controller cabinet have a clear view of the intersection.
- Anchor bolts (size and quantity) shall be per the cabinet manufacturers recommendations.

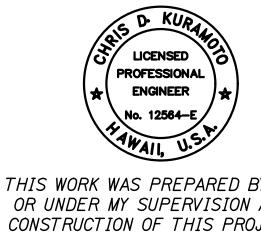

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Humto 04/30/22 EXPIRATION DATE OF THE LICENSE

STATE OF HAWAII DEPARTMENT OF TRANSPORTATION

ELECTRICAL STREET LIGHT <u>DETAIL</u>

KEAAU-PAHOA ROAD INTERSECTION IMPROVEMENTS <u>at Orchidland Drive 🛊 Makuu Drive</u> Federal-Aid Project No. STP-0130(27)

Date: Sept 2020

SHEET No. 10 OF 10 SHEETS