FED. ROAD DIST. NO.	STATE	FED. AID PROJ. NO.	FISCAL YEAR	SHEET NO.	TOTAL SHEETS
HAWAII	HAW.	STP-0130(28)PH.1	2012	264	288


General Construction Notes:

- 1. Applicable Construction Work Shall Be Done in Accordance With the Standard Details for Public Works Construction of the Department of Public Works, City and County of Hilo.
- 2. It Is Not the Intent of These Plans and Specifications to Imply that All Existing Utilities Are Shown on the Plans. Only Those Underground Pipes, Cables, Ductlines, Etc. Known to Exist by the Engineer from His Search of Records at the Time of Design Are Indicated on the Plans. The Contractor Shall Arrange with the Respective Utility Companies to Tone and Mark the Location and Depth of the Existing Facilities.
- 3. The Contractor Shall Exercise Proper Care when Excavating in Areas with Existing Underground Facilities. The Contractor Shall be Responsible to Repair and/or Pay Any Damages to the Existing Facilities. Damages to Existing Facilities Shall Be Reported Immediately to The Utility Company Concerned.
- 4. No Contractor Shall Perform Any Trenching Operation so as to Cause Falling Rocks, Soil or Debris in Any Form to Fall, Slide or Flow onto Adjoining Properties, Streets or Natural Watercourses. Should Such Violations Occur, the Costs Incurred for Any Remedial Action by the Chief Engineer Shall Be Payable by the Contractor.
- 5. The Contractor Shall Keep All Bikeways, Walkways, Driveways, Parking Lots and Roadways Open for Pedestrian and/or Vehicular Traffic. Safety Barriers and Appropriate Warning Signs and Devices Shall Be Provided at All Times for the Safety of Pedestrians and/or Vehicles.
- 6. The Contractor Shall, at His Own Expense, Keep the Project Area and the Surrounding Area Free from Dust Nuisances. The Work Shall Be in Conformance with the Air Pollution Control Standards and Regulations of the Department of Health, State of Hawaii.
- 7. The Contractor Shall Be Responsible for Conformity with the Applicable Provisions of Chapter 54, Water Quality Standards and Chapter 55, Water Pollution Control, of Title 11, Administrative Rules of the State Department of Health.
- 8. Excavated Material Shall Be Hauled and Disposed by the Contractor.
- 9. Open Trenches Shall Be Prohibited During Non-Working Hours.

- 10. The Contractor Shall Be Responsible to Investigate, Probe, Tone, Expose, Locate and Protect the Existing Underground Utilities Affected by This Project.
 Contractor Shall Be Required to Adjust the Installation of the New Light Poles to Clear Existing Underground Systems at No Additional Cost to the State.
 Contractor Shall Be Required to Repair All Damages to the Existing Systems Caused by His Negligence at No Additional Cost to the State. All Repair Work Shall Be Done in Accordance with the Standards of the Department of Design and Construction and the Various Utility Companies.
- 11. The Contractor Shall Be Required to Restore the Existing Grass Areas Damaged to Construction.
 Topsoiling and Grassing Shall Be in Accordance with DPR Standard Specifications for Landscaping.
- 12. The Contractor Shall Visit Site, Verify All Existing Dimensions, As Built Conditions, Structures, Site Improvements, Etc. Prior to Bidding.
- 13. The Contractor Shall Coordinate His Operations with Those of Other Contractors Who May Be Employed on Adjacent or Related Projects of the City and Avoid Unnecessary Delay or Hindrance in the Performance of Their Respective Contracts.
- 14. The Contractor Is to Protect Existing Landscape
 Structures. All Damages Shall Be Repaired/Replaced
 to the Satisfaction of the Officer—In—Charge at No
 Additional Cost to the State.
- 15. The Contractor Shall Provide for Provision to the Officer—In—Charge to Revise Location of Light Poles, Fixtures & Ductlines ± 10'. The Contractor Shall Re—Layout and Adjust at No Additional Cost to the State.
- 16. Trim Tree Branches as Required for Installation of Street Lighting Standard Assembly.
- 17. The Contractor Shall Provide Additional Wiring as Required to Maintain Operational Existing Pole Lights, Traffic Signal Lights, Etc. Indicated To Remain.

	Electrical Symbols							
Exst	Exst New Description							
o====o	•	Description Street Light Standard on Utility Pole						
	٥	HELCO Meter						
		Street Light Pullbox, SLD-1 Type						
≈UP	° UP	Utility Pole						
<u> — 0/н —</u>	<u> — o/H — </u>	Over Head Line						
	1							

TRIM

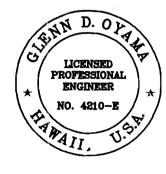

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Men D Cyan APRIL 30, 2014
NAKAMURA, OYAMA & ASSOC. LIC. EXP. DATE

DEPARTMENT OF TRANSPORTATION
HIGHWAYS DIVISION

GENERAL CONSTRUCTION NOTES

ELECTRICAL SYMBOLS

KEAAU-PAHOA ROAD, SHOULDER


LANE CONVERSION, PHASE 1


Keaau Bypass Road to Shower Drive

Fed. Aid Proj. No. STP-0130(28), Phase 1
Scale: Not To Scale Date: June 2012

SHEET No. E-1 OF 25 SHEETS


ET No. E-I OF 25 SI

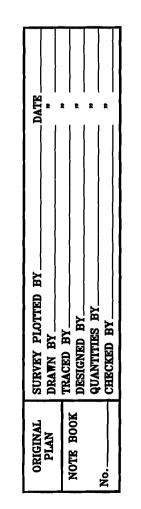

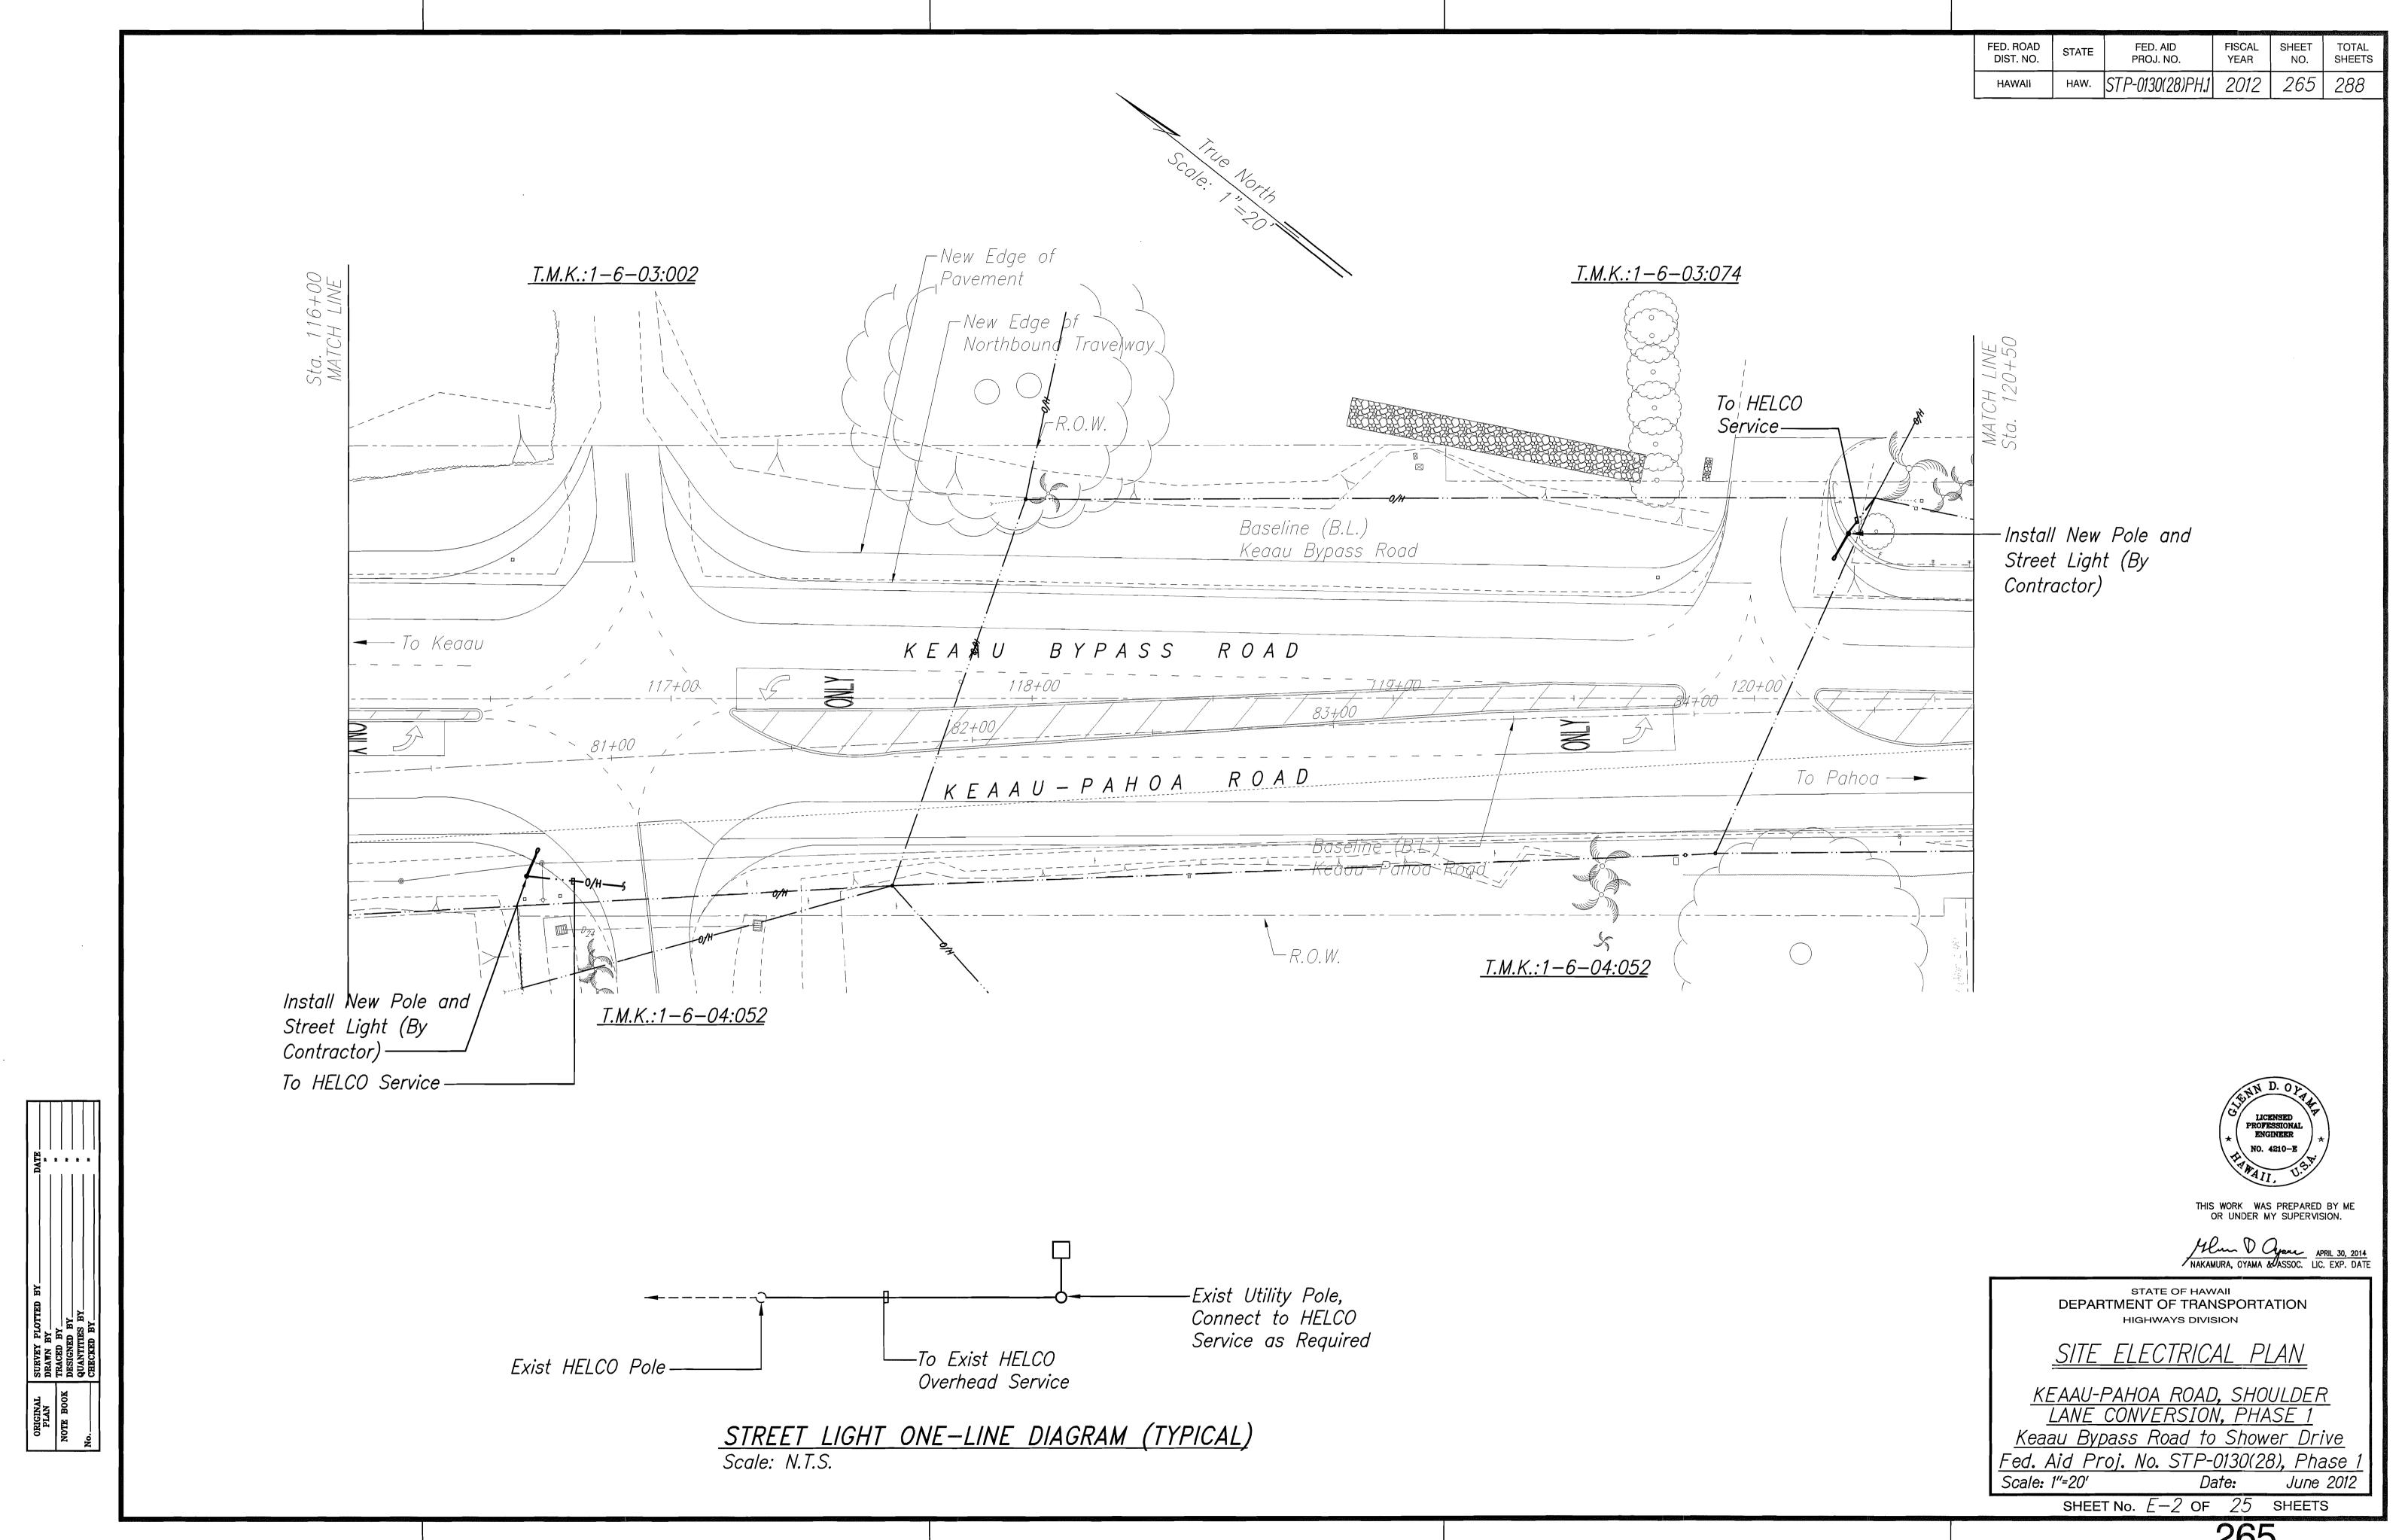

FED. ROAD DIST. NO. STATE FED. AID PROJ. NO. FISCAL SHEET NO. SHEETS

HAWAII HAW. STP-0130(28)PH.1 2012 266 288

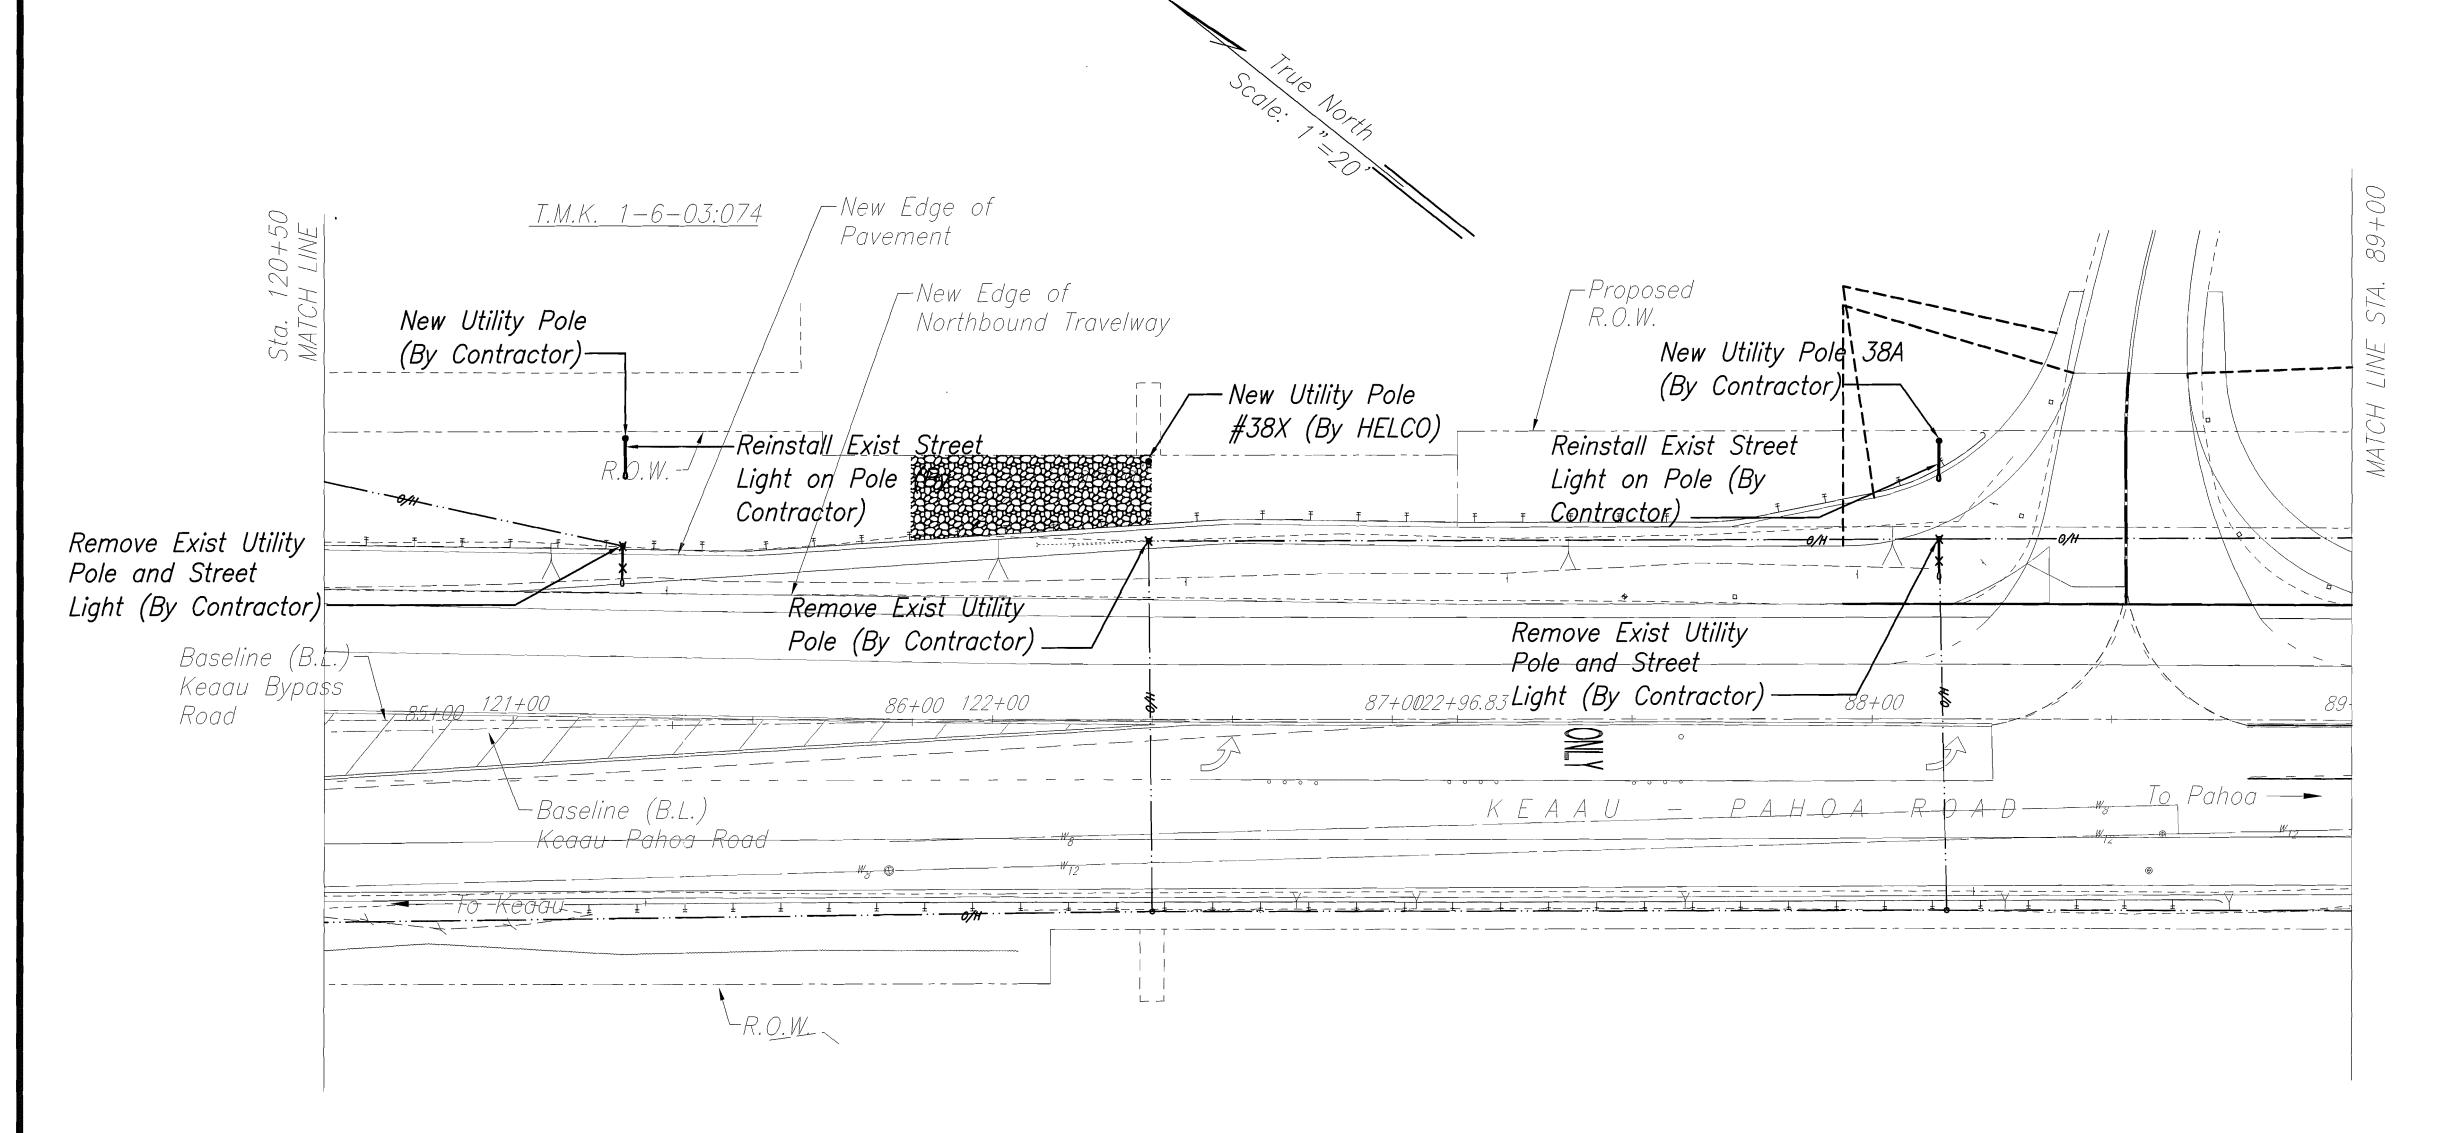

<u>Note:</u> All Utility Poles to be Relocated Within 1' (Preferable) But Not More Than 5' From New ROW. Verify Location With Civil Engineers.



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STATE OF HAWAII
DEPARTMENT OF TRANSPORTATION
HIGHWAYS DIVISION

SITE ELECTRICAL PLAN

KEAAU-PAHOA ROAD, SHOULDER

LANE CONVERSION, PHASE 1

Keaau Bypass Road to Shower Drive


Fed. Aid Proj. No. STP-0130(28), Phase 1


Scale: 1"=20' Date: June 2012


SHEET No. E-3 OF 25 SHEETS

ORIGINAL PLAN NOTE BOOK

	FED. ROAD DIST. NO.	STATE	FED. AID PROJ. NO.	FISCAL YEAR	SHEET NO.	TOTAL SHEETS
,	HAWAII	HAW.	STP-0130(28)PH.1	2012	267	288

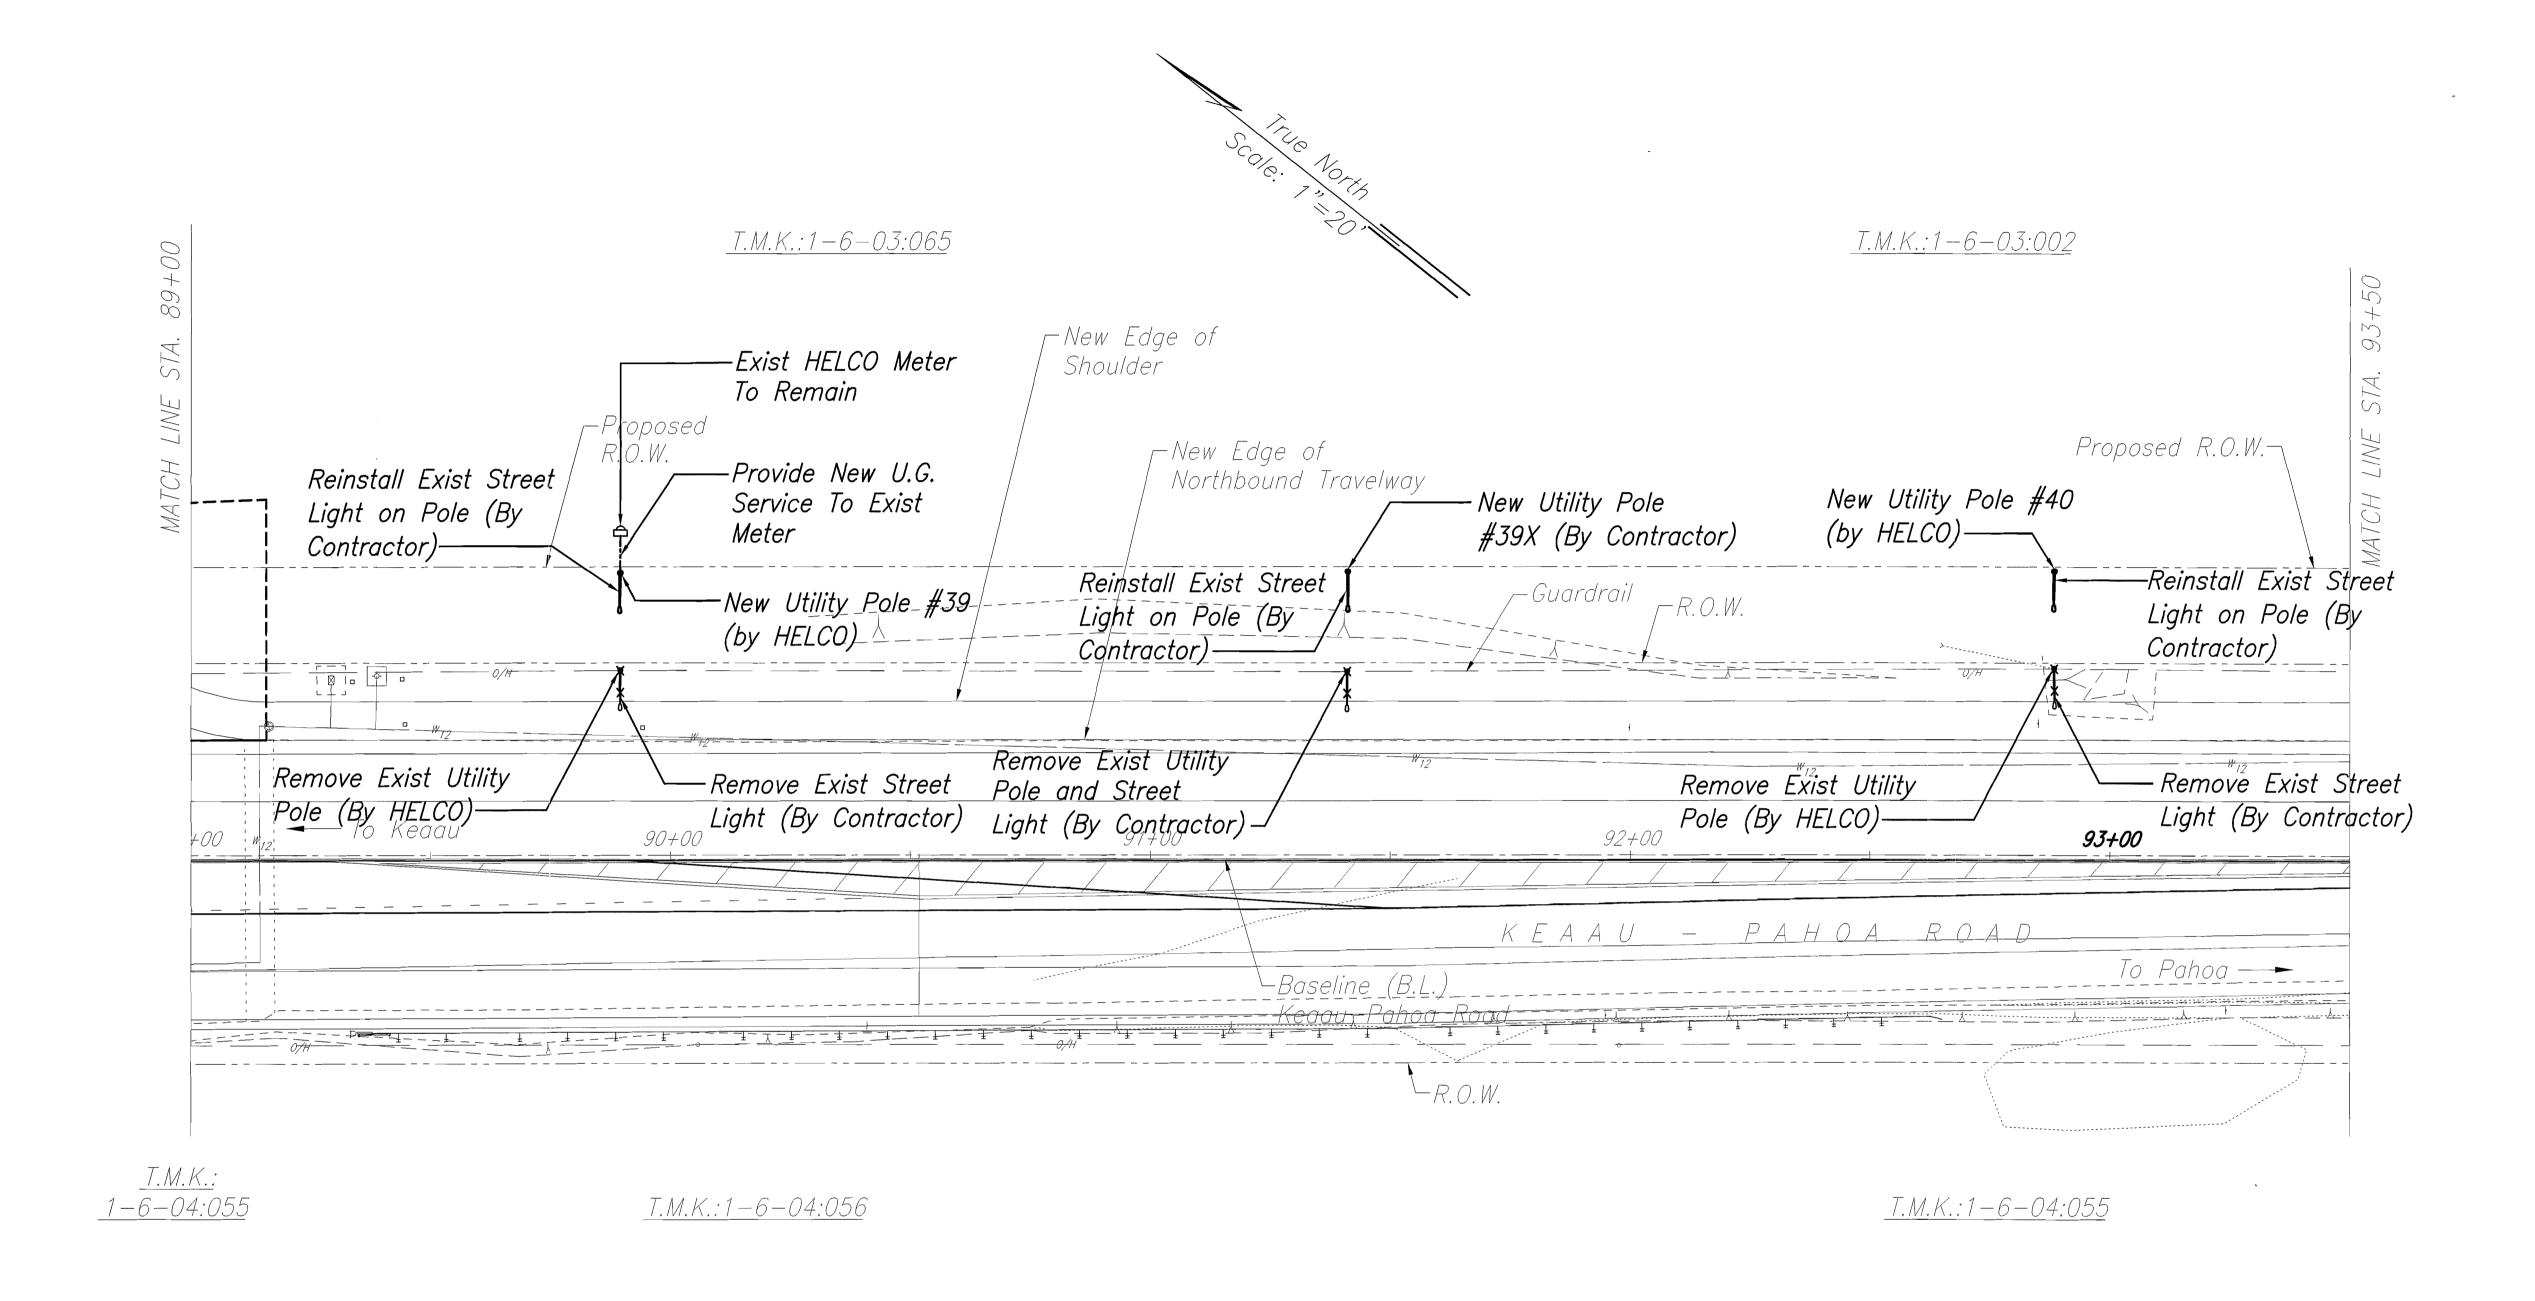

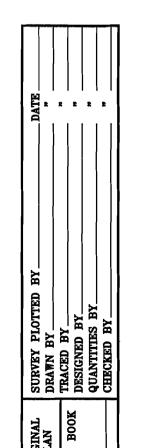

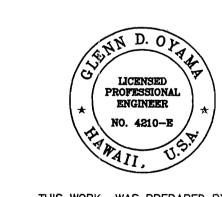

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NAKAMURA, OYAMA & ASSOC. LIC. EXP. DATE

STATE OF HAWAII
DEPARTMENT OF TRANSPORTATION
HIGHWAYS DIVISION

SITE ELECTRICAL PLAN

KEAAU-PAHOA ROAD, SHOULDER


LANE CONVERSION, PHASE 1

Keaau Bypass Road to Shower Drive

Fed. Aid Proj. No. STP-0130(28), Phase 1

Scale: 1"=20' Date: June 2012

SHEET No. E-4 OF 25 SHEETS

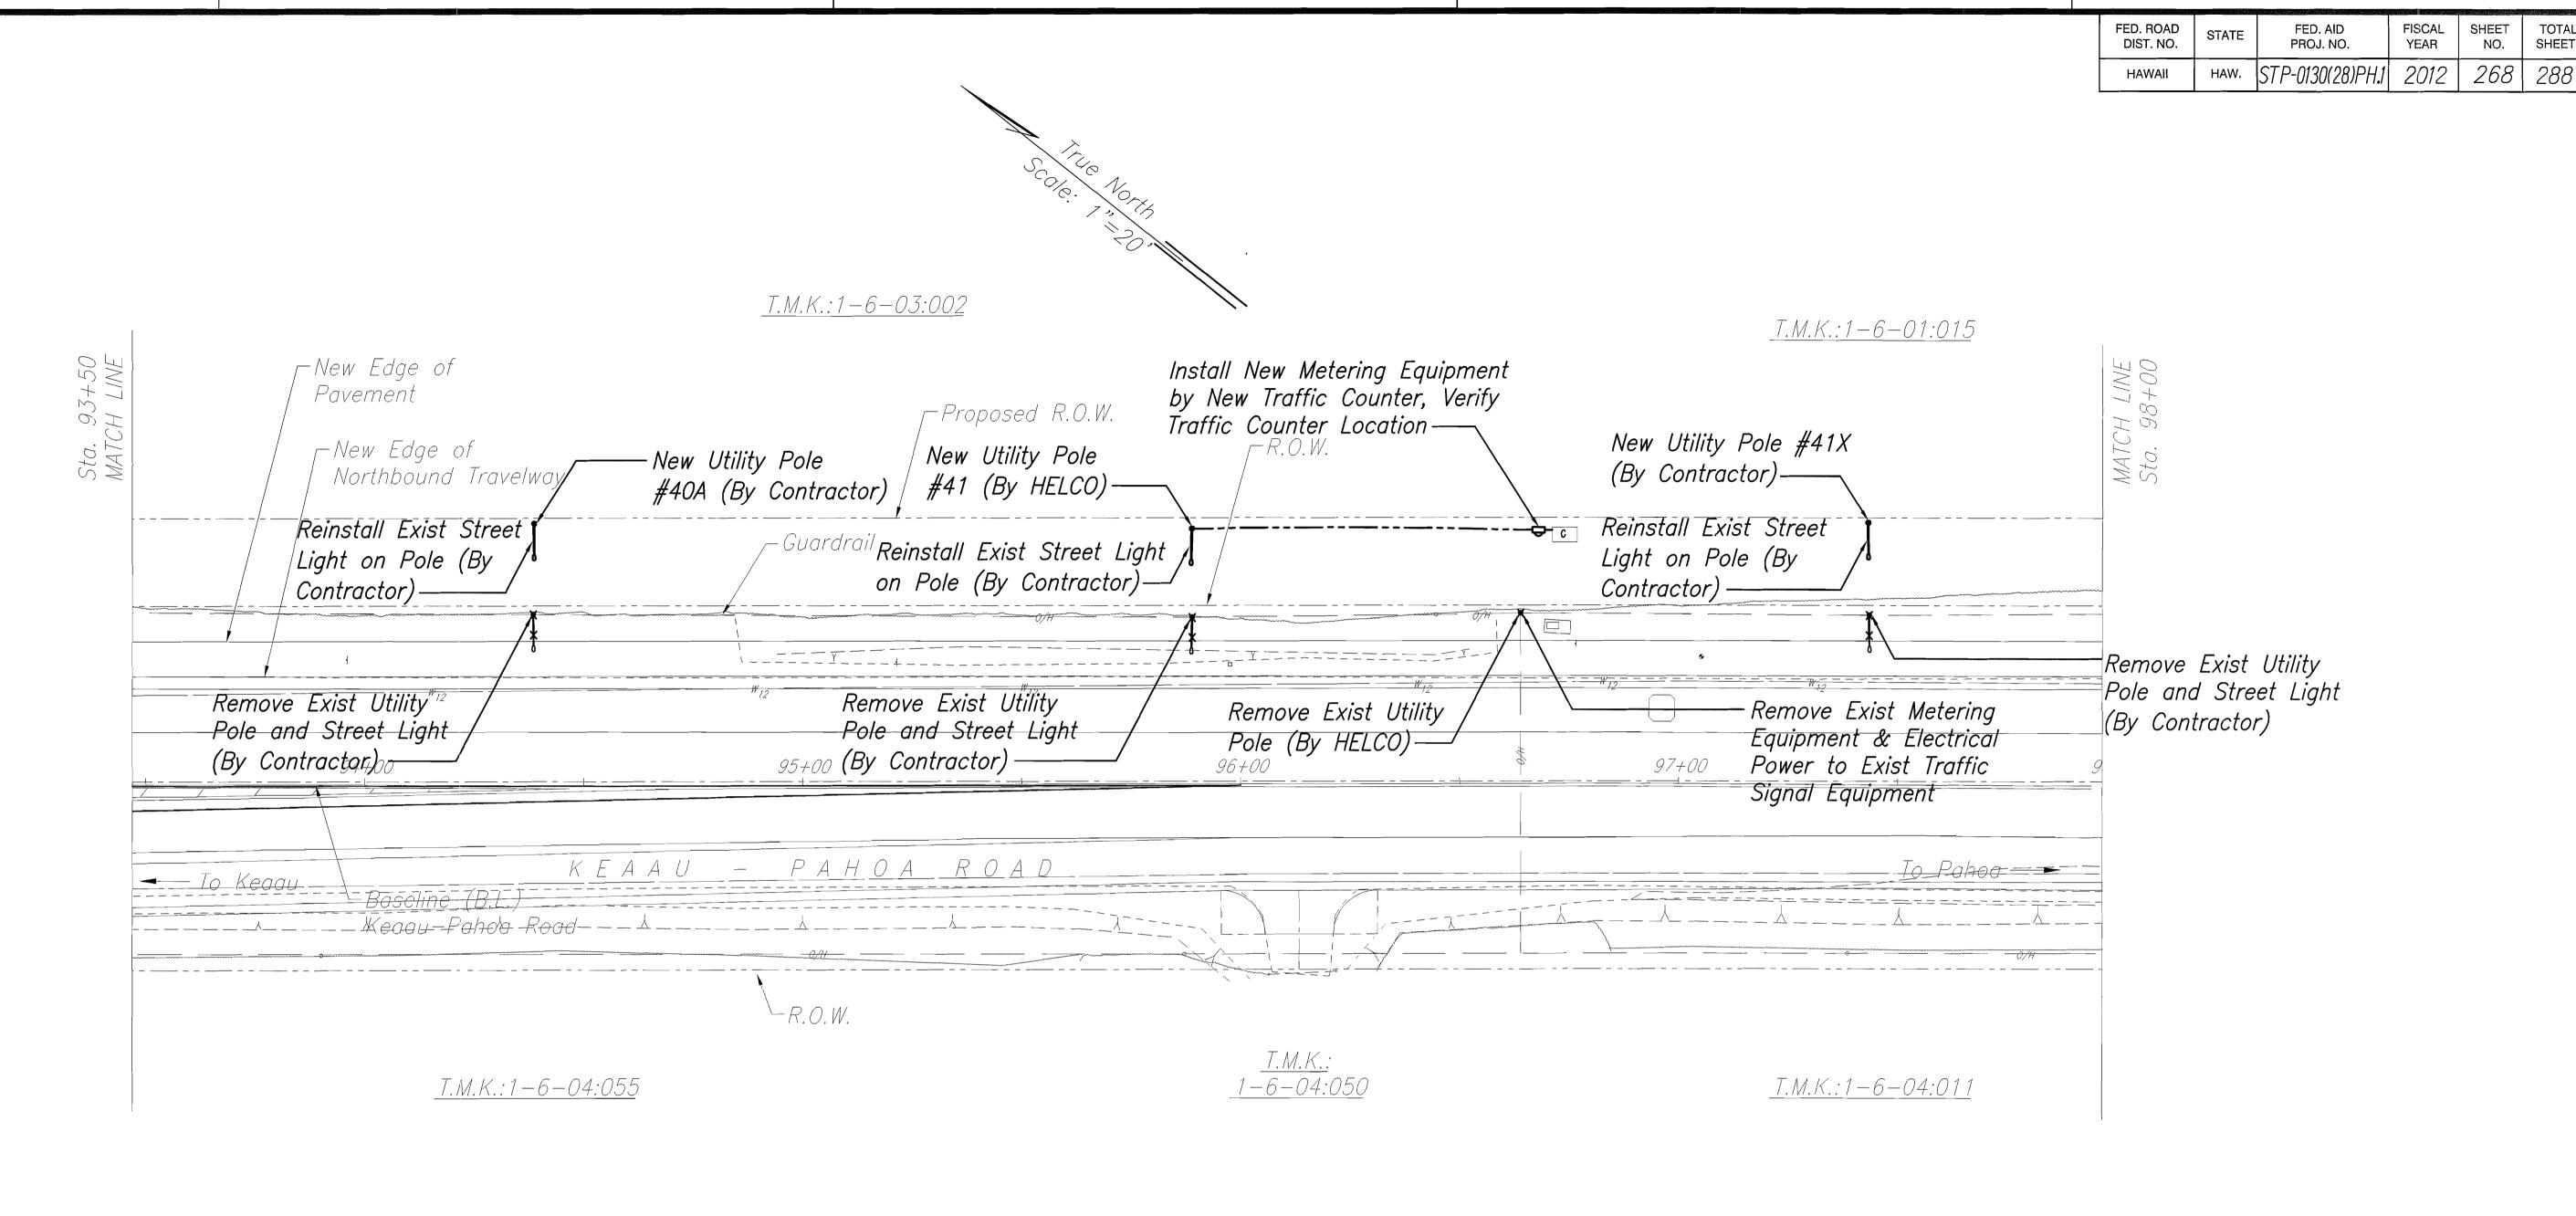

Service Data:


5. Type: Underground.

3. Service Conductors: 3#6, 1#8 G.

Service Voltage: 120/240V, 1 Phase, 3 w.
 Load Data: Connected: 5 KVA Estimated Deman: 2 KVA


4. Metering: HELCO Meter Std. B-5; Rate Schedule: "G".

6. Billing Information: State of Hawaii, DOT. HWY. DIV.

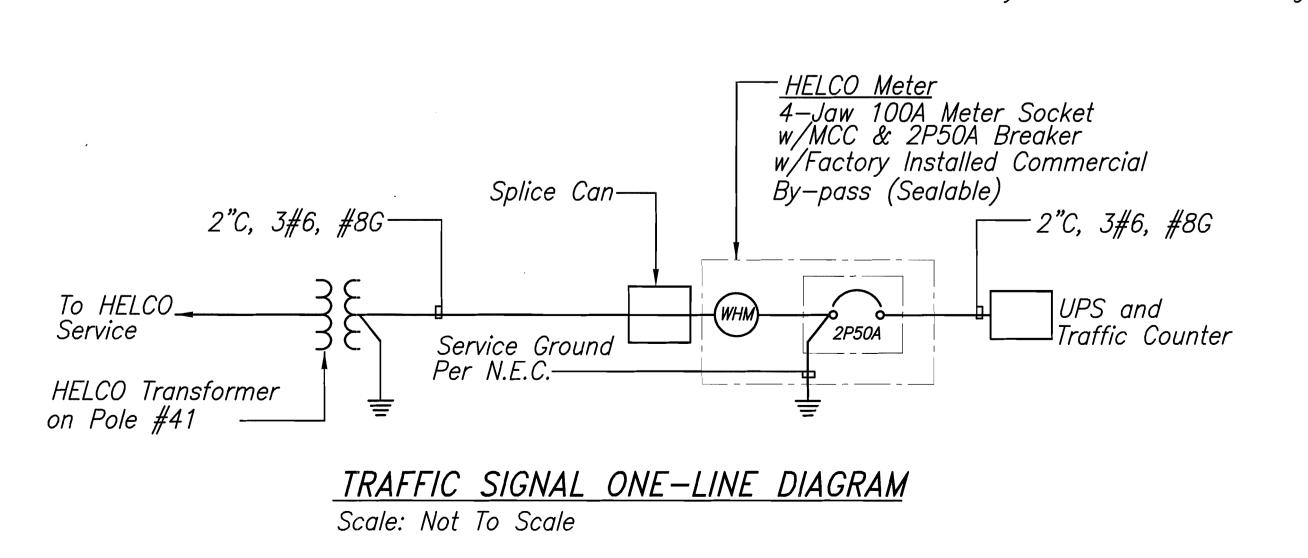

E....

ORIGINAL SURVEY PLOTTED I PLAN DRAWN BY TRACED BY DESIGNED BY QUANTITIES BY CHECKED BY CHECKED BY

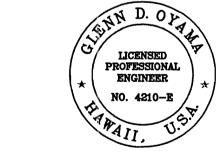

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MAKAMURA, OYAMA & ASSOC. LIC. EXP. DAT

STATE OF HAWAII
DEPARTMENT OF TRANSPORTATION
HIGHWAYS DIVISION

SITE ELECTRICAL PLAN

KEAAU-PAHOA ROAD, SHOULDER LANE CONVERSION, PHASE 1


Keaau Bypass Road to Shower Drive
Fed. Aid Proj. No. STP-0130(28), Phase 1
Scale: 1"=20' Date: June 2012

SHEET No. E-5 OF 25 SHEETS

FED. ROAD DIST. NO. STATE FED. AID PROJ. NO. FISCAL SHEET NO. SHEETS

HAWAII HAW. STP-0130(28)PH.1 2012 269 288

Scale. North

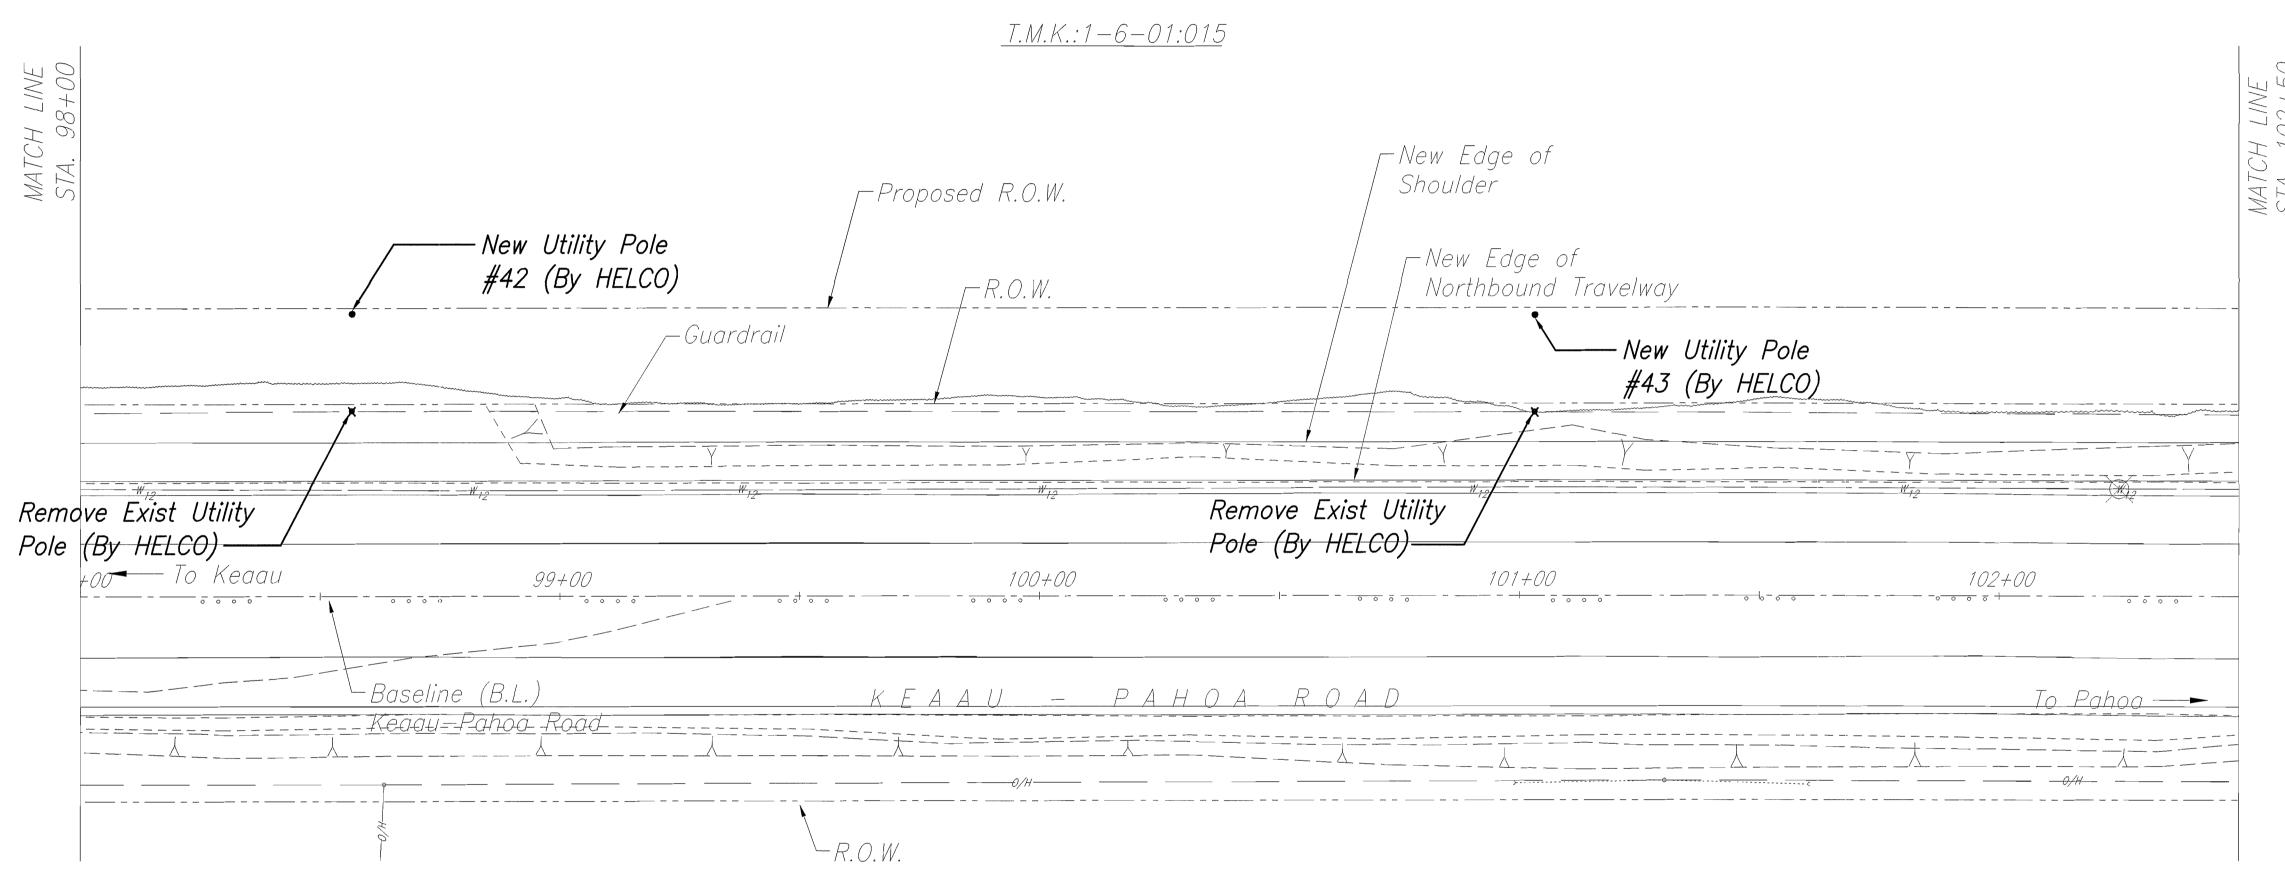

<u>T.M.K.:1-6-04:011</u>

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Makamira Oyana 2/4550C LIC EXP. DAT

STATE OF HAWAII
DEPARTMENT OF TRANSPORTATION
HIGHWAYS DIVISION

SITE ELECTRICAL PLAN


KEAAU-PAHOA ROAD, SHOULDER


LANE CONVERSION, PHASE 1

Keaau Bypass Road to Shower Drive

Keaau Bypass Road to Shower Drive
Fed. Aid Proj. No. STP-0130(28), Phase 1
Scale: 1"=20' Date: June 2012

SHEET No. E-6 OF 25 SHEETS

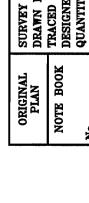

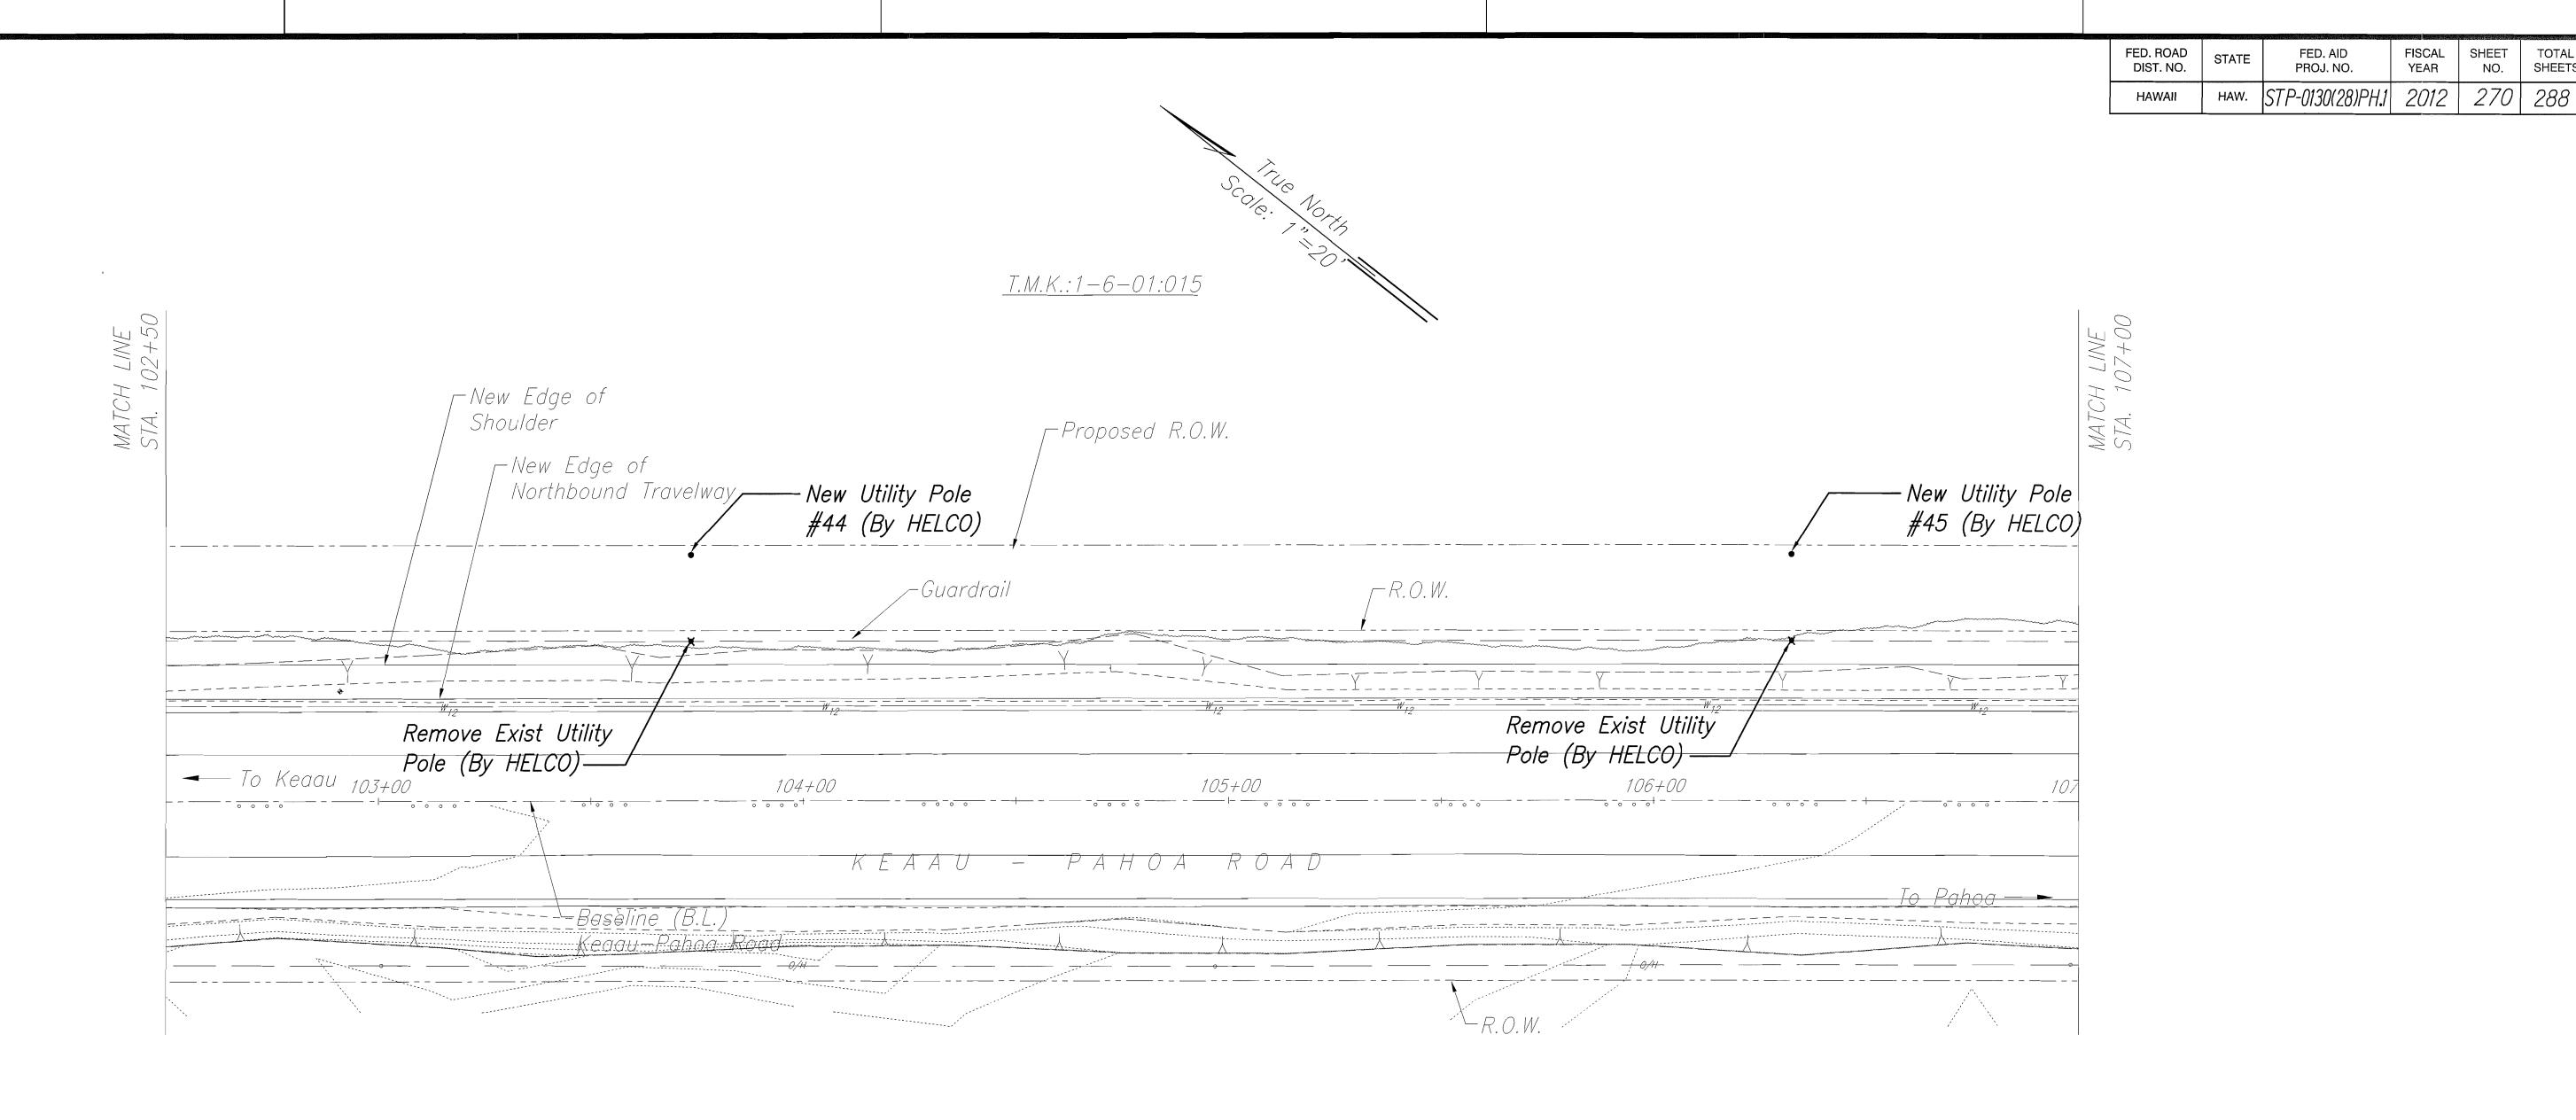

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STATE OF HAWAII
DEPARTMENT OF TRANSPORTATION

SITE ELECTRICAL PLAN

KEAAU-PAHOA ROAD, SHOULDER


LANE CONVERSION, PHASE 1

Keaau Bypass Road to Shower Drive


Fed. Aid Proj. No. STP-0130(28), Phase 1

Scale: 1"=20' June 2012

SHEET No. E-7 OF 25 SHEETS

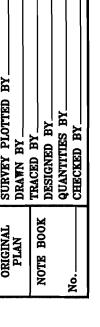

FED. ROAD DIST. NO.	STATE	FED. AID PROJ. NO.	FISCAL YEAR	SHEET NO.	TOTAL SHEETS
HAWAII	HAW.	STP-0130(28)PH.1	2012	271	288

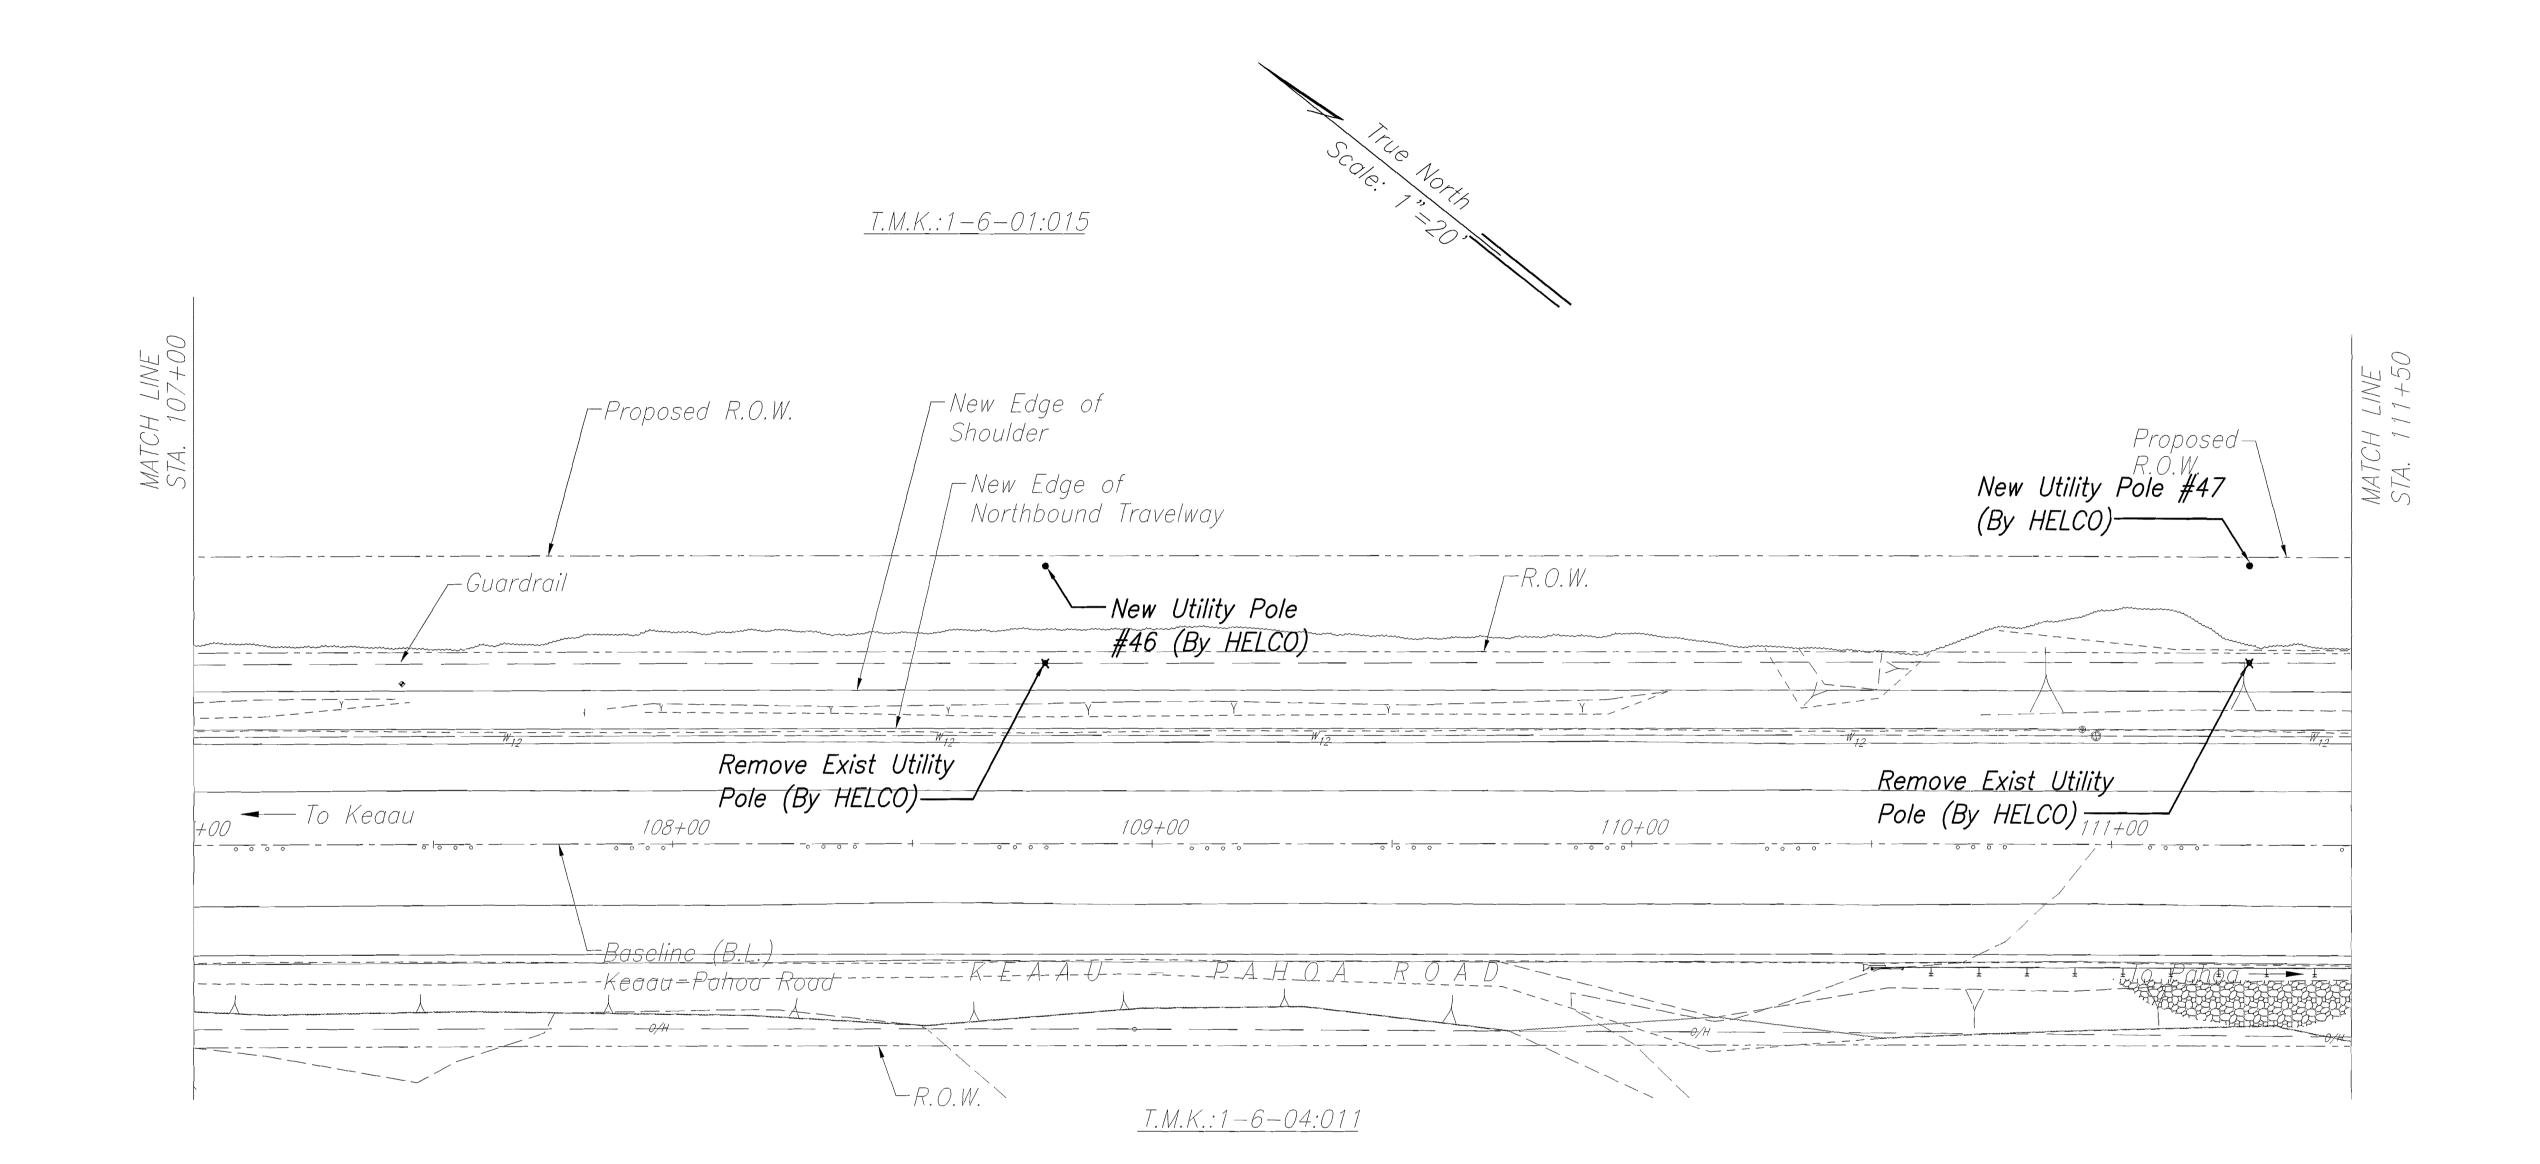



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MAKAMURA OYAMA & ASSOC LIC EXP. DATI

STATE OF HAWAII
DEPARTMENT OF TRANSPORTATION
HIGHWAYS DIVISION

SITE ELECTRICAL PLAN

KEAAU-PAHOA ROAD, SHOULDER


LANE CONVERSION, PHASE 1


Keaau Bypass Road to Shower Drive

Fed Aid Proi No STP-0130(28) Phase

Fed. Aid Proj. No. STP-0130(28), Phase 1
Scale: 1"=20' Date: June 2012

SHEET No. E-8 OF 25 SHEETS

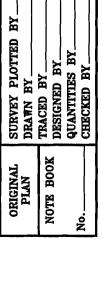


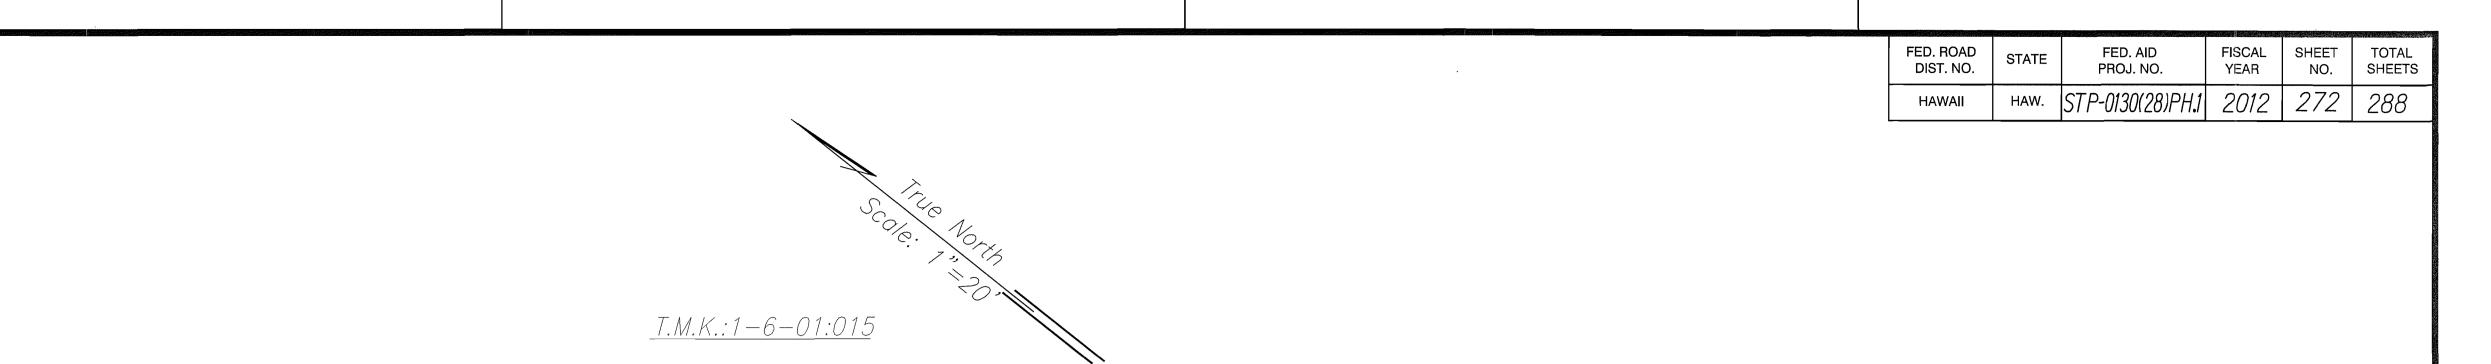

Proposed R.O.W. New Edge of Shoulder _ R.O.W. New Edge of Northbound Travelway opNew Utility Pole #48 (By HELCO) Remove Exist Utility Pole (By HELCO)-KEAAU - PAHOA ROAD \- R.O.W.

T.M.K.:1-6-04:011

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STATE OF HAWAII
DEPARTMENT OF TRANSPORTATION HIGHWAYS DIVISION

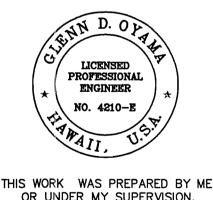SITE ELECTRICAL PLAN


KEAAU-PAHOA ROAD, SHOULDER

LANE CONVERSION, PHASE 1


Keaau Bypass Road to Shower Drive

Fed. Aid Proj. No. STP-0130(28), Phase Scale: 1"=20' June 2012

SHEET No. E-9 OF 25 SHEETS

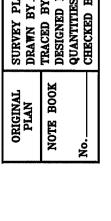

FED. ROAD DIST. NO.	STATE	FED. AID PROJ. NO.	FISCAL YEAR	SHEET NO.	TOTAL SHEETS
HAWAII	HAW.	STP-0130(28)PH.1	2012	273	288

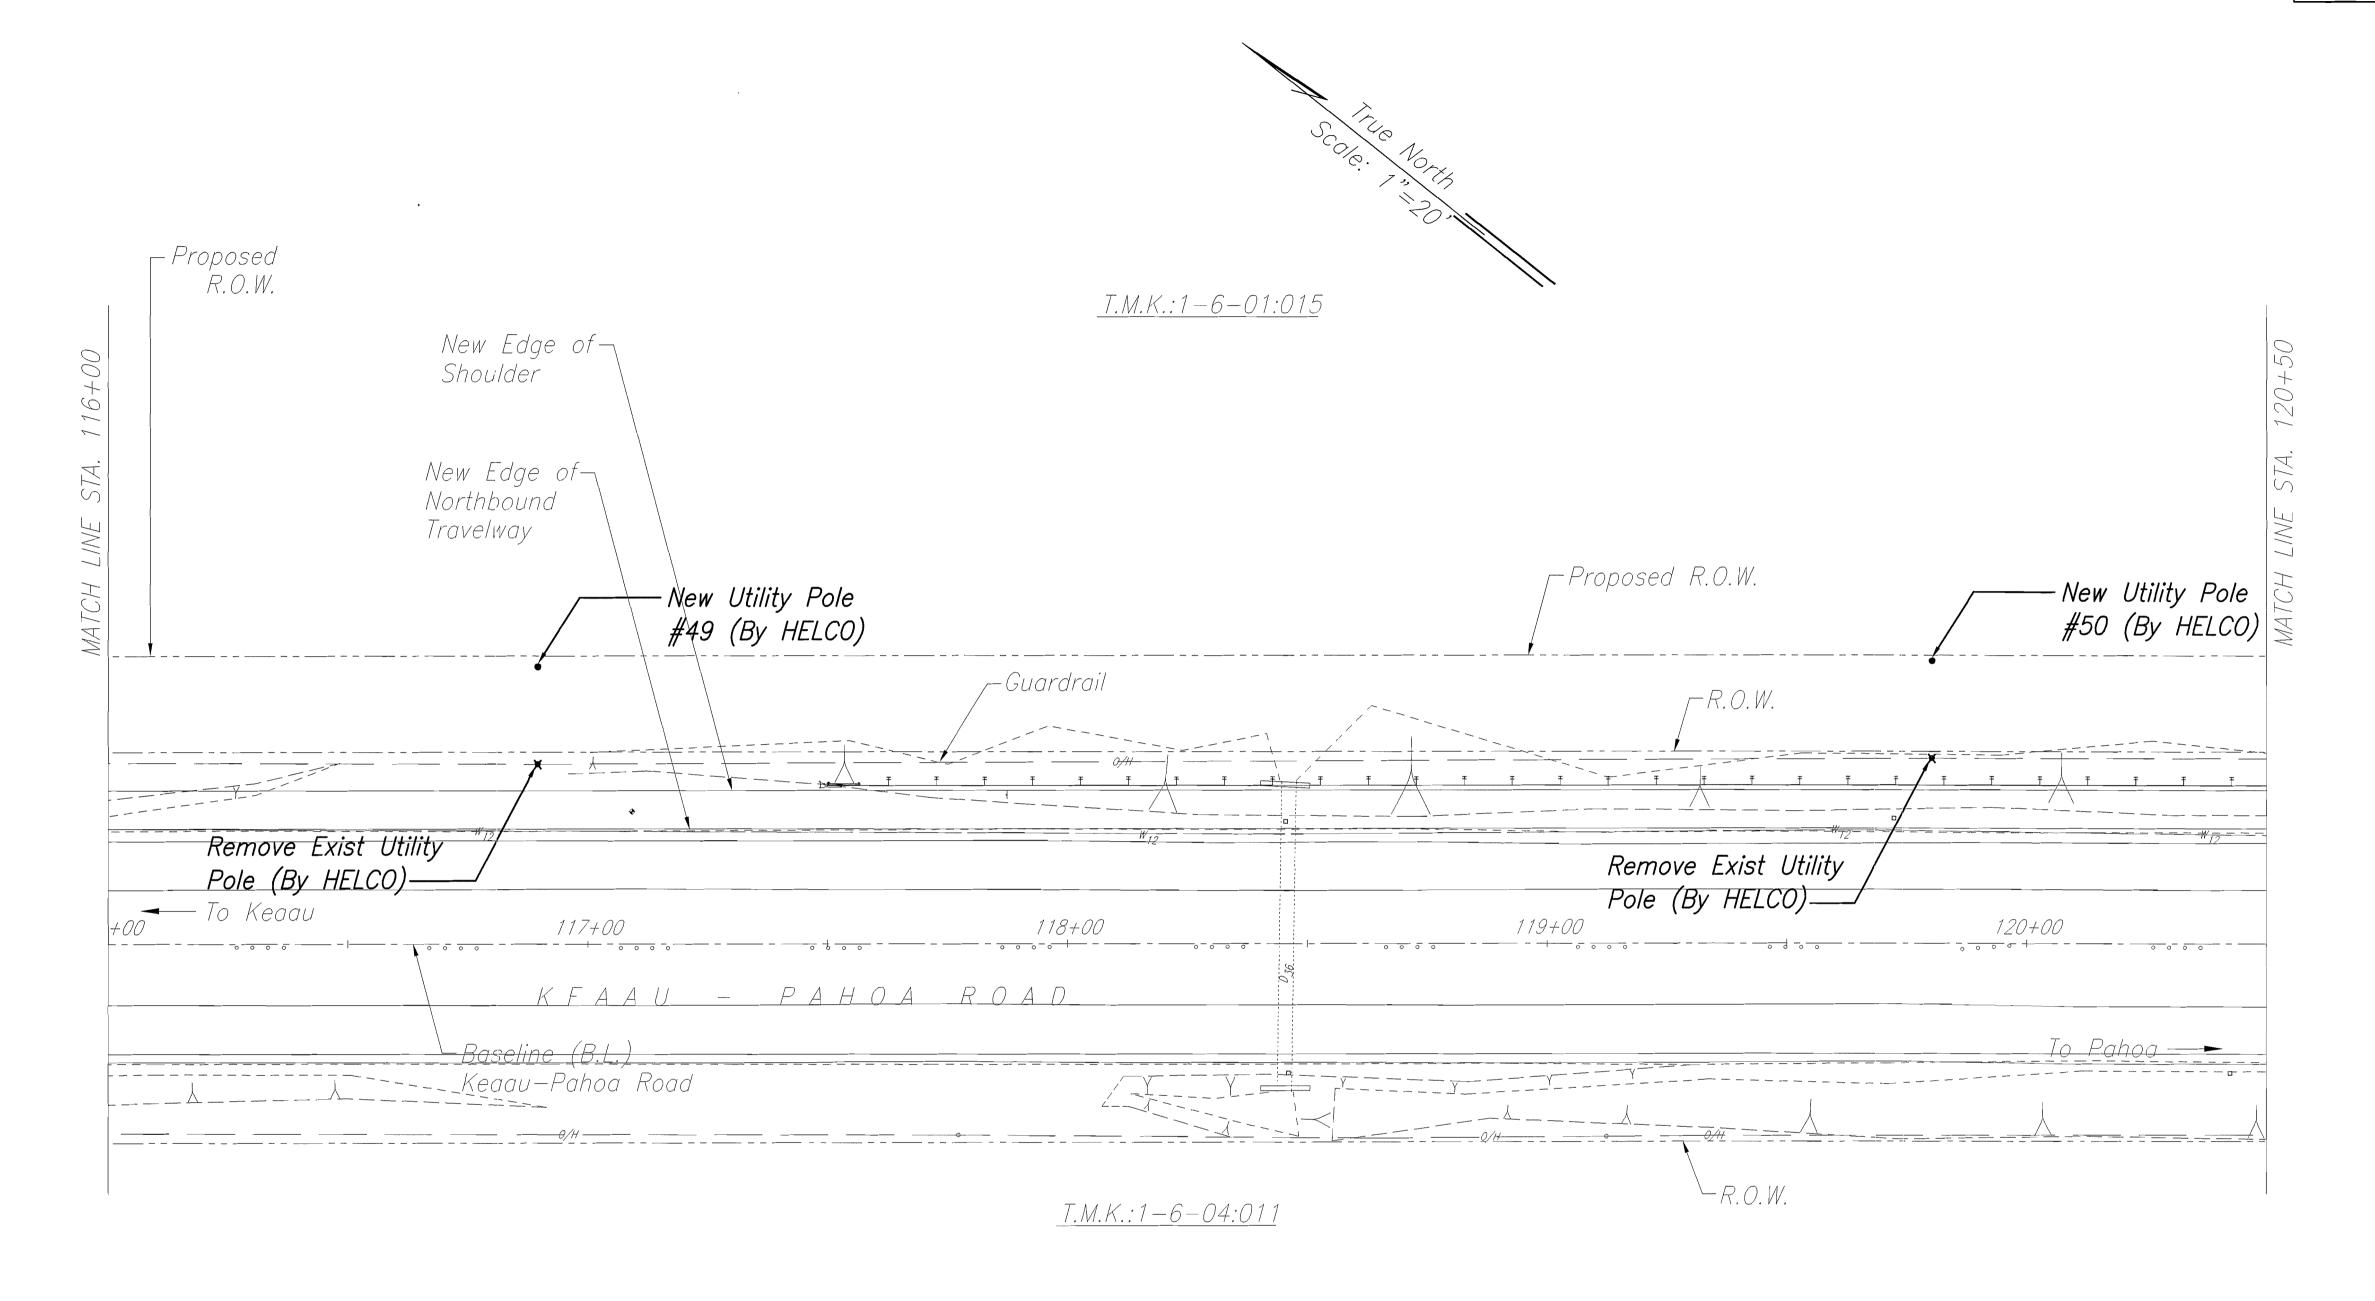



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STATE OF HAWAII DEPARTMENT OF TRANSPORTATION HIGHWAYS DIVISION

SITE ELECTRICAL PLAN


KEAAU-PAHOA ROAD, SHOULDER


LANE CONVERSION, PHASE 1

Keaau Bypass Road to Shower Drive Fed. Aid Proj. No. STP-0130(28), Phase 1

Scale: 1"=20' June 2012 SHEET No. E-10 OF 25 SHEETS

FED. ROAD DIST. NO.	STATE	FED. AID PROJ. NO.	FISCAL YEAR	SHEET NO.	TOTAL SHEETS
HAWAII	HAW.	STP-0130(28)PH.1	2012	274	288

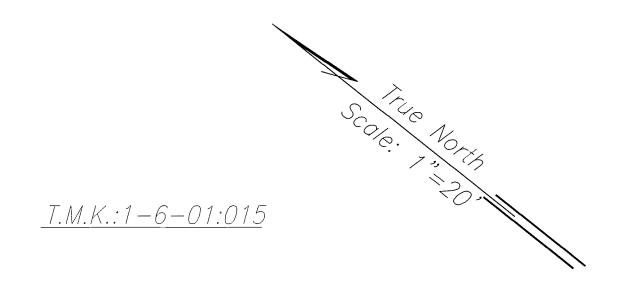

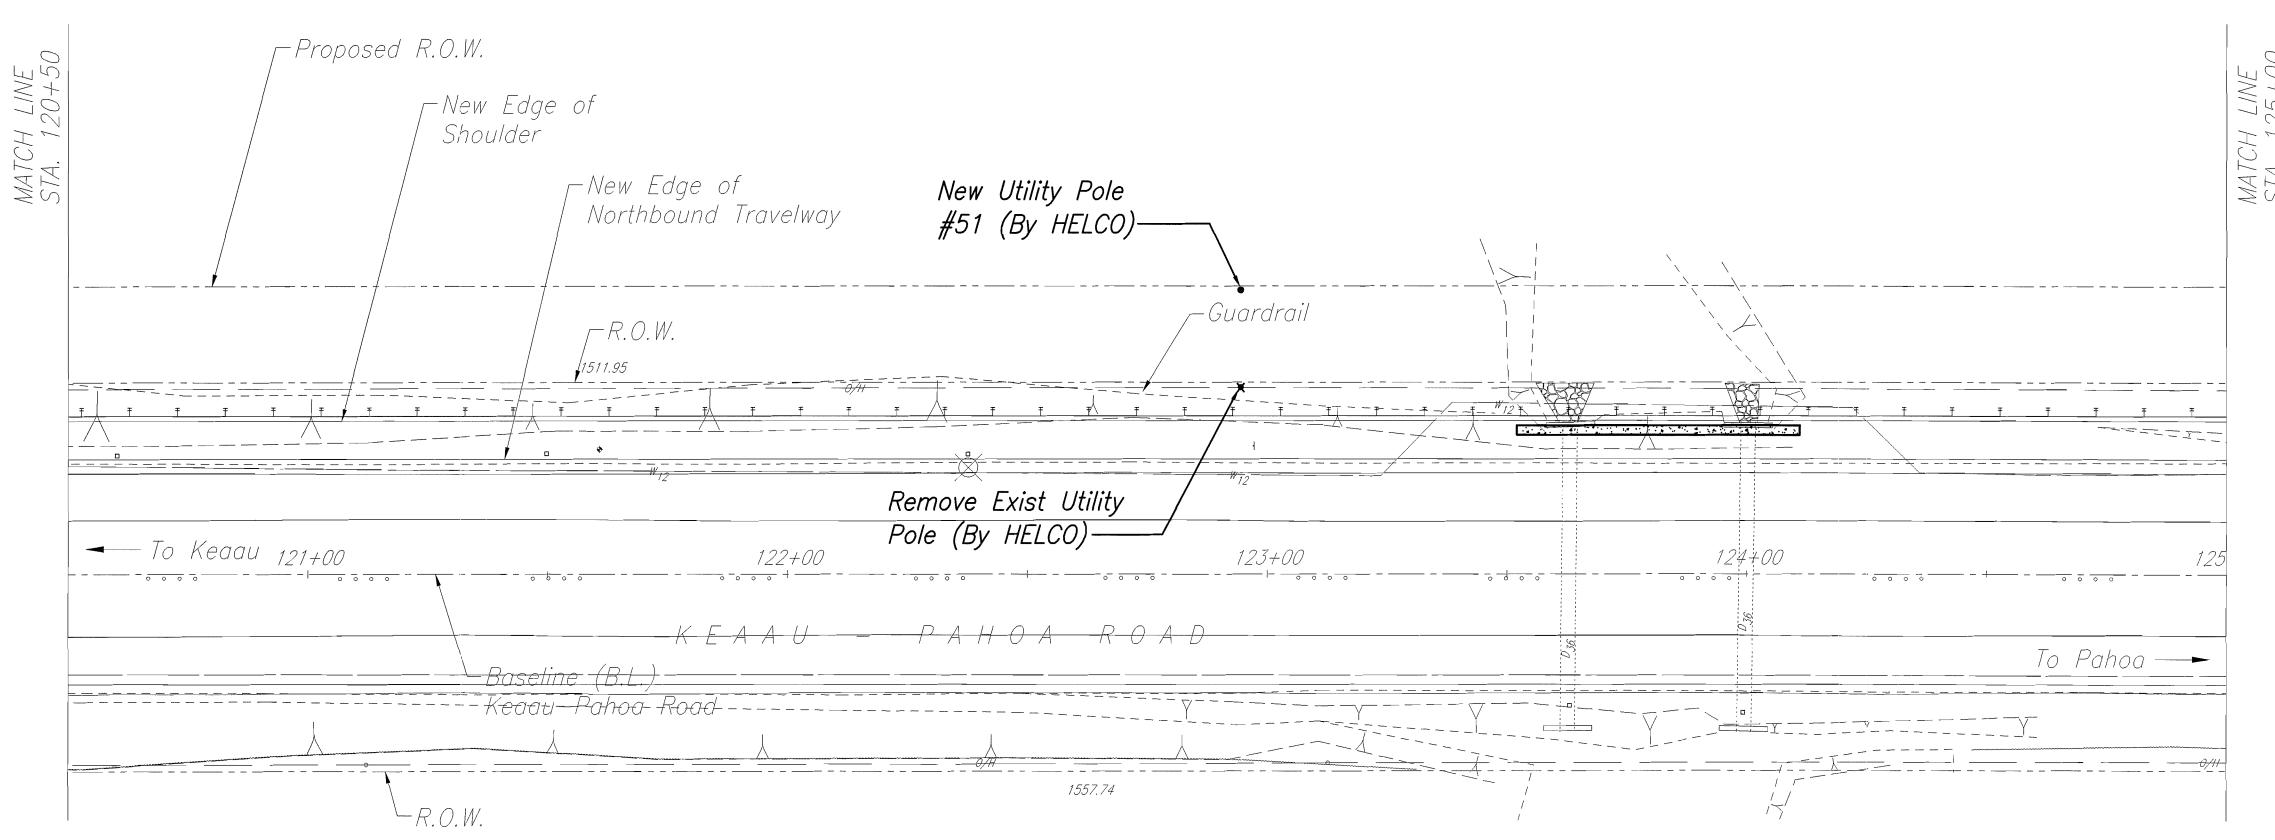

<u>Note:</u> All Utility Poles to be Relocated Within 1' (Preferable) But Not More Than 5' From New ROW. Verify Location With Civil Engineers.



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NAKAMURA, OYAMA & ASSOC. LIC. EXP. DATE

STATE OF HAWAII
DEPARTMENT OF TRANSPORTATION
HIGHWAYS DIVISION

SITE ELECTRICAL PLAN

KEAAU-PAHOA ROAD, SHOULDER


LANE CONVERSION, PHASE 1


Keaau Bypass Road to Shower Drive

 Fed. Aid Proj. No. STP-0130(28), Phase 1

 Scale: 1"=20'
 Date:
 June 2012

SHEET No. E-11 OF 25 SHEETS

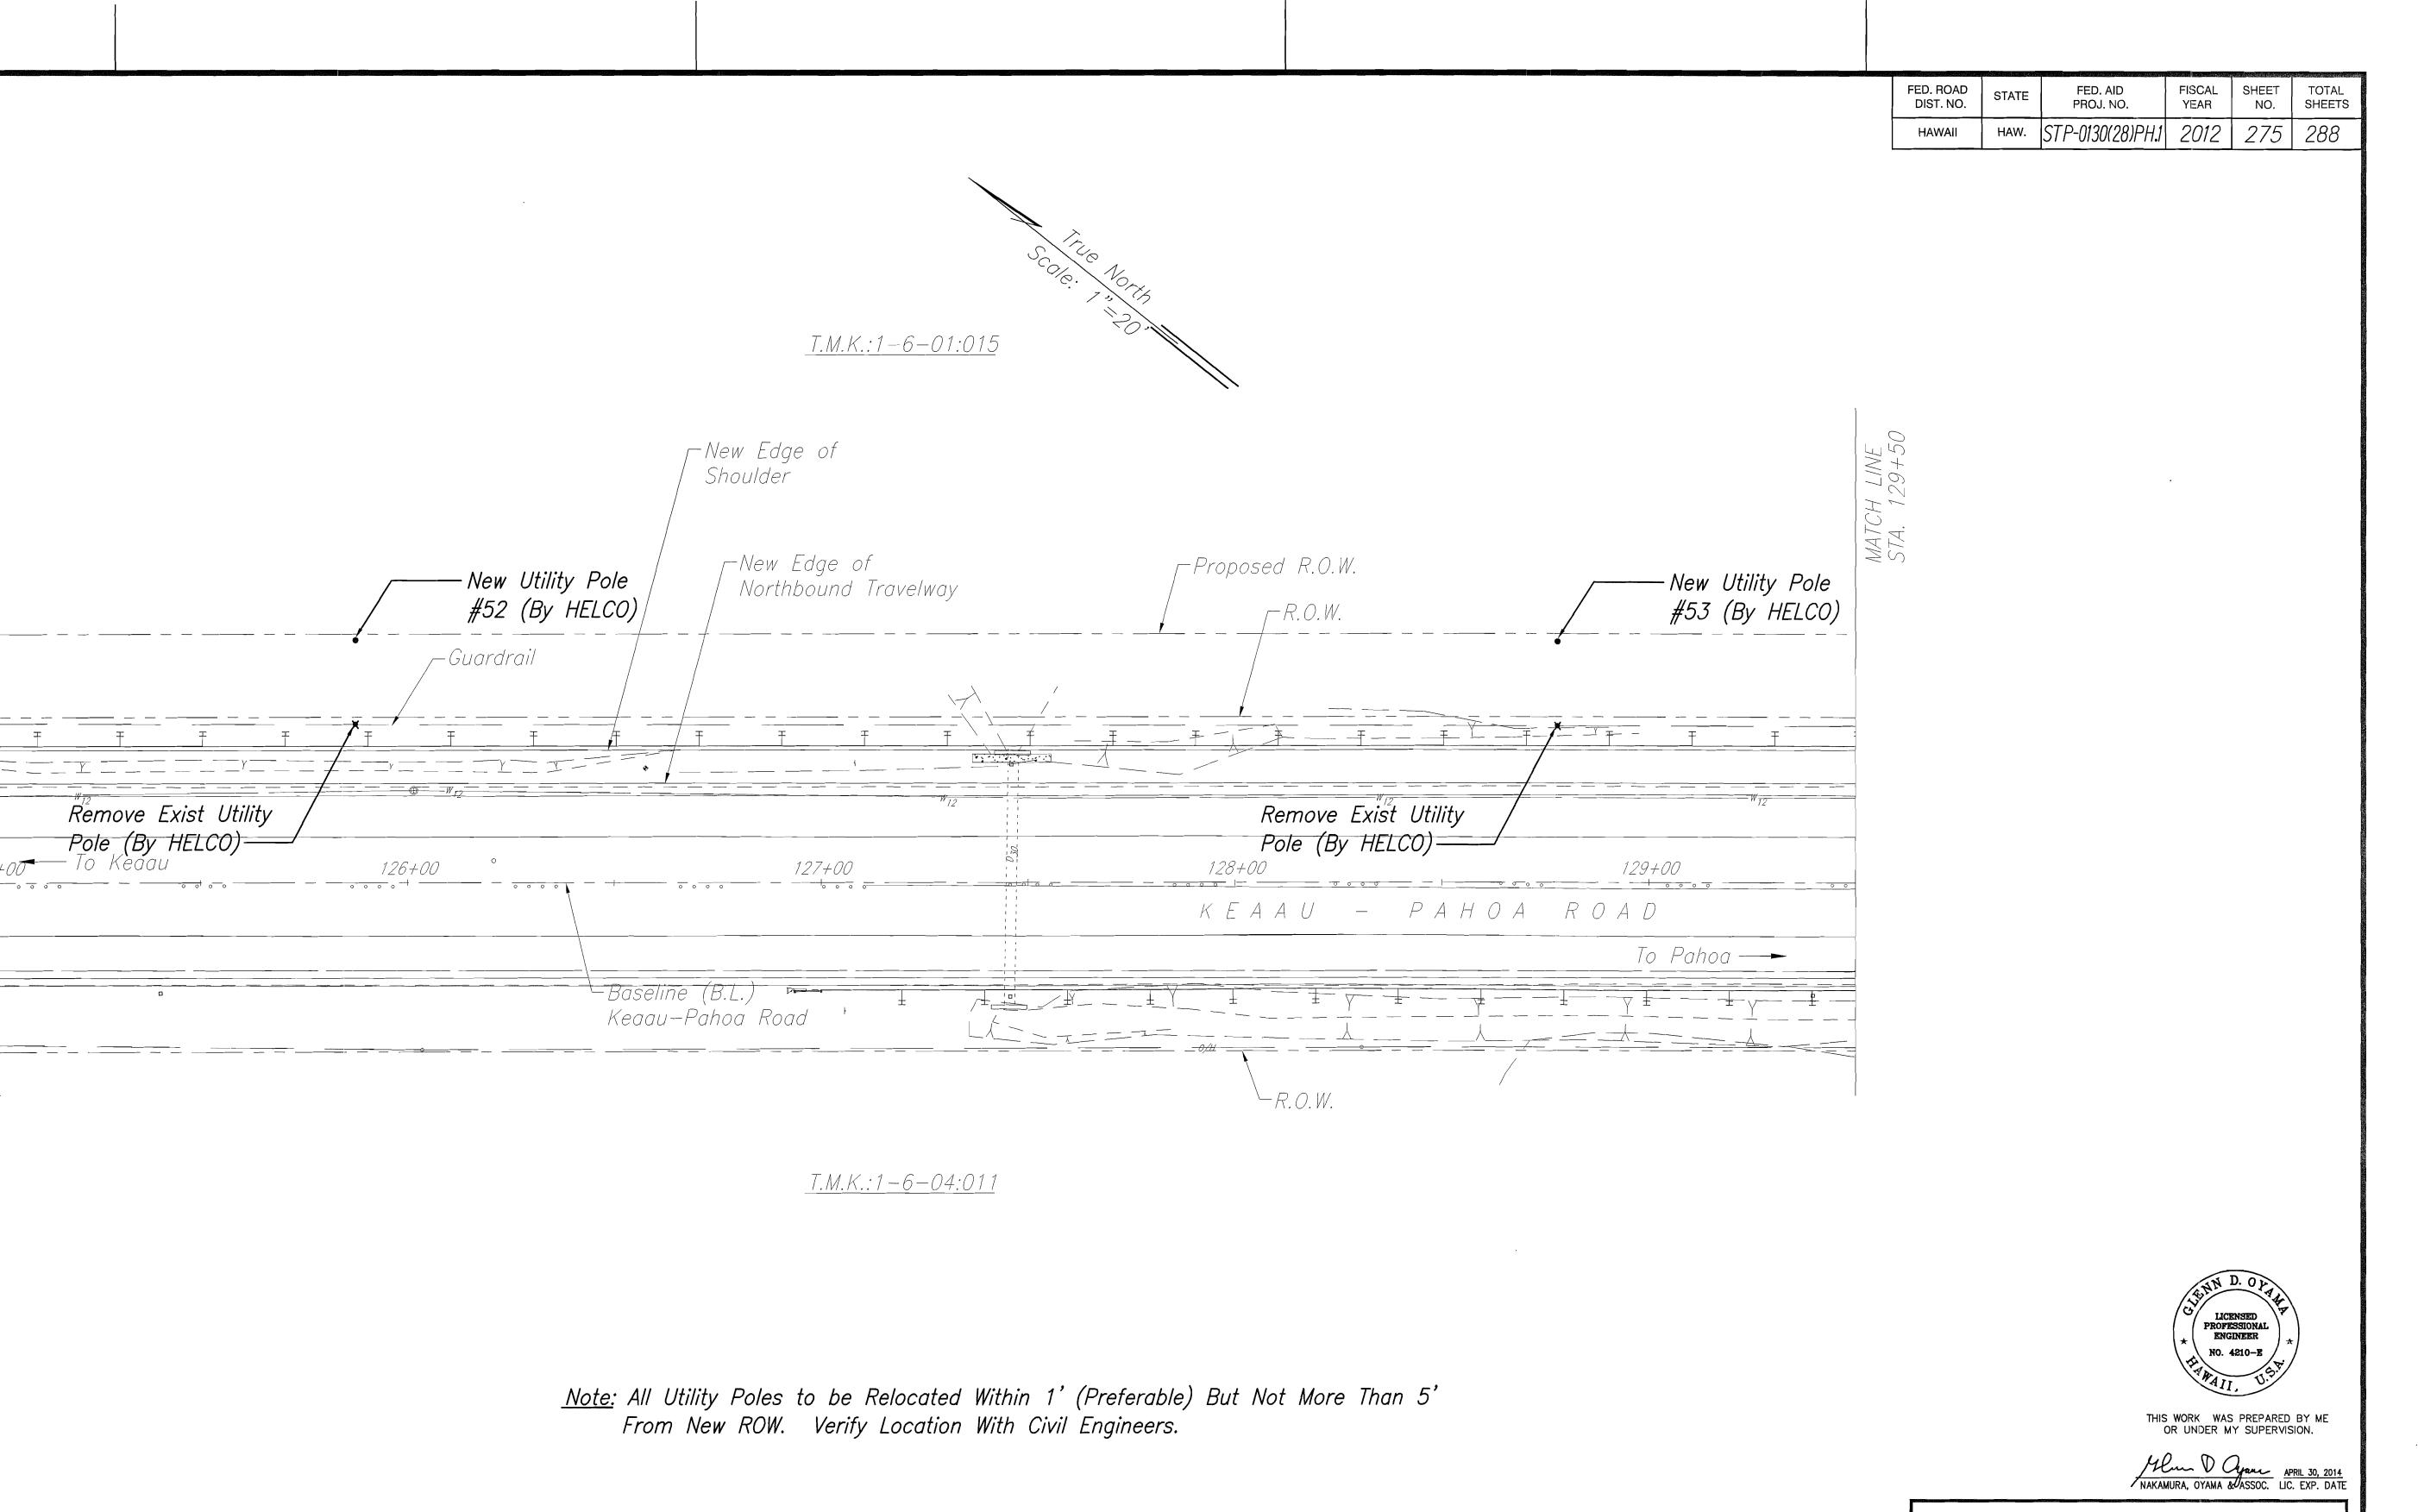

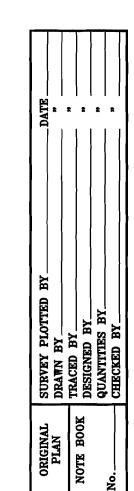

STATE OF HAWAII
DEPARTMENT OF TRANSPORTATION
HIGHWAYS DIVISION

SITE ELECTRICAL PLAN

KEAAU-PAHOA ROAD, SHOULDER


LANE CONVERSION, PHASE 1

Keaau Bypass Road to Shower Drive

Fed. Aid Proj. No. STP-0130(28), Phase 1
Scale: 1"=20' Date: June 2012

SHEET No. E-12 OF 25 SHEETS

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<u>Note:</u> All Utility Poles to be Relocated Within 1' (Preferable) But Not More Than 5' From New ROW. Verify Location With Civil Engineers.

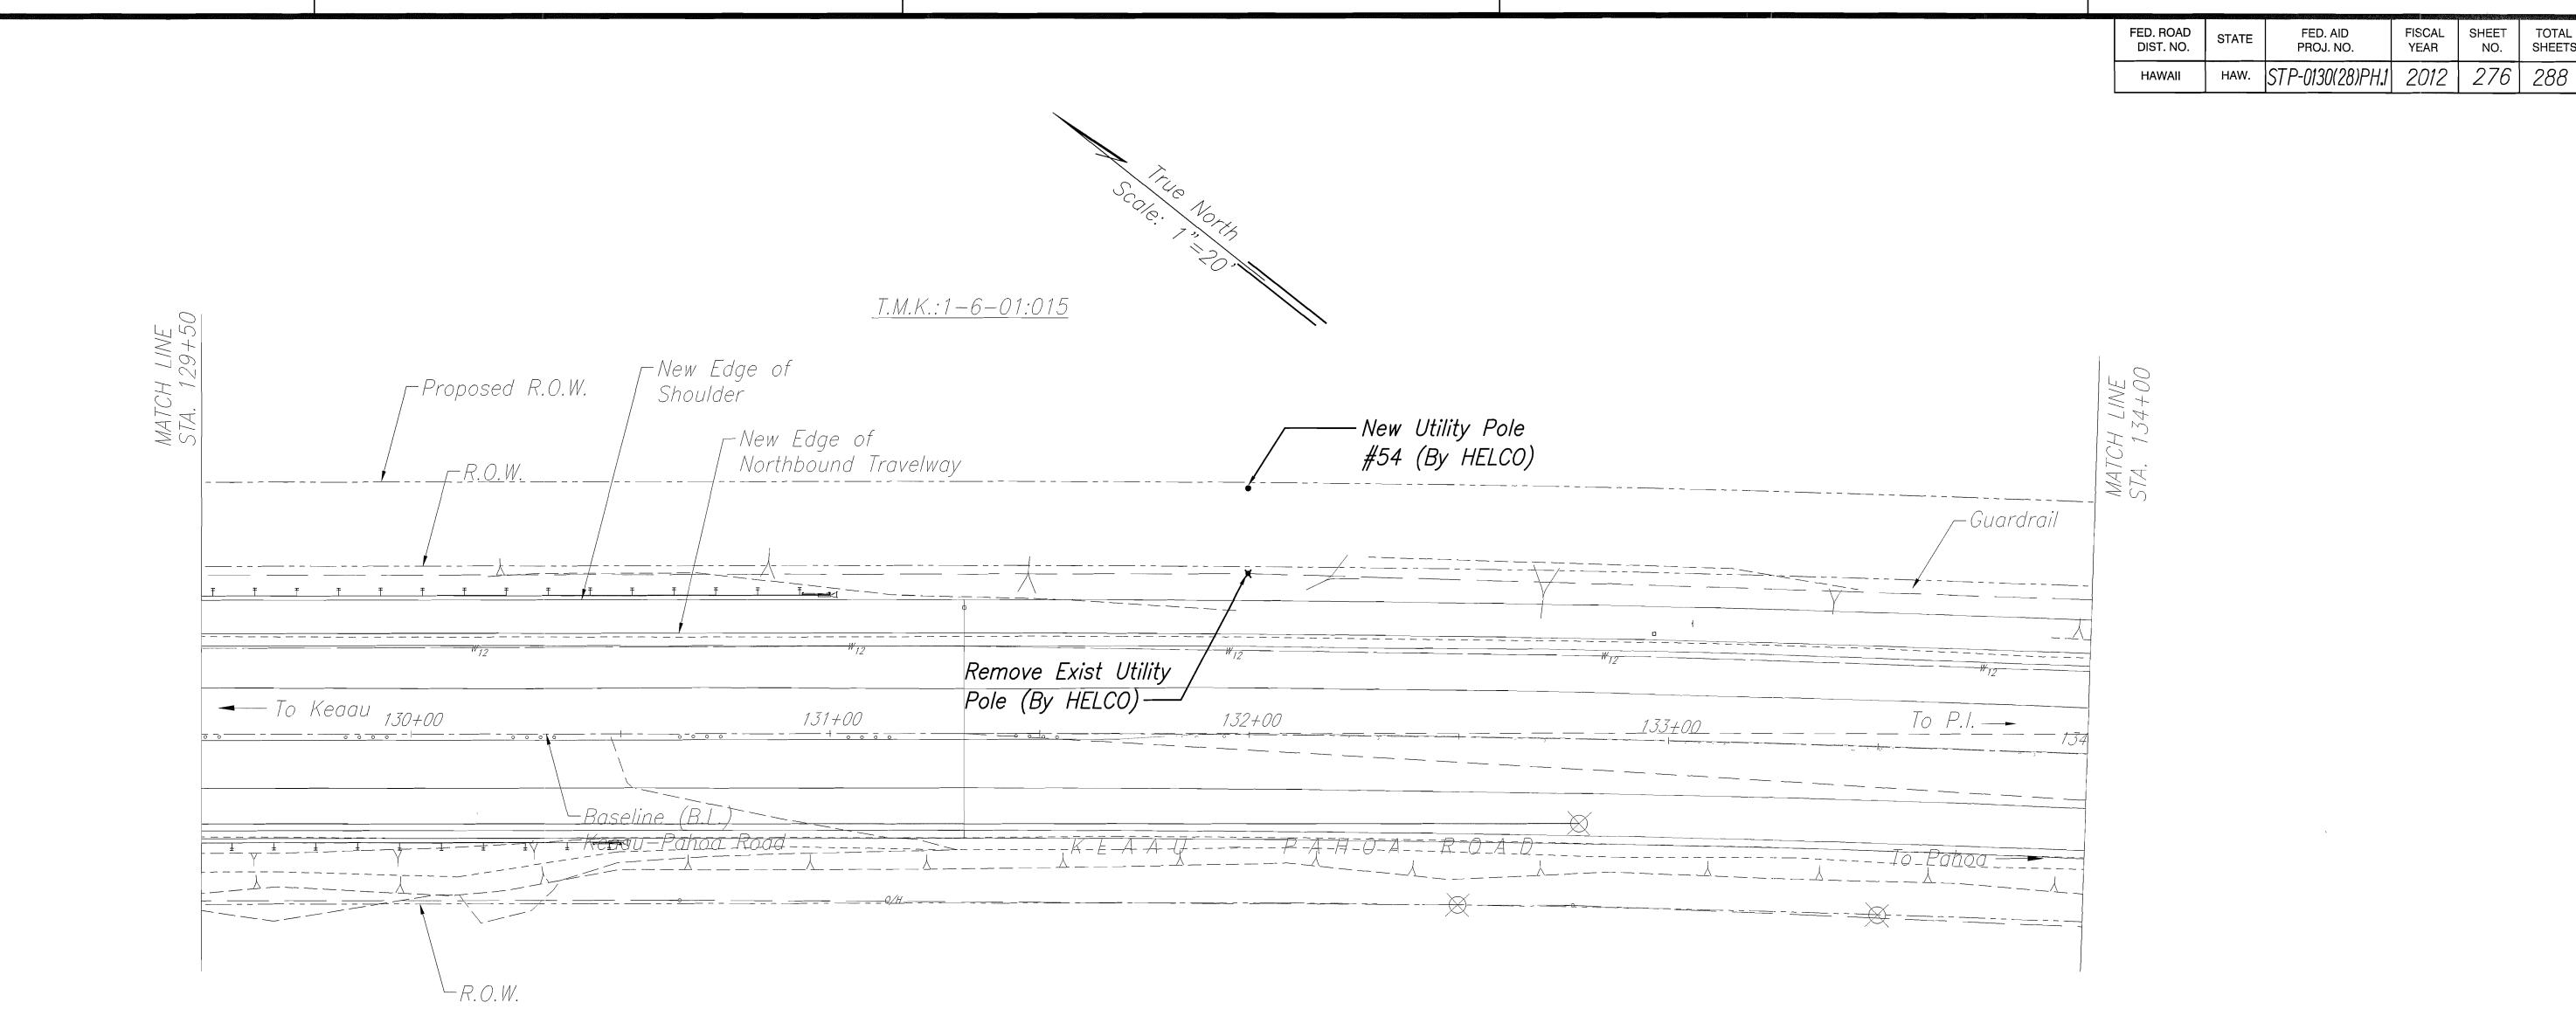

FISCAL YEAR

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STATE OF HAWAII
DEPARTMENT OF TRANSPORTATION HIGHWAYS DIVISION

SITE ELECTRICAL PLAN

KEAAU-PAHOA ROAD, SHOULDER


LANE CONVERSION, PHASE 1

Keaau Bypass Road to Shower Drive


Fed. Aid Proj. No. STP-0130(28), Phase 1


Scale: 1"=20' Date: June 2012

SHEET No. E-13 OF 25 SHEETS

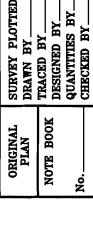



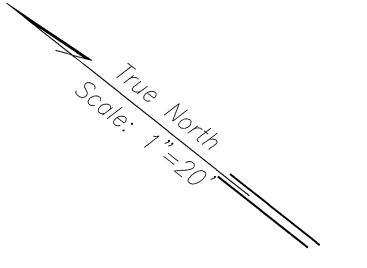

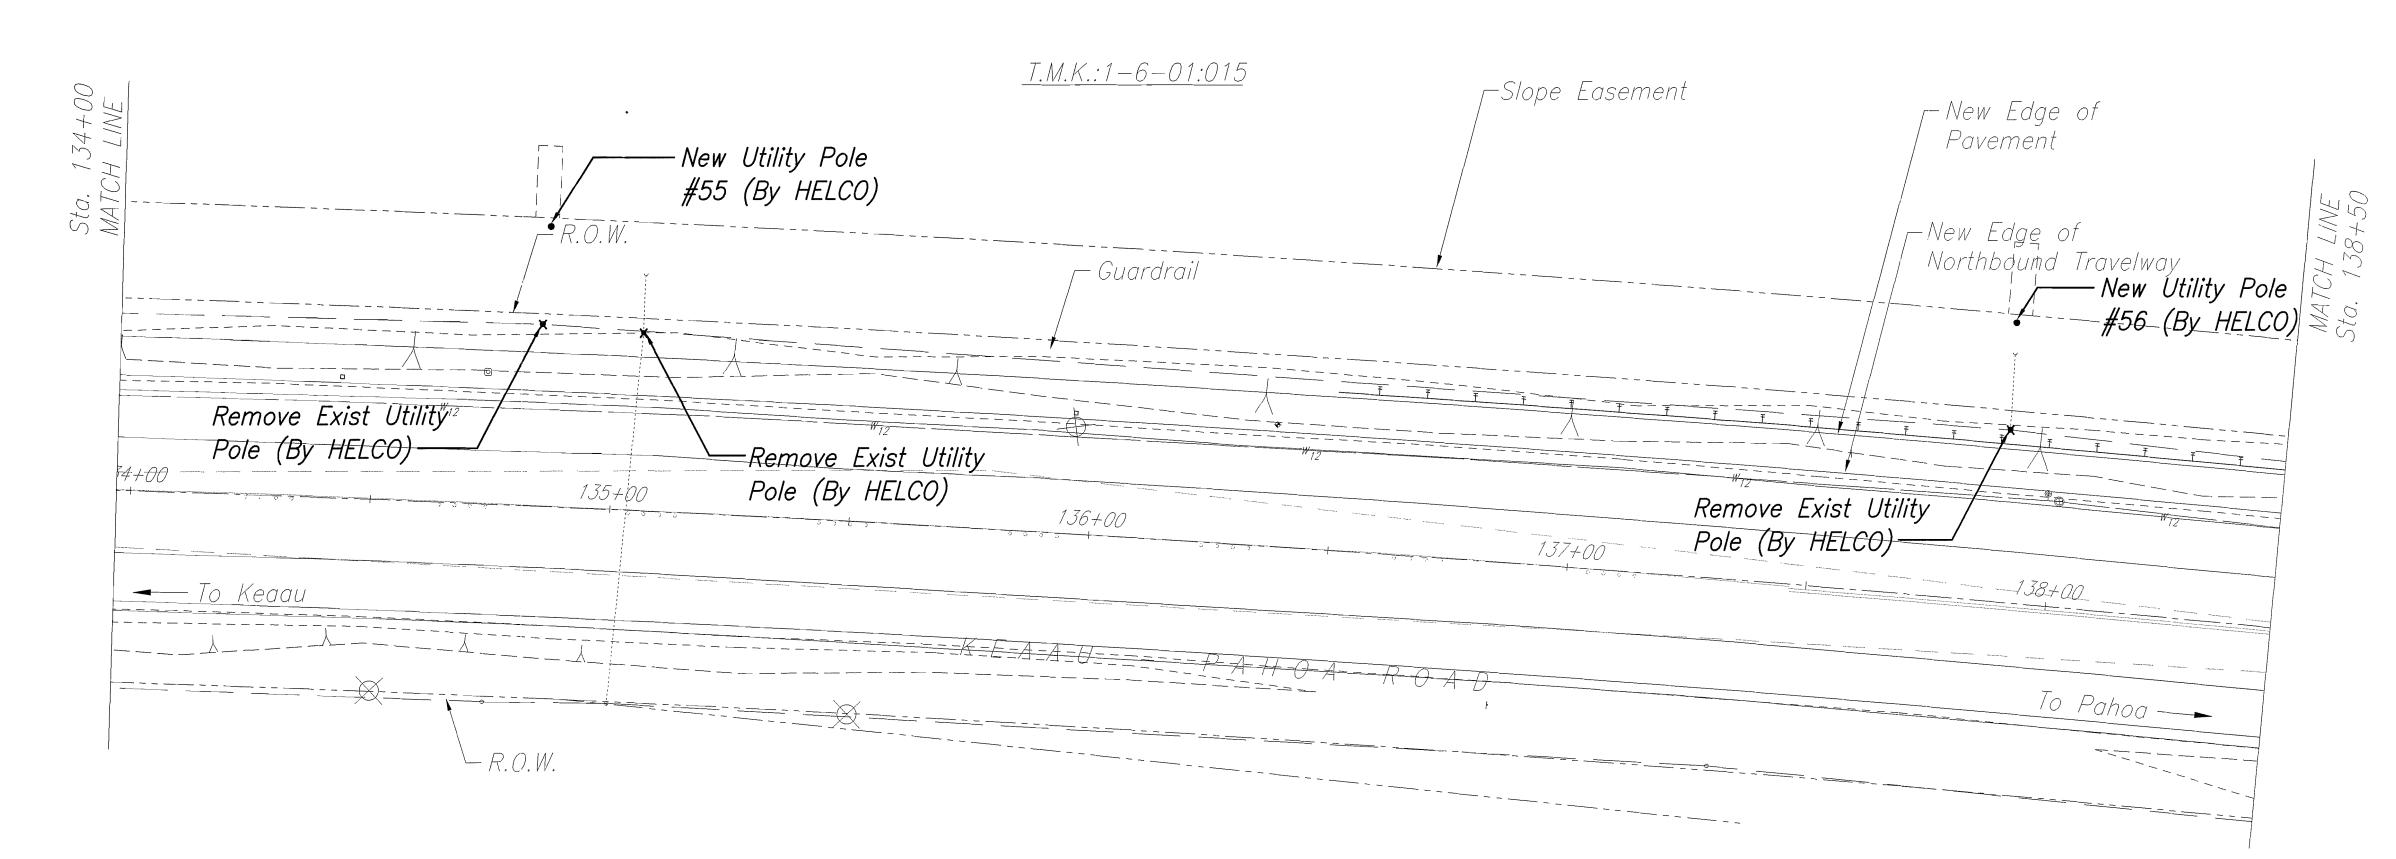

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STATE OF HAWAII
DEPARTMENT OF TRANSPORTATION HIGHWAYS DIVISION

SITE ELECTRICAL PLAN


KEAAU-PAHOA ROAD, SHOULDER

LANE CONVERSION, PHASE 1

Keaau Bypass Road to Shower Drive Fed. Aid Proj. No. STP-0130(28), Phase 1
Scale: 1"=20' Date: June 2012

SHEET No. E-14 OF 25 SHEETS

FED. ROAD DIST. NO.	STATE	FED. AID PROJ. NO.	FISCAL YEAR	SHEET NO.	TOTAL SHEETS
HAWAII	HAW.	STP-0130(28)PH.1	2012	278	288

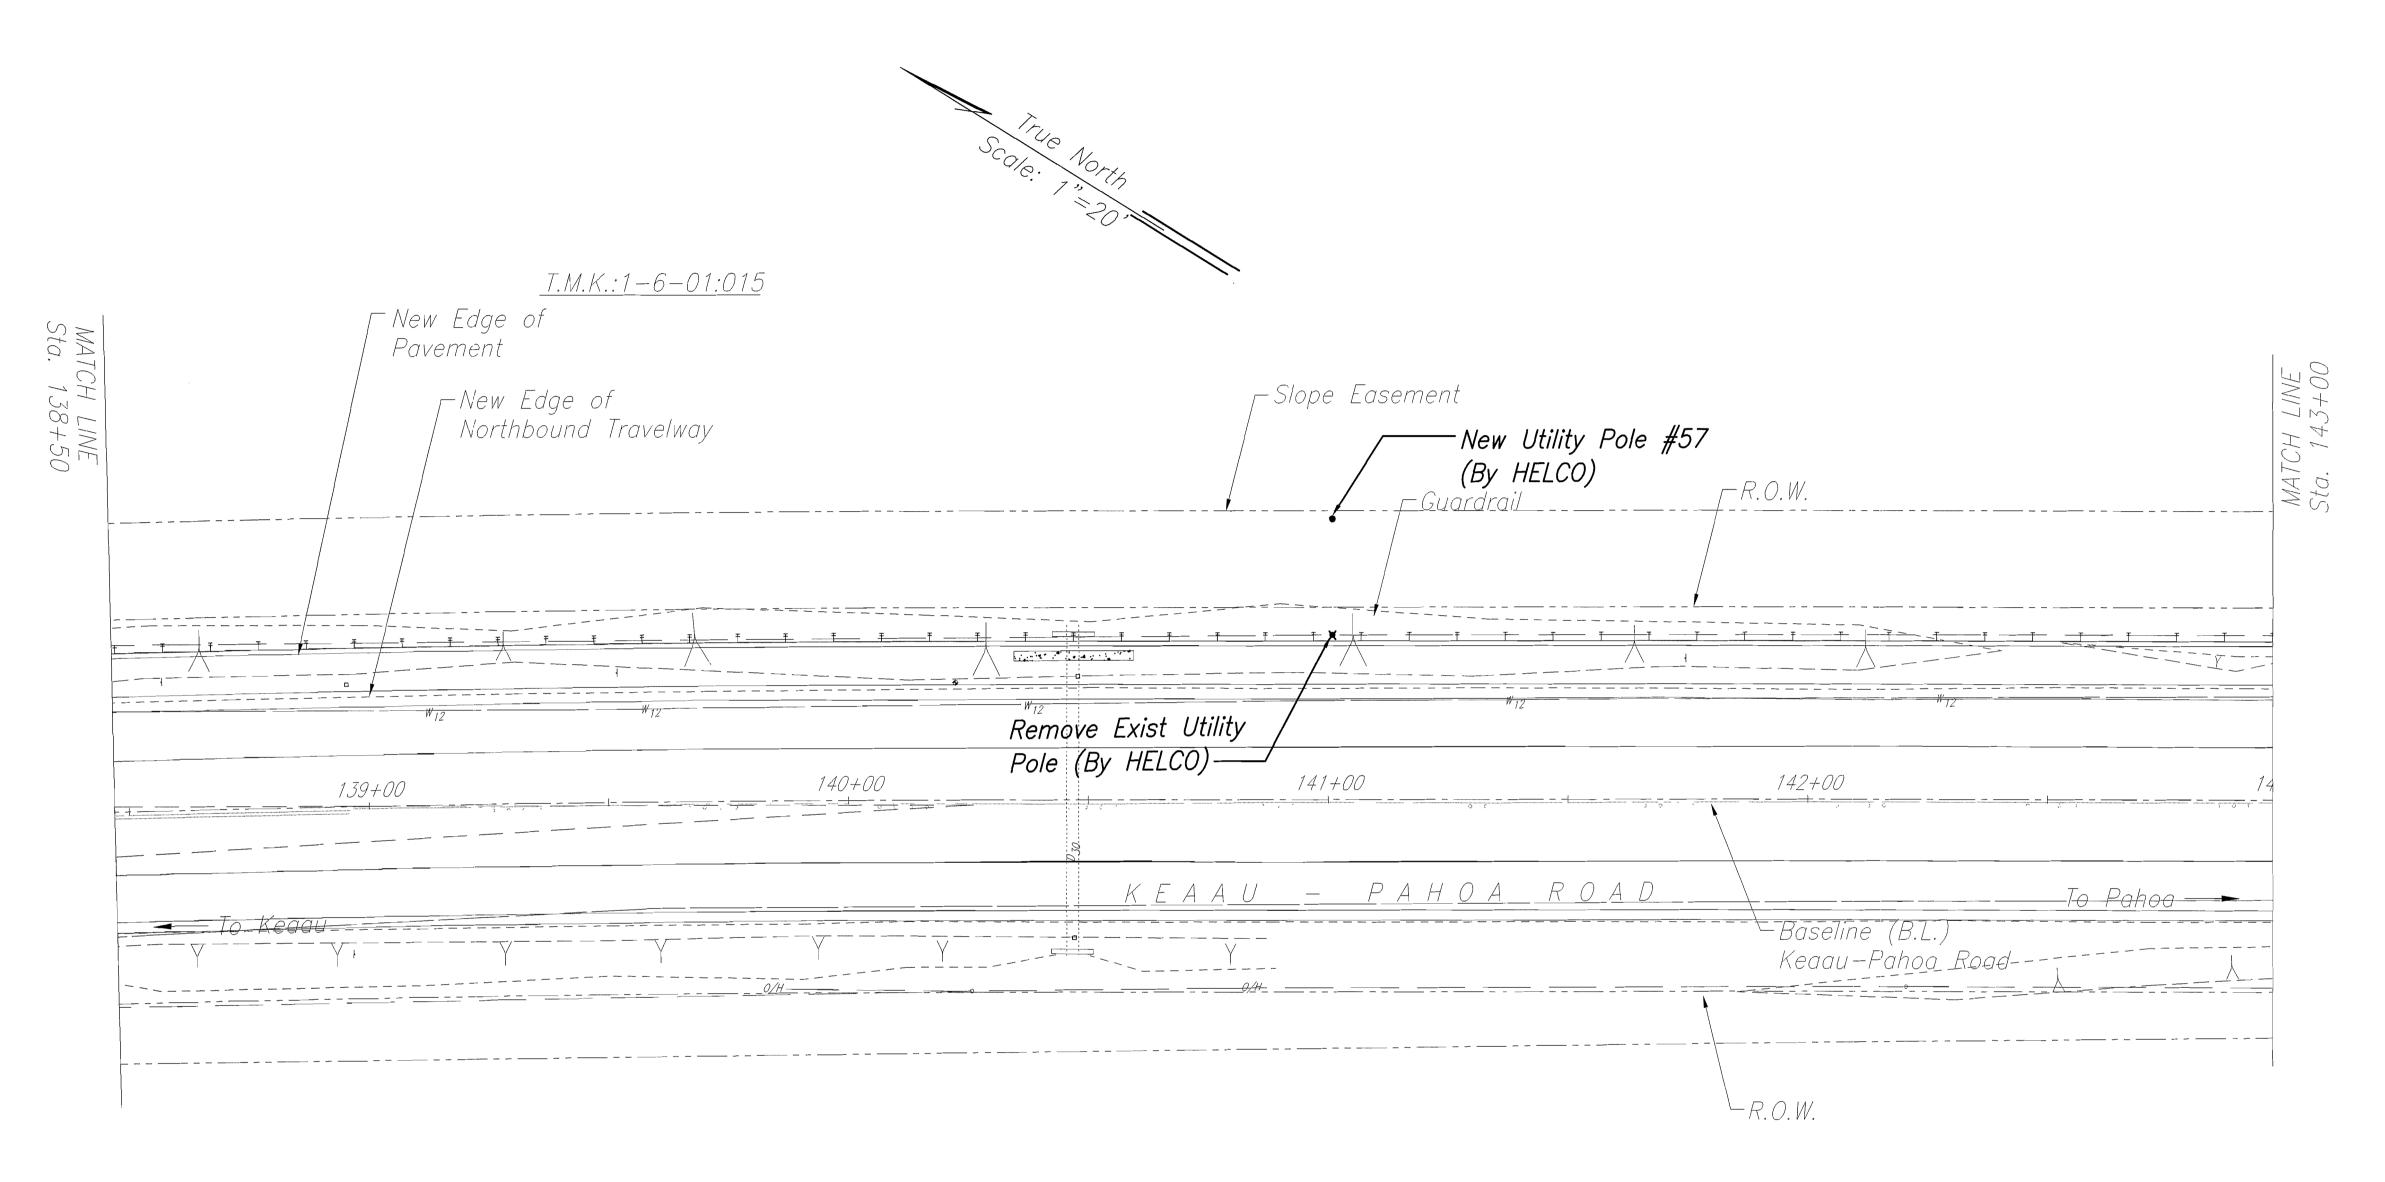

<u>Note:</u> All Utility Poles to be Relocated Within 1' (Preferable) But Not More Than 5' From New ROW. Verify Location With Civil Engineers.



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STATE OF HAWAII DEPARTMENT OF TRANSPORTATION HIGHWAYS DIVISION

SITE ELECTRICAL PLAN

KEAAU-PAHOA ROAD, SHOULDER


LANE CONVERSION, PHASE 1

Keaau Bypass Road to Shower Drive


Fed. Aid Proj. No. STP-0130(28), Phase 1

Scale: 1"=20'


SHEET No. E-15 OF 25 SHEETS

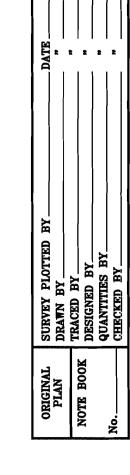

FED. ROAD DIST. NO.	STATE	FED. AID PROJ. NO.	FISCAL YEAR	SHEET NO.	TOTAL SHEETS
HAWAII	HAW.	STP-0130(28)PH.1	2012	279	288

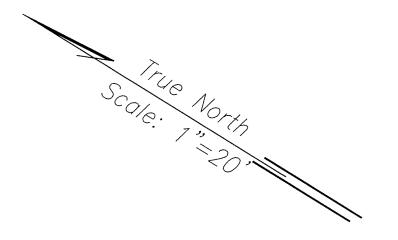

<u>T.M.K.:1-6-01:015</u>

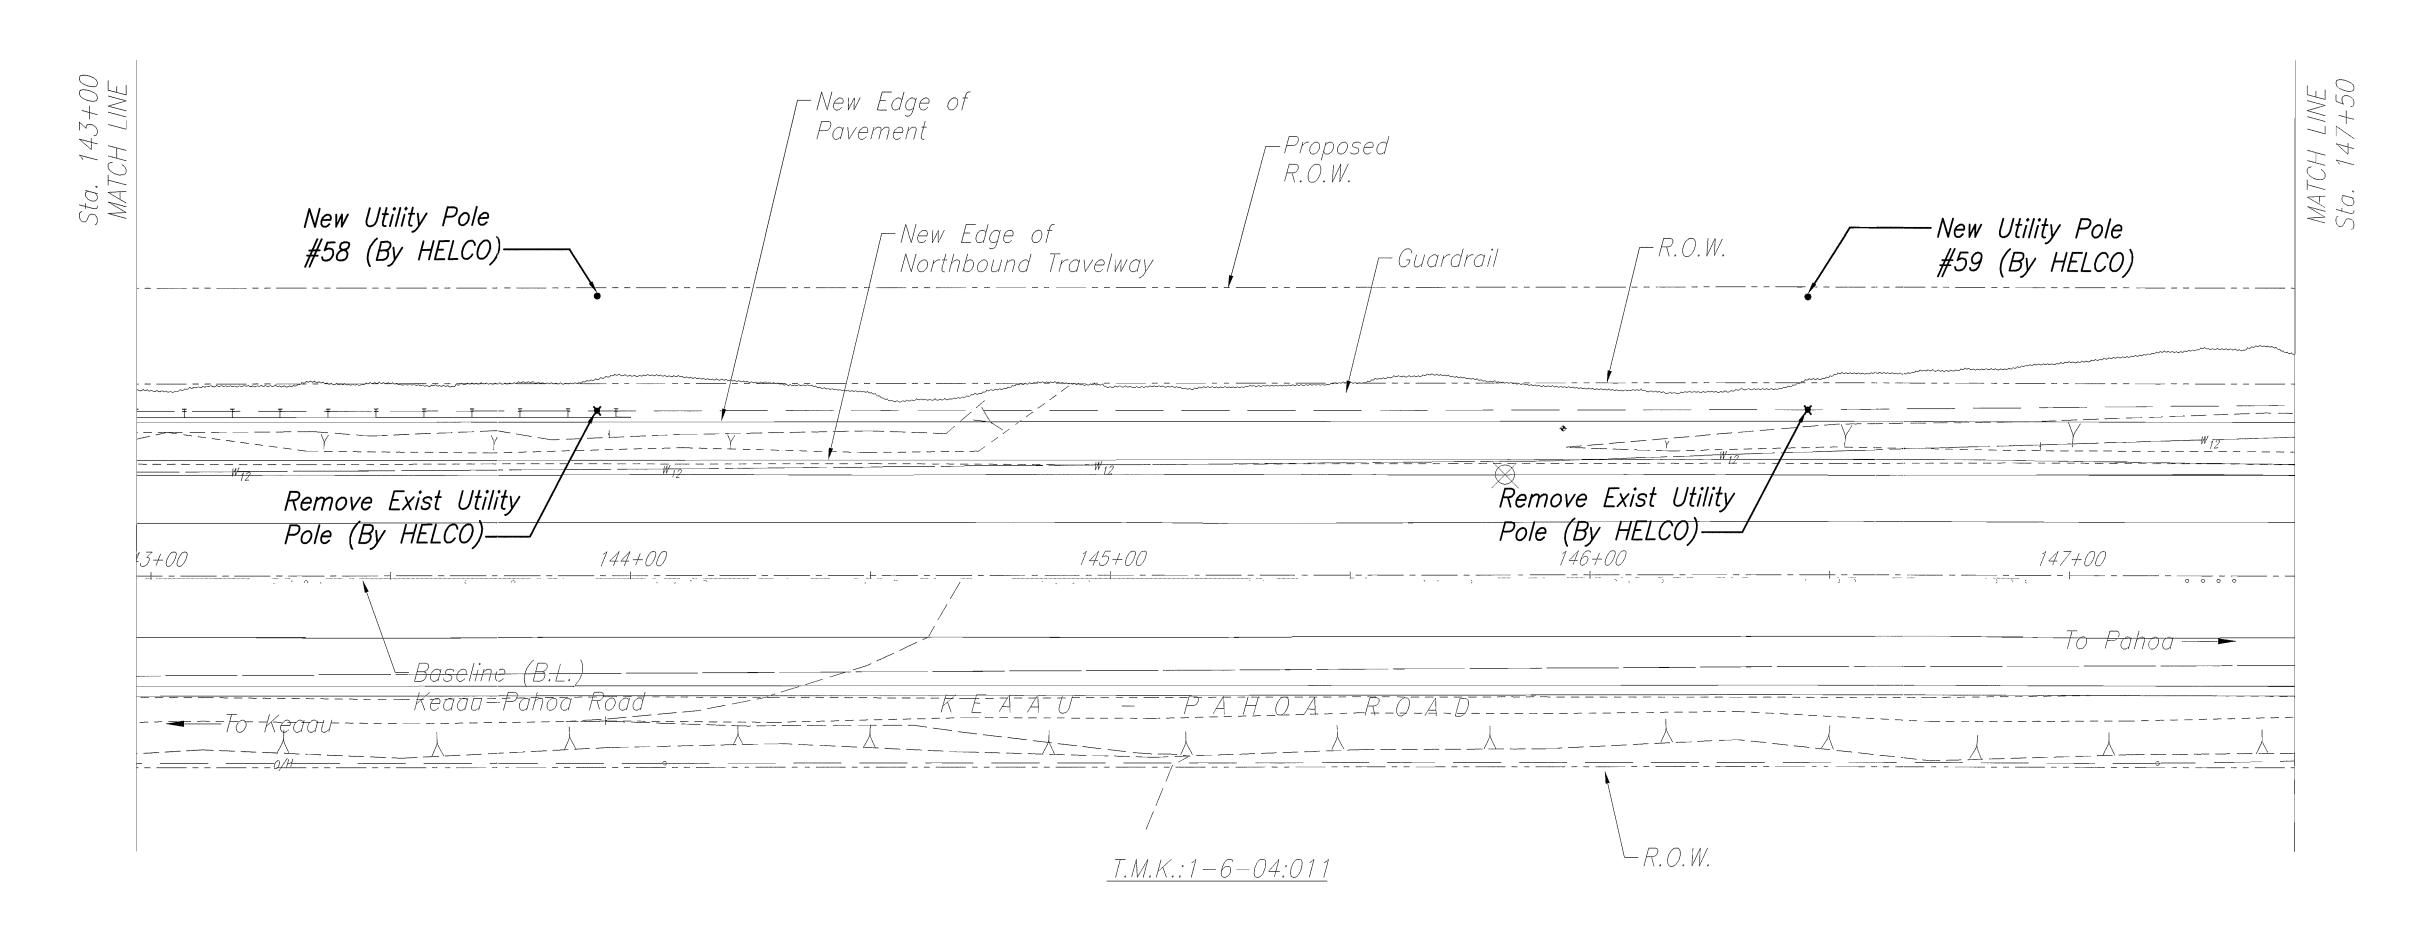

Note: All Utility Poles to be Relocated Within 1' (Preferable) But Not More Than 5' From New ROW. Verify Location With Civil Engineers.



STATE OF HAWAII
DEPARTMENT OF TRANSPORTATION HIGHWAYS DIVISION

SITE ELECTRICAL PLAN

KEAAU-PAHOA ROAD, SHOULDER


LANE CONVERSION, PHASE 1


Keaau Bypass Road to Shower Drive

Fed. Aid Proj. No. STP-0130(28), Phase 1 Scale: 1"=20' June 2012

SHEET No. E-16 OF 25 SHEETS

FED. ROAD DIST. NO.	STATE	FED. AID PROJ. NO.	FISCAL YEAR	SHEET NO.	TOTAL SHEETS
HAWAII	HAW.	STP-0130(28)PH.1	2012	280	288

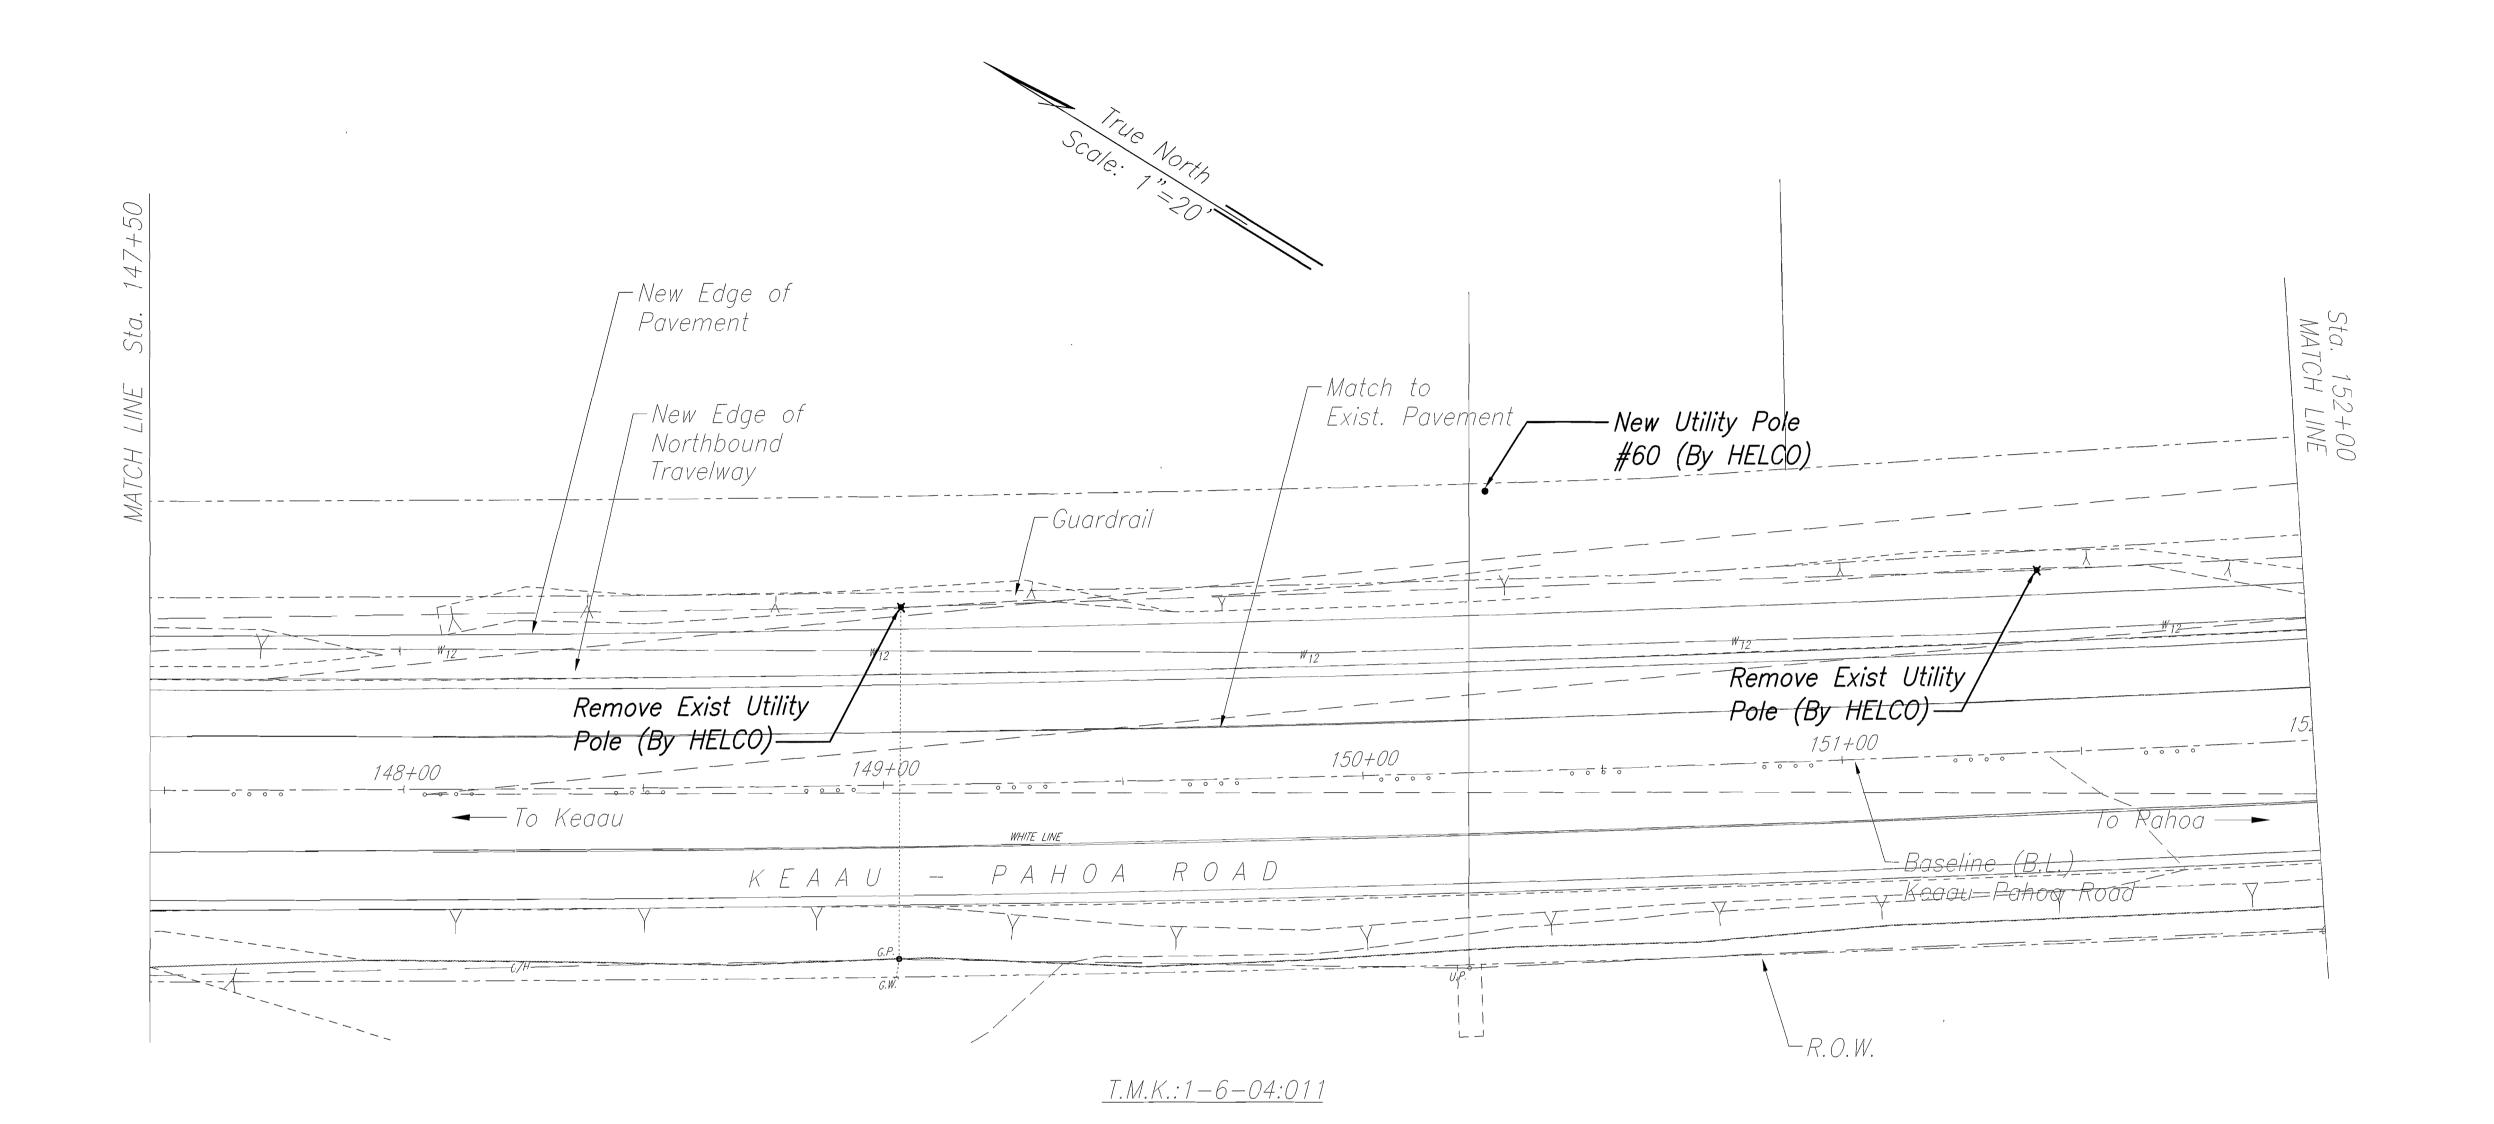

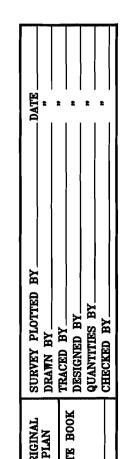



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NAKAMURA, OYAMA & ASSOC. LIC. EXP. DAT

STATE OF HAWAII
DEPARTMENT OF TRANSPORTATION
HIGHWAYS DIVISION

SITE ELECTRICAL PLAN

KEAAU-PAHOA ROAD, SHOULDER


LANE CONVERSION, PHASE 1

Keaau Bypass Road to Shower Drive

Fed. Aid Proj. No. STP-0130(28), Phase 1
Scale: 1"=20' Date: June 2012

SHEET No. E-17 OF 25 SHEETS

FED. ROAD DIST. NO.	STATE	FED. AID PROJ. NO.	FISCAL YEAR	SHEET NO.	TOTAL SHEETS
HAWAII	HAW.	STP-0130(28)PH.1	2012	281	288

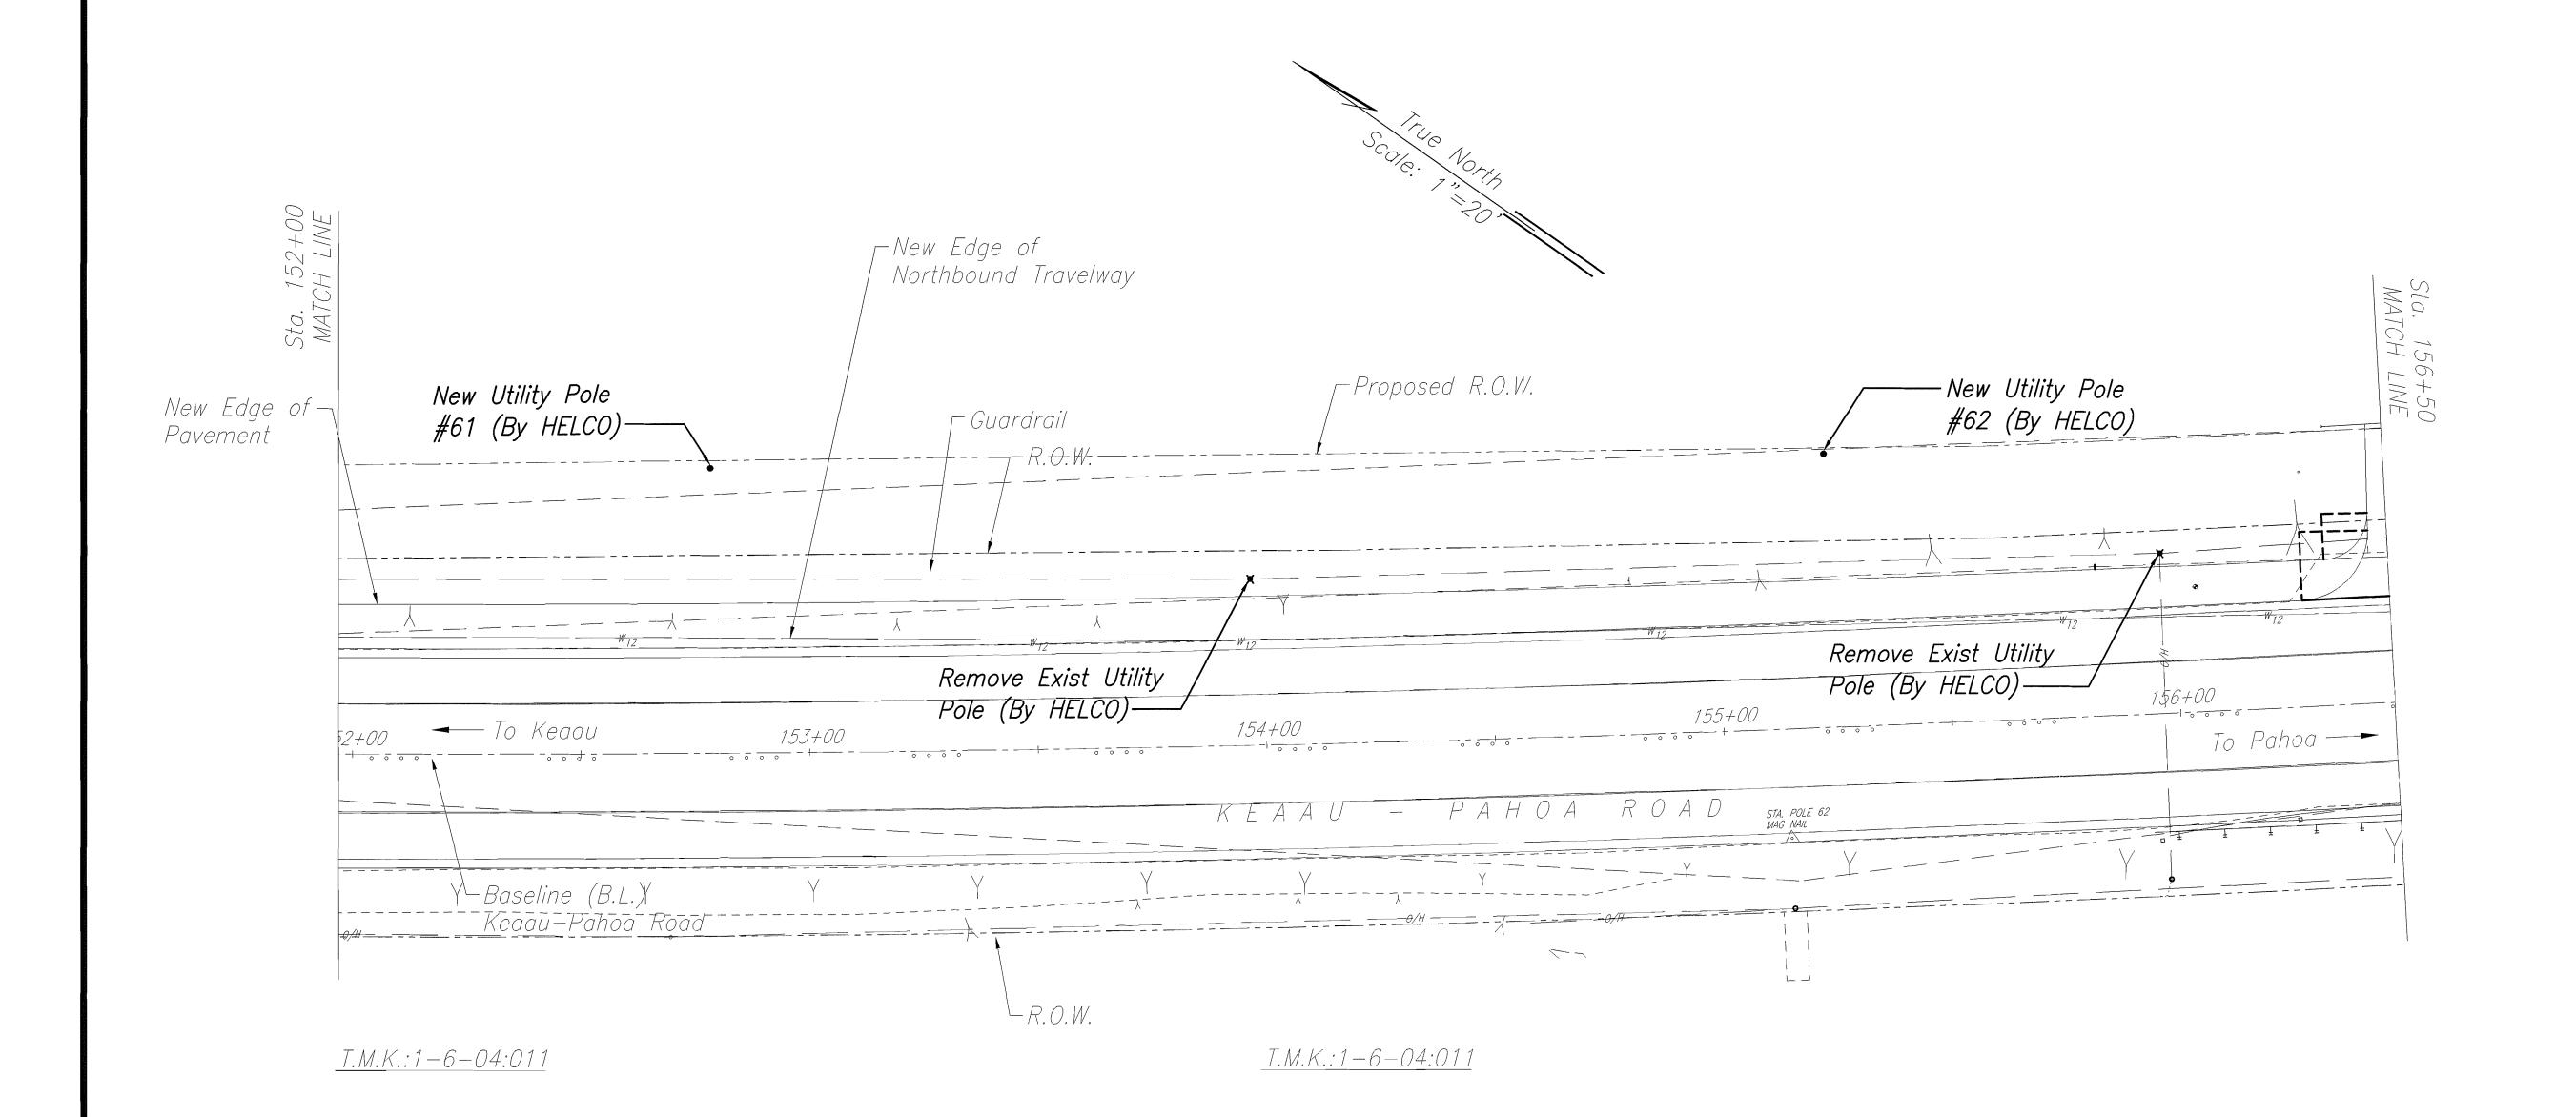

 SURVEY PLOTTED BY
 DATE

 DRAWN BY
 "

 TRACED BY
 "

 DESIGNED BY
 "

 QUANTITIES BY
 "

 CHECKED BY
 "

<u>Note:</u> All Utility Poles to be Relocated Within 1' (Preferable) But Not More Than 5' From New ROW. Verify Location With Civil Engineers.



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Makamura, Oyama & ASSOC, LIC, FXP, DAT

STATE OF HAWAII
DEPARTMENT OF TRANSPORTATION
HIGHWAYS DIVISION

SITE ELECTRICAL PLAN


KEAAU-PAHOA ROAD, SHOULDER

LANE CONVERSION, PHASE 1

Keaau Bypass Road to Shower Drive

Keaau Bypass Road to Shower Drive
Fed. Aid Proj. No. STP-0130(28), Phase 1
Scale: 1"=20' Date: June 2012

SHEET No. E-18 OF 25 SHEETS

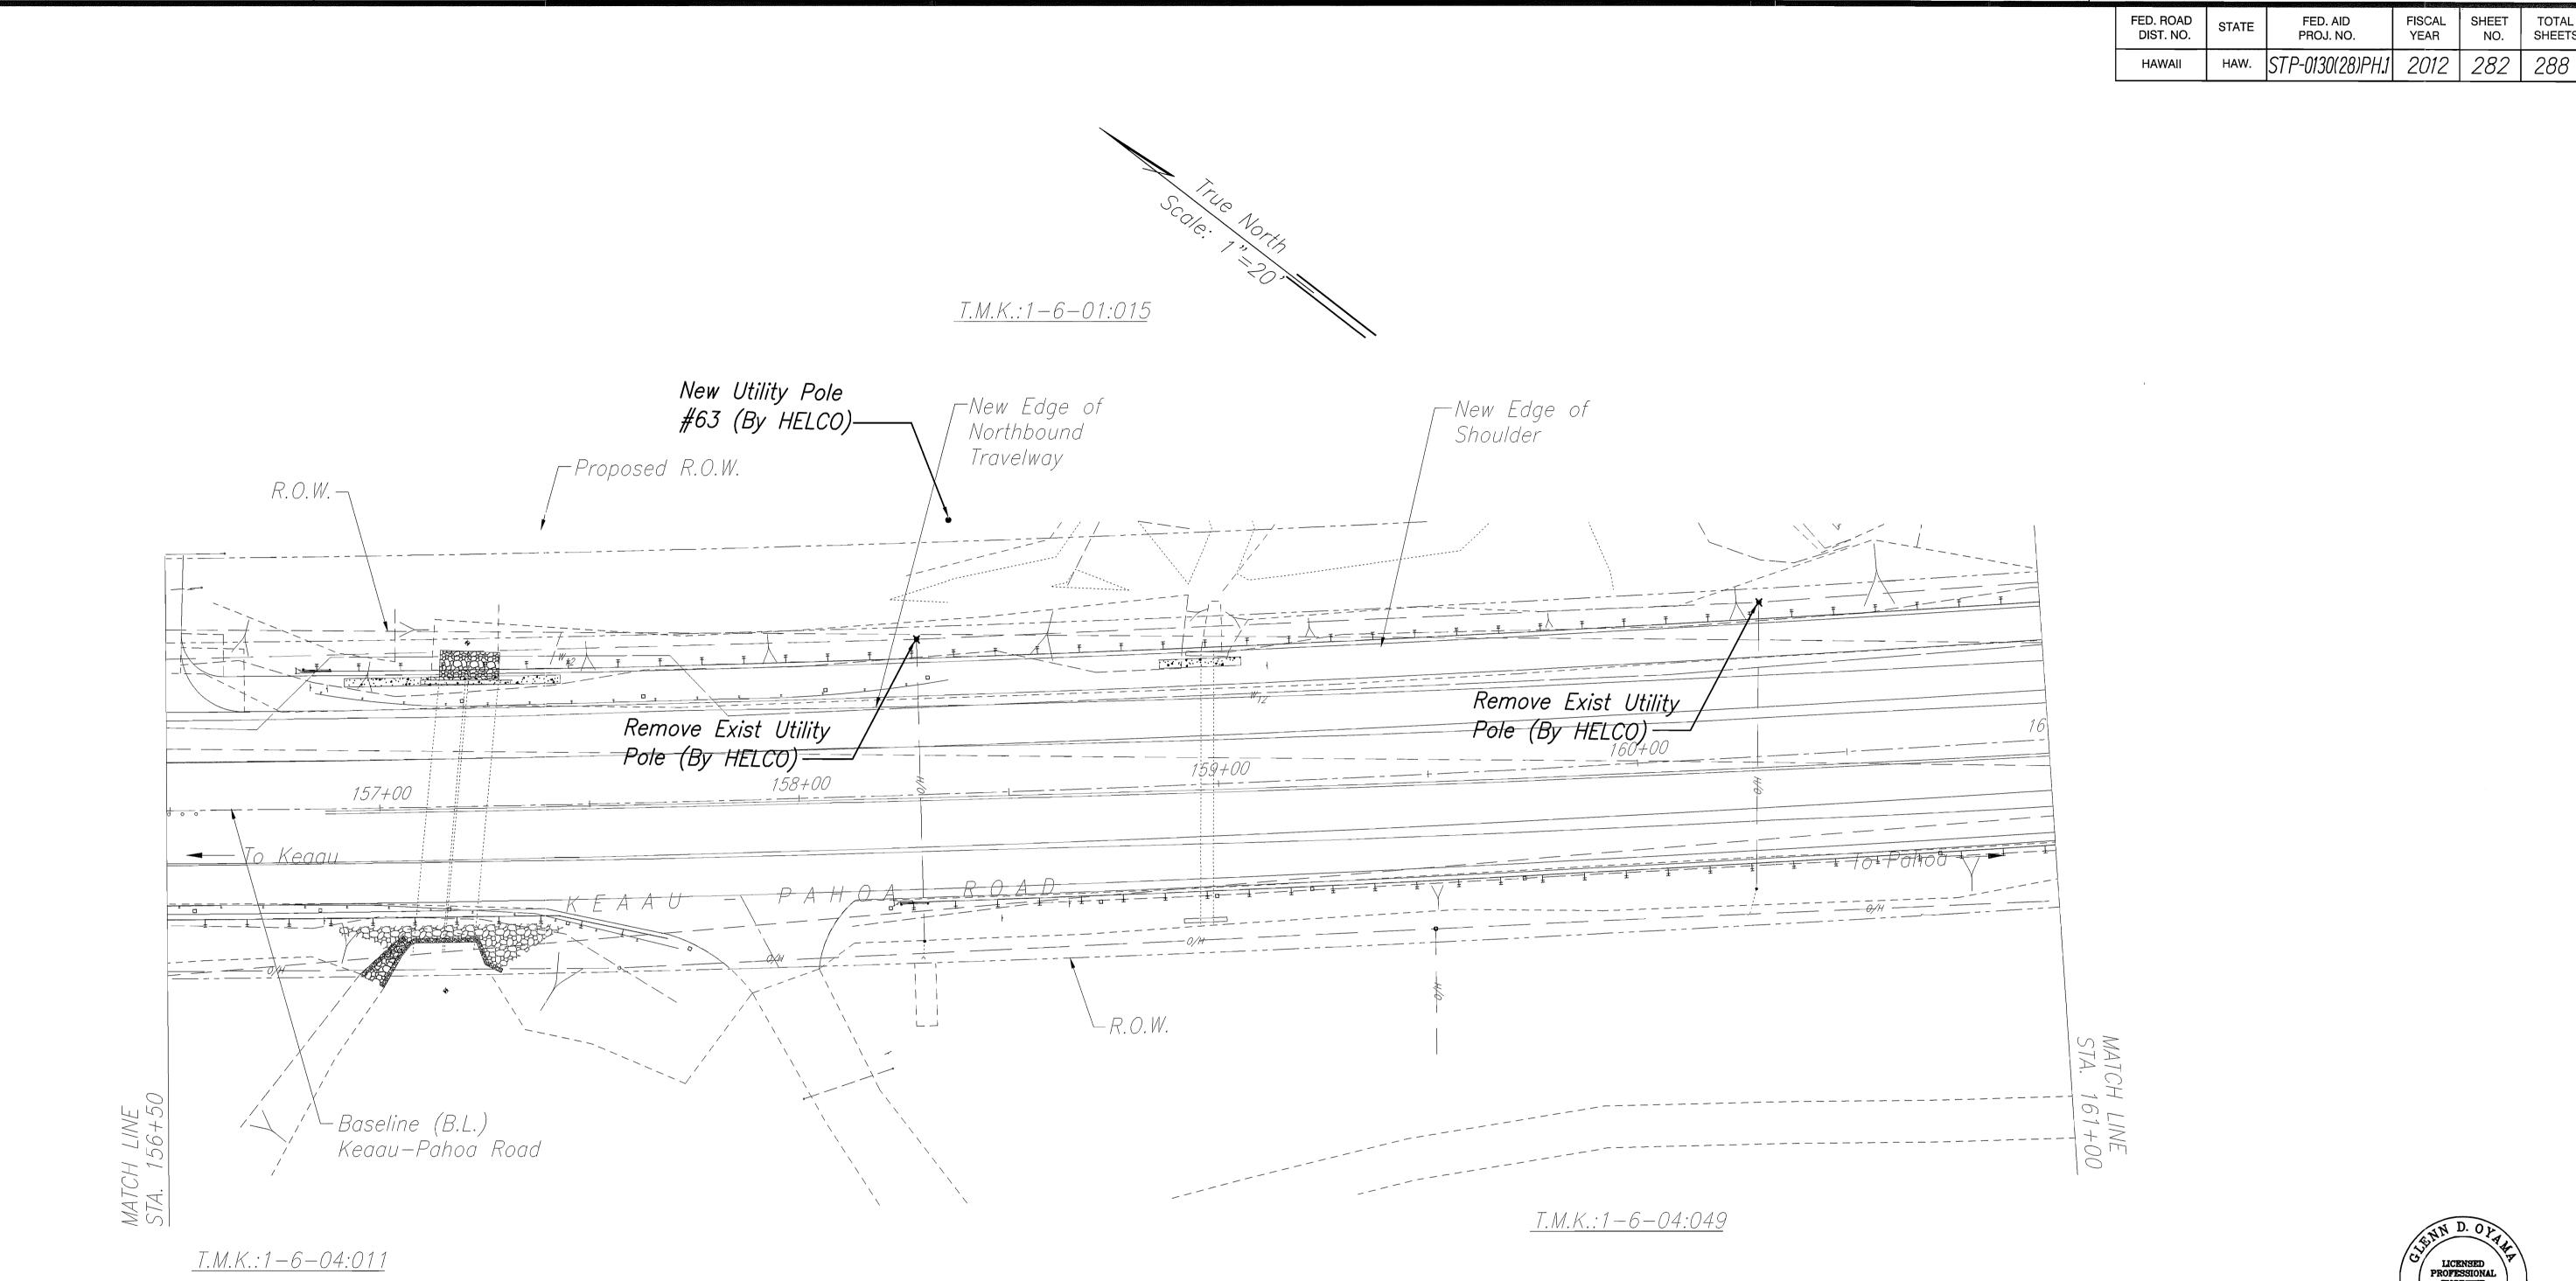



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STATE OF HAWAII
DEPARTMENT OF TRANSPORTATION HIGHWAYS DIVISION

SITE ELECTRICAL PLAN

FED. AID PROJ. NO.

FISCAL YEAR


KEAAU-PAHOA ROAD, SHOULDER


LANE CONVERSION, PHASE 1


Keaau Bypass Road to Shower Drive

Fed. Aid Proj. No. STP-0130(28), Phase 1
Scale: 1"=20' Date: June 2012 June 2012

SHEET No. E-19 OF 25 SHEETS

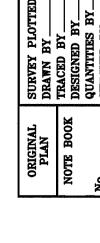

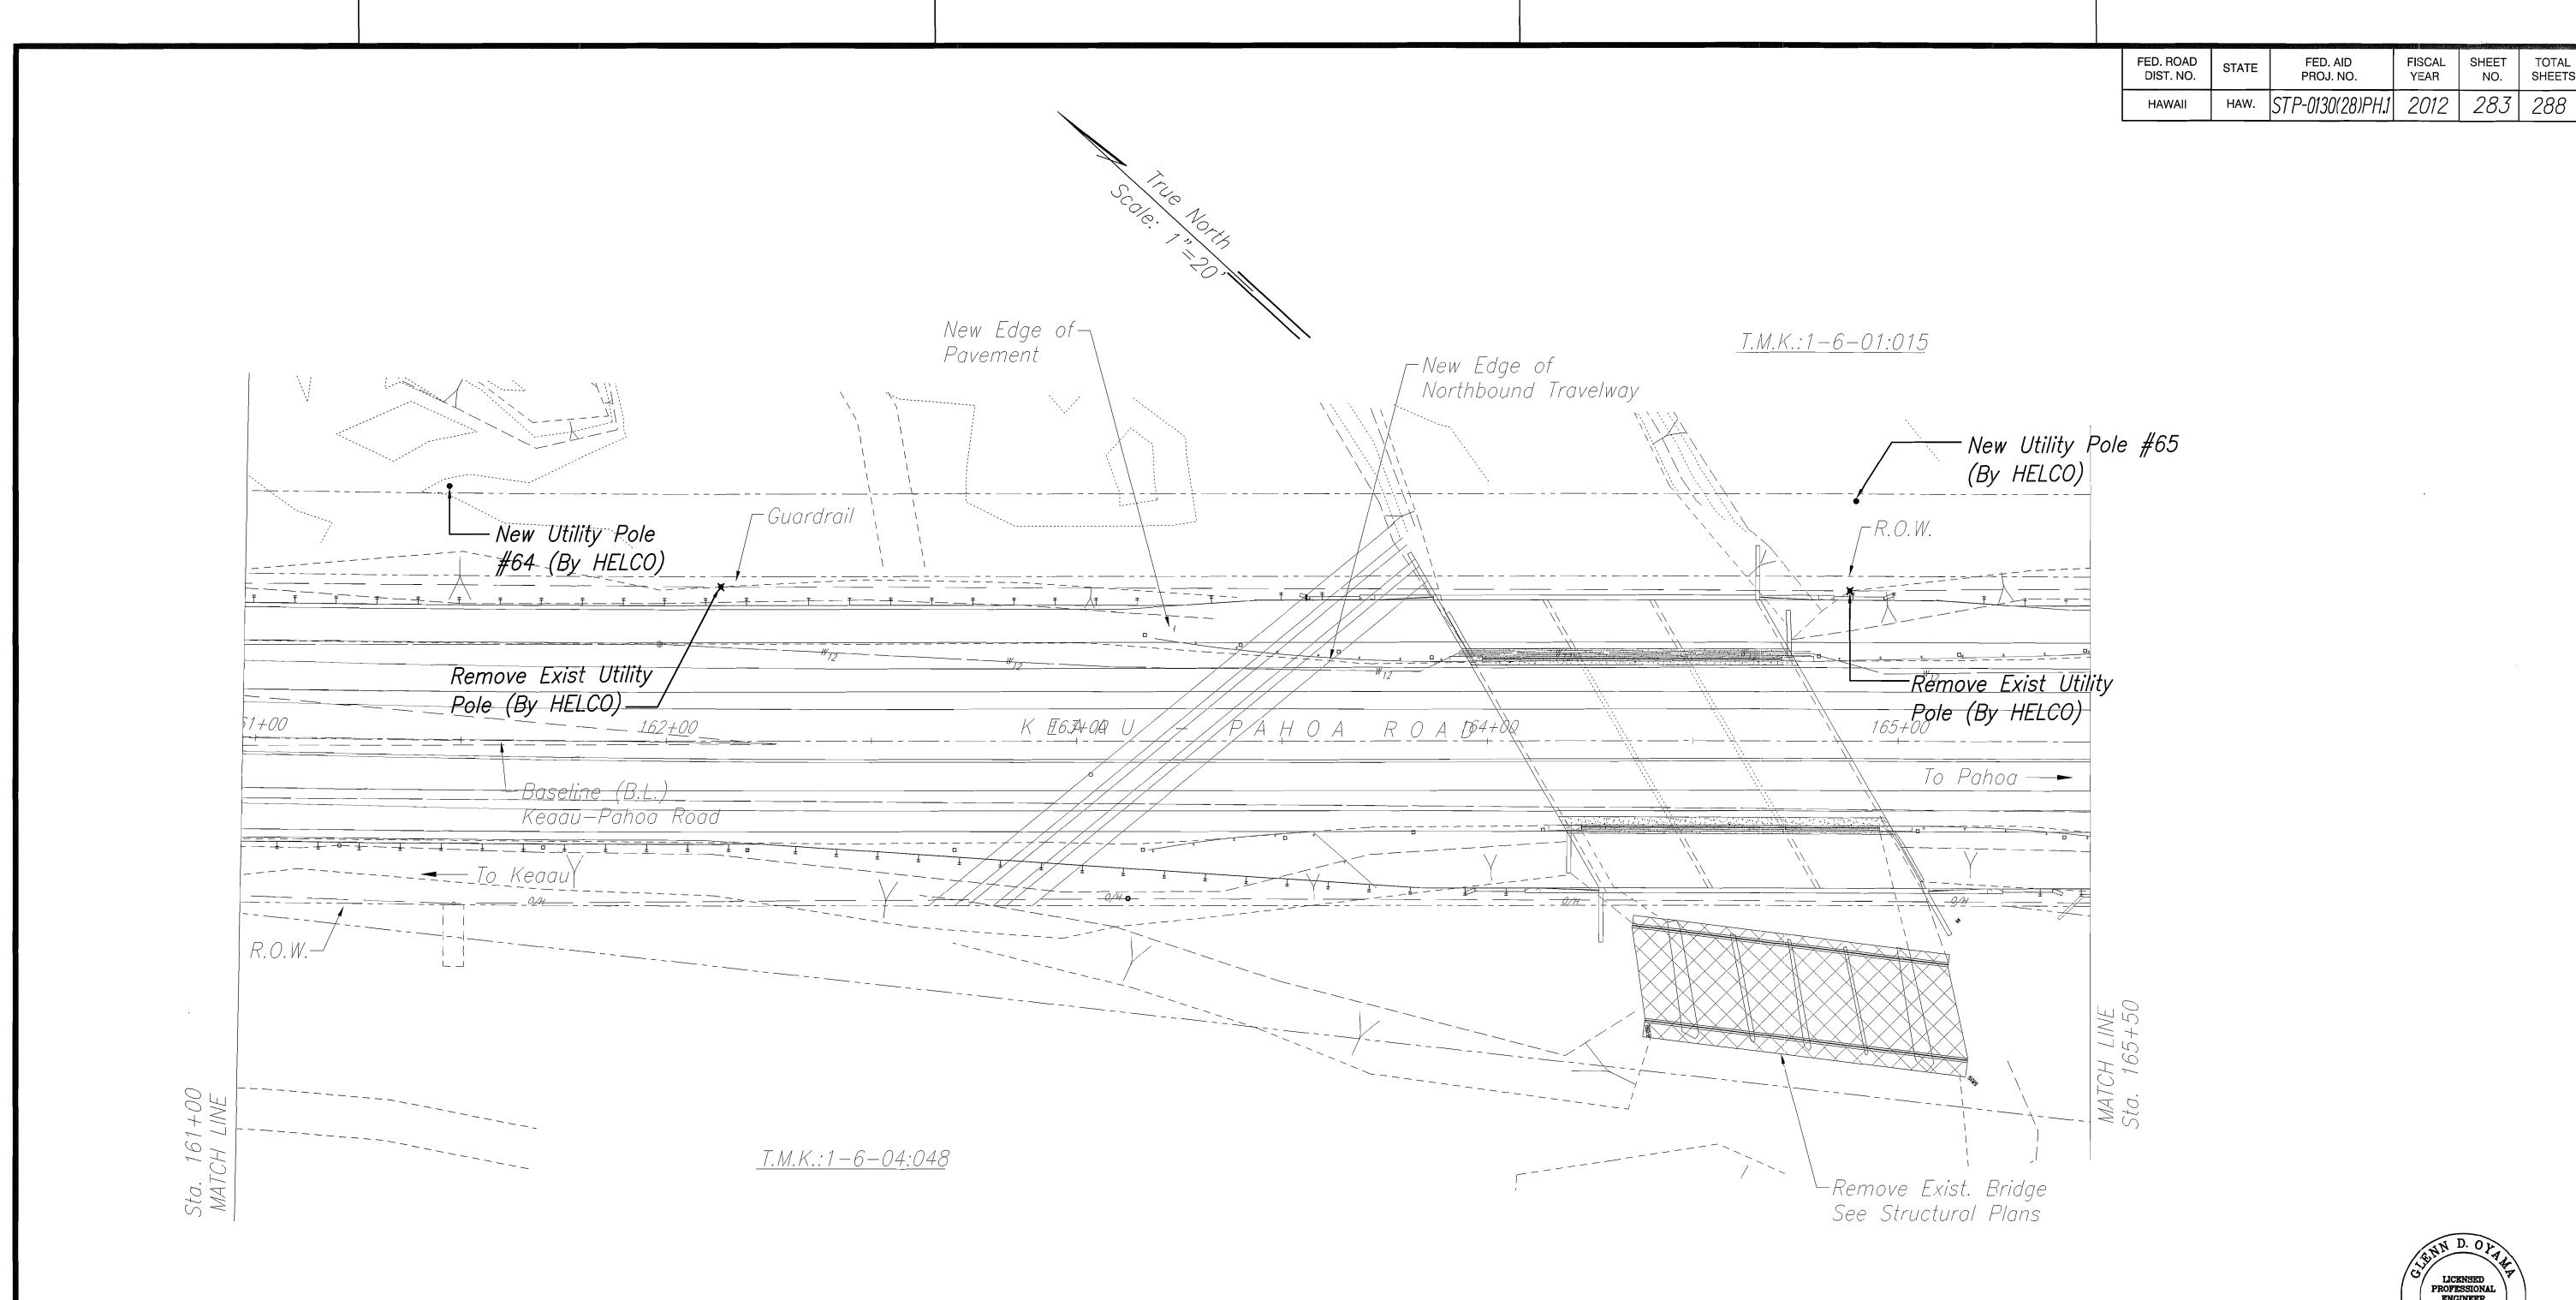

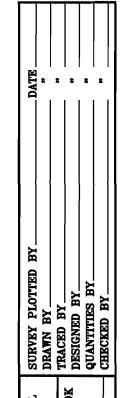



FISCAL SHEET TOTAL YEAR NO. SHEETS

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STATE OF HAWAII
DEPARTMENT OF TRANSPORTATION HIGHWAYS DIVISION

SITE ELECTRICAL PLAN


KEAAU-PAHOA ROAD, SHOULDER


LANE CONVERSION, PHASE 1

Keaau Bypass Road to Shower Drive

Fed. Aid Proj. No. STP-0130(28), Phase Scale: 1"=20' June 2012 Date:

SHEET No. E-20 of 25 sheets

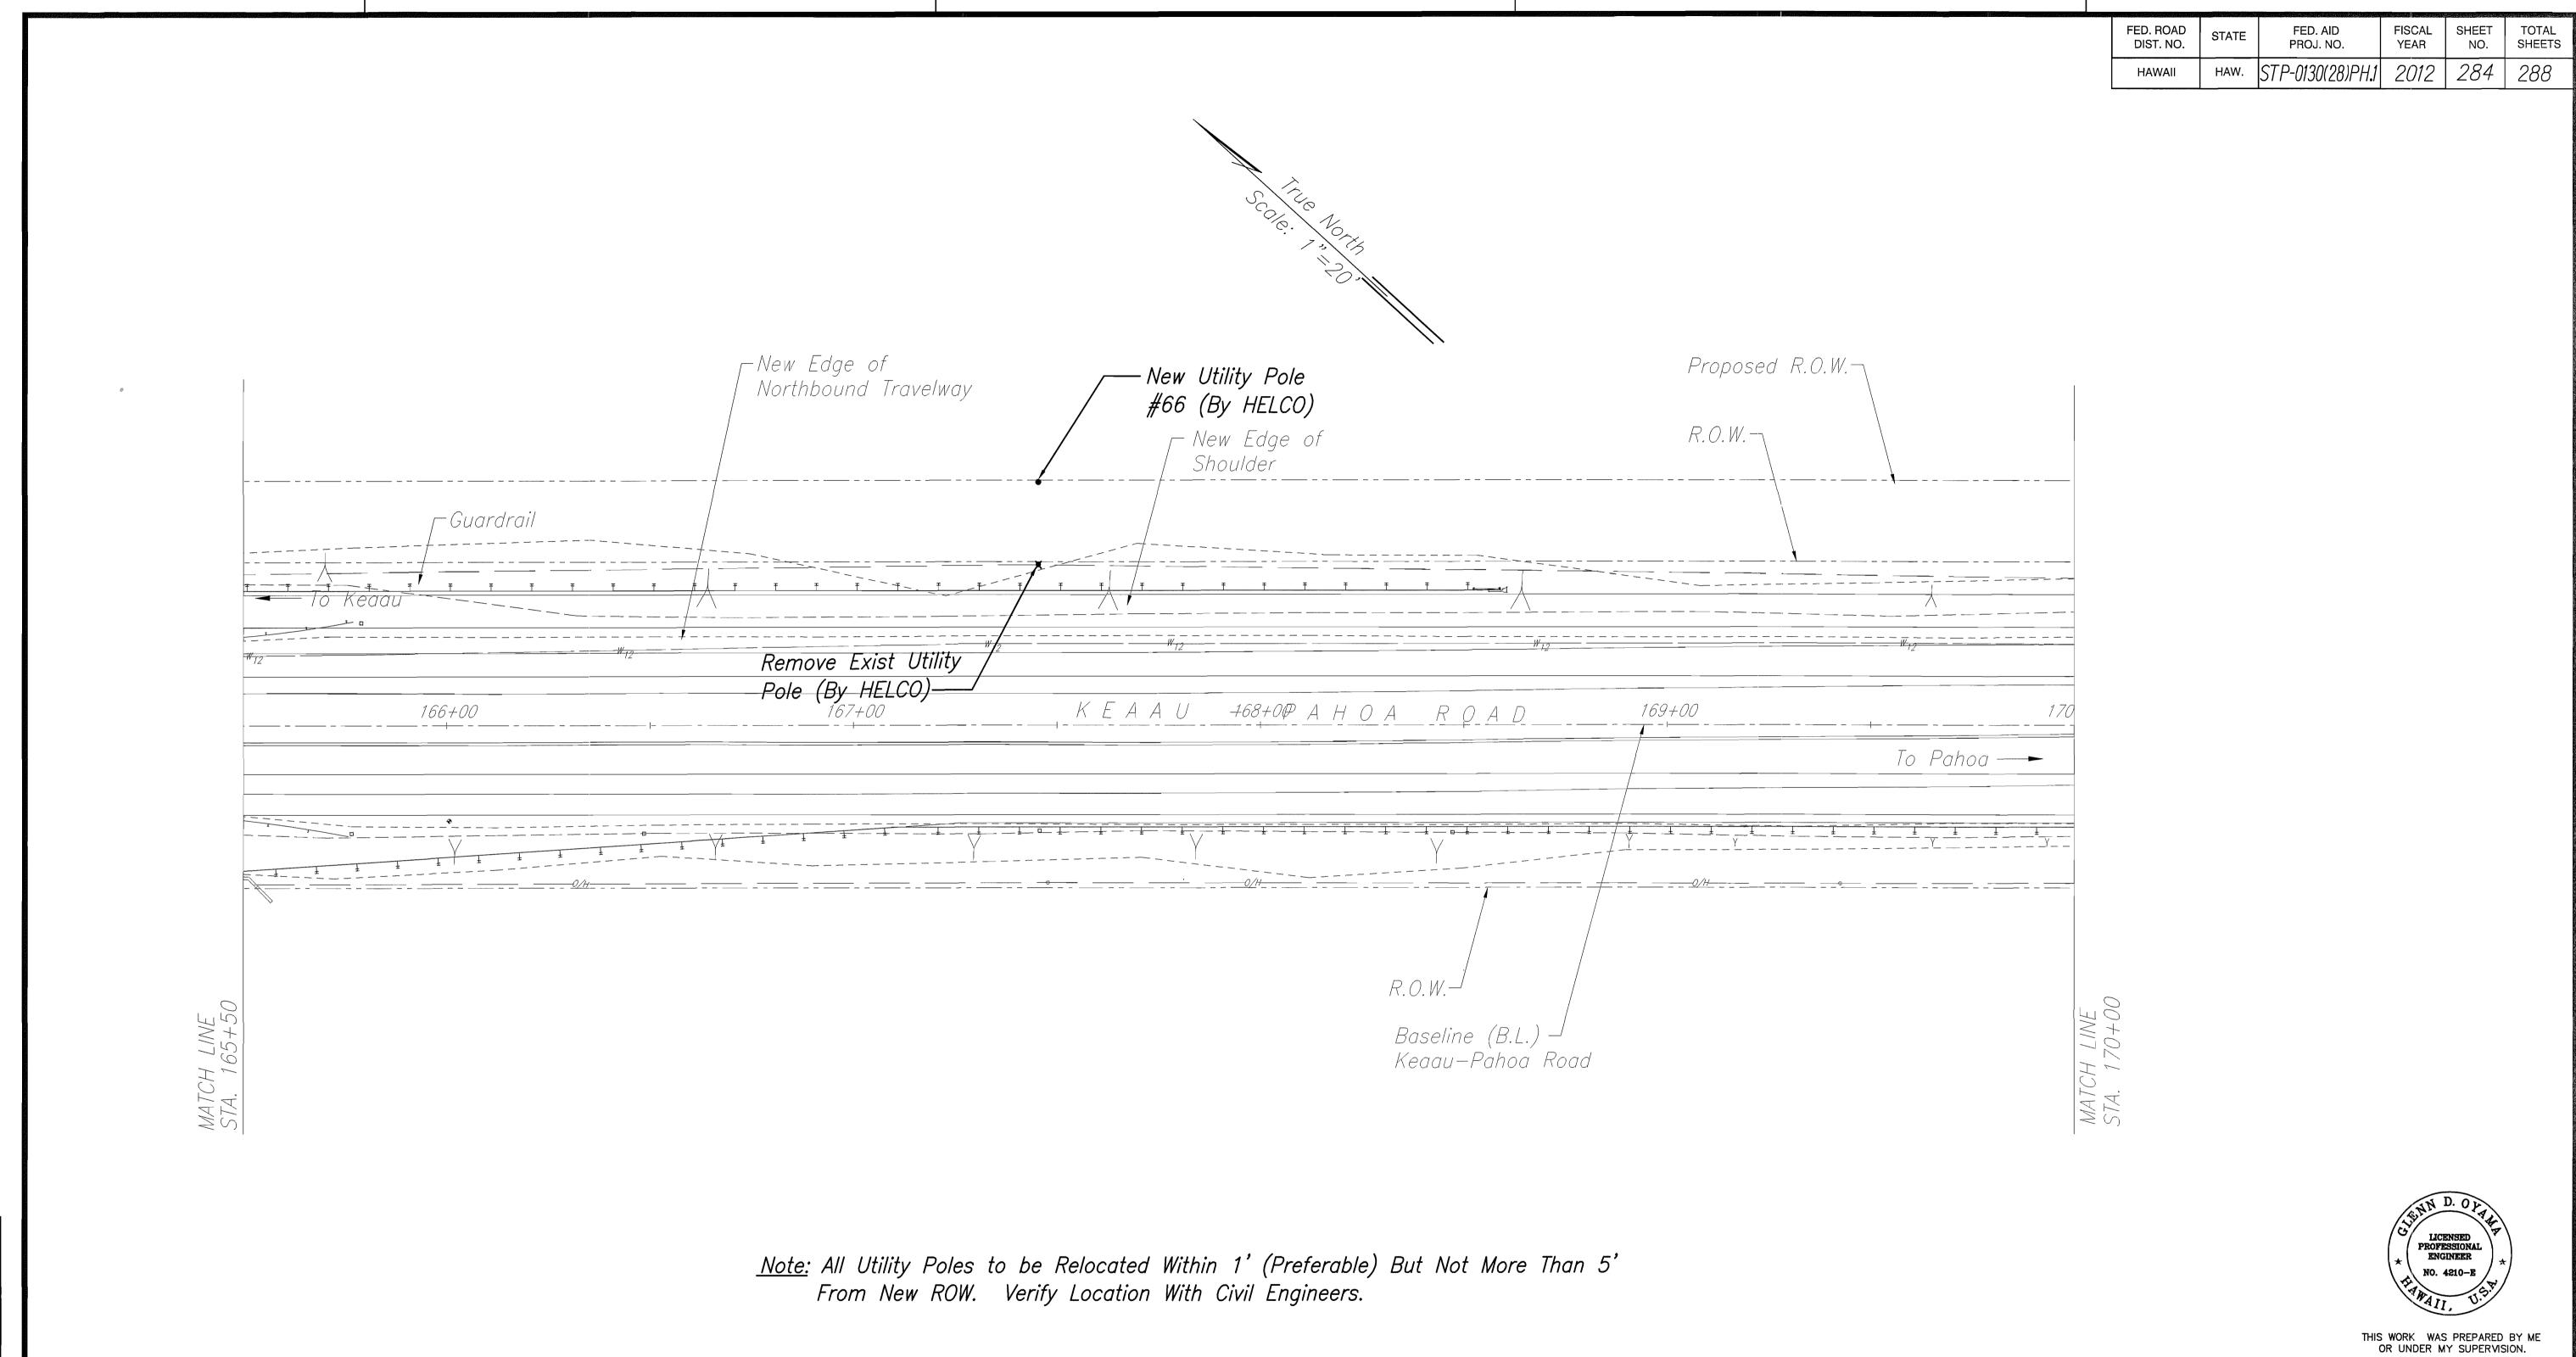

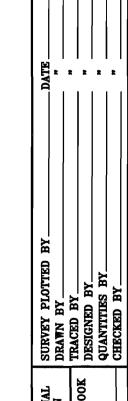

STATE OF HAWAII
DEPARTMENT OF TRANSPORTATION HIGHWAYS DIVISION

SITE ELECTRICAL PLAN


KEAAU-PAHOA ROAD, SHOULDER

LANE CONVERSION, PHASE 1

Keaau Bypass Road to Shower Drive Fed. Aid Proj. No. STP-0130(28), Phase 1 Scale: 1"=20' Date: June 2012

SHEET No. E-21 OF 25 SHEETS

FED. ROAD DIST. NO.	STATE	FED. AID PROJ. NO.	FISCAL YEAR	SHEET NO.	TOTAL SHEETS
HAWAII	HAW.	STP-0130(28)PH.1	2012	285	288

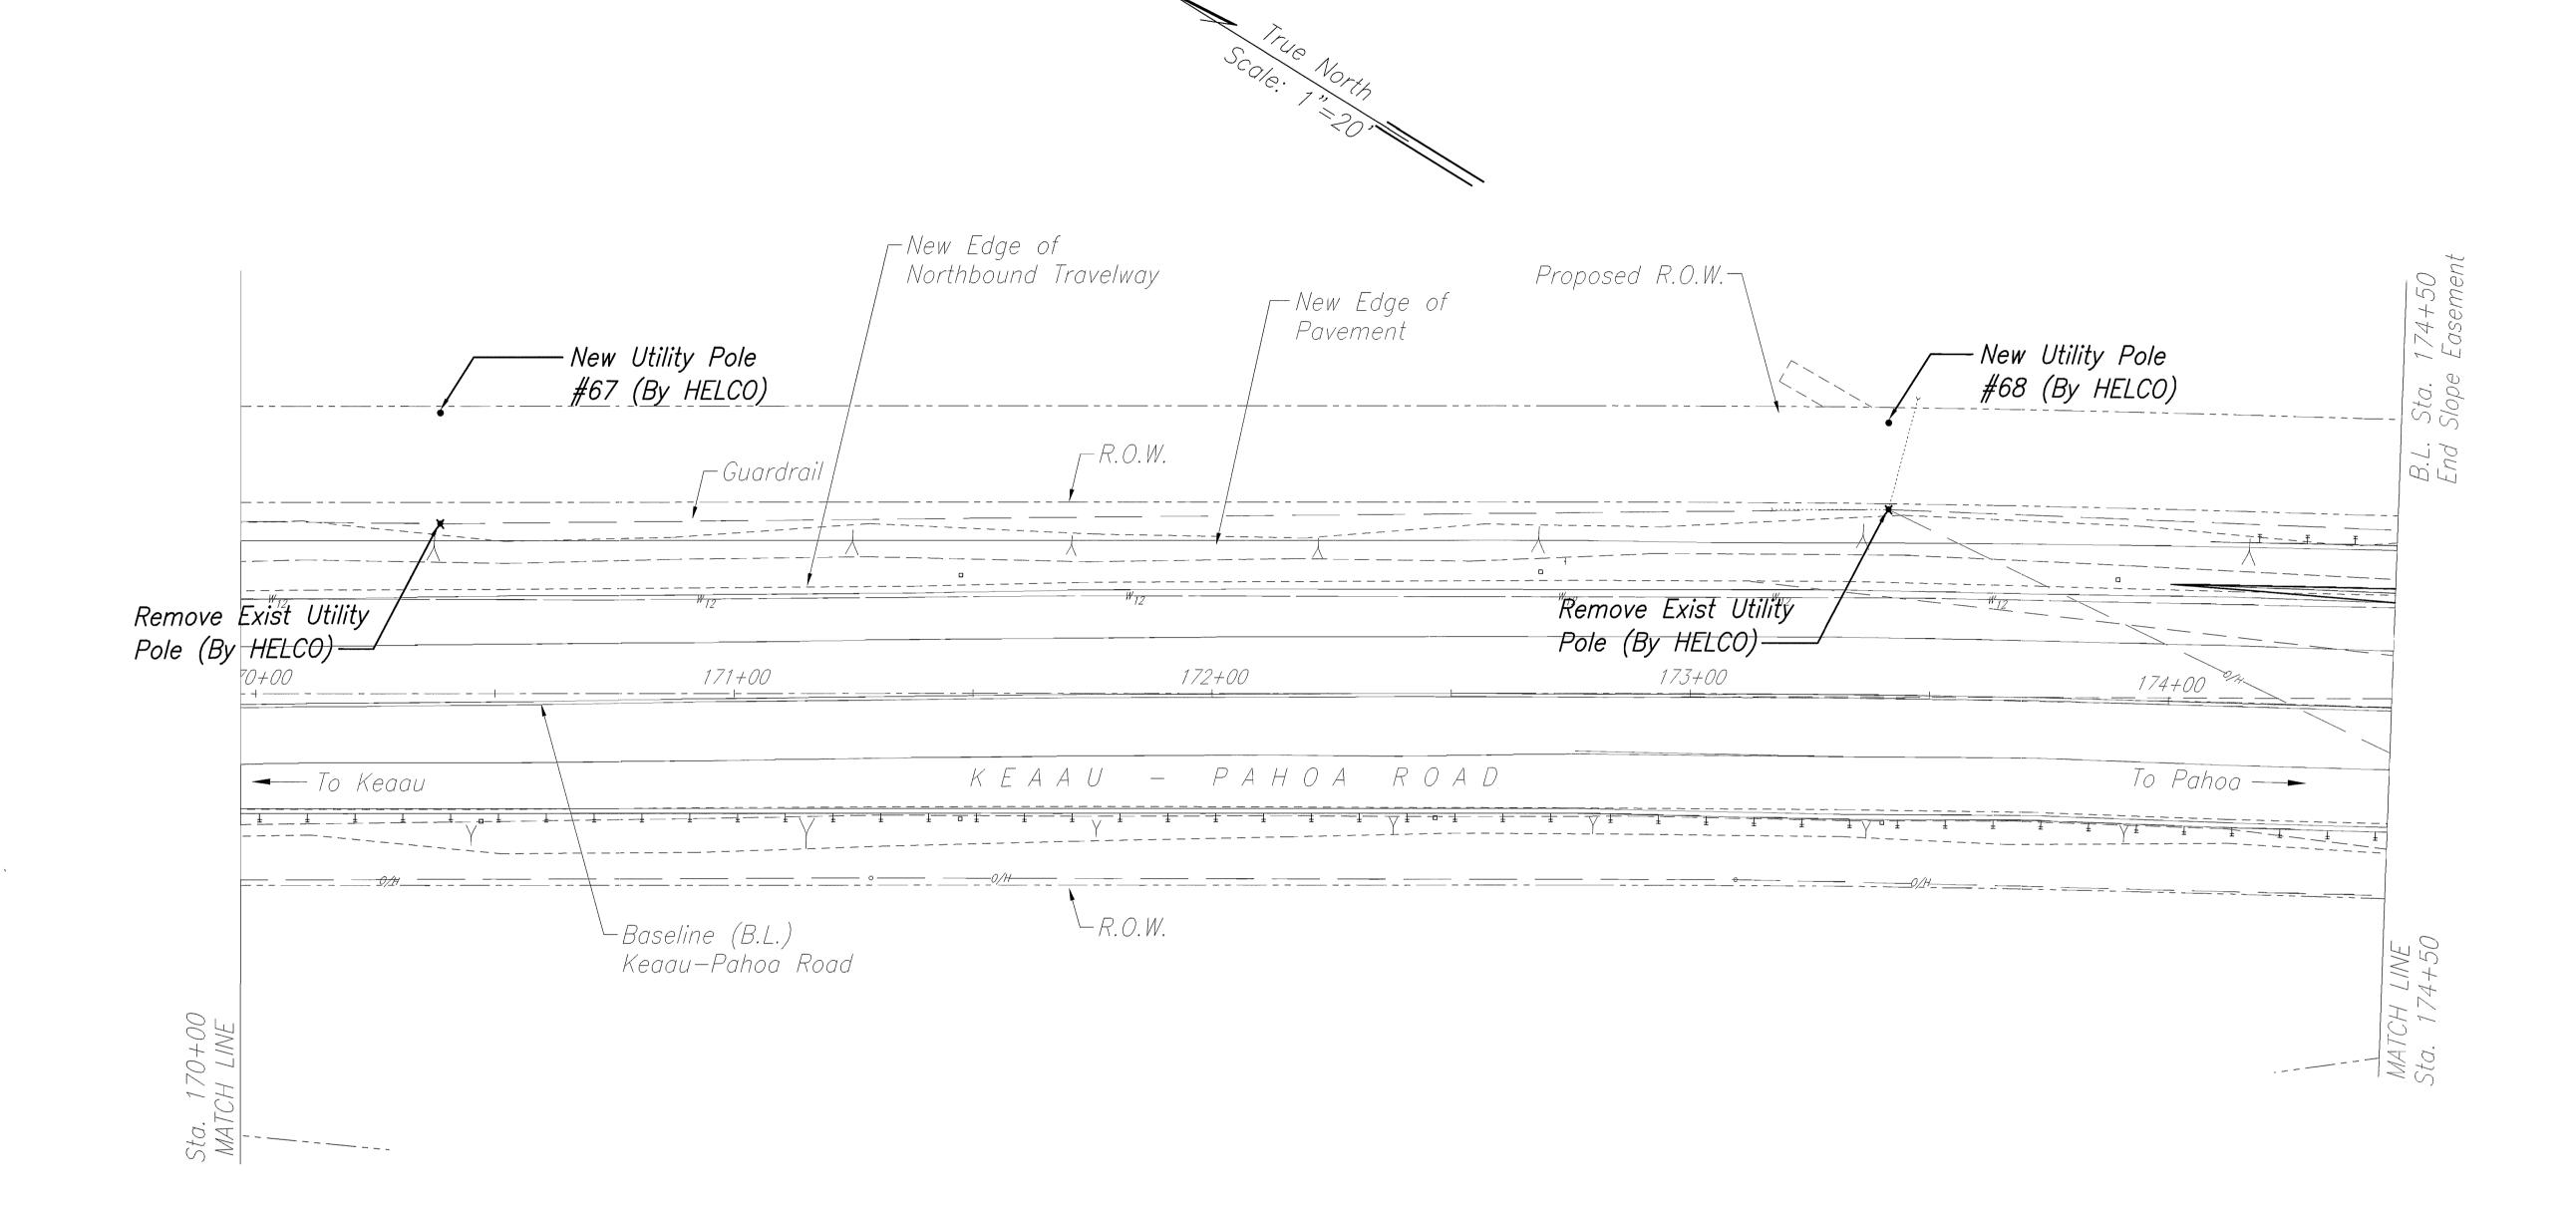

<u>Note:</u> All Utility Poles to be Relocated Within 1' (Preferable) But Not More Than 5'

From New ROW. Verify Location With Civil Engineers.

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STATE OF HAWAII
DEPARTMENT OF TRANSPORTATION HIGHWAYS DIVISION

SITE ELECTRICAL PLAN


KEAAU-PAHOA ROAD, SHOULDER


LANE CONVERSION, PHASE 1

Keaau Bypass Road to Shower Drive

Fed. Aid Proj. No. STP-0130(28), Phase 1
Scale: 1"=20' Date: June 2012

SHEET No. E-22 OF 25 SHEETS

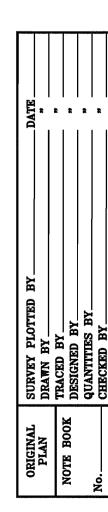

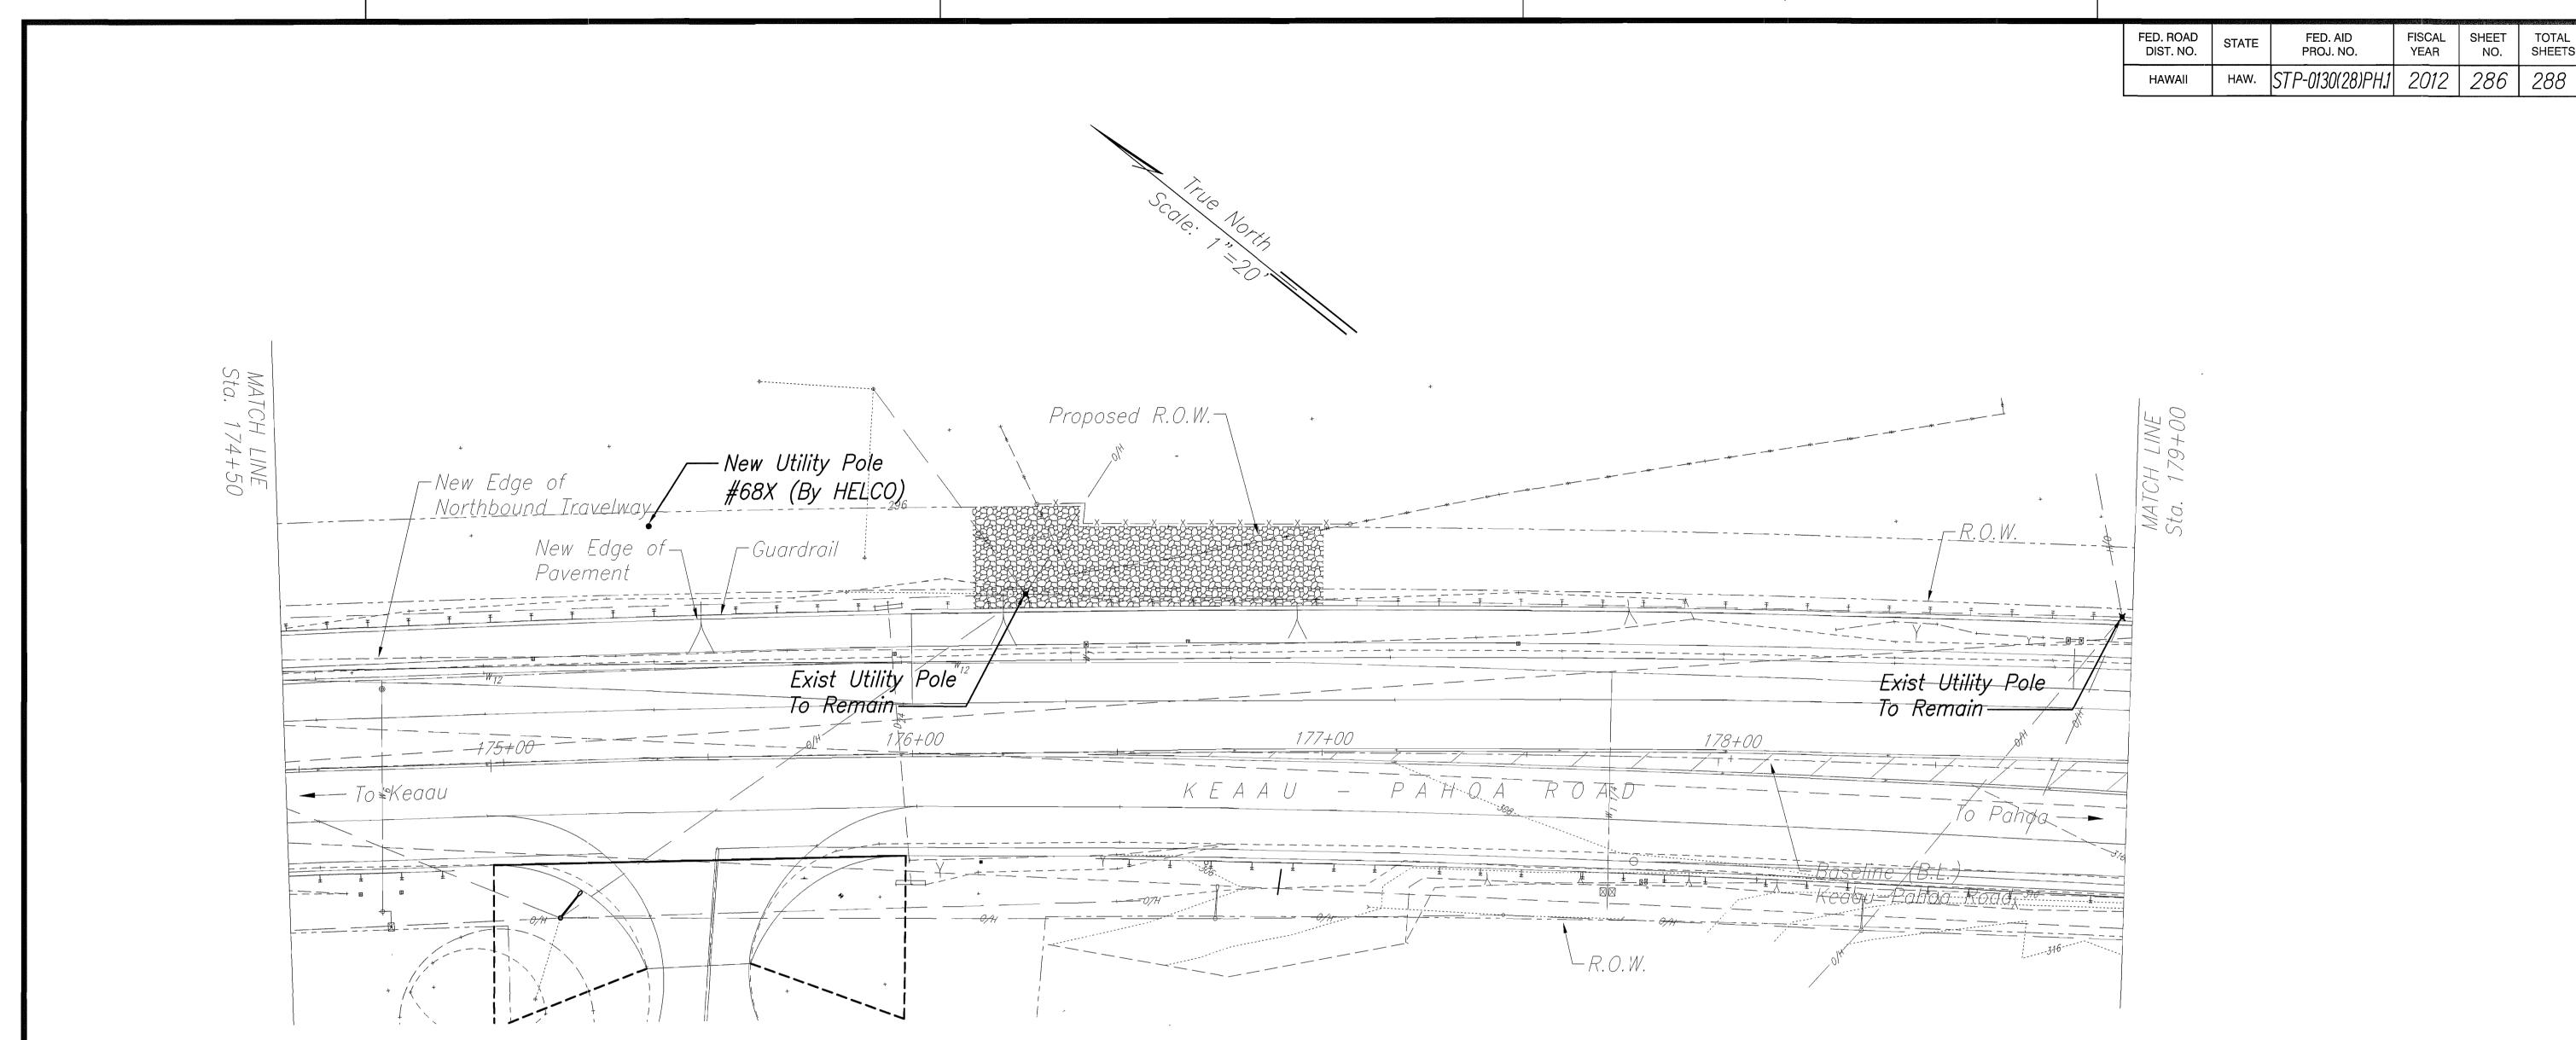



FISCAL SHEET YEAR NO.

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STATE OF HAWAII
DEPARTMENT OF TRANSPORTATION HIGHWAYS DIVISION

SITE ELECTRICAL PLAN


KEAAU-PAHOA ROAD, SHOULDER

LANE CONVERSION, PHASE 1


Keaau Bypass Road to Shower Drive

Fed. Aid Proj. No. STP-0130(28), Phase 1
Scale: 1"=20' Date: June 2012

SHEET No. E-23 OF 25 SHEETS

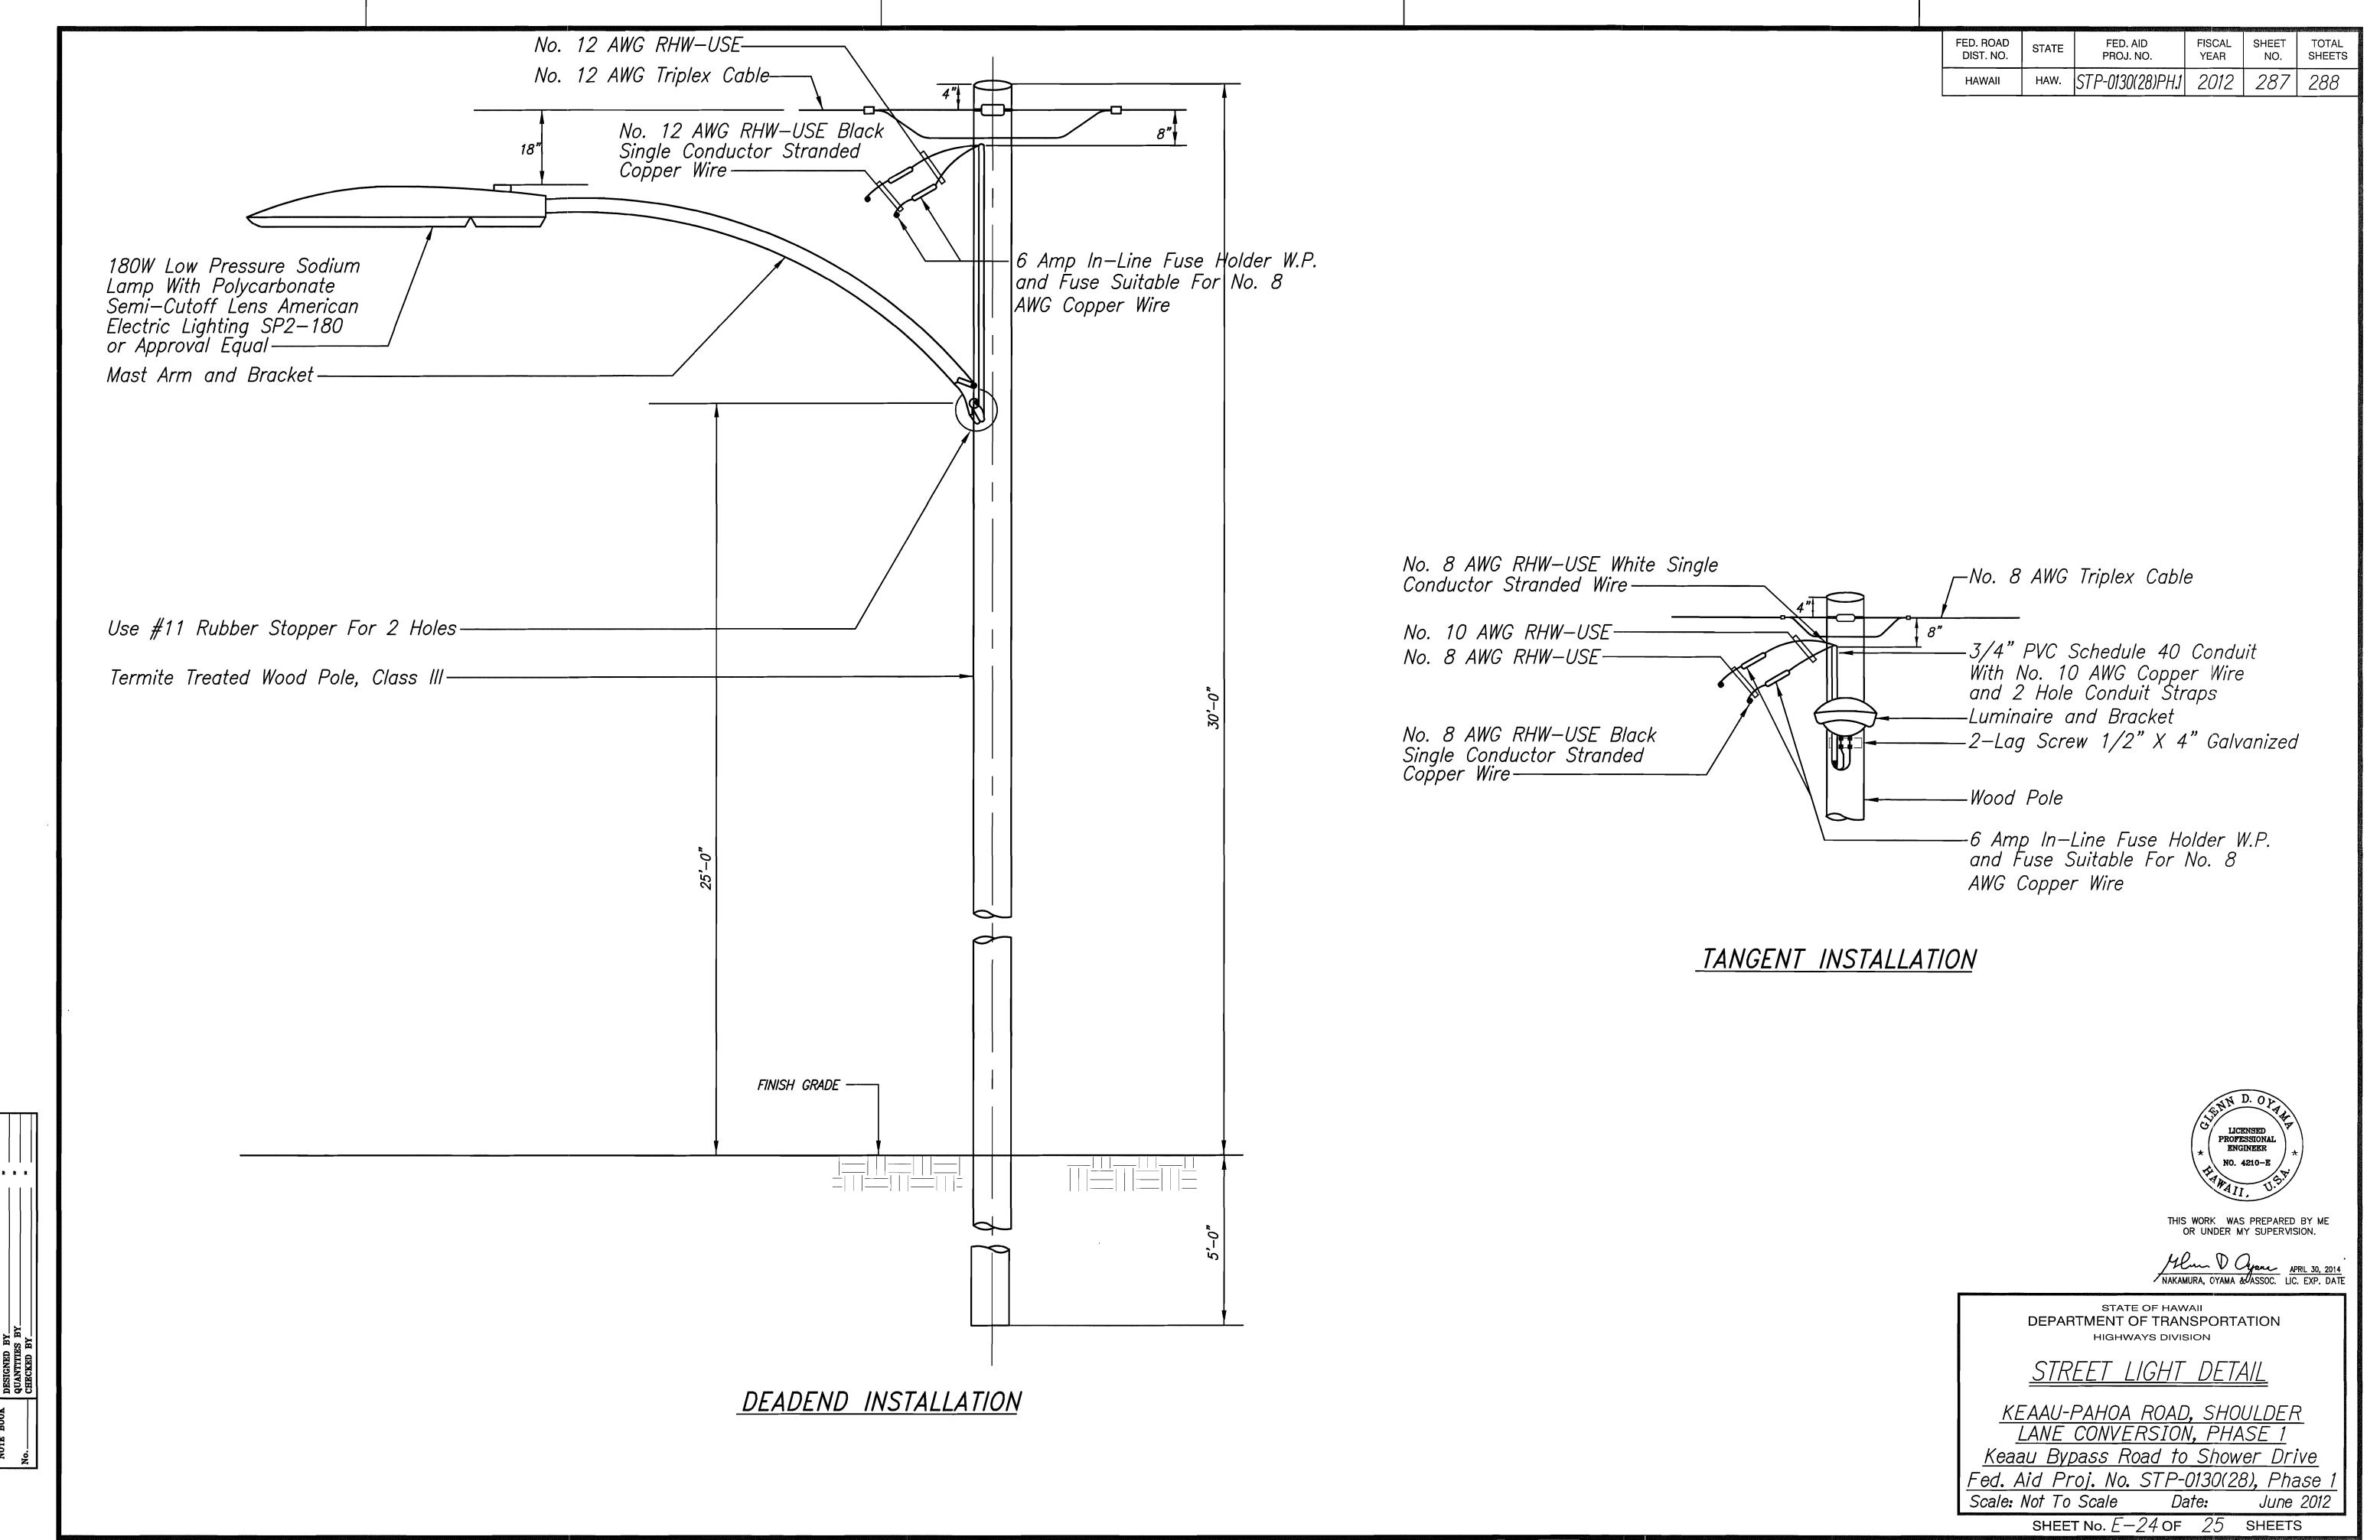

FED. ROAD DIST. NO. STATE FED. AID PROJ. NO. FISCAL YEAR NO. SHEETS NO. SHEETS NO. STP-0130(28)PH.1 2012 288 288

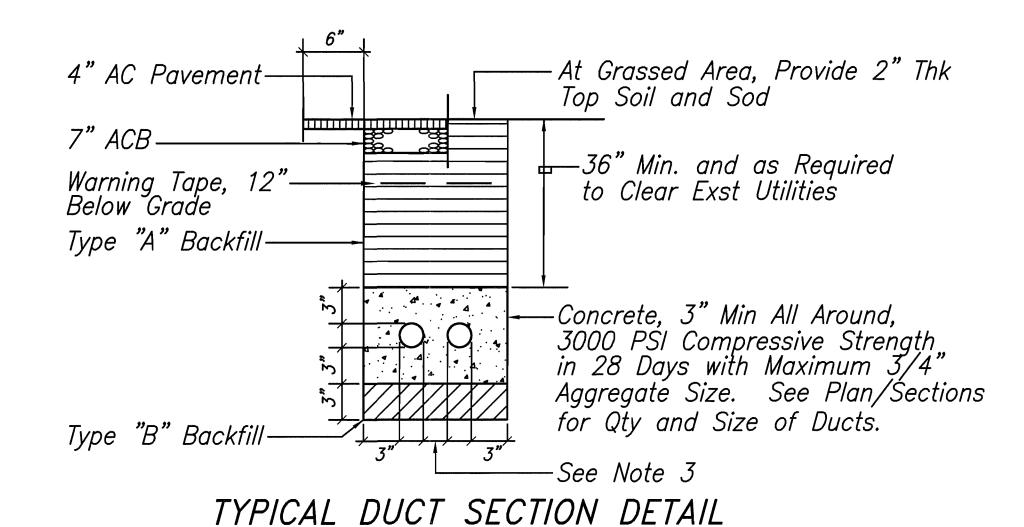

Duct Section Notes:

- 1. All Ducts Shall Be Schedule 40 PVC or Equivalent & Provided with a Polyolefin Pull Line.
- 2. <u>Backfill Data:</u>


<u>Type "A" Backfill:</u> Earth & Gravel, Maximum Rock Size Shall Be 1" and the Mixture Shall Contain Not More Than 50% by Volume of Rock Particles, 95% Compaction. Install Type "A" Backfill in Maximum 6" Layers Loose Thickness Prior to Compaction.

<u>Type "B" Backfill:</u> Earth & Gravel, Mixture Must Pass a 1/2" Mesh Screen & Contain not More Than 20% by Volume of Rock Particles, 95% Compaction. If Materials at Bottom of Trench Is Not Type "B", an Additional 3" Shall Be Excavated and Type "B" Backfill Provided.


- 3. <u>Duct Separation Requirements:</u>

 - Signal/Comm to Signal/Comm...... 2"
- 4. See Plans or Diagrams for Size & Number of Ducts. Flatten Duct Bank as Required to Pass Over or Under Existing and New Utilities.
- 5. Comply With HELCO, Hawaiian Telcom & Oceanic Time Warner Cable Utility Company Requirements.

 Perform a Mandrel Test After Ducts Are Installed.
- 6. Excess Excavated Material Shall Be Hauled and Disposed by the Contractor.
- 7. It Is Not the Intent of These Plans and Specifications to Imply That All Existing Utilities Are Shown on the Plans. Only Those Known to Exist by the Engineer from His Search of Records at the Time of Design Are Indicated on These Plans.
- 8. Investigate, Probe, and Tone Traverse of New Ductline. Expose, Locate and Protect the Existing Underground Utilities Including Irrigation, Drainage, Sewage, Electrical, Communication and System Lines Affected by This Project.
- 9. Operate the Existing Irrigation, Drainage, Sewage, Electrical, Communication and Water Systems to Help Determine the Location and Condition of the Various Systems Prior to Start of Construction.
- 10. Exercise Proper Care by Hand Trenching when Excavating in Areas Nearby Existing Underground Facilities. The Contractor to Be Responsible To Repair and/or Pay Any Damages to the Existing Facilities. Damages to the Existing Facilities to Be Reported Immediately to All Concerned Parties. All Repair Work Shall Be Done Within 36 Hours to Match Its Original Condition and In Accordance with the Standards of the Various Utility Companies and Agencies.
- 11. Pavement and/or Concrete Sidewalk Restoration Shall Be Equal or Better than Original in Quality and Thickness. Cut Pavement 6" Beyond Trench.
- 12. Grassed Areas and Plants Damaged During Construction Shall Be Restored to as Close as Their Original Condition as Practicable. Suitable Topsoil Shall Be Provided For Top 6" of Backfill.
- 13. Contractor Shall Use Heavy Machine Equipment to Excavate if Basalt and Large Rocks Are Encountered.
- 14. Contractor Shall Shore, Brace and Dewater Within the Excavated Trenches as Required.

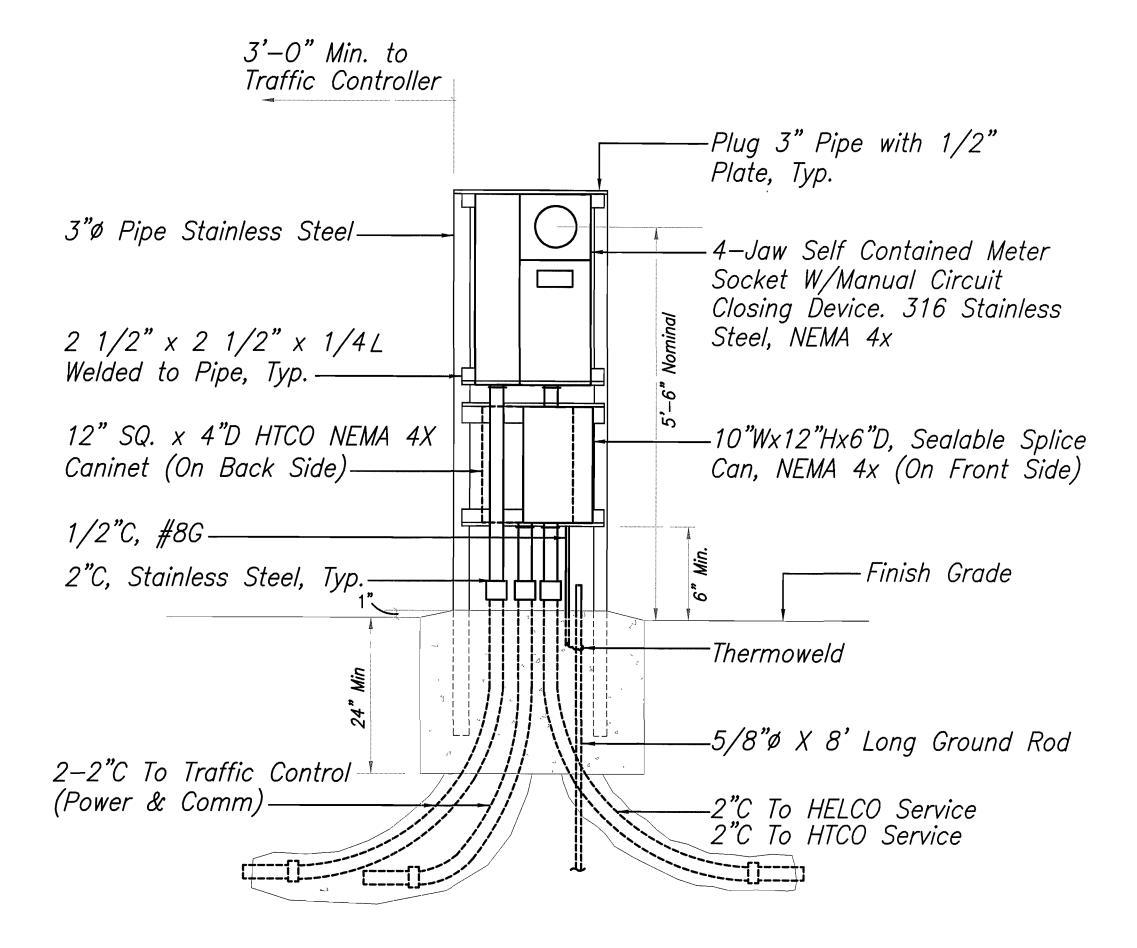

SERVICE EQUIPMENT DETAIL

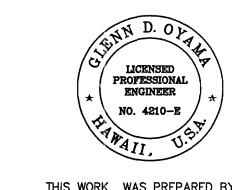

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NAKAMURA, OYAMA & ASSOC. LIC. EXP. DATE

DEPARTMENT OF TRANSPORTATION

HIGHWAYS DIVISION

TYPICAL DUCT SECTION DETAIL

SERVICE EQUIPMENT DETAIL

KEAAU-PAHOA ROAD, SHOULDER

LANE CONVERSION, PHASE 1

Keaau Bypass Road to Shower Drive

Fed. Aid Proj. No. STP-0130(28), Phase 1

Scale: Not To Scale Date: June 2012

SHEET No. E-25 OF 25 SHEETS



