

FED. ROAD DIST. NO.	STATE	PROJ. NO.	FISCAL YEAR	SHEET NO.	TOTAL SHEETS
HAWAII	HAW.	130A-01-99	2000	13	18

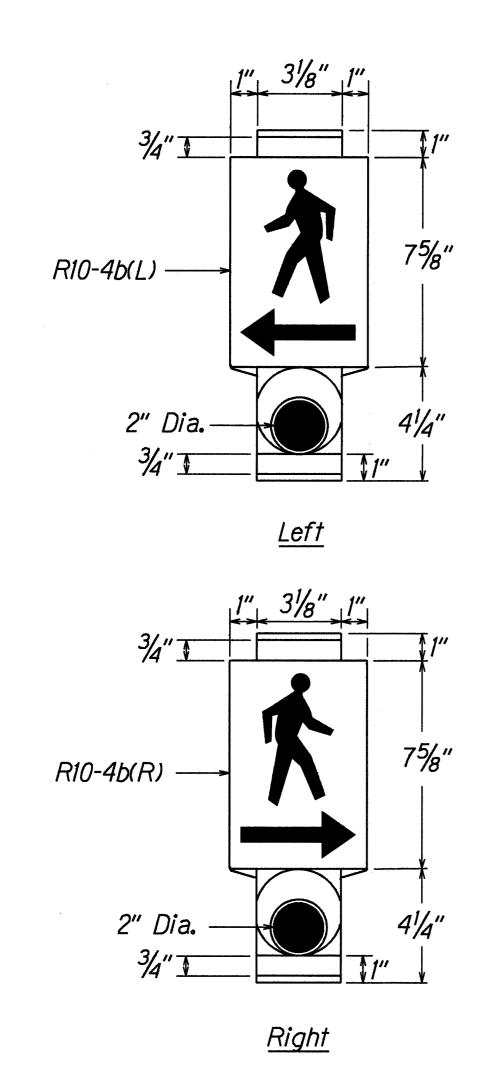

PEDESTRIAN PUSH BUTTON WITH SIGN

Man, Arrow ♦ Push Button - White Background - Black

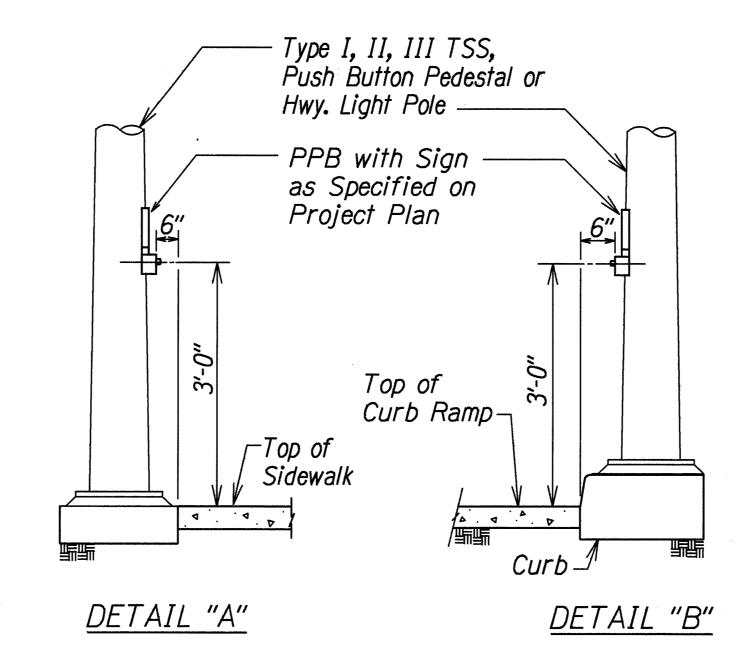

STATE OF HAWAII
DEPARTMENT OF TRANSPORTATION TRAFFIC SIGNAL DETAILS

PEDESTRIAN PUSHBUTTON DETAILS

Scale: Not to scale SHEET No. 1 SHEETS OF 4

KEAAU-PAHOA ROAD Installation of Traffic Signals at
Pahoa-Kapoho Road
Project No. 130A-01-99 STATE RIGHT-OF-WAY BACKFILL NOTES

and Gravel. If Earth and Gravel used, the maximum shall contain not more than 50% by volume of rock particles. Maximum 8" loose fill per lift. Obtain 95% compaction for each lift.

Concrete

3000 psi compressive strength @ 3 days.

NOTE: Base Course ♦ Sub-Base Course per 1994 State Standard Specifications for Highway Construction.

GENERAL NOTES

- 1. If trench is located on unpaved area, the Contractor shall replace 10" A.C. Base Course and 4" A.C. Pavement with Type "A" backfill material.
- 2. The Metal Detectable Red Plastic Warning Tape shall be a minimum 5 mils thick and 4" wide with a continuous metallic backing and corrosion resistant 1± mil thick foil core. The message on the tape shall read, "CAUTION - STATE TRAFFIC SIGNAL AND/OR HWY LIGHTING BURIED BELOW," utilizing 1½ inches series "C" black lettering. The message will be repeated with a 41/4" spacing between top line of message and start of next repeat.
- 3. The Contractor may begin backfilling the conduit trench when the concrete reaches 3000 psi compressive strength after 3 days.
- 4. Maximum four (4) Conduits per row for multiple conduit duct
- 5. For direct buried duct sections, the concrete jacket required at the conduit by-pass for various utilities, shall not be paid for separately but considered incidental to the direct buried conduits.
- 6. After installing all the traffic signal cables, the Contractor shall duct seal all conduits in the pullboxes, traffic signal standards and traffic signal controller cabinet concrete base. The duct seal material shall be approved by the Traffic Signal Inspector/Engineer and shall not be paid for separately but considered incidental to the direct buried and/or concrete encased conduits.

CAUTION-STATE TRAFFIC SIGNAL AND/OR HWY LIGHTING BURIED BELOW

1½" series "C"


Black Letters

-5 mils thick (min.) Plastic Warning Tape


CAUTION-STATE TRAFFIC SIGNAL AND/OR HWY LIGHTING BURIED BELOW

For additional information see note no. 2.


METAL DETECTABLE RED PLASTIC WARNING TAPE

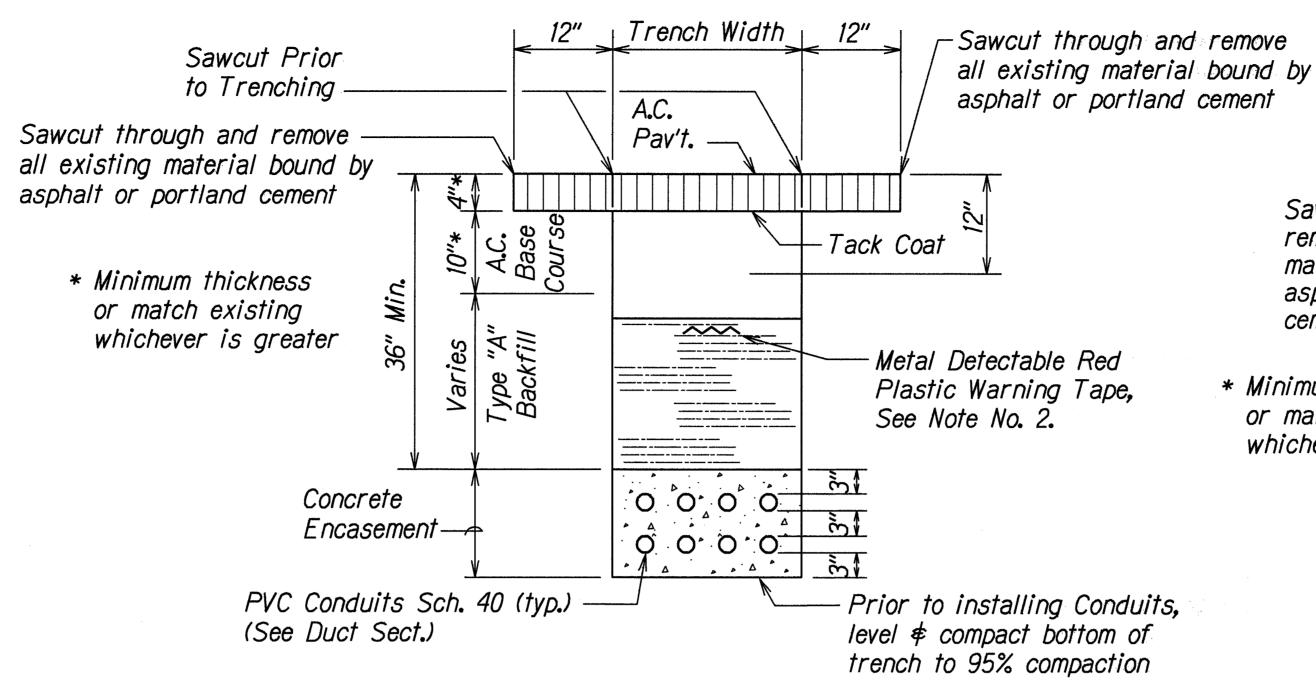

TYPICAL BACKFILL SECTION WITH CONCRETE ENCASED DUCTS

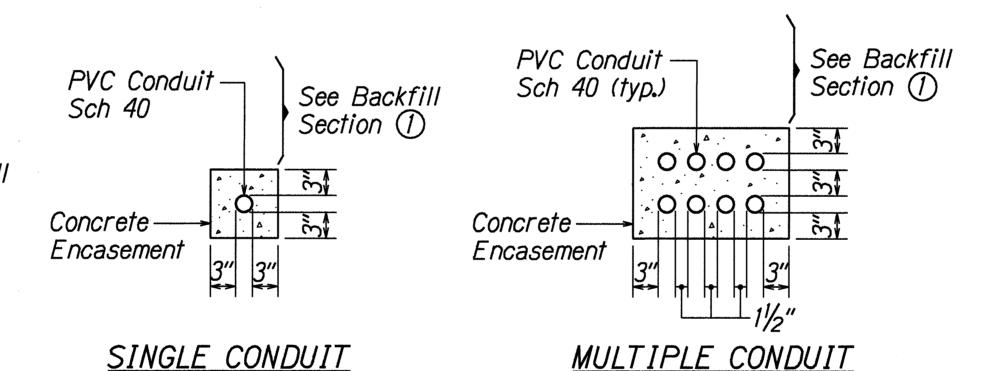

DUCT SECTIONS - CONC. ENCASED

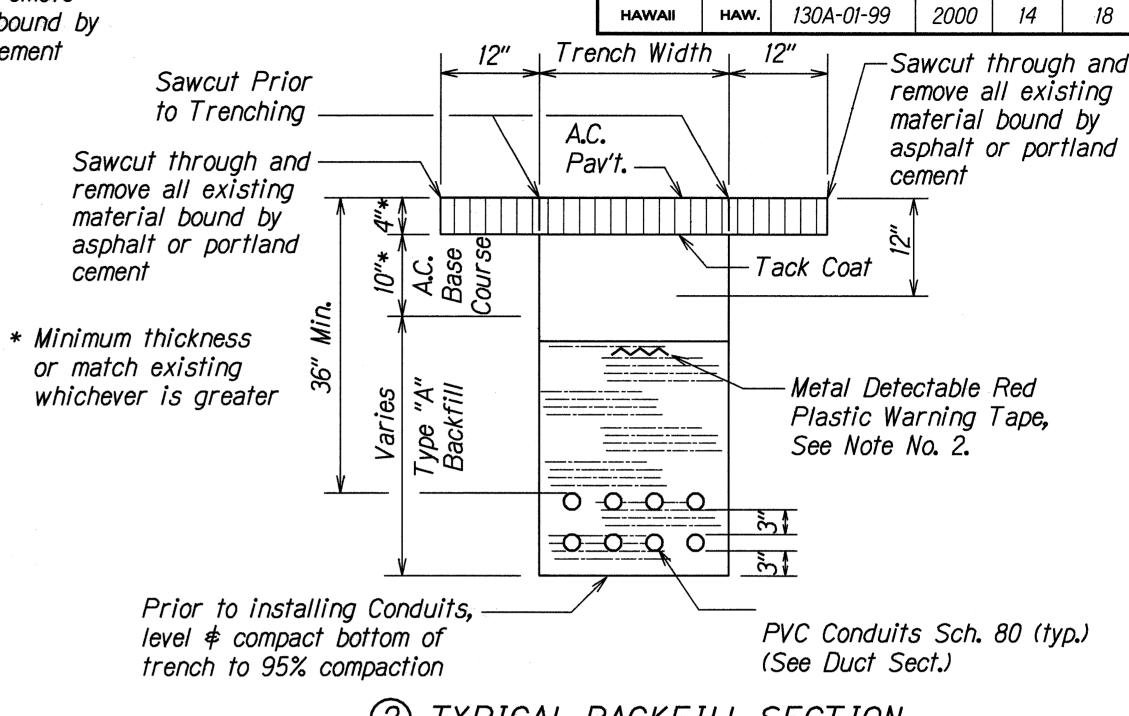

FED. ROAD DIST. NO.


STATE

FISCAL YEAR

PROJ. NO.

SHEET NO.


TYPICAL BACKFILL SECTION DIRECT BURIED DUCTS

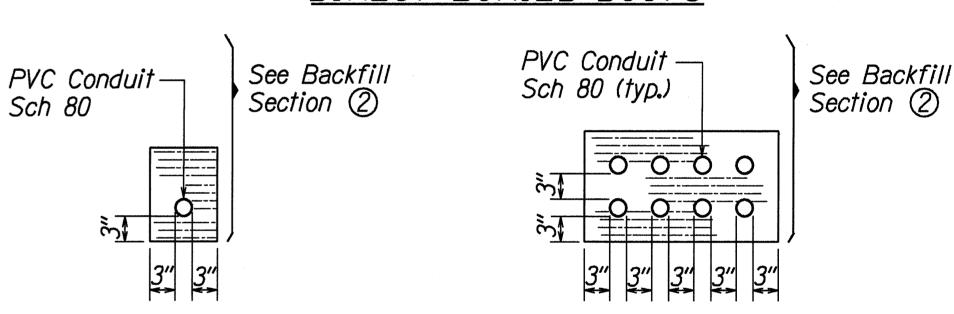

SINGLE CONDUIT

MULTIPLE CONDUIT

DUCT SECTIONS - DIRECT BURIED

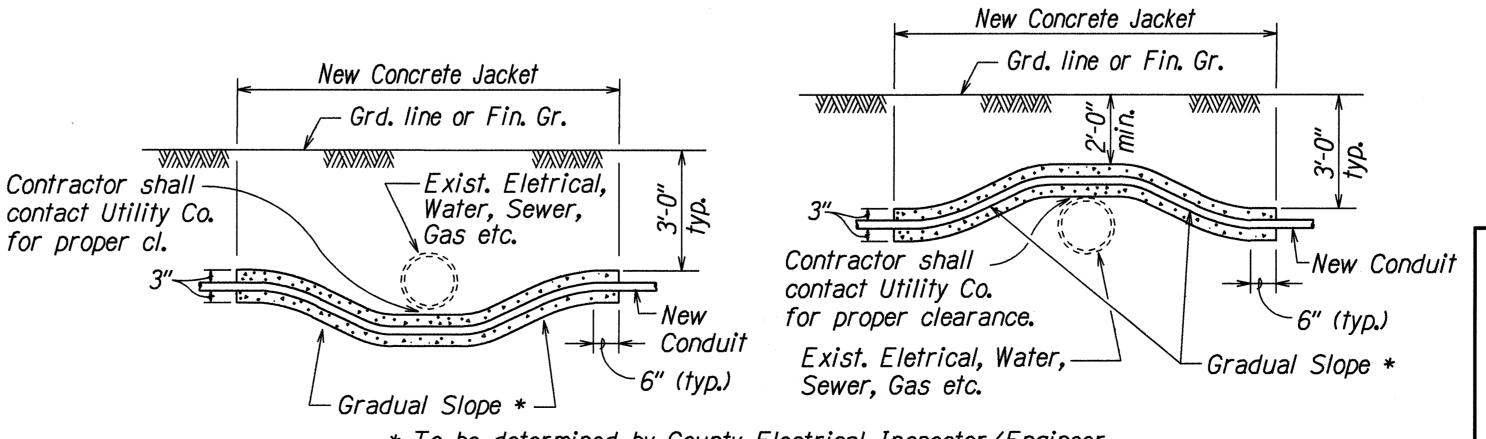

* To be determined by County Electrical Inspector/Engineer CONDUIT BY-PASS DETAIL AT VARIOUS UTILITIES

Not to Scale

STATE OF HAWAII **DEPARTMENT OF TRANSPORTATION**

TRAFFIC SIGNAL DETAILS


KEAAU-PAHOA ROAD Installation of Traffic Signals at Pahoa-Kapoho Road Project No. 130A-01-99


Not to Scale

Date: April, 2000 SHEETS SHEET No. 2 OF 4

ORIGINAL PLAN NOTE BOOK tdl.ruby 3kprtsd2

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ONE LINE DIAGRAM

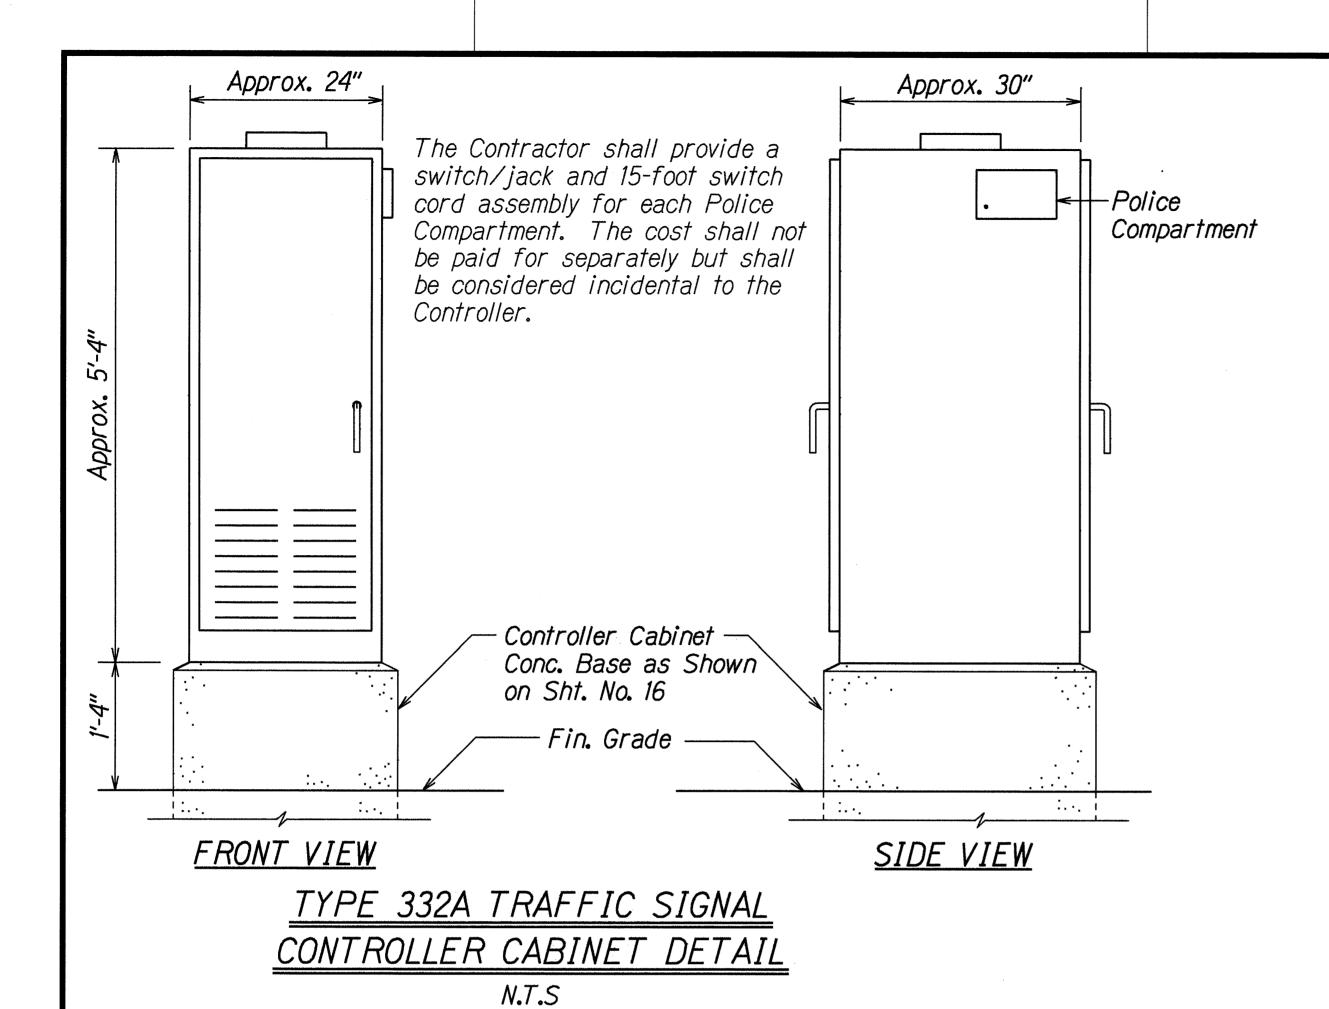NOTES:

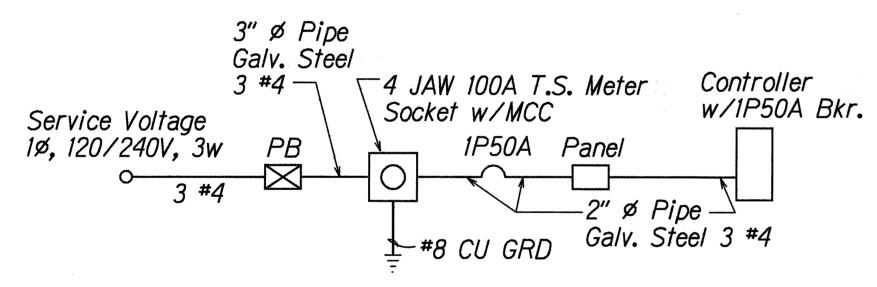- 1. Contractor shall make all electrical connections to controller, provide 2-IP50A breaker, ground and concrete-encased 2" conduit.
- 2. All conduits to contain a polyolefin pull line (Jet Line cat. #232 or equivalent).
- 3. Pedestal conduits shall be hot-dipped galv. after fabrication.
 - a. All fastening bolts, nuts \$\phi\$ washers shall be stainless steel.
 - b. Provide 4" cl. in front of meter.
 - c. * Sealable enclosure 6"Dx10"Wx12"H.

ELECTRICAL SERVICE DETAIL

FED. ROAD DIST. NO.	STATE	PROJ. NO.	FISCAL YEAR	SHEET NO.	TOTAL SHEETS
HAWAII	HAW.	130A-01-99	2000	15	18

NOTES:

- 1. Concrete shall be Class 3 (4,000 PSI Min.)
- 2. Dimensions shall be altered to suit controller cabinet actually furnished.
- 3. Conduits bends and drain are incidental to concrete base.
- 4. Refer to Cabinet Manufacturer's Specifications for details of anchor bolts and base setting.
- 5. All exposed surfaces of concrete base shall be given a class 2, rubbed finish.
- 6. All Conduits shall be Schedule 40.

STATE OF HAWAII
DEPARTMENT OF TRANSPORTATION
HIGHWAYS DIVISION

TRAFFIC SIGNAL DETAILS

KEAAU-PAHOA ROAD
Installation of Traffic Signals at
Pahoa-Kapoho Road

Project No. 130A-01-99

Scale: As Noted Date: April, 2000

SHEET No. 3 OF 4

F 4 SHEETS

