

DEMOLITION NOTES

- 1. THE CONTRACTOR SHALL COORDINATE ALL WORK WITH THE ENGINEER IN THE FIELD DURING THE ACTUAL DEMOLITION WORK TO RESOLVE ALL QUESTIONS WHERE APPLICABLE.
- 2. DISCONNECT AND REMOVE THE EXISTING ELECTRICAL ITEMS AND THEIR ASSOCIATED WIRING AS INDICATED.
- 3. ALL UN-USED EXISTING WIRING SHALL BE REMOVED IN ITS ENTIRETY.
- 4. ALL REMOVED ITEMS SHALL REMAIN THE PROPERTY OF THE OWNER. CONTRACTOR SHALL CONSULT THE OWNER FOR STORAGE AND/OR DISPOSAL INSTRUCTIONS.
- 5. CONTRACTOR SHALL ARRANGE FOR UTILITY SERVICE DISCONNECTIONS AND REMOVALS AS APPLICABLE.
- 6. IT SHALL BE THE CONTRACTOR'S RESPONSIBILITY TO VERIFY ALL EXISTING CONDITIONS. THE EXISTING CONDITIONS SHOWN ARE INTENDED TO BE AS COMPLETE AND ACCURATE AS POSSIBLE. HOWEVER, ALL ITEMS NOT SHOWN SHALL BE DEMOLISHED WHERE REQUIRED AT NO ADDITIONAL COST TO THE OWNER.

DEFINITIONS

WIRING - ALL CONDUITS, RACEWAYS, CONDUCTORS, FITTINGS, PULLBOXES, JUNCTION BOXES, OUTLET BOXES, DEVICES, AND OTHER MATERIALS OR ITEMS AS NECESSARY FOR A COMPLETED AND OPERATIONAL ELECTRICAL CIRCUIT OR SYSTEM; OR THAT WHICH COMPRISES AN ELECTRICAL CIRCUIT OR SYSTEM.

OUTLET - IN ADDITION TO DEFINITION IN THE NEC, OUTLET SHALL MEAN THE REQUIRED OUTLET BOXES, CONDUCTORS, TERMINATIONS, WIRING DEVICES, AND COVER PLATES, TO PROVIDE FOR THE INTENDED USE, APPLICATION, OR UTILIZATION EQUIPMENT.

CONDUCTOR COLOR CODE:

BK BLACK Y YELLOW
W WHITE BR BROWN
R RED PK PINK
G GREEN GY GRAY
O ORANGE PU PURPLE
BL BLUE BK1 BLACK—ONE


FED. ROAD	STATE	FED. AID	FISCAL	SHEET	TOTAL
DIST. NO.		PROJ. NO.	YEAR	NO.	SHEETS
HAWAII	HAW.	130B-01-92	1997	96	115

ABBREVIATIONS

A AMPERE AC ALTERNATING CURRENT AF AMPERE FRAME	MIN MISC	LIGHTS, LIGHTING, LONG, LENGTH MINIMUM
		NA 1 1X 1 3A1 1XA
		MISCELLANEOUS
AIC AMPERE INTERRUPTING CAPACITY	N	NEUTRAL
AT AMPERE TRIP	NIC	NOT IN CONTRACT
C CONDUIT	NTS	NOT TO SCALE
CAB CABINET	NP	NAMEPLATE
CB CIRCUIT BREAKER	OC	ON CENTER
CL CENTERLINE	ОН	OVERHEAD
CO CONDUIT ONLY	P	POLE
CMU CONCRETE MASONRY UNIT	PBX	PULLBOX
D DEEP	PFFB	PROVISIONS FOR FUTURE BREAKER
DWG DRAWING	PH	PHASE
E, ELEC ELECTRIC, ELECTRICAL	PNLBD	PANELBOARD
EA EACH	PL	PROPERTY LINE
EL ELEVATION	REF	REFERENCE
ENCL ENCLOSURE	RMC	RIGID METAL CONDUIT (STEEL)
EP ELECTRICAL PRIMARY	RNMC	RIGID NON-METALLIC CONDUIT
EQPT EQUIPMENT		(SCH 40 PVC UNLESS OTHERWISE INDICATED)
ES ELECTRICAL SECONDARY	R/W	RIGHT OF WAY
EXIST EXISTING	SD	SERVICE DROP
FBO FURNISHED BY OWNER OR OTHERS	(=) (=)	TEL TELEPHONE
G, GND GROUND	(TYP)	TYPICAL
GFIC GROUND FAULT INTERRUPTING CAPABILITY	UG	UNDERGROUND
H HORIZONTAL OR HIGH	\ \	VOLTS, VERTICAL
HELCO HAWAII ELECTRIC LIGHT COMPANY	VTU	VEHICLE TRACKING UNIT
HH HANDHOLE	W	WIRE(S), WIDE, WATTS
H.T.CO. HAWAIIAN TELEPHONE COMPANY	WHM	WATT-HOUR METER
HDGAF HOT DIPPED GALVANIZED AFTER FABRICATION	WP	WEATHERPROOF WELDED WIDE FARRIC
IBC INSTALLED BY CONTRACTOR	WF W V U V U	WELDED WIRE FABRIC
	W.x_H.x_L.	W.=WIDE, H.=HIGH, L.=LONG OR LENGTH
JBX JUNCTION BOX		
KVA KILO-VOLT AMPERE KWH KILO-WATT HOUR		
FLECTRICAL PLAN SYMBOLS		

ELECTRICAL PLAN SYMBOLS

A B	ELECTRICAL DETAIL INDICATOR. (A = NUMBER OR LETTER IDENTIFICATION, B = DRAWING OR SHEET WHERE SHOWN.)	
□ *	* - EQUIPMENT AS IDENTIFIED	
	UNDERGROUND SERVICE DUCTLINE. REFER DETAIL INDICATOR WHERE SHOWN	
	EMBEDDED CONDUIT BELOW EXTERIOR FINAL GRADE	
— ET,ED,ES,T,V,SD —	UTILITY LINES, OVERHEAD, AS IDENTIFIED, ET — ELECTRIC TRANSMISSION, ED — ELECTRIC DISTRIBUTION, ES — ELECTRIC SECONDARY, T — TELEPHONE, V — CATV, SD — SERVICE DROP	
0	UTILITY POLE	
~X	UTILITY POLE WITH STREET LIGHTING	

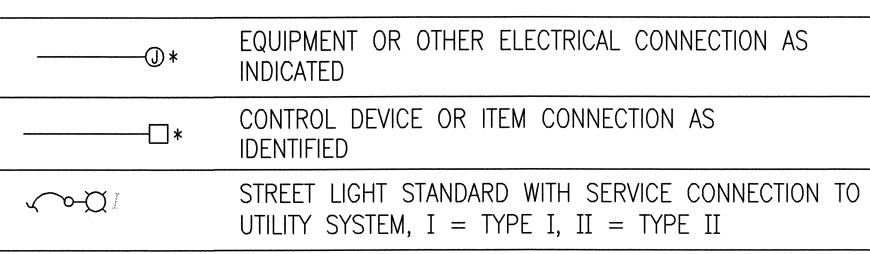



THIS WORK WAS PREPARED BY ME OR UNDER MY SUPERVISION.

WALT. CA.

PROJECT NO.

Mal. 1. Ch. PF.

DATE: 5/20/97 Scale:


STATE OF HAVAII
DEPARTMENT OF TRANSPORTATION
HIGHWAYS DIVISION

ELECTRICAL PLAN

KEA'AU-PAHOA ROAD VICINITY OF
KEA'AU TOWN (KEA'AU BYPASS ROAD)
PROJECT NO. 130B-01-92, PHASE 1

Scale: As Shown
SHEET No.

Date: *May, 1997*OF 20 SHEETS

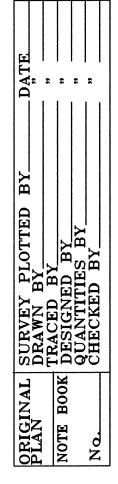

GENERAL NOTES:

- 1. ALL ELECTRICAL ITEMS INDICATED ON THE DRAWINGS ARE NEW AND SHALL BE PROVIDED BY THE CONTRACTOR UNLESS INDICATED AS "EXISTING", OR AS OTHERWISE NOTED.
- 2. ALL LOCATIONS SHOWN ON THE DRAWING FOR ITEMS OF WORK TO BE FURNISHED AND/OR INSTALLED ARE APPROXIMATE. THE CONTRACTOR SHALL SELECT LOCATIONS TO SUIT FIELD CONDITIONS SUBJECT TO APPROVAL OF THE ENGINEER.
- 3. CONTRACTOR SHALL INDICATE ALL FINAL LOCATIONS ON THE "AS-BUILT" DRAWINGS WHERE THEY DIFFER FROM THAT SHOWN ON THE DRAWINGS.
- 4. CONTRACTOR SHALL BE RESPONSIBLE FOR COORDINATING THE WORK AMONG THE VARIOUS TRADES AS NECESSARY TO AVOID CONFLICTS AND TO INSURE THE INSTALLATION OF ALL WORK WITHIN THE AVAILABLE
- 5. CONTRACTOR SHALL INVESTIGATE AND TONE AREA BEFORE DIGGING OR EXCAVATING.
- 6. ALL ELECTRICAL EQUIPMENT SHALL BE NEW AND WARRANTED BY THE MANUFACTURER.
- 7. EXISTING CONDITIONS, MATERIALS, SIZES, LOCATIONS, AND DIMENSIONS SHOWN ON THESE DRAWINGS REPRESENT THE BEST AVAILABLE INFORMATION OBTAINED FROM FIELD INVESTIGATION. PRIOR TO ORDERING MATERIALS AND EQUIPMENT, THE CONTRACTOR SHALL VERIFY ALL EXISTING CONDITIONS, MATERIALS, SIZES, LOCATIONS, AND DIMENSIONS THAT AFFECT THE WORK OF THIS PROJECT. NOTIFY THE ENGINEER OF ALL QUESTIONS IN WRITING AND RESOLVE ALL CONTRACTOR'S QUESTIONS AND CONCERNS PRIOR TO PROCUREMENT AND BEFORE START OF CONSTRUCTION.
- 8. ALL ELECTRICAL INSTALLATION SHALL BE IN ACCORDANCE WITH THE NATIONAL ELECTRICAL CODE, NATIONAL ELECTRICAL SAFETY CODE, AND FEDERAL, STATE, AND COUNTY GOVERNMENT STANDARDS, REGULATIONS, AND ORDINANCES.
- 9. SITE PLAN INDICATES APPROXIMATE LOCATIONS OF KNOWN BURIED ITEMS. CONTRACTOR SHALL NOT CAUSE ANY HARM TO OR DAMAGE ANY EXISTING BURIED ITEM. CONTRACTOR SHALL PROVIDE ALL NECESSARY MEANS TO LOCATE ALL EXISTING BURIED ITEMS INTERFERRING WITH NEW WORK. CONTRACTOR SHALL REPAIR OR REPLACE ANY DAMAGED BURIED ITEM TO THE SATISFACTION AND ACCEPTANCE OF THE ENGINEER.
- 10. ALL EXPOSED CONDUITS AND FITTINGS, AND METAL PORTIONS OF EQUIPMENT ENCLOSURE SHALL BE FIELD PAINTED FOR CORROSION PROTECTION.
- 11. ALL EQUIPMENT SHALL BE PROPERLY MOUNTED, ANCHORED, AND SUPPORTED BY APPROVED METHODS FOR SEISMIC RESTRAINT OF .3G FORCES.
- 12. THE CONTRACTOR SHALL VERIFY THE EXACT LOCATION OF ALL BURIED SEWER, WATER AND GAS PIPING, DRAINAGE STRUCTURES, AND ALL OTHER BURIED ITEMS WITH THE APPROPRIATE AGENCIES PRIOR TO DOING ANY EXCAVATION WORK.
- 13. THE CONTRACTOR SHALL VERIFY THE EXACT LOCATION OF ALL TRAFFIC SIGNAL STANDARDS, HANDHOLES, AND CONTROLLERS WITH THE ENGINEER. THE CONTRACTOR SHALL STAKE-OUT LOCATIONS FOR APPROVAL BY THE ENGINEER.
- 14. THE CONTRACTOR SHALL VERIFY LOCATION OF ALL OVERHEAD UTILITY LINES TO AVOID CONFLICTS DURING CONSTRUCTION. CONTRACTOR SHALL NOTE ALL POSSIBLE HAZARDS, HOWEVER REMOTE, AND SHALL TAKE ALL NECESSARY PRECAUTIONS AS REQUIRED TO AVOID ANY AND ALL HAZARDS.

NOTES TO CONTRACTOR — GTE H.T.CO. REQUIREMENTS

- 1. ALL WORK SHALL BE IN STRICT ACCORDANCE WITH SPECIFICATIONS AND REQUIREMENTS OF GTE H. T. CO. FOR THE FACILITIES WITHIN THEIR JURISDICTION.
- 2. THE CONTRACTOR SHALL CLOSELY COORDINATE ALL WORK WITH GTE H. T. CO. ALL TRENCHES MUST BE INSPECTED BY H. T. CO. PRIOR TO BACKFILLING THE CONCRETE ENCASING OPERATIONS. THE CONTRACTOR SHALL NOTIFY THE H.T.CO. INSPECTOR AT KONA TELEPHONE NUMBER 329-4756 AT LEAST 72 HOURS PRIOR TO POURING OF CONCRETE OR BACKFILLING.
- 3. UNLESS OTHERWISE INDICATED, ALL CONDUITS, SWEEPS, COUPLINGS, ADAPTERS, AND BELL ENDS SHALL BE CARLON GT42, 2-INCH OR 4-INCH PVC CONDUIT MEETING GTE SPECIFICATION GTS-8342.
- 4. STONES, ROCKS, ETC. SHALL NOT BE USED WITH BACKFILL MATERIAL, ONLY SELECT MATERIALS SHALL BE USED AS BACKFILL MATERIAL.
- 5. A 4-INCH WIDE WARNING TAPE RED IN COLOR WITH A BLACK IMPRINTED MESSAGE "WARNING STOP DIGGING-CALL GTE, COMMUNICATIONS CABLE BURIED BELOW. FAILURE TO COMPLY COULD RESULT IN LEGAL ACTION" SHALL BE PLACED 12-INCHES BELOW THE SURFACE OVER THE DUCT OR CONCRETE JACKET FOR THE ENTIRE LENGTH OF DUCT INSTALLATIONS. SEE H. T. CO. STANDARD DRAWING 34028. RECOMMENDED TAPE IS MANUFACTURED BY THOR ENTERPRISES, INC., SUN PRAIRIE, WE 53590 (1-800-827-8467) PART NUMBERS DTOGTE-41 (1000-FT.) AND DTOGTE-46 (6000-FT.).
- CONDUITS SHOULD BE CONSTRUCTED WITH NO LESS THAN 20 FOOT RADIUS CURVES.
- LESS THAN 12-INCHES LONG AND HAVING A DIAMETER OF ONE-FOURTH THROUGH EACH CONDUIT AFTER WHICH A BRUSH WITH STIFF BRISTLES EARTH, SAND, OR GRAVEL HAVE BEEN LEFT IN THE CONDUIT. GENERAL MACHINE PRODUCTS CO. (GMP), TREVOSE, PA (215-357-5500). RECOMMENDED GMP PART NO. 81823R (TEST MANDREL FOR 3-INCH GMP PART NO. 17092 (BRUSH FOR 3-INCH CONDUIT) AND GMP PART NO. 17094 (BRUSH FOR 4-INCH CONDUIT). RECOMMENDED 2-INCH MANDRELS AND BRUSHES ARE MADE BY CONDUX INTERNATIONAL, INC., 145 KINGSWOOD ROAD, MANKATO, MN 56001 (1-800-533-2077). RECOMMENDED CONDUX PART NO. 08013020 (TEST MANDREL FOR 2-INCH CONDUIT) AND PART NO. 08028900 (BRUSH FOR 2-INCH CONDUIT).
- 8. INSTALL NEPTCO WP1800P MULETAPE IN ALL NEW CONDUITS AND CAP ALL CONDUITS AFTER TESTING. THE NEPTCO MULETAPE IS AVAILABLE IN 3000 FT., 6500 FT., AND 10000 FT. REELS. THE NEPTCO MULETAPE IS PRE-LUBRICATED AND PRINTED WITH SEQUENTIAL FOOTAGE MARKINGS. USING THE NEPTCO MULETAPE, THE CONTRACTOR SHALL MEASURE AT LEAST ONE CONDUIT OF A COMMON DUCT RUN. THE DISTANCE SHALL BE MARKED ON THE RECORD PRINTS AND SUBMITTED TO THE H. T. CO. INSPECTOR FOR RECORD KEEPING.
- 9. ALL CONDUITS SHALL ENTER PULLBOXES/MANHOLES AT 90 DEGREE ANGLE AND FLUSH WITH FLARED OR BELL ENDS TO PREVENT CABLE DAMAGE.
- 10. PROVIDE A FIVE-EIGHTH INCH X 8-FT. GROUND ROD IN ALL OTHER H. T. CO. PULL BOXES AND MANHOLES.
- 11. THE TOP OF ALL UTILITY BOXES SHALL BE 1-INCH ABOVE FINISH GRADE IN NON-PAVED SHOULDERS UNLESS OTHERWISE NOTED.
- 12. ALL DUCTS ASSOCIATED WITH PULLBOXES OR MANHOLES SHALL BE INSTALLED WITH ADEQUATE DRAINAGE TOWARD THE PULLBOXES OR MANHOLES. (MINIMUM ONE-FOURTH PERCENT UNLESS OTHERWISE NOTED).
- 13. ALL CONDUITS SHALL CONNECT TO PULLBOXES AND MANHOLES AT ENDS ONLY. NO CONNECTION TO SIDES WILL BE ALLOWED.

NOTES TO CONTRACTOR — HELCO REQUIREMENTS:

FED. ROAD DIST. NO.	STATE	FED. AID PROJ. NO.	FISCAL YEAR		TOTAL SHEETS
HAWAII	HAW.	130B-01-92	1997	97	115

- 1. ALL WORK SHALL COMPLY WITH THE SERVING UTILITY COMPANY'S REQUIREMENTS, SERVICE INSTALLATION MANUALS, AND RULES AND REGULATIONS.
- 2. RESOLVE ANY DISCREPANCY OR QUESTION WITH THE ENGINEER PRIOR TO START OF ANY WORK.
- 3. THE CONTRACTOR SHALL OBTAIN ALL REQUIRED STANDARD DRAWINGS AND INSTALLATION DETAILS FROM THE SERVING UTILITY COMPANIES. THE CONTRACT DRAWINGS DO NOT IN ANY WAY DUPLICATE THE STANDARDS OF THE UTILITY COMPANIES.
- 4. DO ALL NECESSARY EXCAVATION AND BACKFILLING OF DUCTLINES AS PER THE HELCO SPECIFICATION NO. CS-7001 AND CS-7004. PROVIDE WARNING TAPE PER H.T.CO. STANDARD DRAWING 34028.
- 5. PREPARE ALL VAULT SITES AS SPECIFIED BY HELCO SPECIFICATION DRAWING NO. 30-5001 (2-SHEETS).
- 6. FURNISH AND INSTALL SCH 40 PVC DUCTS AS INDICATED ON THE DRAWINGS WITH 3" CONCRETE ENCASEMENT AS INDICATED.
- 7. FURNISH AND INSTALL ALL PULLBOXES, HANDHOLES, AND MANHOLES AS NOTED ON THE DRAWINGS.
- 8. ALL ELECTRIC DUCT LINES SHALL CONTAIN A POLYOLEFIN PULL LINE (JET LINE CAT. NO. 232 OR EQUIVALENT). (200 LB. MINIMUM TEST STRENGTH)
- 9. ALL WORK SHALL BE SUBJECT TO HELCO INSPECTION. CONTRACTOR SHALL GIVE HELCO 3 WORKING DAYS INSPECTION NOTICE PRIOR TO POURING OF CONCRETE, OR FOR ANY OTHER INSPECTION SERVICES.
- 6. MAIN DUCT RUNS EXCEPT RISER CONDUITS AND CROSS-CONNECT PEDESTAL 10. ALL ELECTRIC CONDUITS SHALL BE REAMED WITH A MANDREL 1/2" SMALLER IN DIAMETER THAN THE CONDUIT, DUCTS SHALL BE SWABBED AND CLEARED OF ALL BURRS AND FOREIGN MATERIAL.
- 7. AFTER THE CONDUITS ARE INSTALLED, A ROUND SOLID TEST MANDREL NOT 11. REFER TO HELCO SERVICE DRAWINGS FOR SPECIFIC AND STANDARD DETAIL DRAWINGS.
 - INCH LESS THAN THE DIAMETER OF THE CONDUIT SHALL BE PULLED 12. ALL BENDS DUE TO CHANGE IN GRADE SHALL HAVE A RADIUS BEND OF NOT LESS THAN 20'-0" (HORIZONTAL OR VERTICAL CHANGE).
 - SHALL BE PULLED THROUGH TO MAKE CERTAIN THAT NO PARTICLES OF 13. ALL STREET LIGHT AND OTHER ELECTRICAL CONNECTION POINTS SHALL BE THOSE DESIGNATED BY HELCO.
 - RECOMMENDED 3-INCH AND 4-INCH MANDRELS/BRUSHES ARE MADE BY 14. ANY QUESTIONS AS TO THE RESPONSIBILITY OF ANY WORK NOT SPECIFICALLY COVERED IN THESE NOTES AND ON THE DRAWINGS SHALL BE CLARIFIED WITH HELCO'S AND JSL'S ENGINEERING DEPARTMENT.
 - CONDUIT), GMP PART NO. 81824R (TEST MANDREL FOR 4-INCH CONDUIT), 15. ALL HANDHOLES, PULLBOXES, AND MANHOLES WITHIN THE ROAD R/W SHALL BE PLACED WITH TOPS FLUSH WITH FINAL GRADE, PAVEMENT, OR SIDEWALK AS APPLICABLE.
 - ELECTRICAL SERVICE INSTALLATION SHALL COMPLY WITH HELCO'S REQUIREMENTS. CONTRACTOR SHALL OBTAIN HELCO'S DRAWING NO. ___(*)_ AND PROVIDE ELECTRICAL SERVICES AS INDICATED. CONTRACTOR SHALL CONSULT WITH ENGINEER WHERE HELCO'S DRAWING DIFFERS AND RESOLVE ALL QUESTIONS PRIOR TO START OF ANY ELECTRICAL SERVICE WORK.

(* - NOT AVAILABLE PRIOR TO BIDDING)



STATE OF HAWAII DEPARTMENT OF TRANSPORTATION HIGHWAYS DIVISION


ELECTRICAL PLAN


KEA'AU-PAHOA ROAD VICINITY OF KEA'AU TOWN (KEA'AU BYPASS ROAD) PROJECT NO. 130B-01-92, PHASE 1


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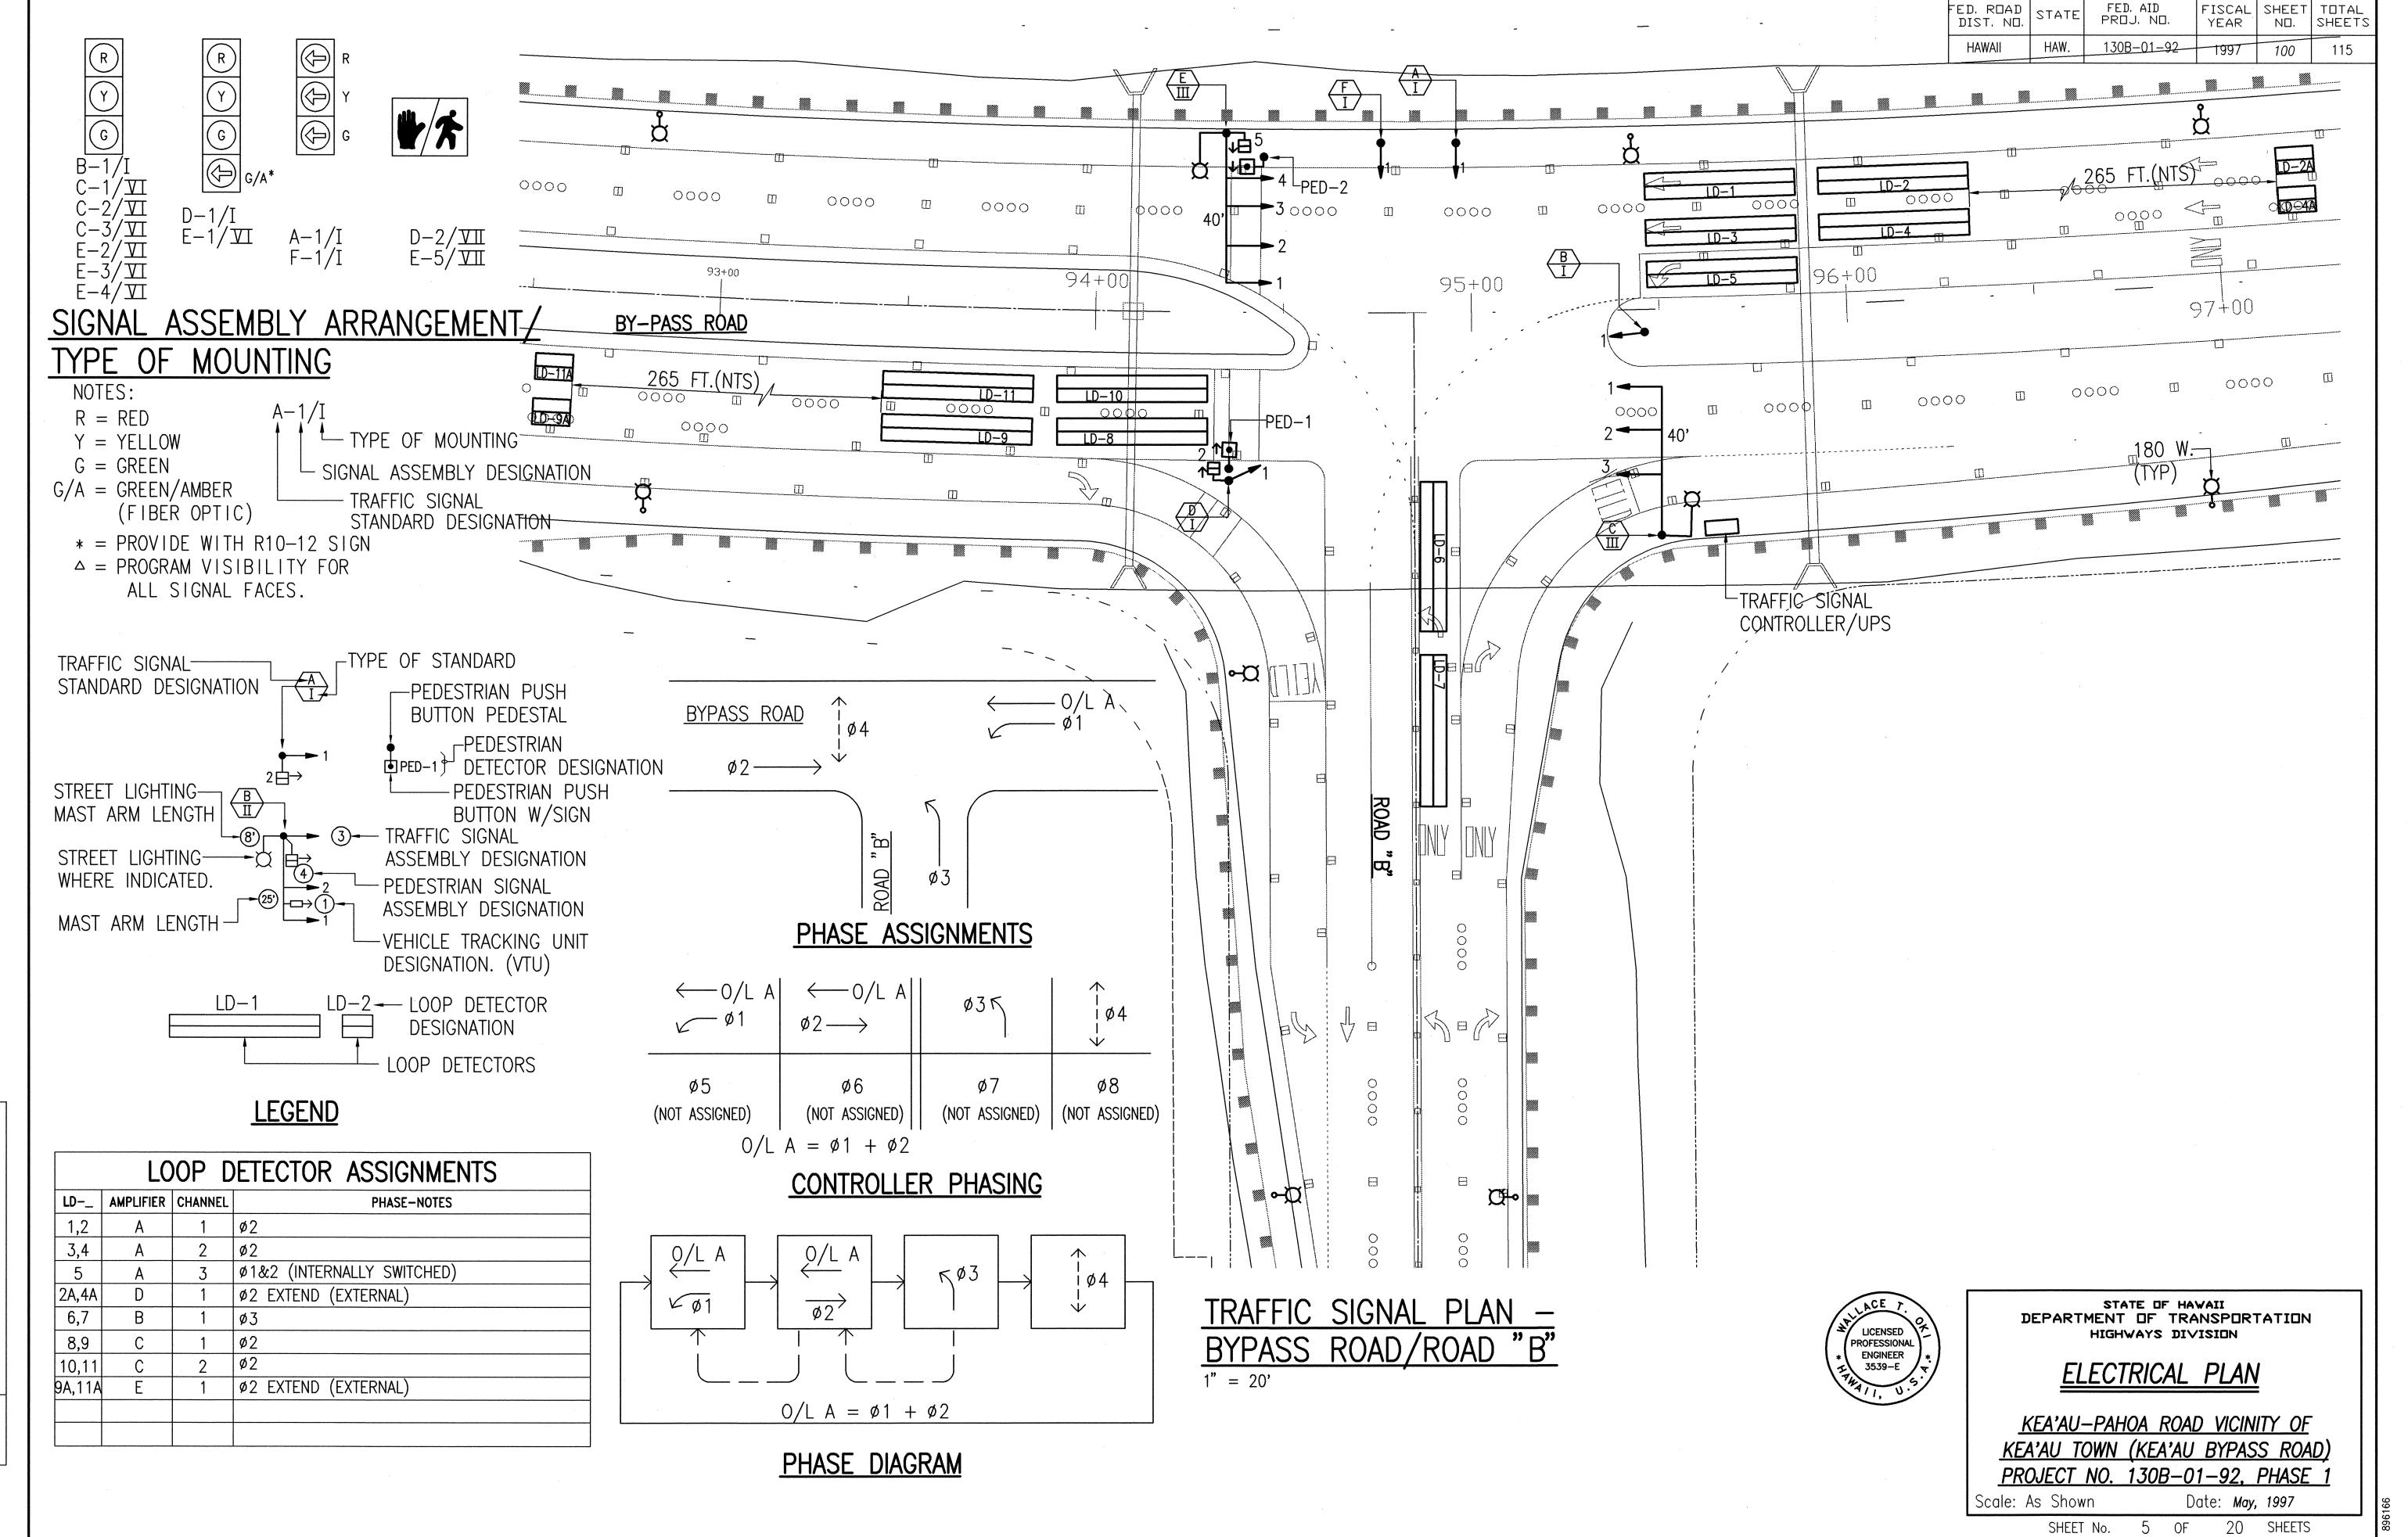
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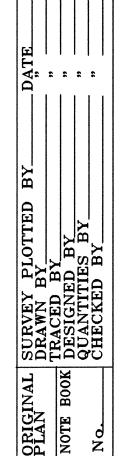
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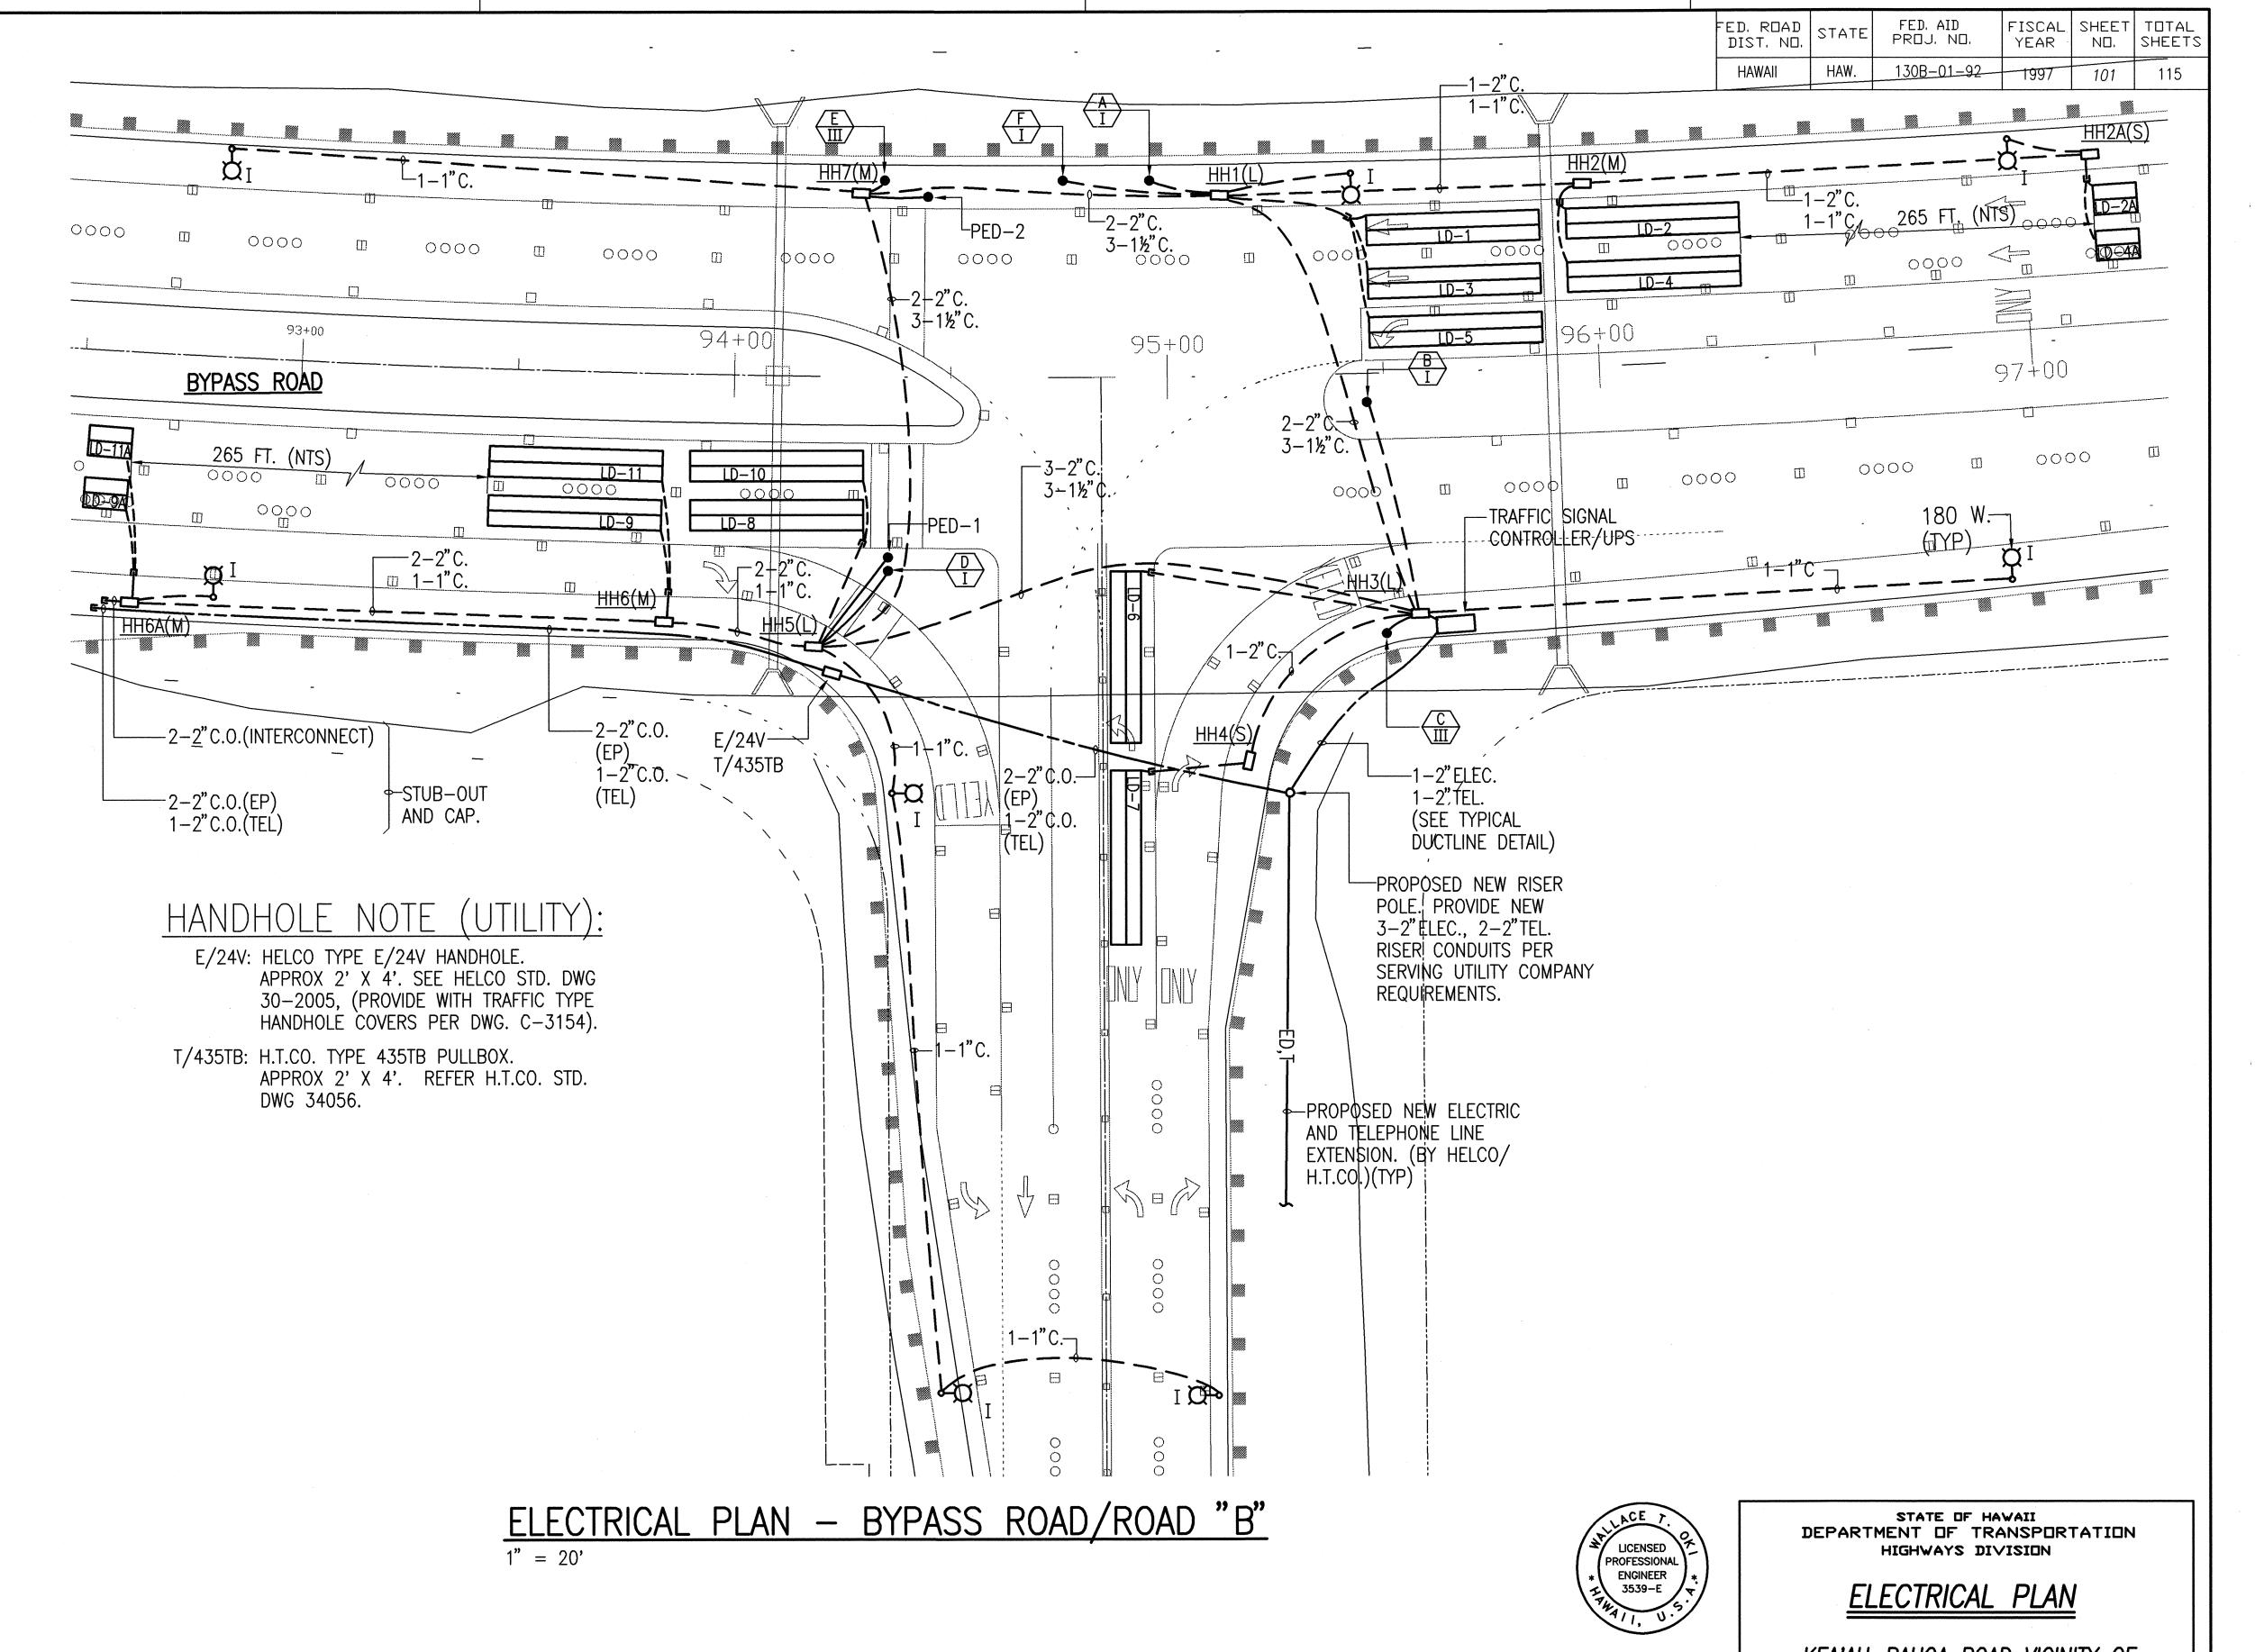






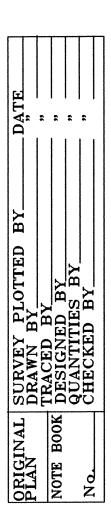

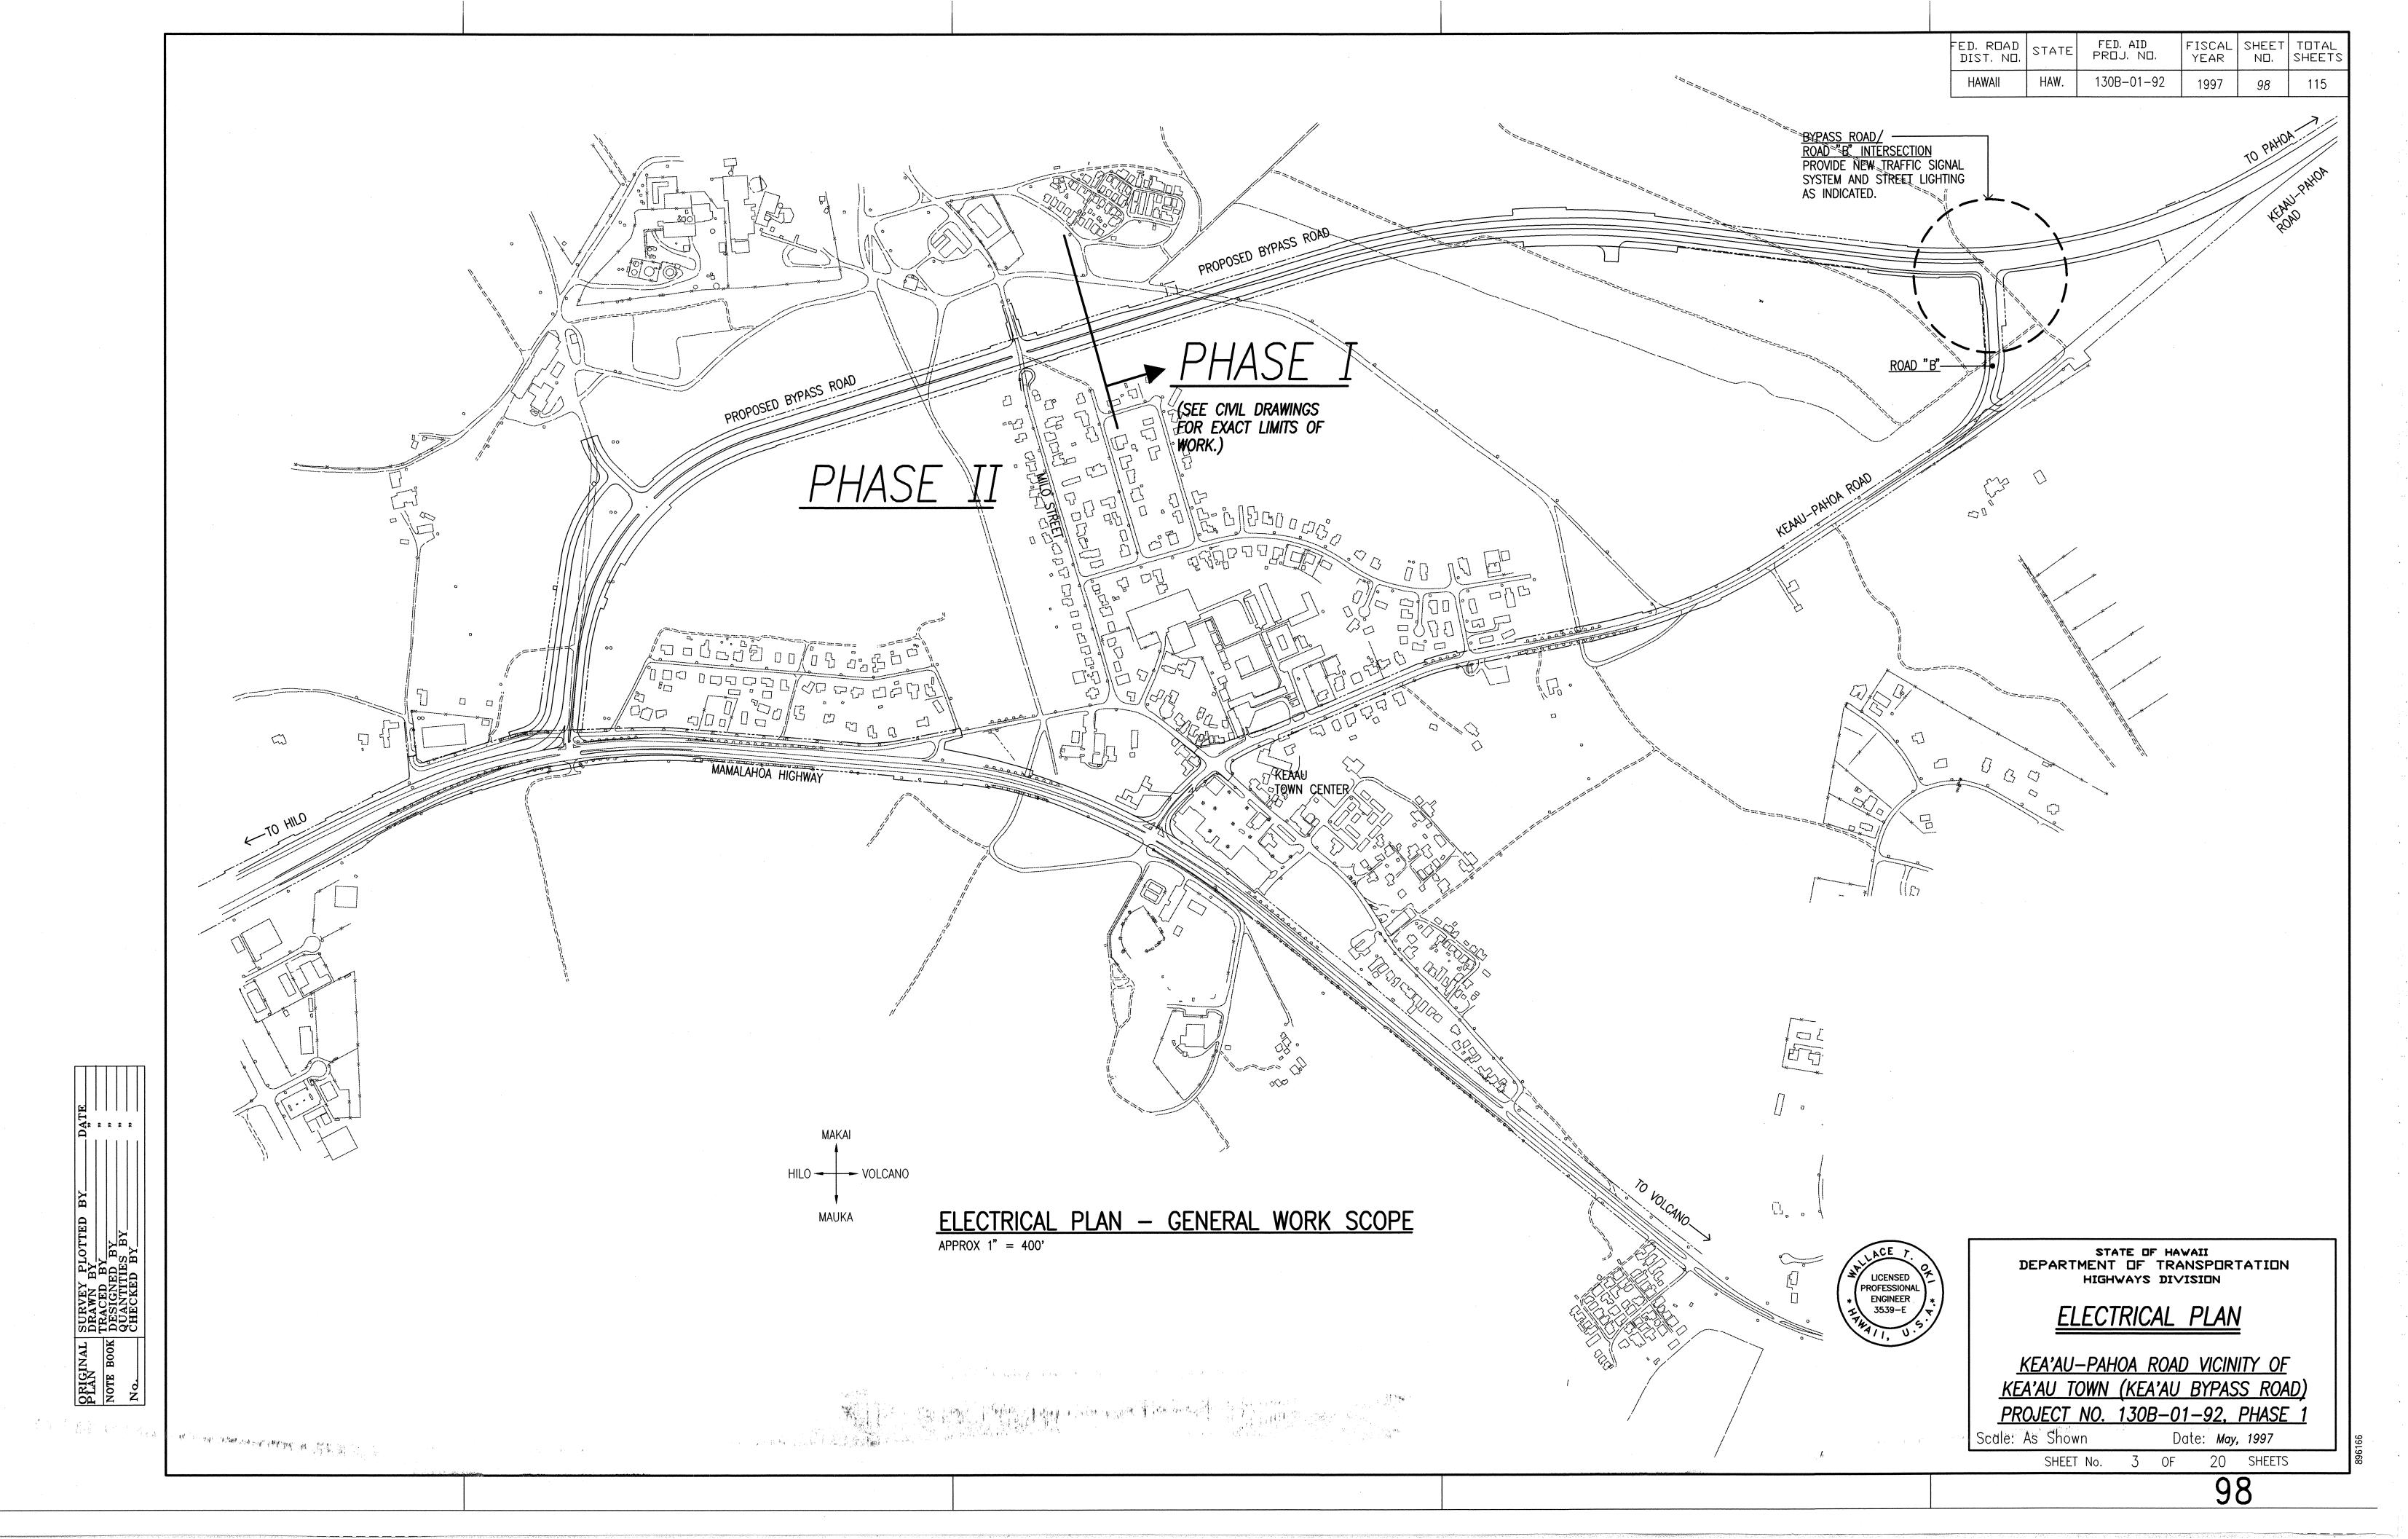

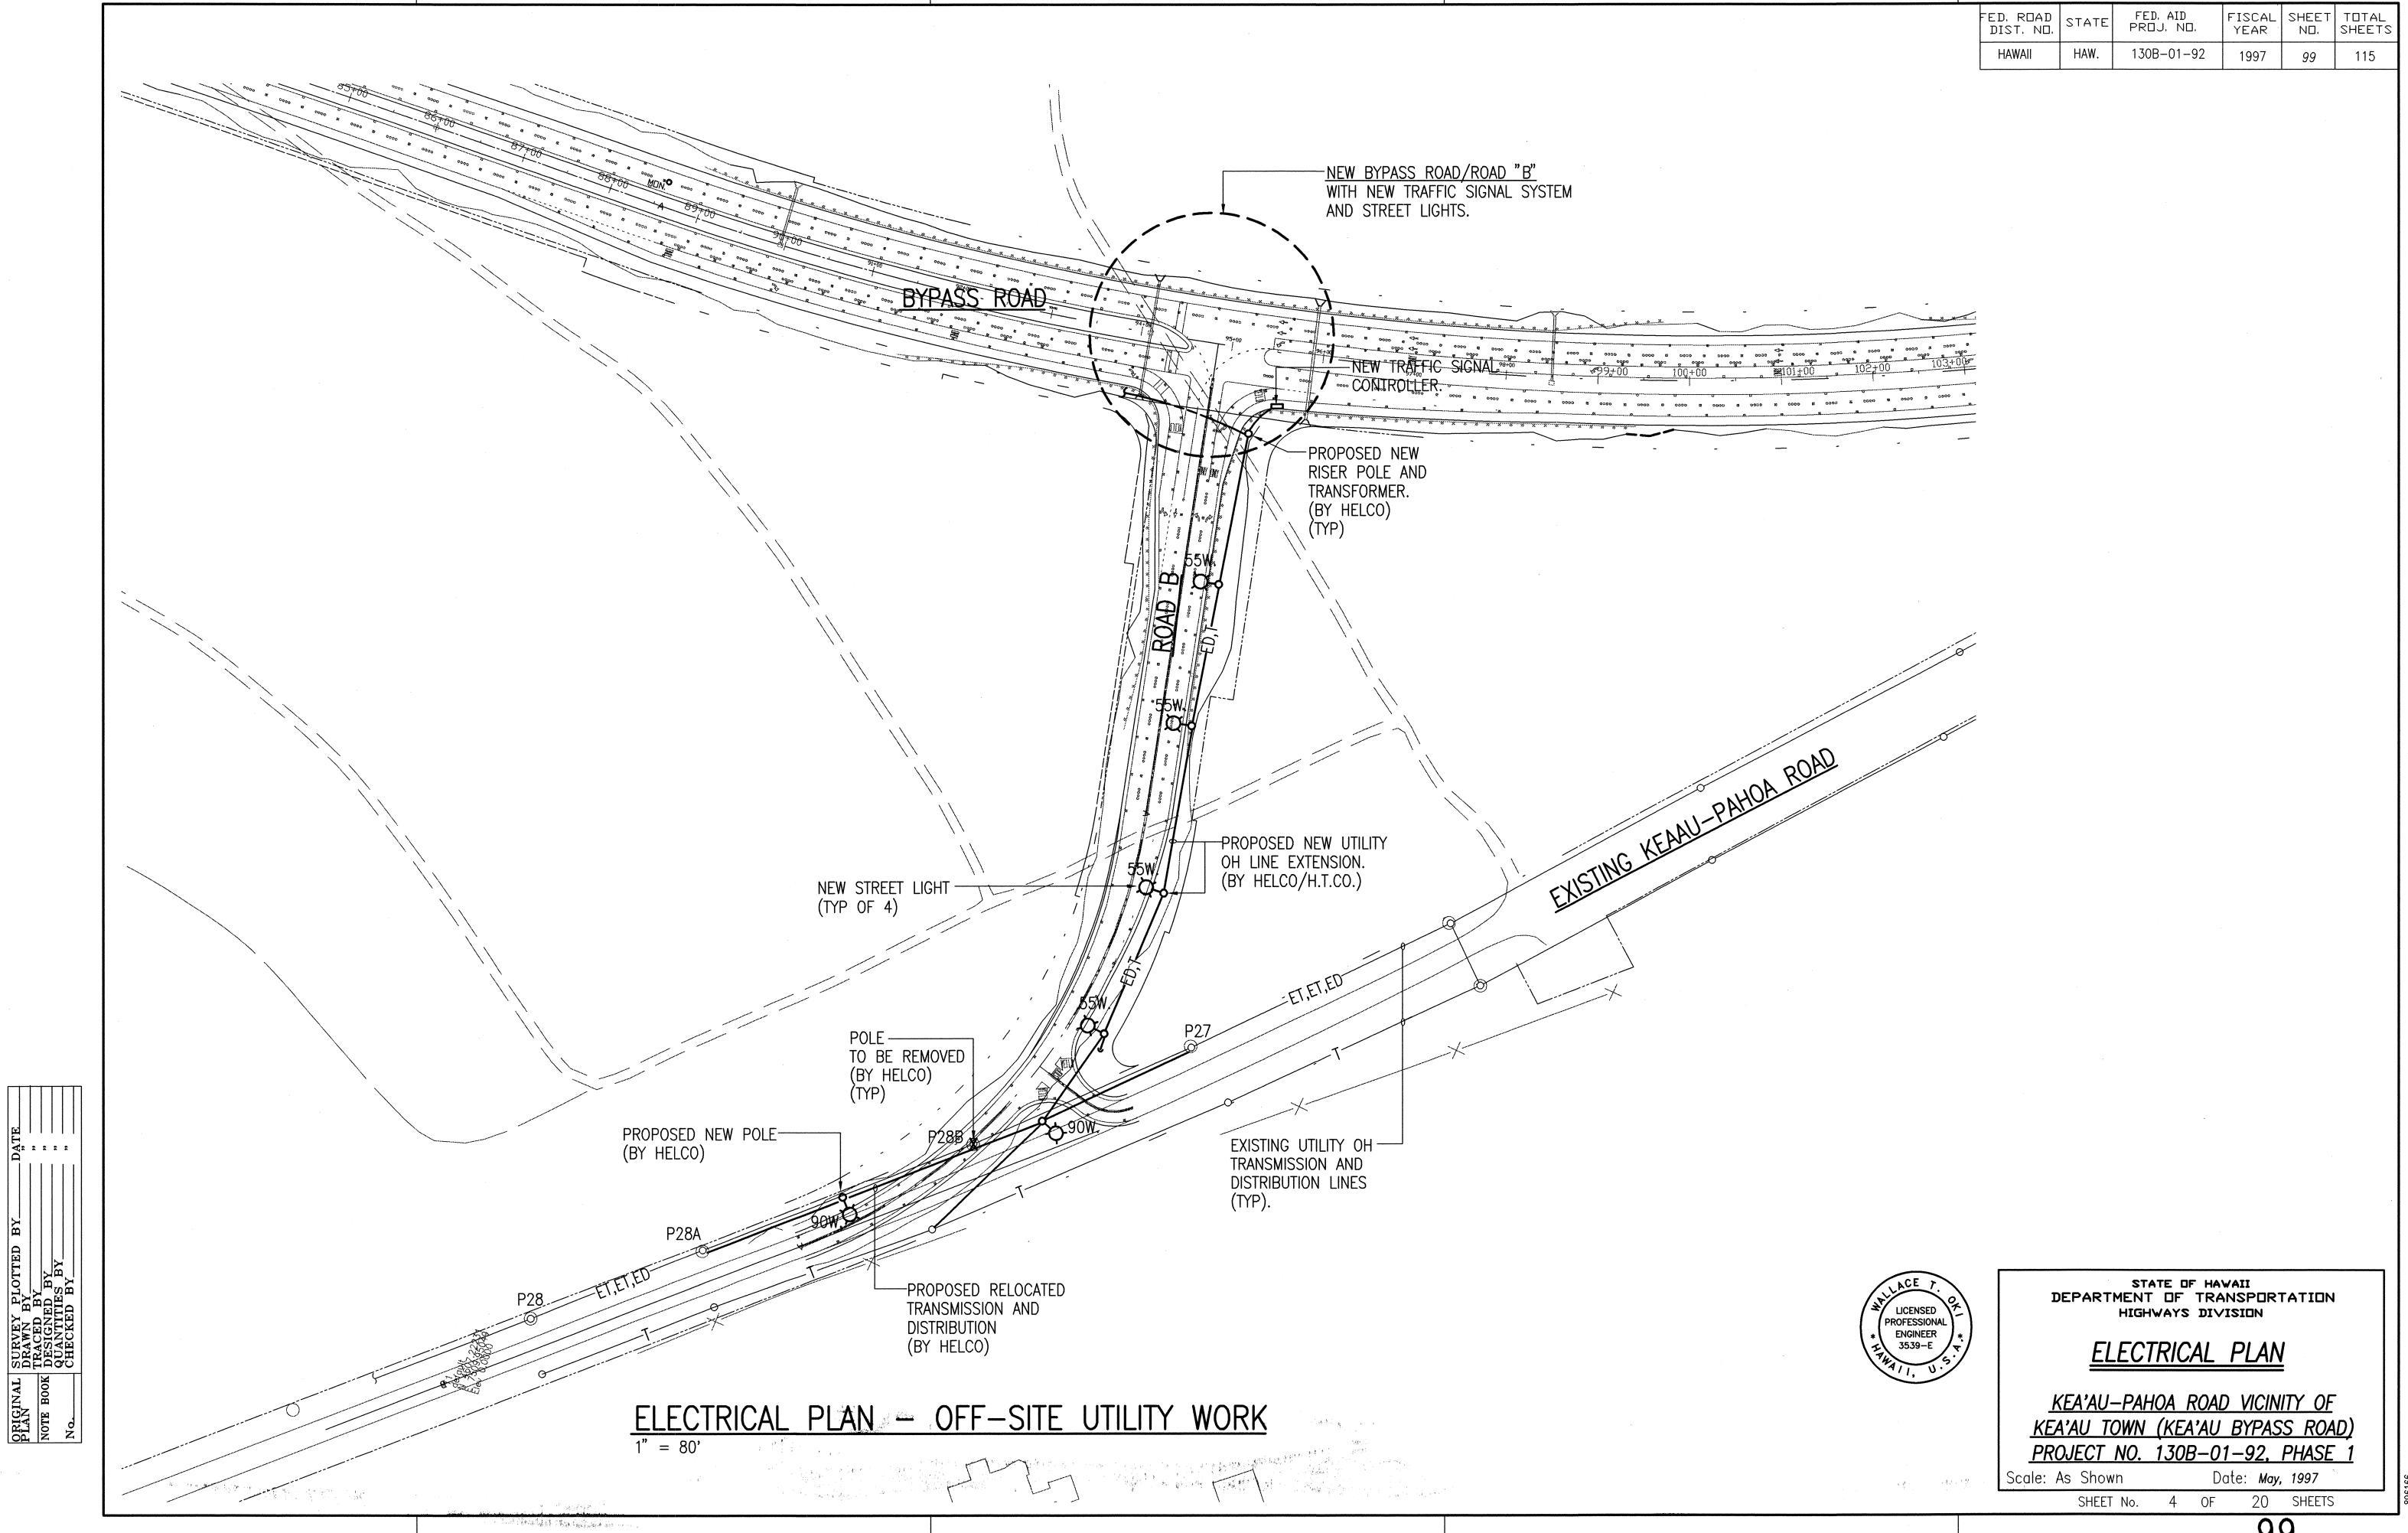


KEA'AU—PAHOA ROAD VICINITY OF KEA'AU TOWN (KEA'AU BYPASS ROAD)
PROJECT NO. 130B—01—92, PHASE 1

Scale: As Shown
SHEET No.

Date: *May,* 1997

OF 20 SHEETS

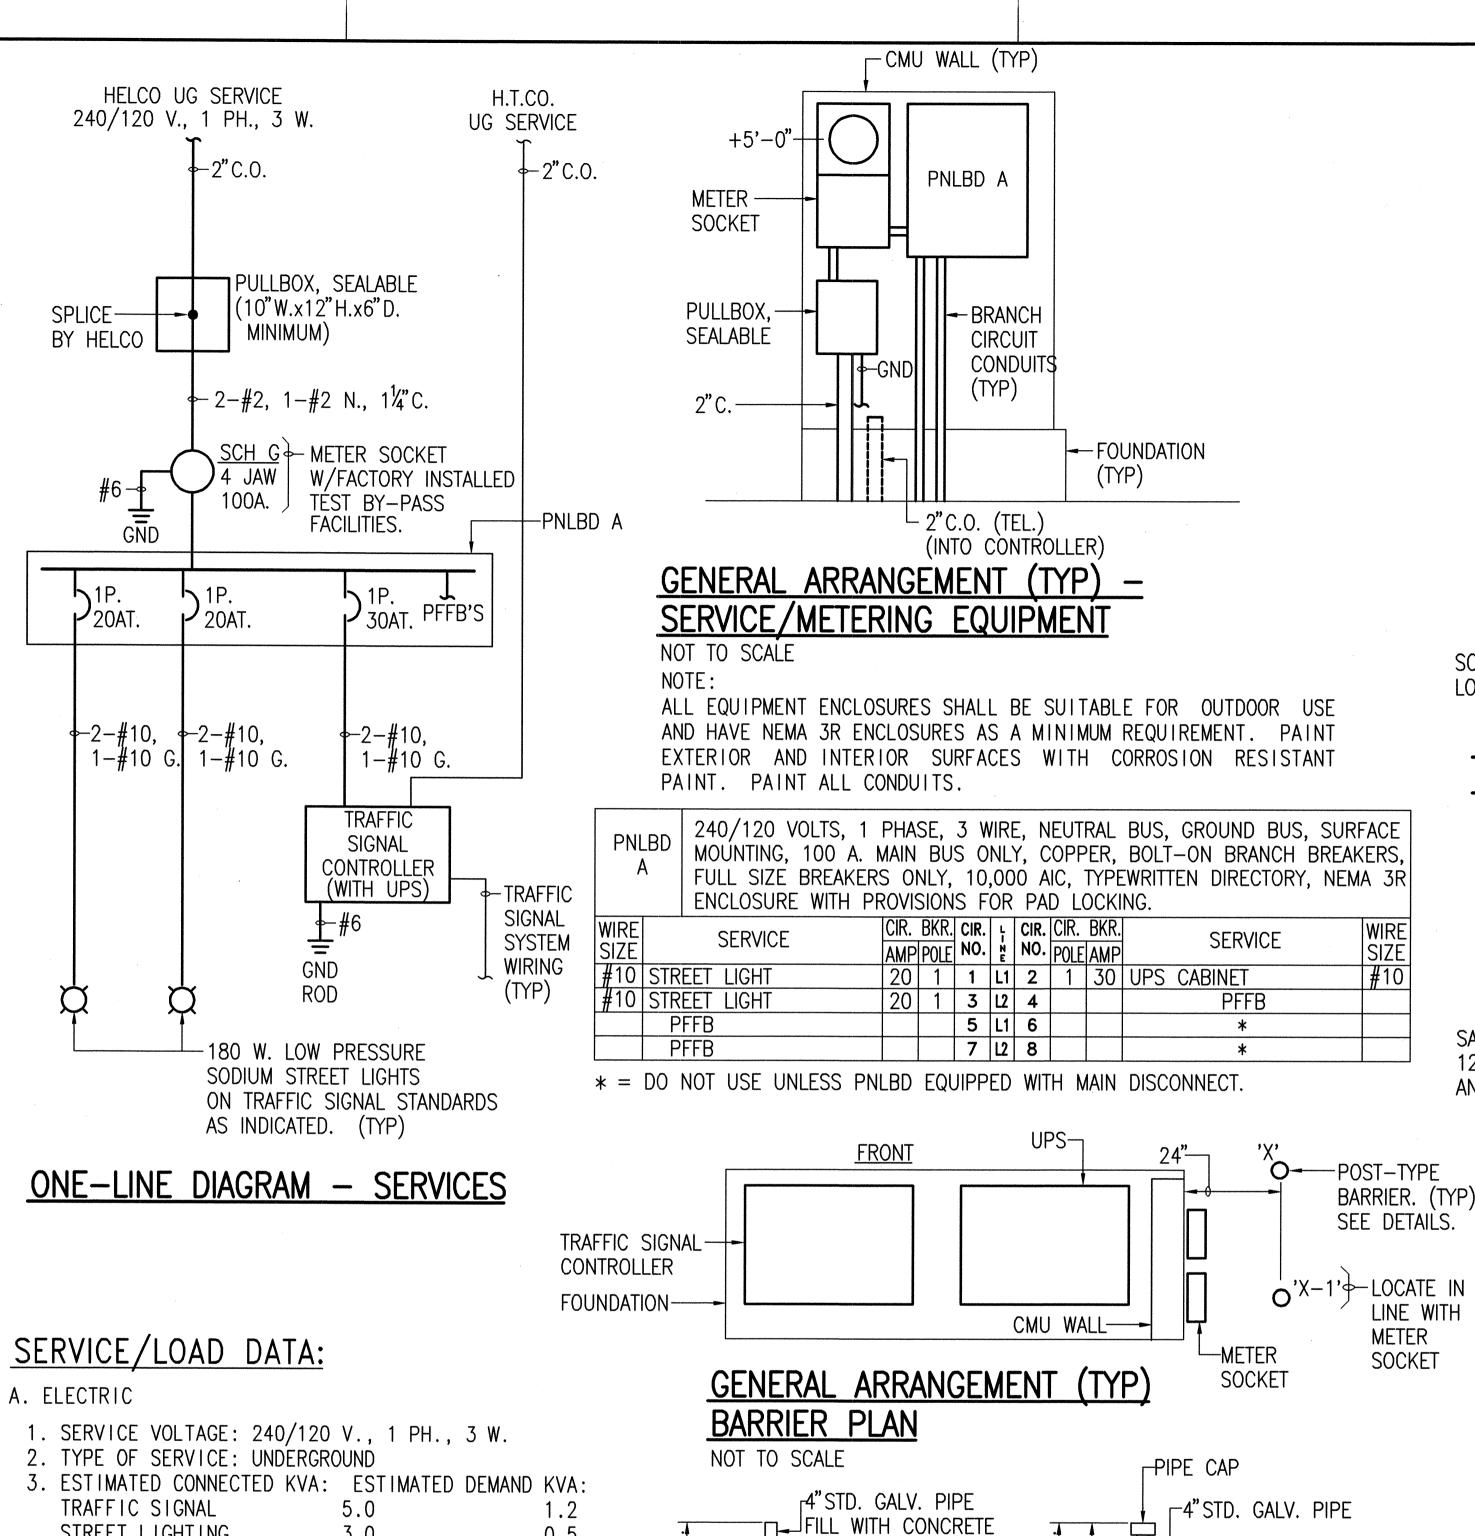


- UTILITY POLE (RISER POLE) ---- 1-LENGTH SCH. 40 PVC STUB-UP TO 12" ABOVE CONDUIT UP POLE COMPLETE FINISH GRADE FOR WITH COUPLING AT TOP END. TELEPHONE CONDUITS PLUG OR CAP TOP. UNLESS OTHERWISE REQUIRED BY HAWAIIAN TELEPHONE -TOP OF BEND TO BE COMPANY. A MIN. OF 6" ABOVE GROUND LEVEL. R=36" (MIN) ┌ GROUND LEVEL -18" MIN. 1:11: 1: 1: 1. -1-, --, -, -, -, -, -, -, SCH. 40 PVC, 36"-3" CONCRETE— -CONCRETE ENCASED LONG RADIUS BEND. **ENVELOPE** DUCTS AS INDICATED. GENERAL ARRANGEMENT (TYP)-

RISER CONDUIT DETAIL (TRAFFIC SIGNAL SYSTEM)


NOT TO SCALE

NOTE: PROVIDE QUANTITY AND SIZES AS INDICATED ON THE DRAWINGS. REFER TO HELCO'S DRAWINGS FOR ADDITIONAL RISER DETAIL REQUIREMENTS.

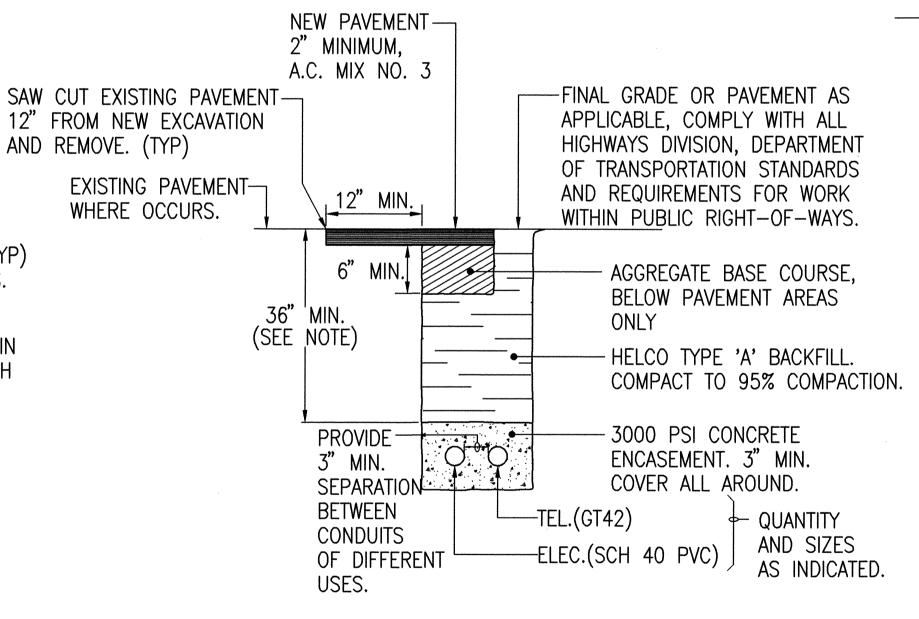

CURB. (TYP) GENERAL ARRANGEMENT (TYP) LOCATION FOR TRAFFIC SIGNAL STANDARD FOUNDATION NOT TO SCALE

(TYPICAL FOR NON-SIDEWALK LOCATIONS)

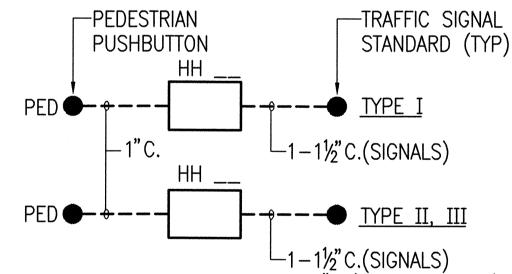

1-1½"C.(SIGNALS) 1-1"C.(STREET LIGHTS) GENERAL ARRANGEMENT (TYP) REQUIRED CONDUITS BETWEEN AND TRAFFIC SIGNAL STANDARDS/PED PUSHBUTTON

NOT TO SCALE

LICENSED

PROFESSIONAL

ENGINEER

3539-E

STATE OF HAWAII DEPARTMENT OF TRANSPORTATION HIGHWAYS DIVISION

ELECTRICAL PLAN

KEA'AU-PAHOA ROAD VICINITY OF KEA'AU TOWN (KEA'AU BYPASS ROAD) PROJECT NO. 130B-01-92, PHASE 1

Scale: As Shown Date: *May*, 1997 20 SHEETS SHEET No. OF

STREET LIGHTING $\frac{0.5}{1.7}$ 3.0 TOTAL 8.0

4. ESTIMATED TOTAL DEMAND KVA: 2.0

5. DESIGN SERVICE CAPACITY: 100 AMPERES 6. METERING: RATE SCH G, HELCO STD. B-5 (4 JAW, 100 A. METER SOCKET)

7. BILLING ADDRESS: HIGHWAYS DIVISION DEPARTMENT OF TRANSPORTATION 50 MAKAALA STREET HILO, HAWAII 96720

B. TELEPHONE

1. ESTIMATED LINES REQUIRED: 1 LINE

2. PROPOSED SERVICE CAPACITY: 1 LINE (DROP SERVICE)

AND PROPERTY AND THE PROPERTY AND

3. SERVICE CABINET SIZE: NONE

4. SERVICE CONDUIT: 2"

GENERAL ARRANGEMENT (TYP) -POST-TYPE BARRIERS NOT TO SCALE

TO WEIGH APPROX.

r5"STD. GALV. PIPE

FOUNDATION

-3/4"ø GALV.

150 LBS.

CONCRETE

DETAIL 'X'

NOTE: ALL INSTALLATION SHALL COMPLY WITH HELCO STD. 30-5000. POSTS SHALL BE PAINTED YELLOW PER ANSI Z53.1

DETAIL 'X-1'

WELD 2 NUTS

_5"STD. GALV. PIPE

CONCRETE

grade Market

FOUNDATION

─3/4"ø GALV.

180° APART.

 $-(5/8"\phi)$

CORROSION PROTECTION PAINT

DRAINAGE STRUCTURES, OR OTHER SYSTEMS.

GENERAL ARRANGEMENT (TYP) -

AMERON "AMERLOCK 400" EPOXY COATING OR APPROVED EQUIVALENT.

2. ALUMINUM

NOT TO SCALE

3. APPLY IN ACCORDANCE WITH MANUFACTURER'S INSTRUCTIONS.

DUCTLINE DETAIL (TYPICAL FOR NON-UTILITY DUCTLINE.)

AND AVOID INTERFERENCES WITH ALL EXISTING BURIED UTILITY LINES,

NOTE: INDICATED BURY DEPTH SHALL BE ADJUSTED IN THE FIELD TO CLEAR

SURVEY PLOTTED BRAWN BY TRACED BY DESIGNED BY QUANTITIES BY CHECKED BY

102

FISCAL SHEET TOTAL YEAR NO. SHEETS

102

- SIDEWALK

(TYP)

1997

R/W LINE

FRONT OF

CONTROLLER

R/W LINE

R/W LINE.

⊢PROVIDE 36" MIN ACCESS.

APPLICABLE.

EXTEND SIDEWALK AREA AS

FACE OF

TRAFFIC SIGNAL STANDARD

FOUNDATION. LOCATE AT

-SERVICE/

METERING

EQUIPMENT

FED. AID PROJ. NO.

130B-01-92

GENERAL ARRANGEMENT (TYP)

CONTROLLER LOCATION

(TYPICAL FOR NON-SIDEWALK LOCATIONS)

FED. ROAD DIST. NO.

HAWAII

PROVIDE 36" MIN ACCESS.-

EXTEND SIDEWALK AREA AS

NOT TO SCALE

SIDEWALK


(TYP)


APPLICABLE.


CONTROLLER-


FOUNDATION


HAW.

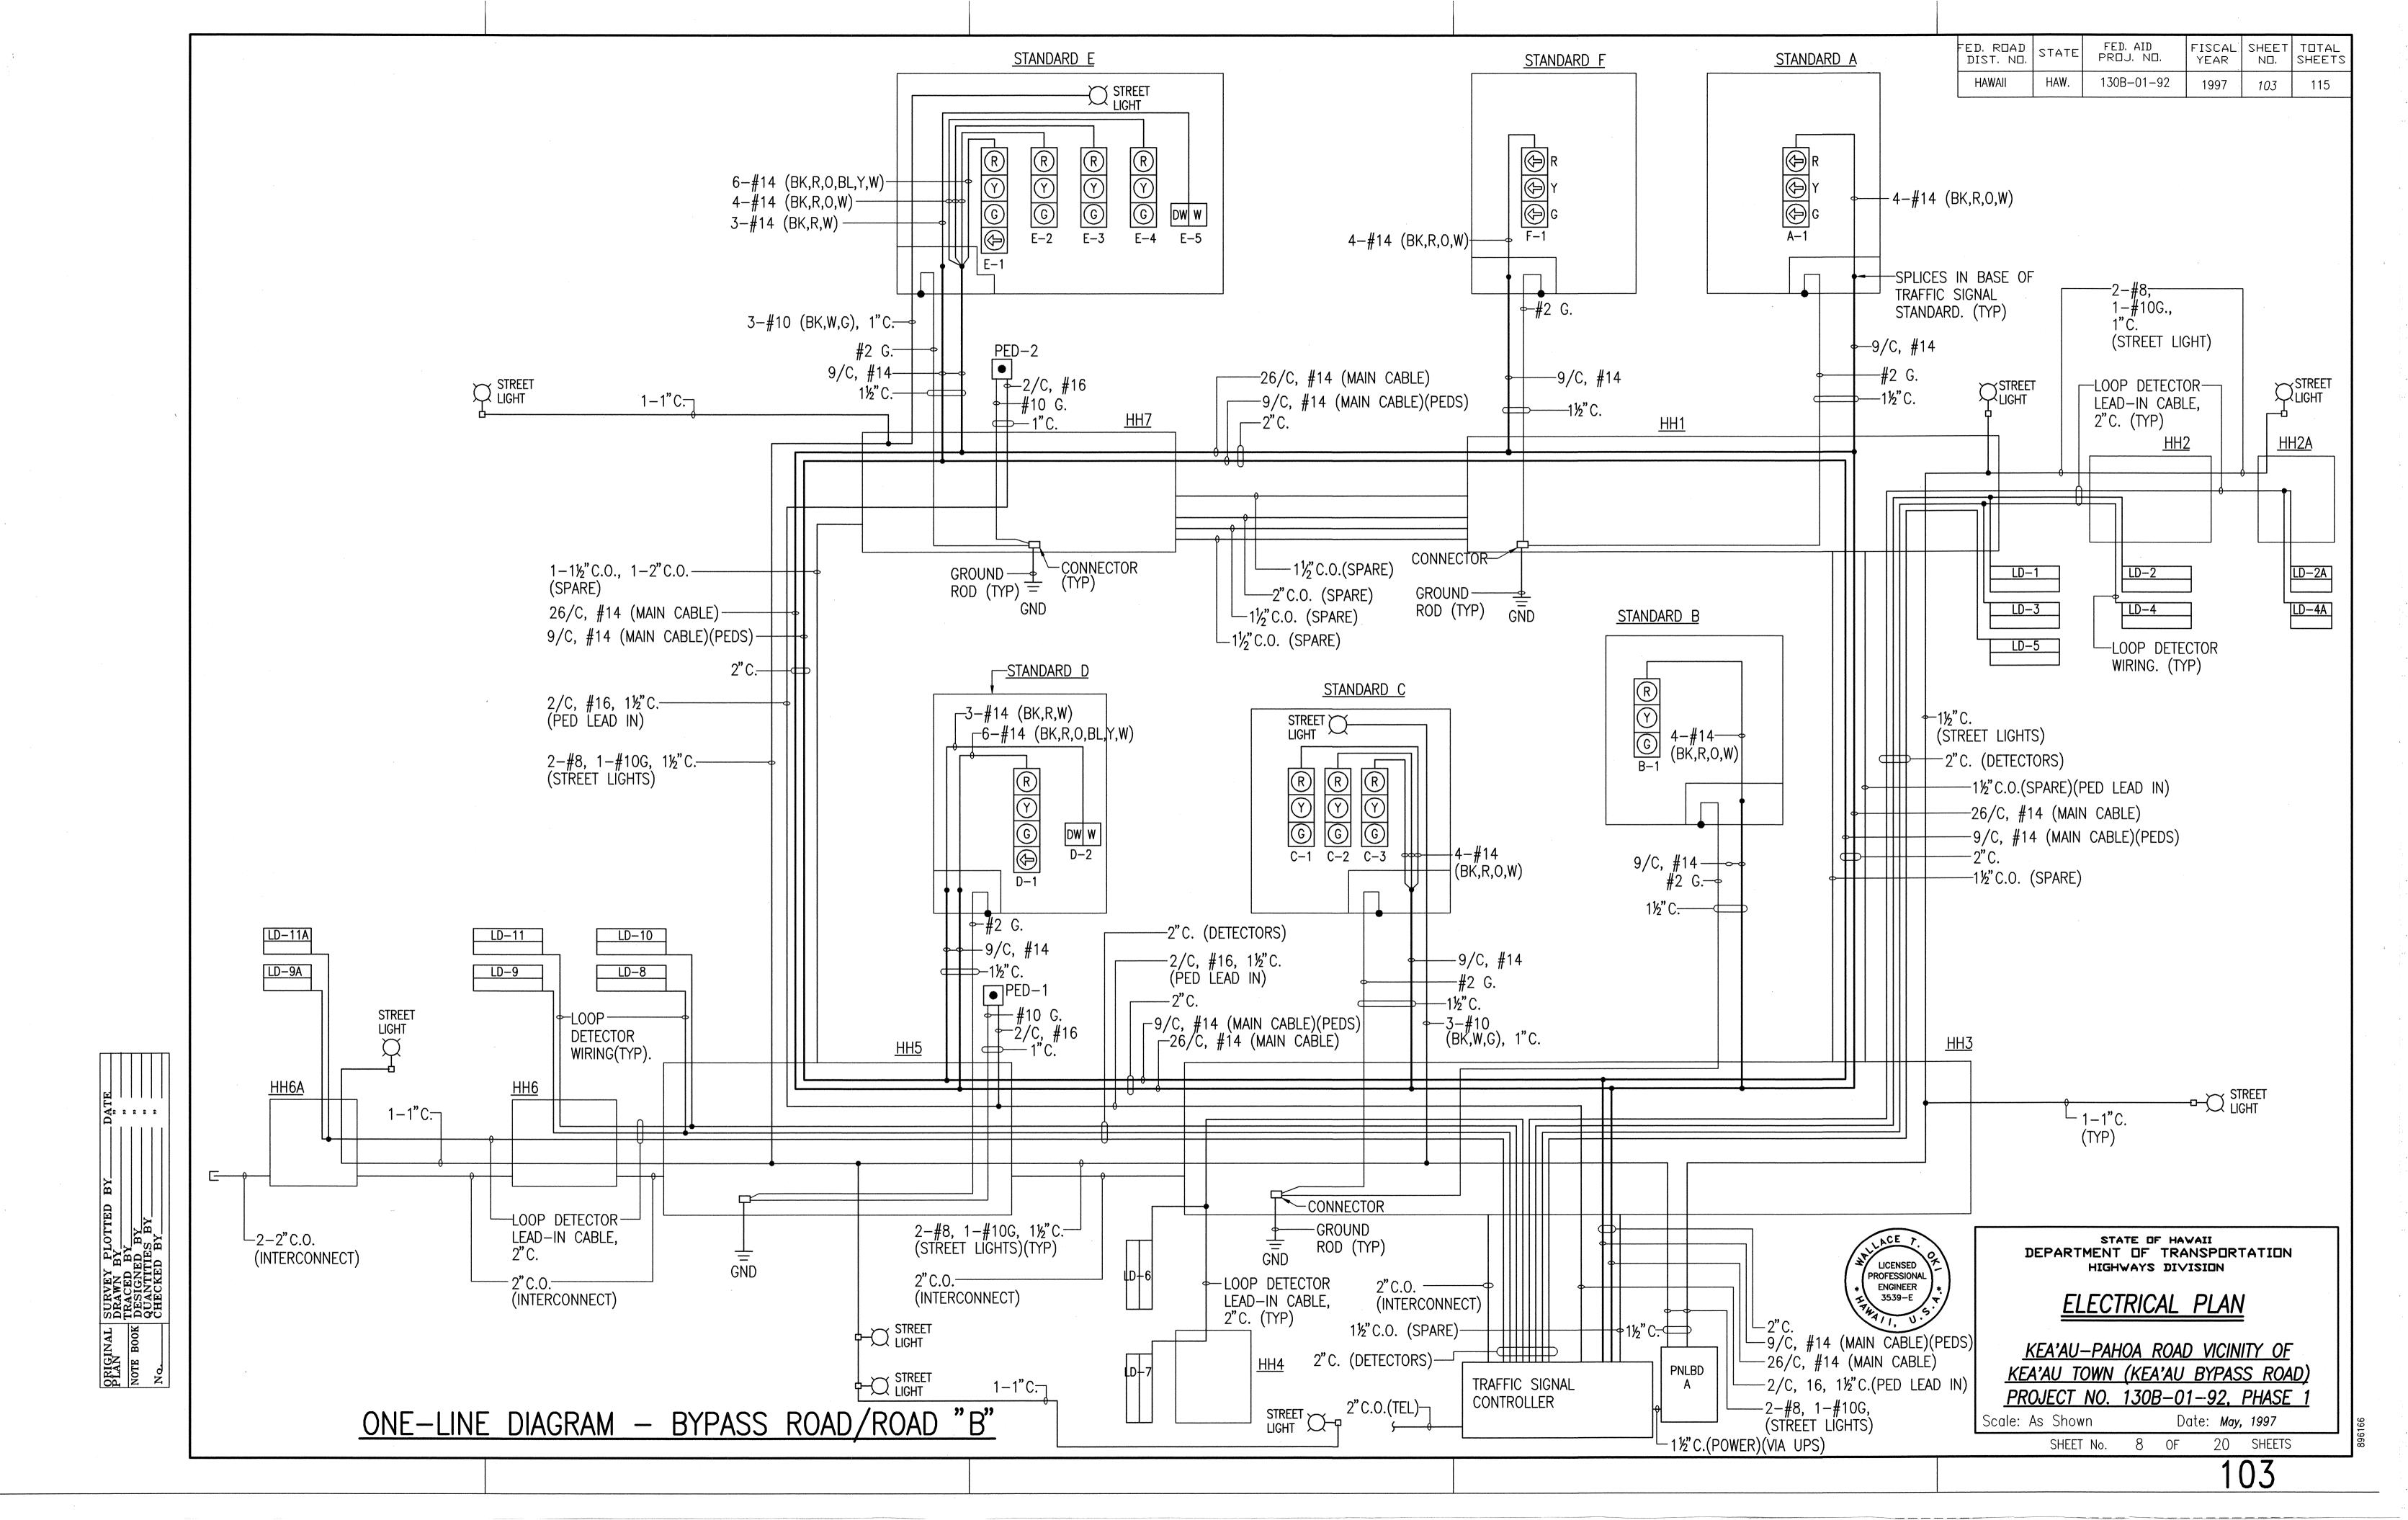


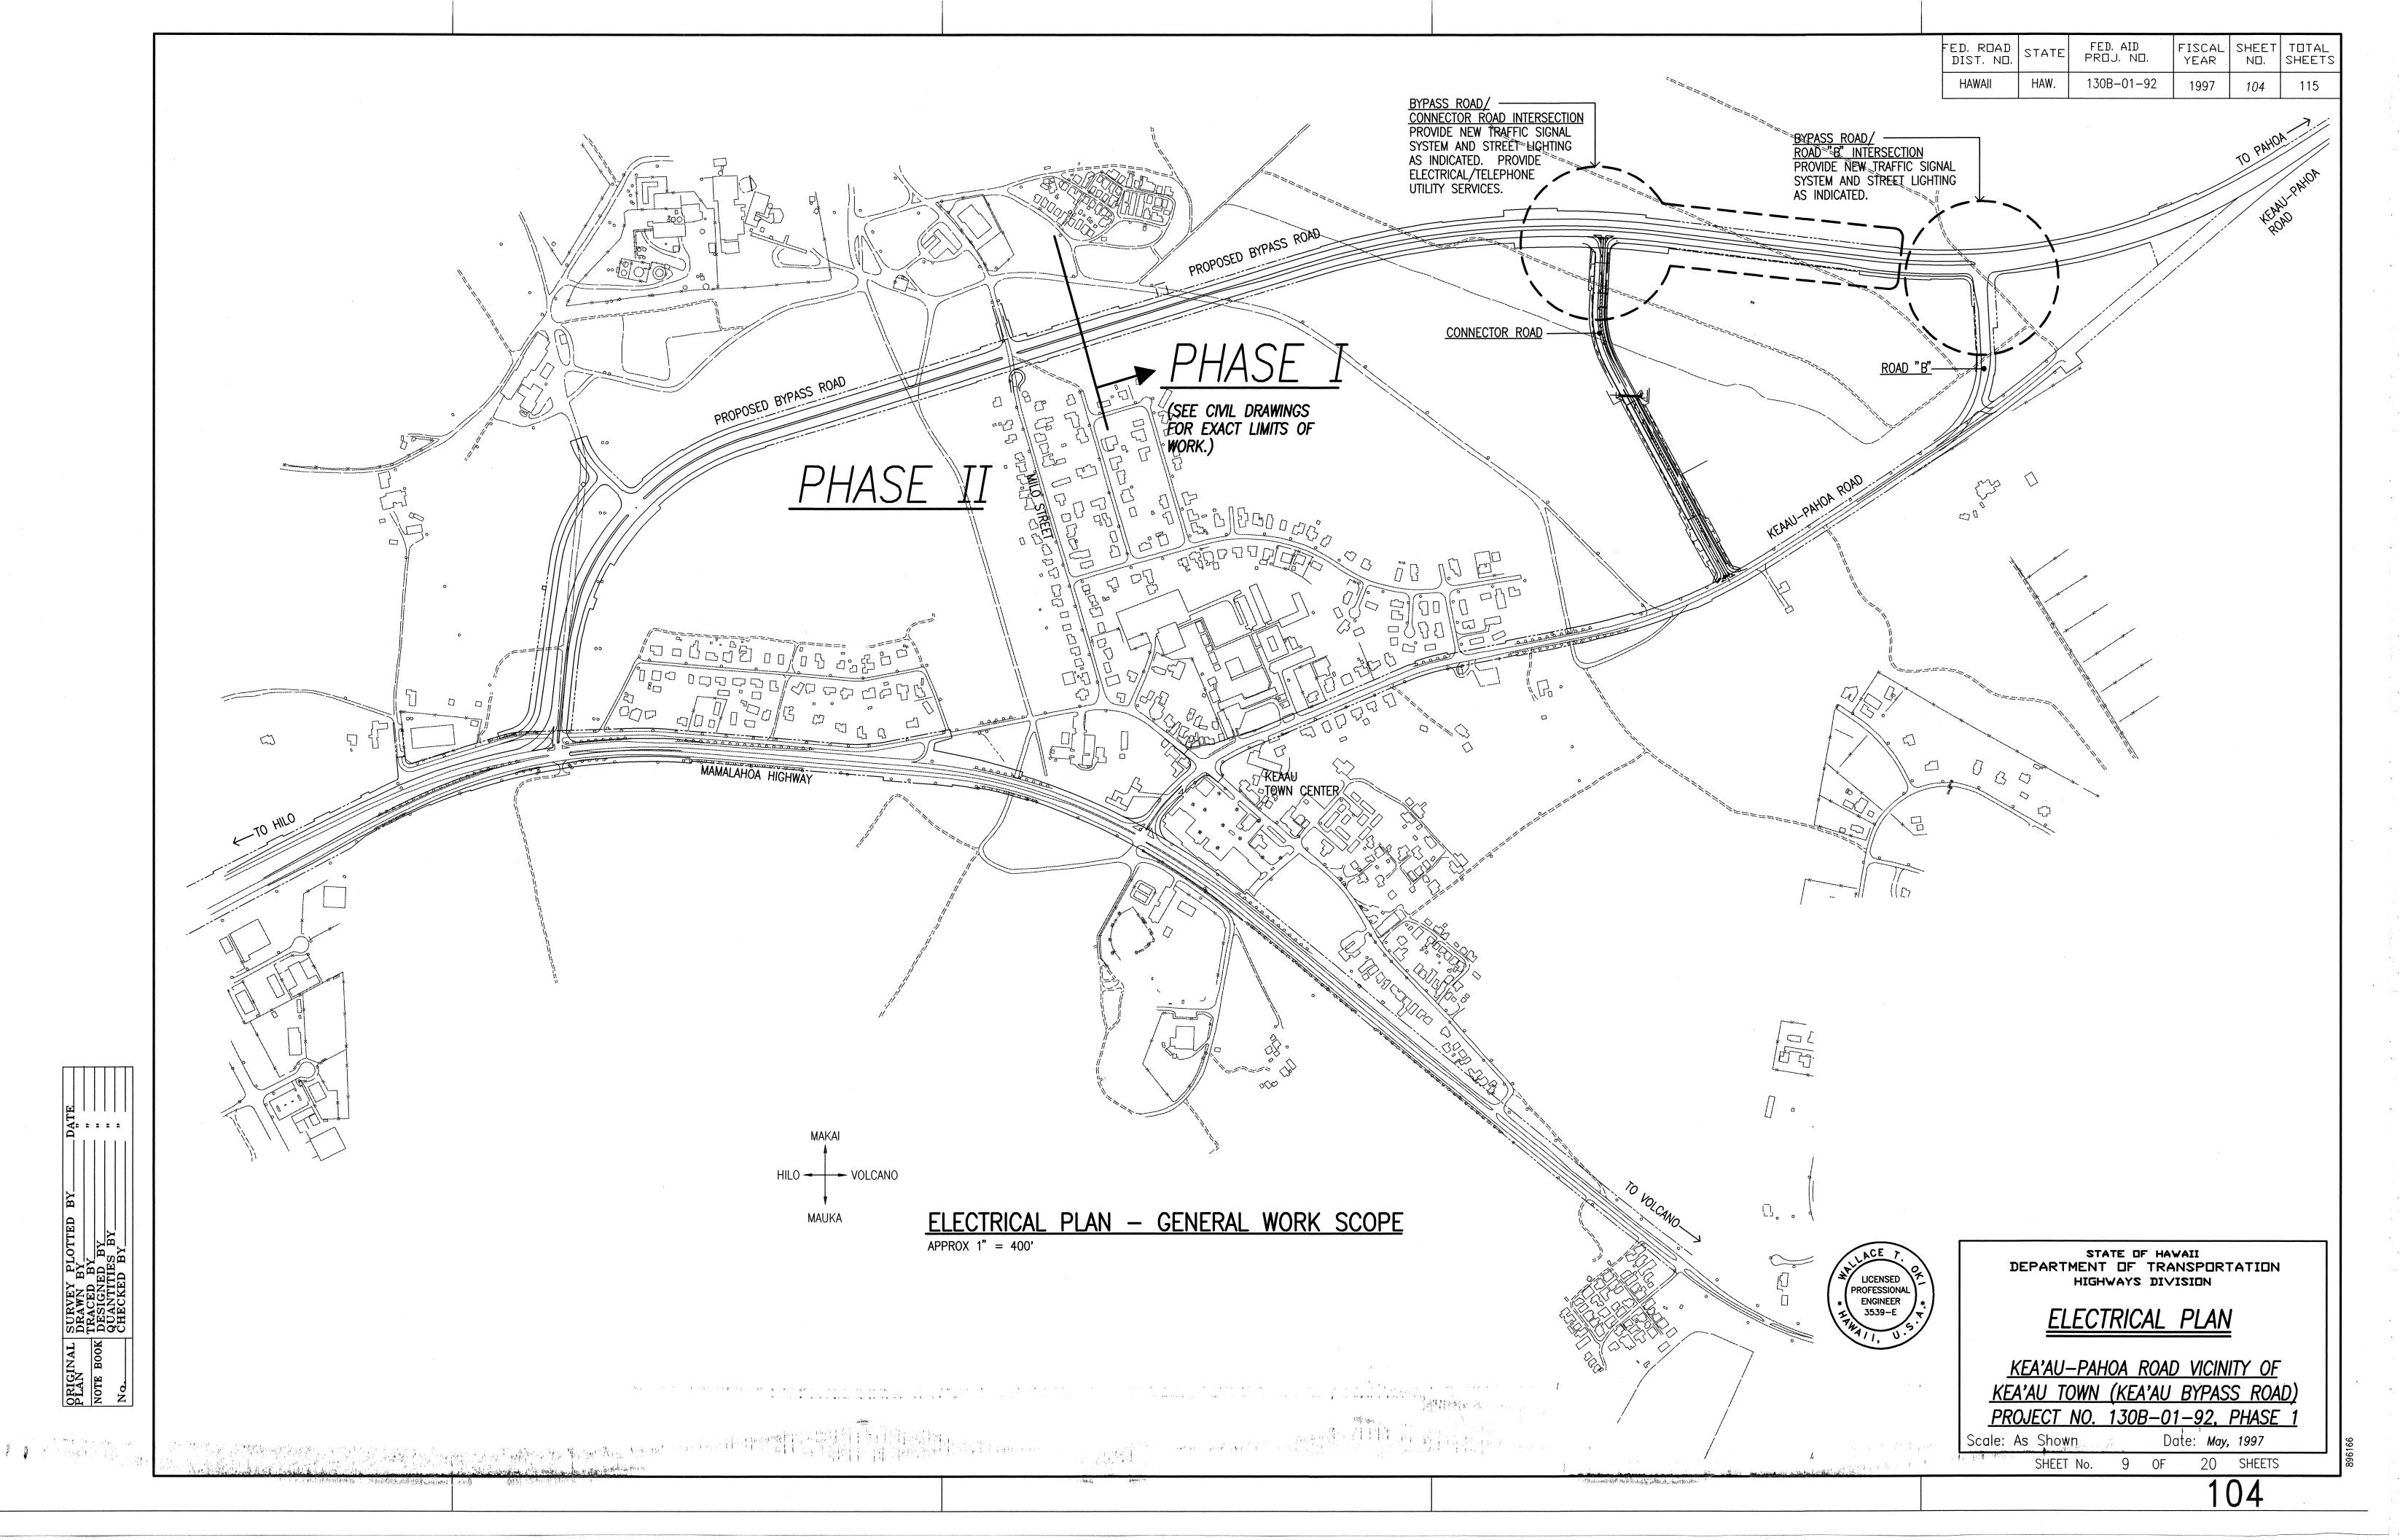

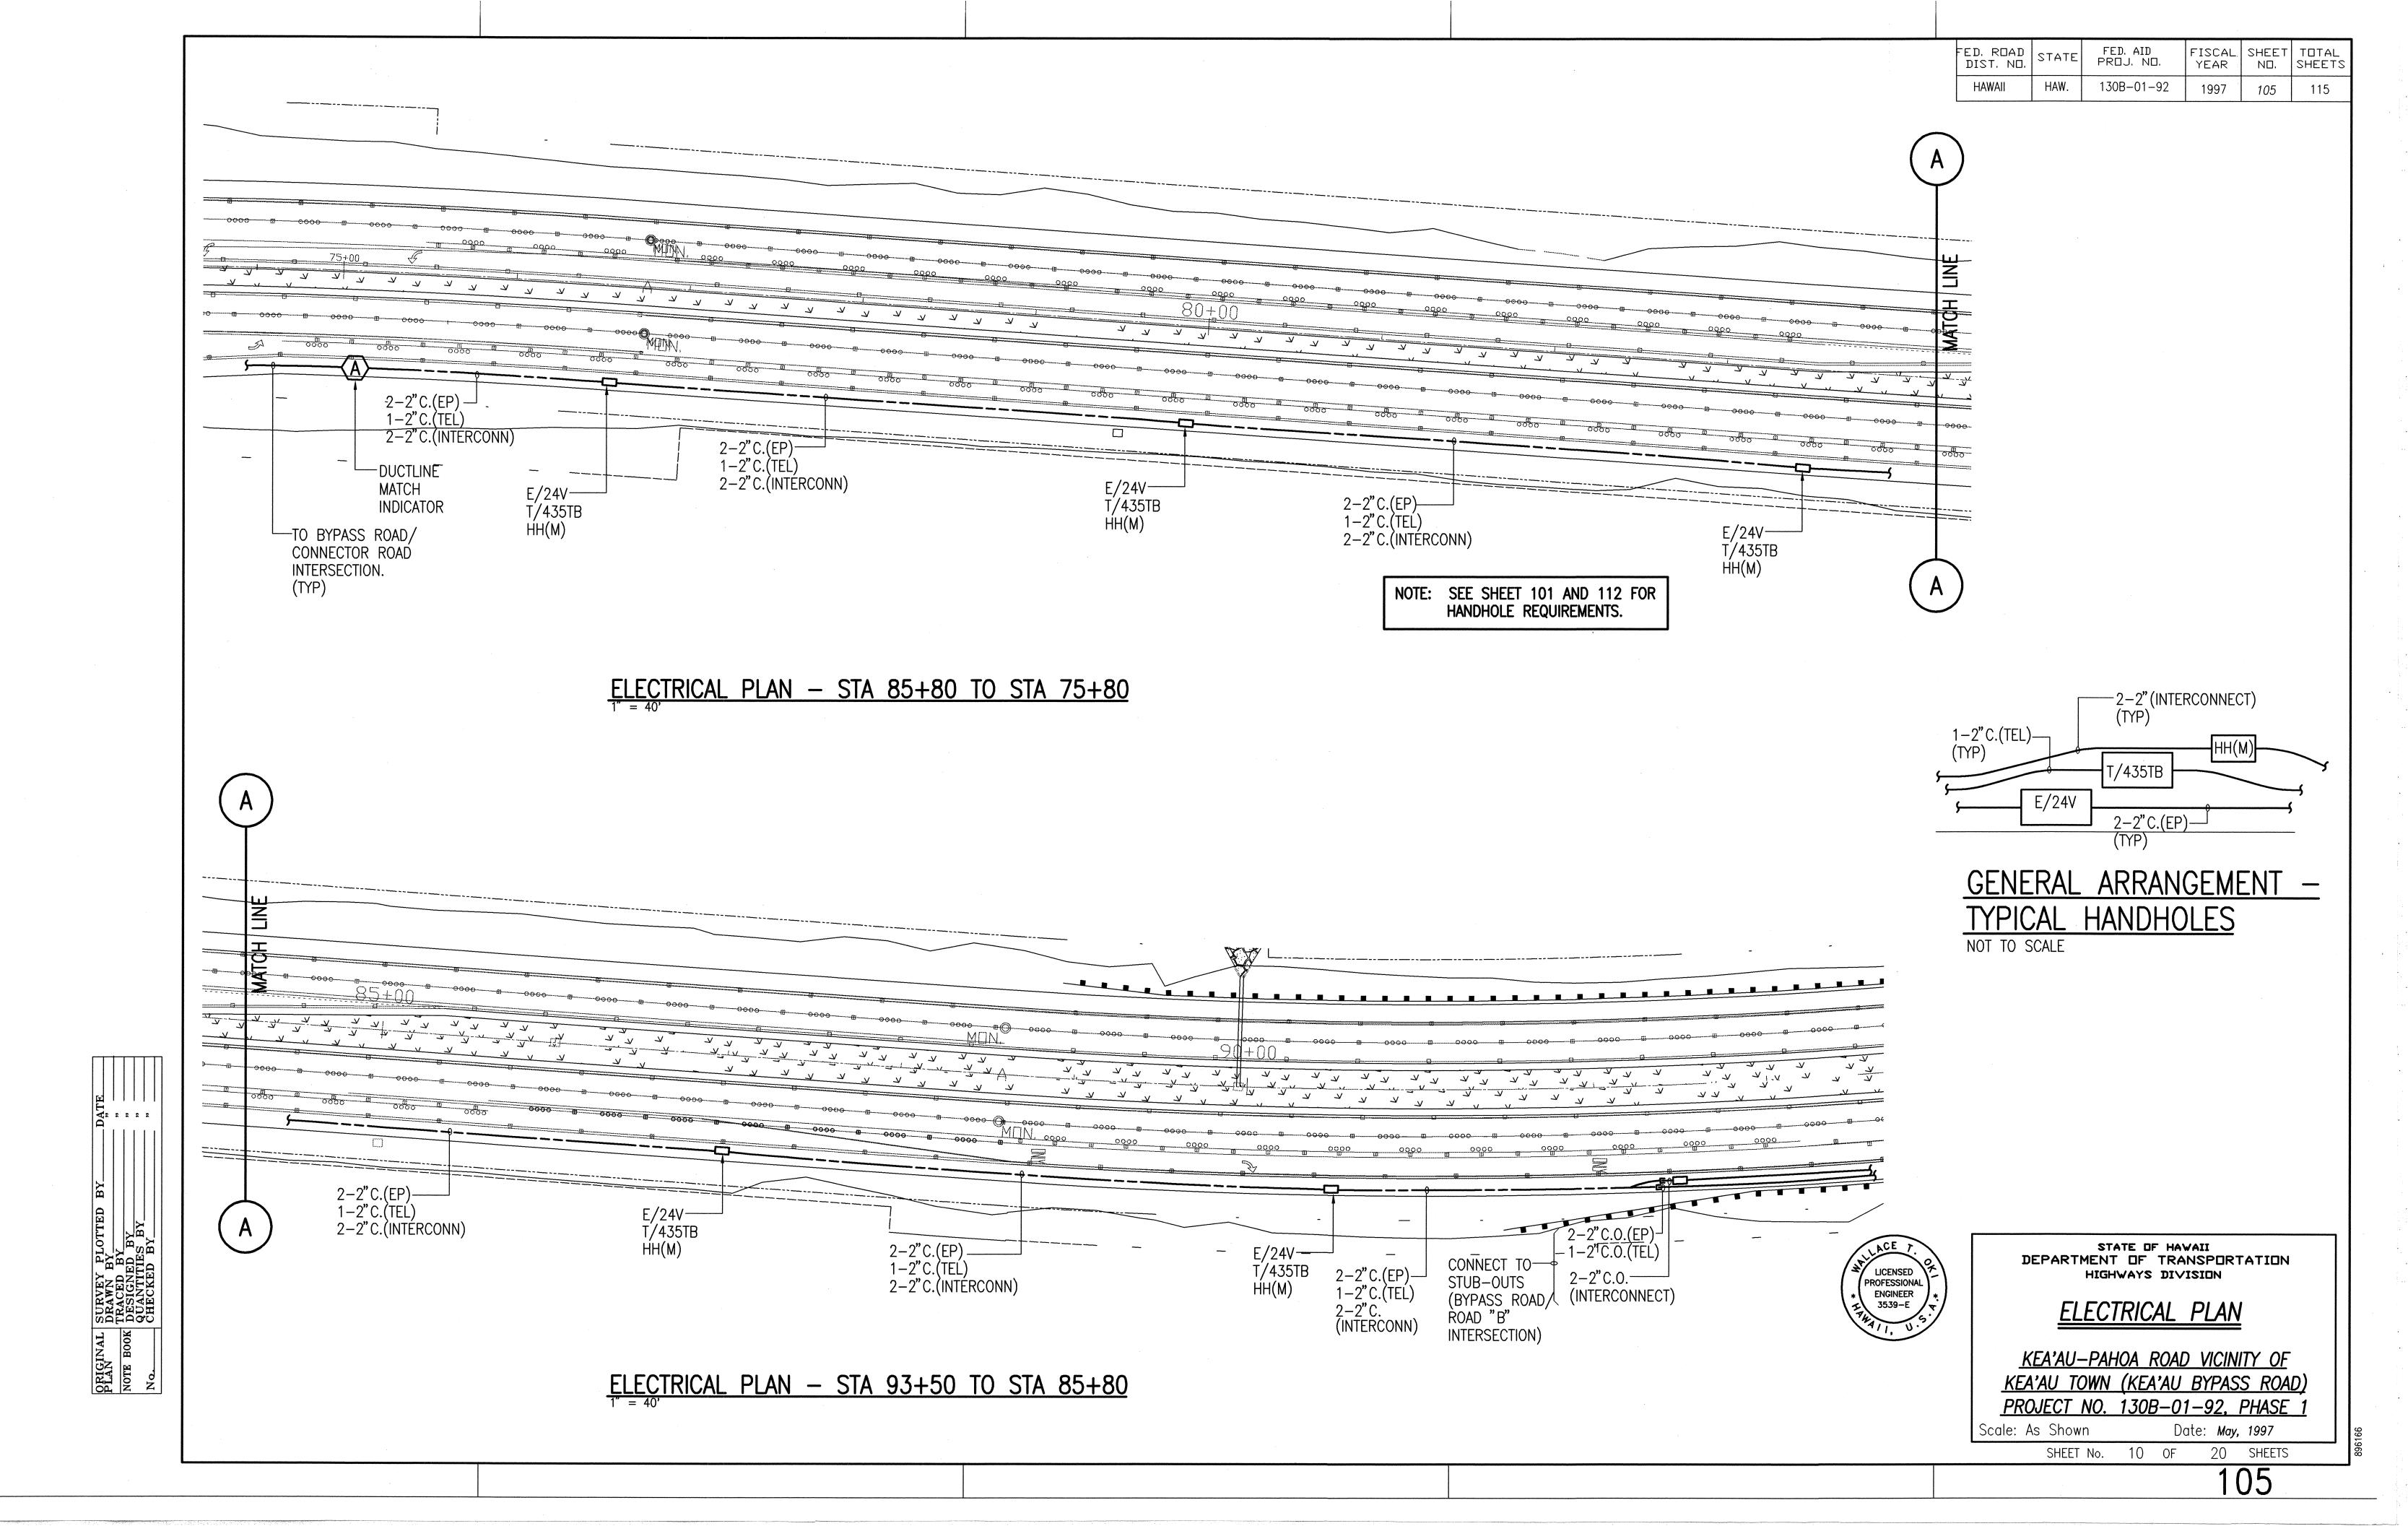

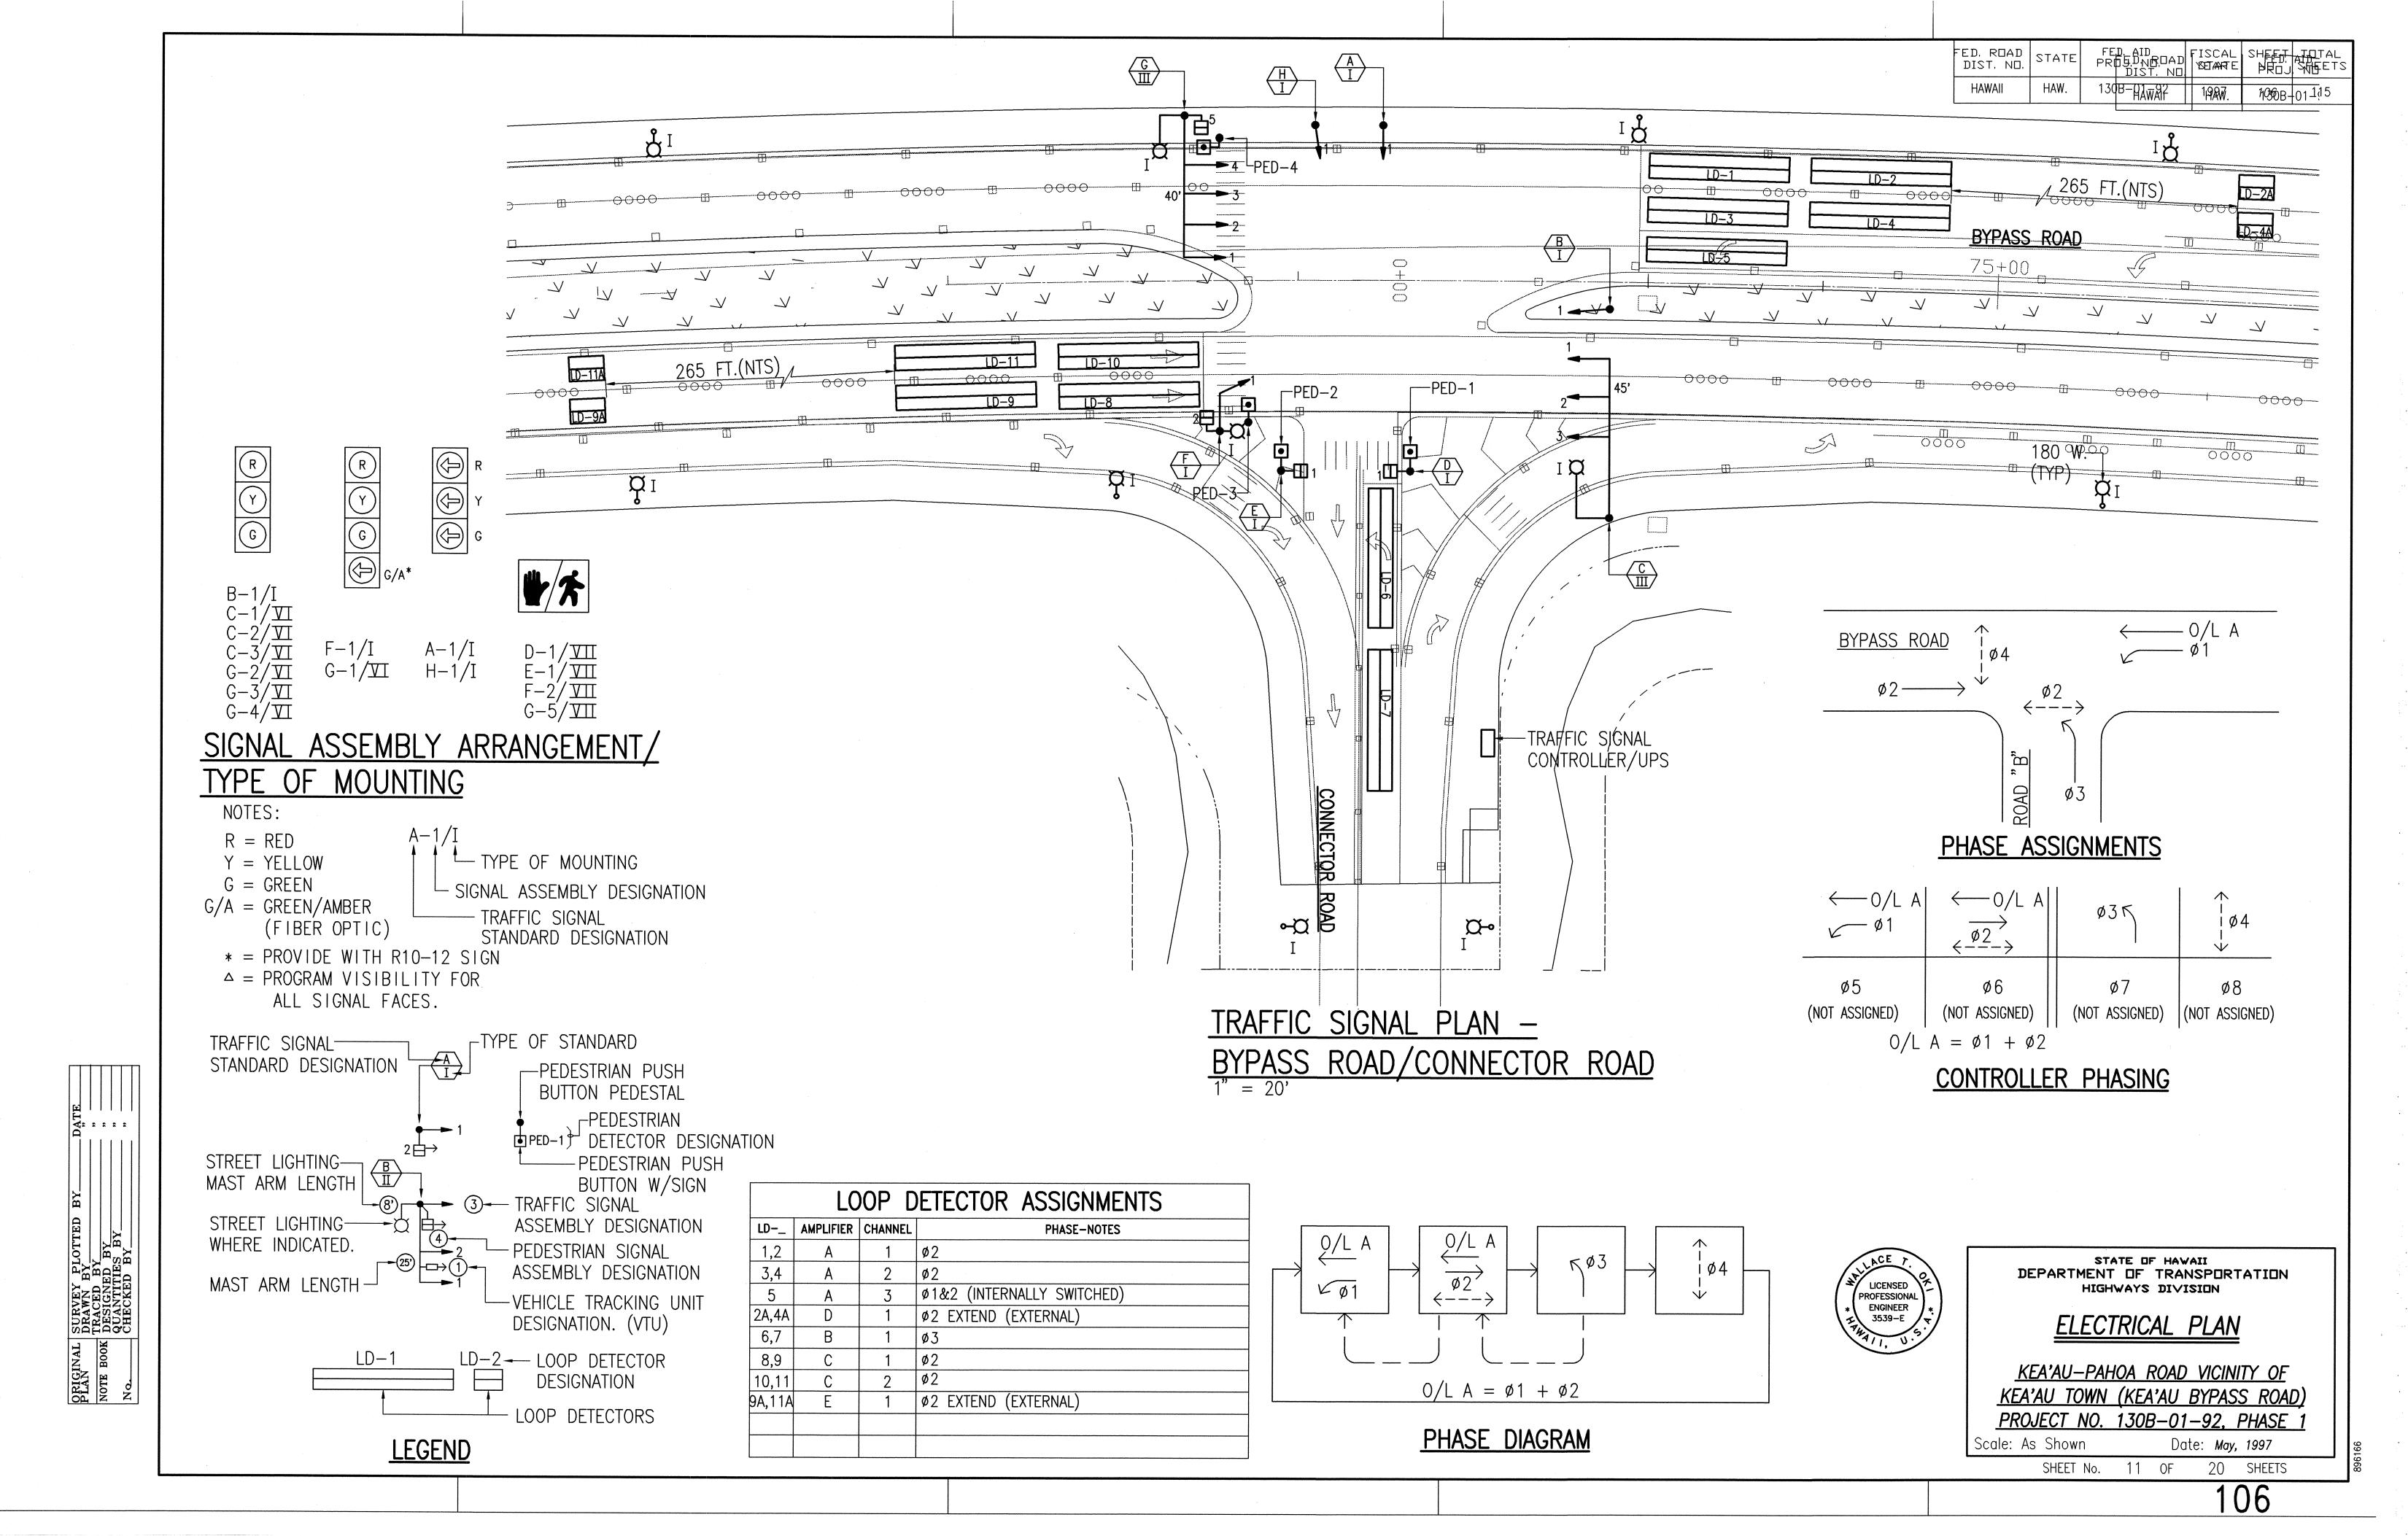

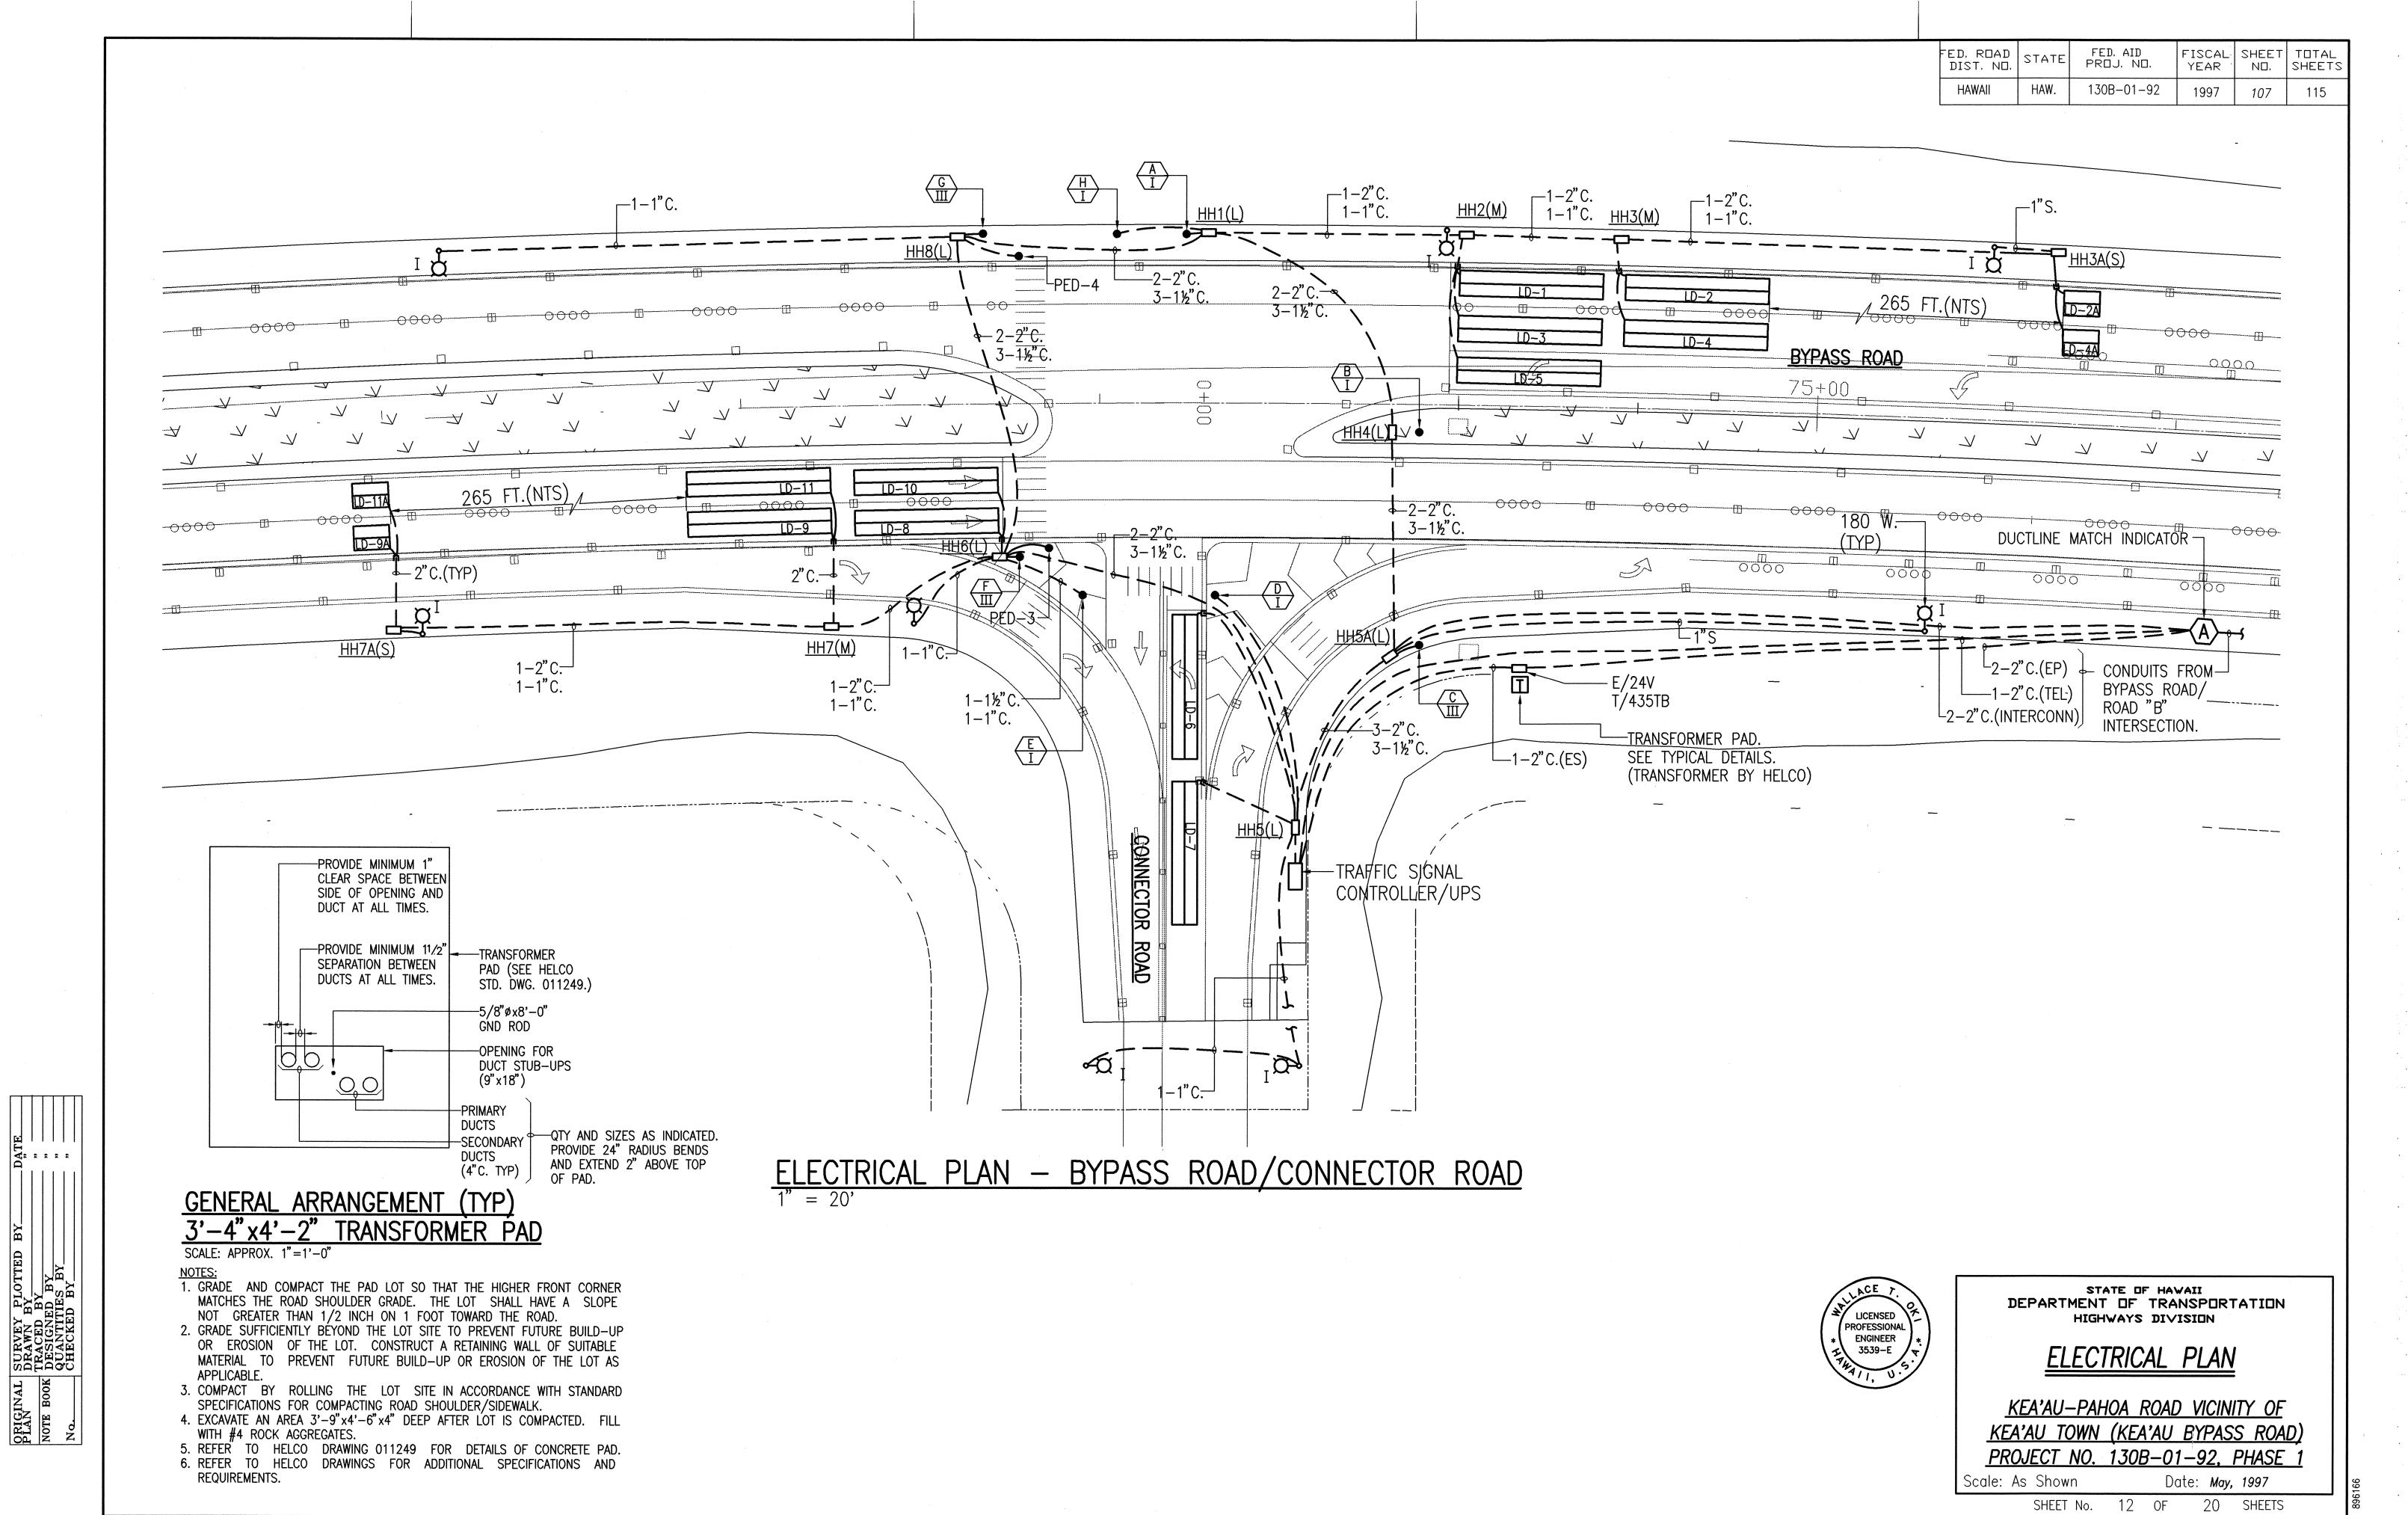

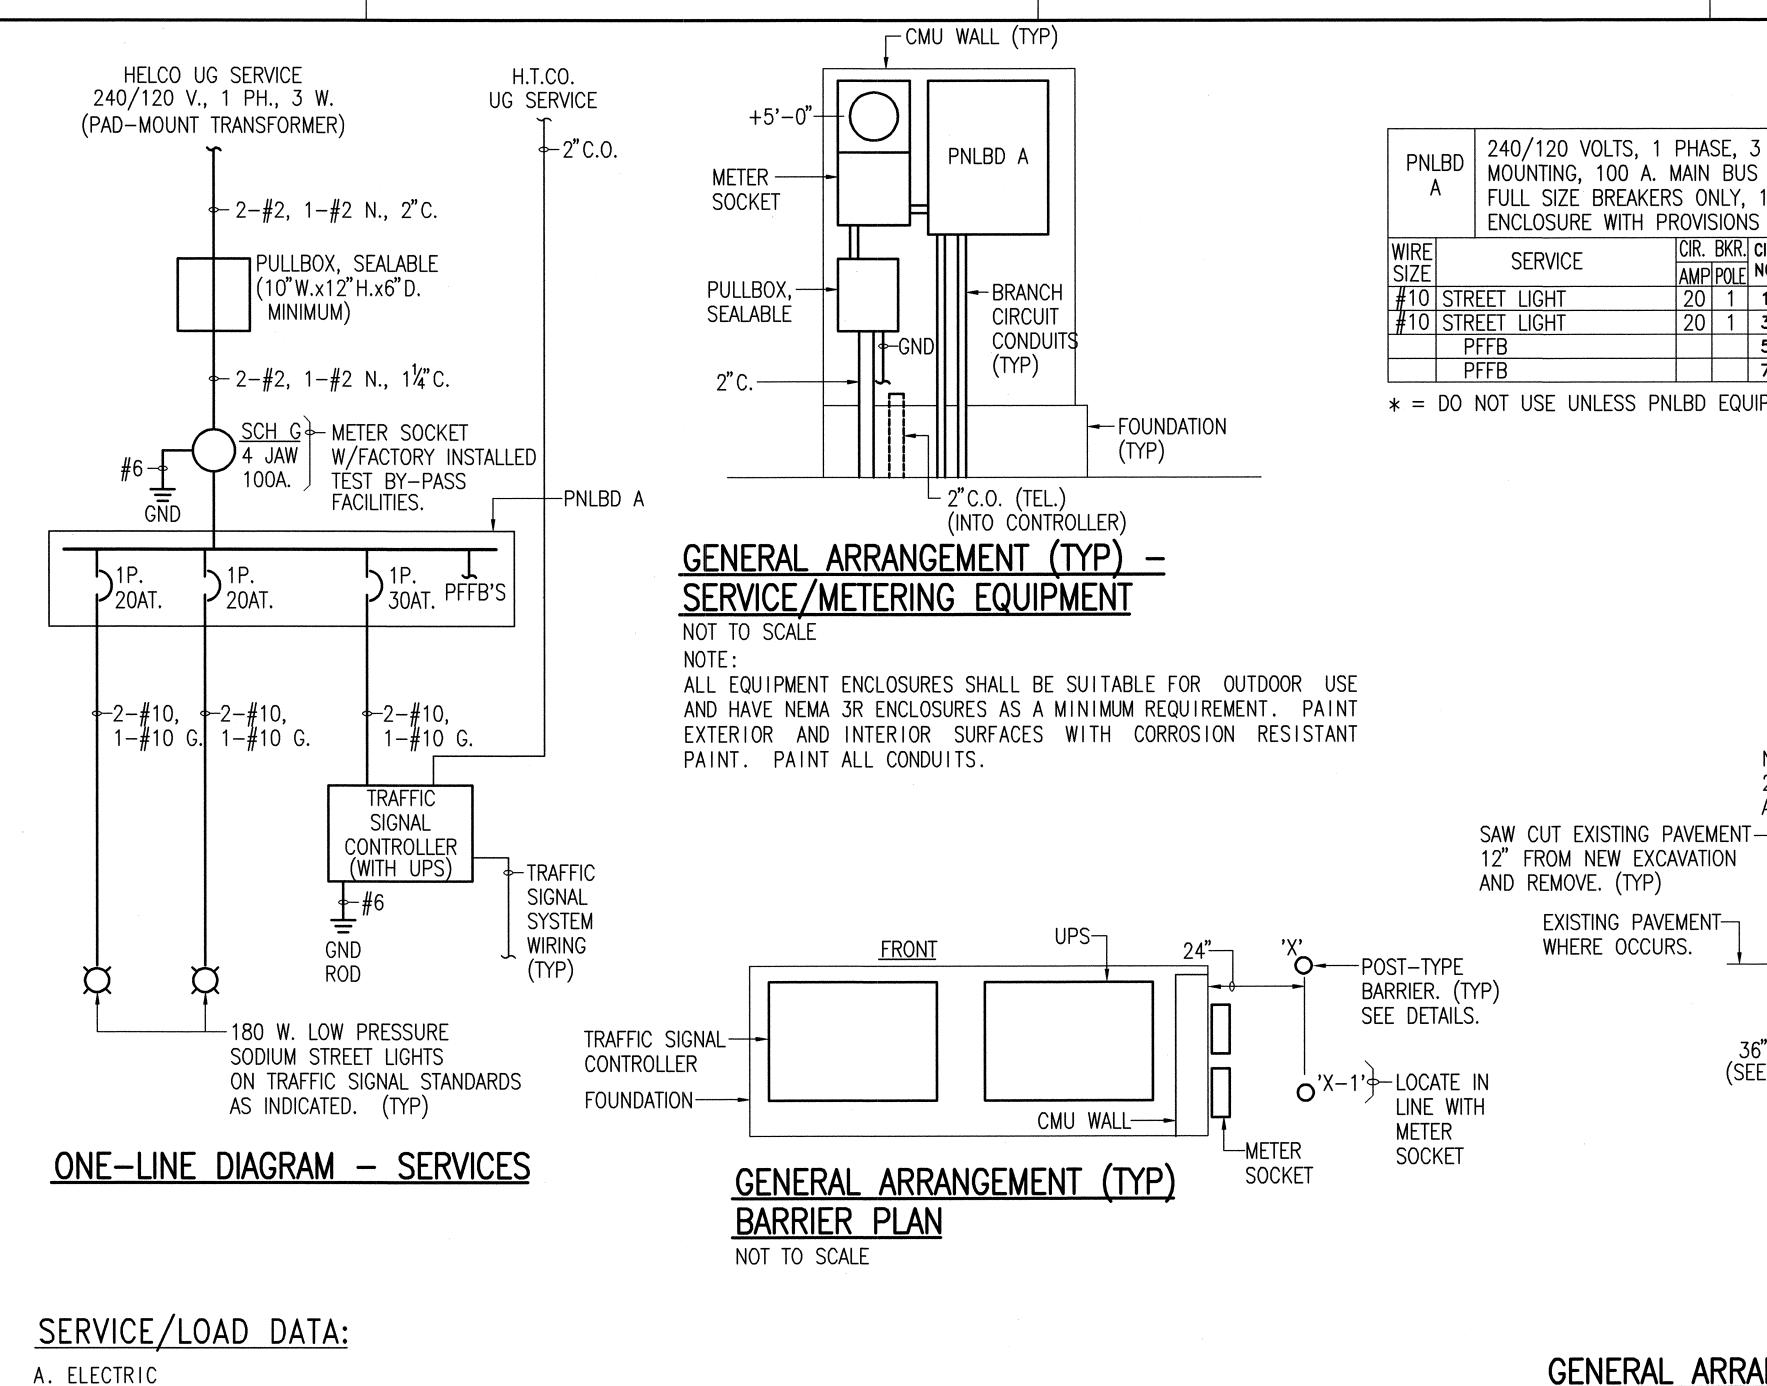

240/120 VOLTS, 1 PHASE, 3 WIRE, NEUTRAL BUS, GROUND BUS, SURFACE MOUNTING, 100 A. MAIN BUS ONLY, COPPER, BOLT-ON BRANCH BREAKERS, FULL SIZE BREAKERS ONLY, 10,000 AIC, TYPEWRITTEN DIRECTORY, NEMA 3R ENCLOSURE WITH PROVISIONS FOR PAD LOCKING. CIR. BKR. CIR. L CIR. CIR. BKR. SERVICE SERVICE AMP POLE NO. NO. POLE AMP SIZE 20 1 1 L1 2 1 30 UPS CABINET #10 STREET LIGHT #10 PFFB #10 STREET LIGHT 20 1 3 L2 4 5 L1 6 * 7 L2 8

NEW PAVEMENT ---

2" MINIMUM.

(SEE NOTE)

3" MIN.

SEPARATION


BETWEEN

CONDUITS

OF DIFFERENT

A.C. MIX NO. 3


* = DO NOT USE UNLESS PNLBD EQUIPPED WITH MAIN DISCONNECT.

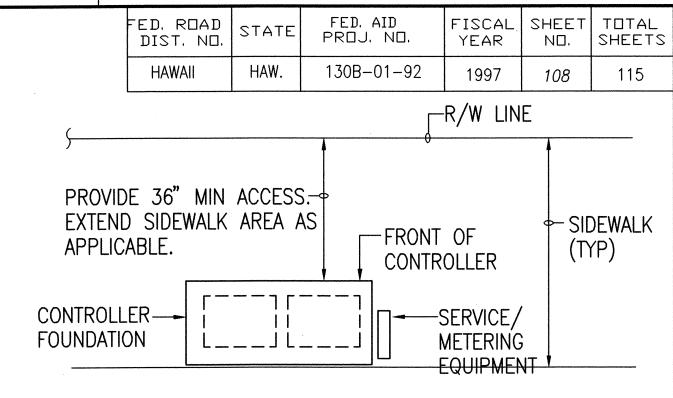

GENERAL ARRANGEMENT (TYP) CONTROLLER LOCATION

NOT TO SCALE

(TYPICAL FOR NON-SIDEWALK LOCATIONS)

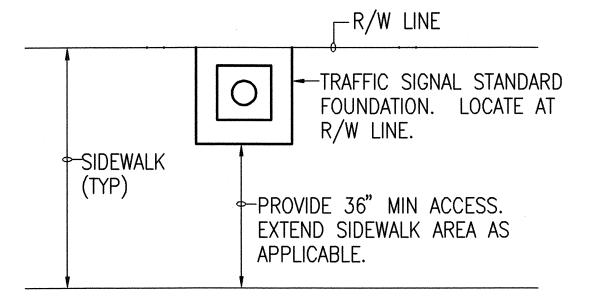


FACE OF CURB. (TYP)

GENERAL ARRANGEMENT LOCATION FOR TRAFFIC SIGNAL STANDARD FOUNDATION

NOT TO SCALE

COMPACT TO 95% COMPACTION (TYPICAL FOR NON-SIDEWALK LOCATIONS)

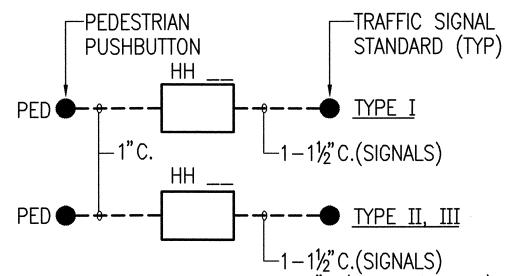

1-1½"C.(SIGNALS) 1-1"C.(STREET LIGHTS) GENERAL ARRANGEMENT (TYP) REQUIRED CONDUITS BETWEEN AND TRAFFIC SIGNAL STANDARDS/PED PUSHBUTTON

NOT TO SCALE

LICENSED **PROFESSIONAL ENGINEER** 3539-E

-FINAL GRADE OR PAVEMENT AS

APPLICABLE, COMPLY WITH ALL

HIGHWAYS DIVISION, DEPARTMENT

OF TRANSPORTATION STANDARDS

AND REQUIREMENTS FOR WORK

ONLY

-ELEC.(SCH 40 PVC)

-TEL.(GT42)

WITHIN PUBLIC RIGHT-OF-WAYS.

AGGREGATE BASE COURSE,

BELOW PAVEMENT AREAS

HELCO TYPE 'A' BACKFILL.

- QUANTITY

AND SIZES

AS INDICATED.

- 3000 PSI CONCRETE

ENCASEMENT. 3" MIN

COVER ALL AROUND.

DEPARTMENT OF TRANSPORTATION HIGHWAYS DIVISION

SHEET No. 13 OF

ELECTRICAL PLAN

STATE OF HAWAII

KEA'AU-PAHOA ROAD VICINITY OF KEA'AU TOWN (KEA'AU BYPASS ROAD) PROJECT NO. 130B-01-92, PHASE 1 Scale: As Shown Date: May, 1997


GENERAL ARRANGEMENT (TYP) - DUCTLINE DETAIL


NOT TO SCALE

EXISTING PAVEMENT—

WHERE OCCURS.

NOTE: INDICATED BURY DEPTH SHALL BE ADJUSTED IN THE FIELD TO CLEAR AND AVOID INTERFERENCES WITH ALL EXISTING BURIED UTILITY LINES, DRAINAGE STRUCTURES, OR OTHER SYSTEMS.

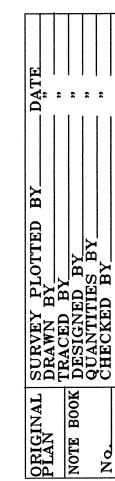

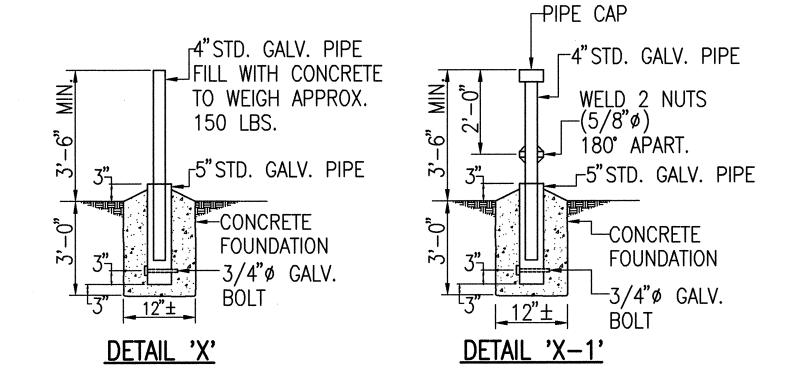

B. TELEPHONE

1. ESTIMATED LINES REQUIRED: 1 LINE

2. PROPOSED SERVICE CAPACITY: 1 LINE (DROP SERVICE)

1. SERVICE VOLTAGE: 240/120 V., 1 PH., 3 W.

3. ESTIMATED CONNECTED KVA: ESTIMATED DEMAND KVA:

3.0

8.0

DEPARTMENT OF TRANSPORTATION

(4 JAW, 100 A. METER SOCKET)

50 MAKAALA STREET

HILO, HAWAII 96720

 $\frac{0.5}{1.7}$

2. TYPE OF SERVICE: UNDERGROUND

4. ESTIMATED TOTAL DEMAND KVA: 2.0

5. DESIGN SERVICE CAPACITY: 100 AMPERES

6. METERING: RATE SCH G, HELCO STD. B-5

7. BILLING ADDRESS: HIGHWAYS DIVISION

TRAFFIC SIGNAL

STREET LIGHTING

TOTAL

3. SERVICE CABINET SIZE: NONE

4. SERVICE CONDUIT: 2"

GENERAL ARRANGEMENT (TYP) -POST-TYPE BARRIERS

NOT TO SCALE NOTE: ALL INSTALLATION SHALL COMPLY WITH HELCO STD. 30-5000.

CORROSION PROTECTION PAINT


AMERON "AMERLOCK 400" EPOXY COATING OR APPROVED EQUIVALENT.


rest energial transfer and the first

2. ALUMINUM


3. APPLY IN ACCORDANCE WITH MANUFACTURER'S INSTRUCTIONS.

20 SHEETS

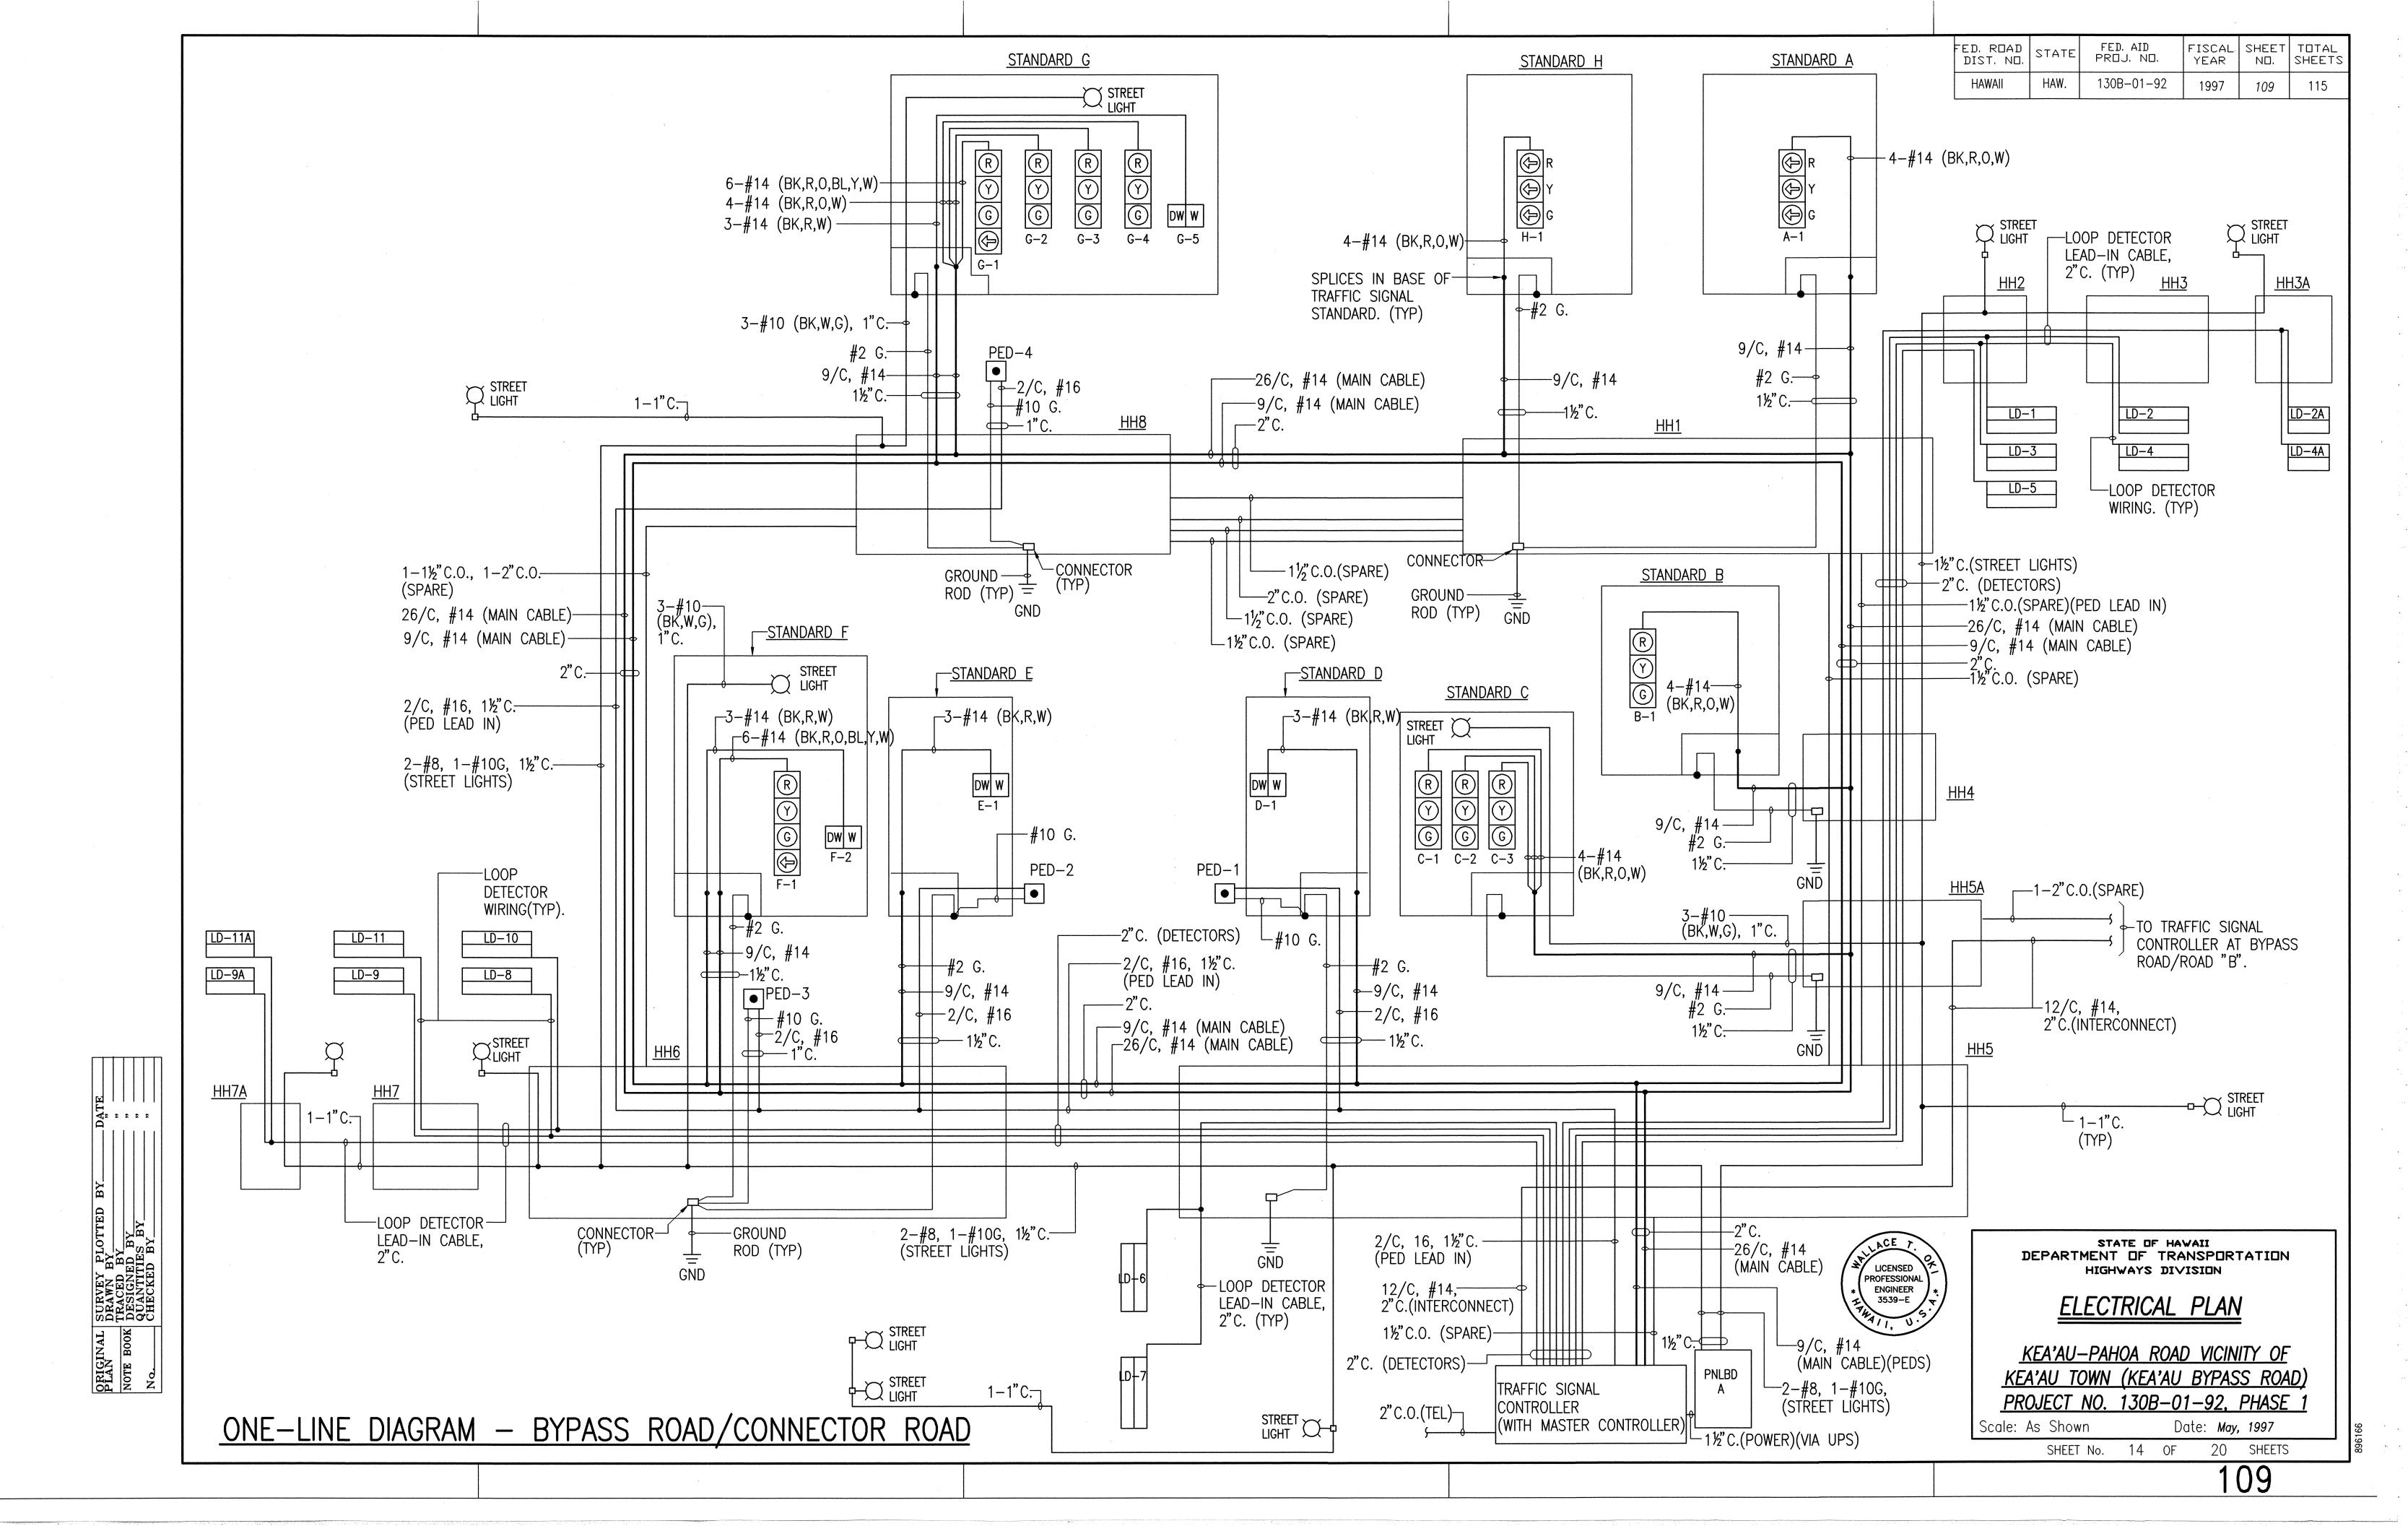

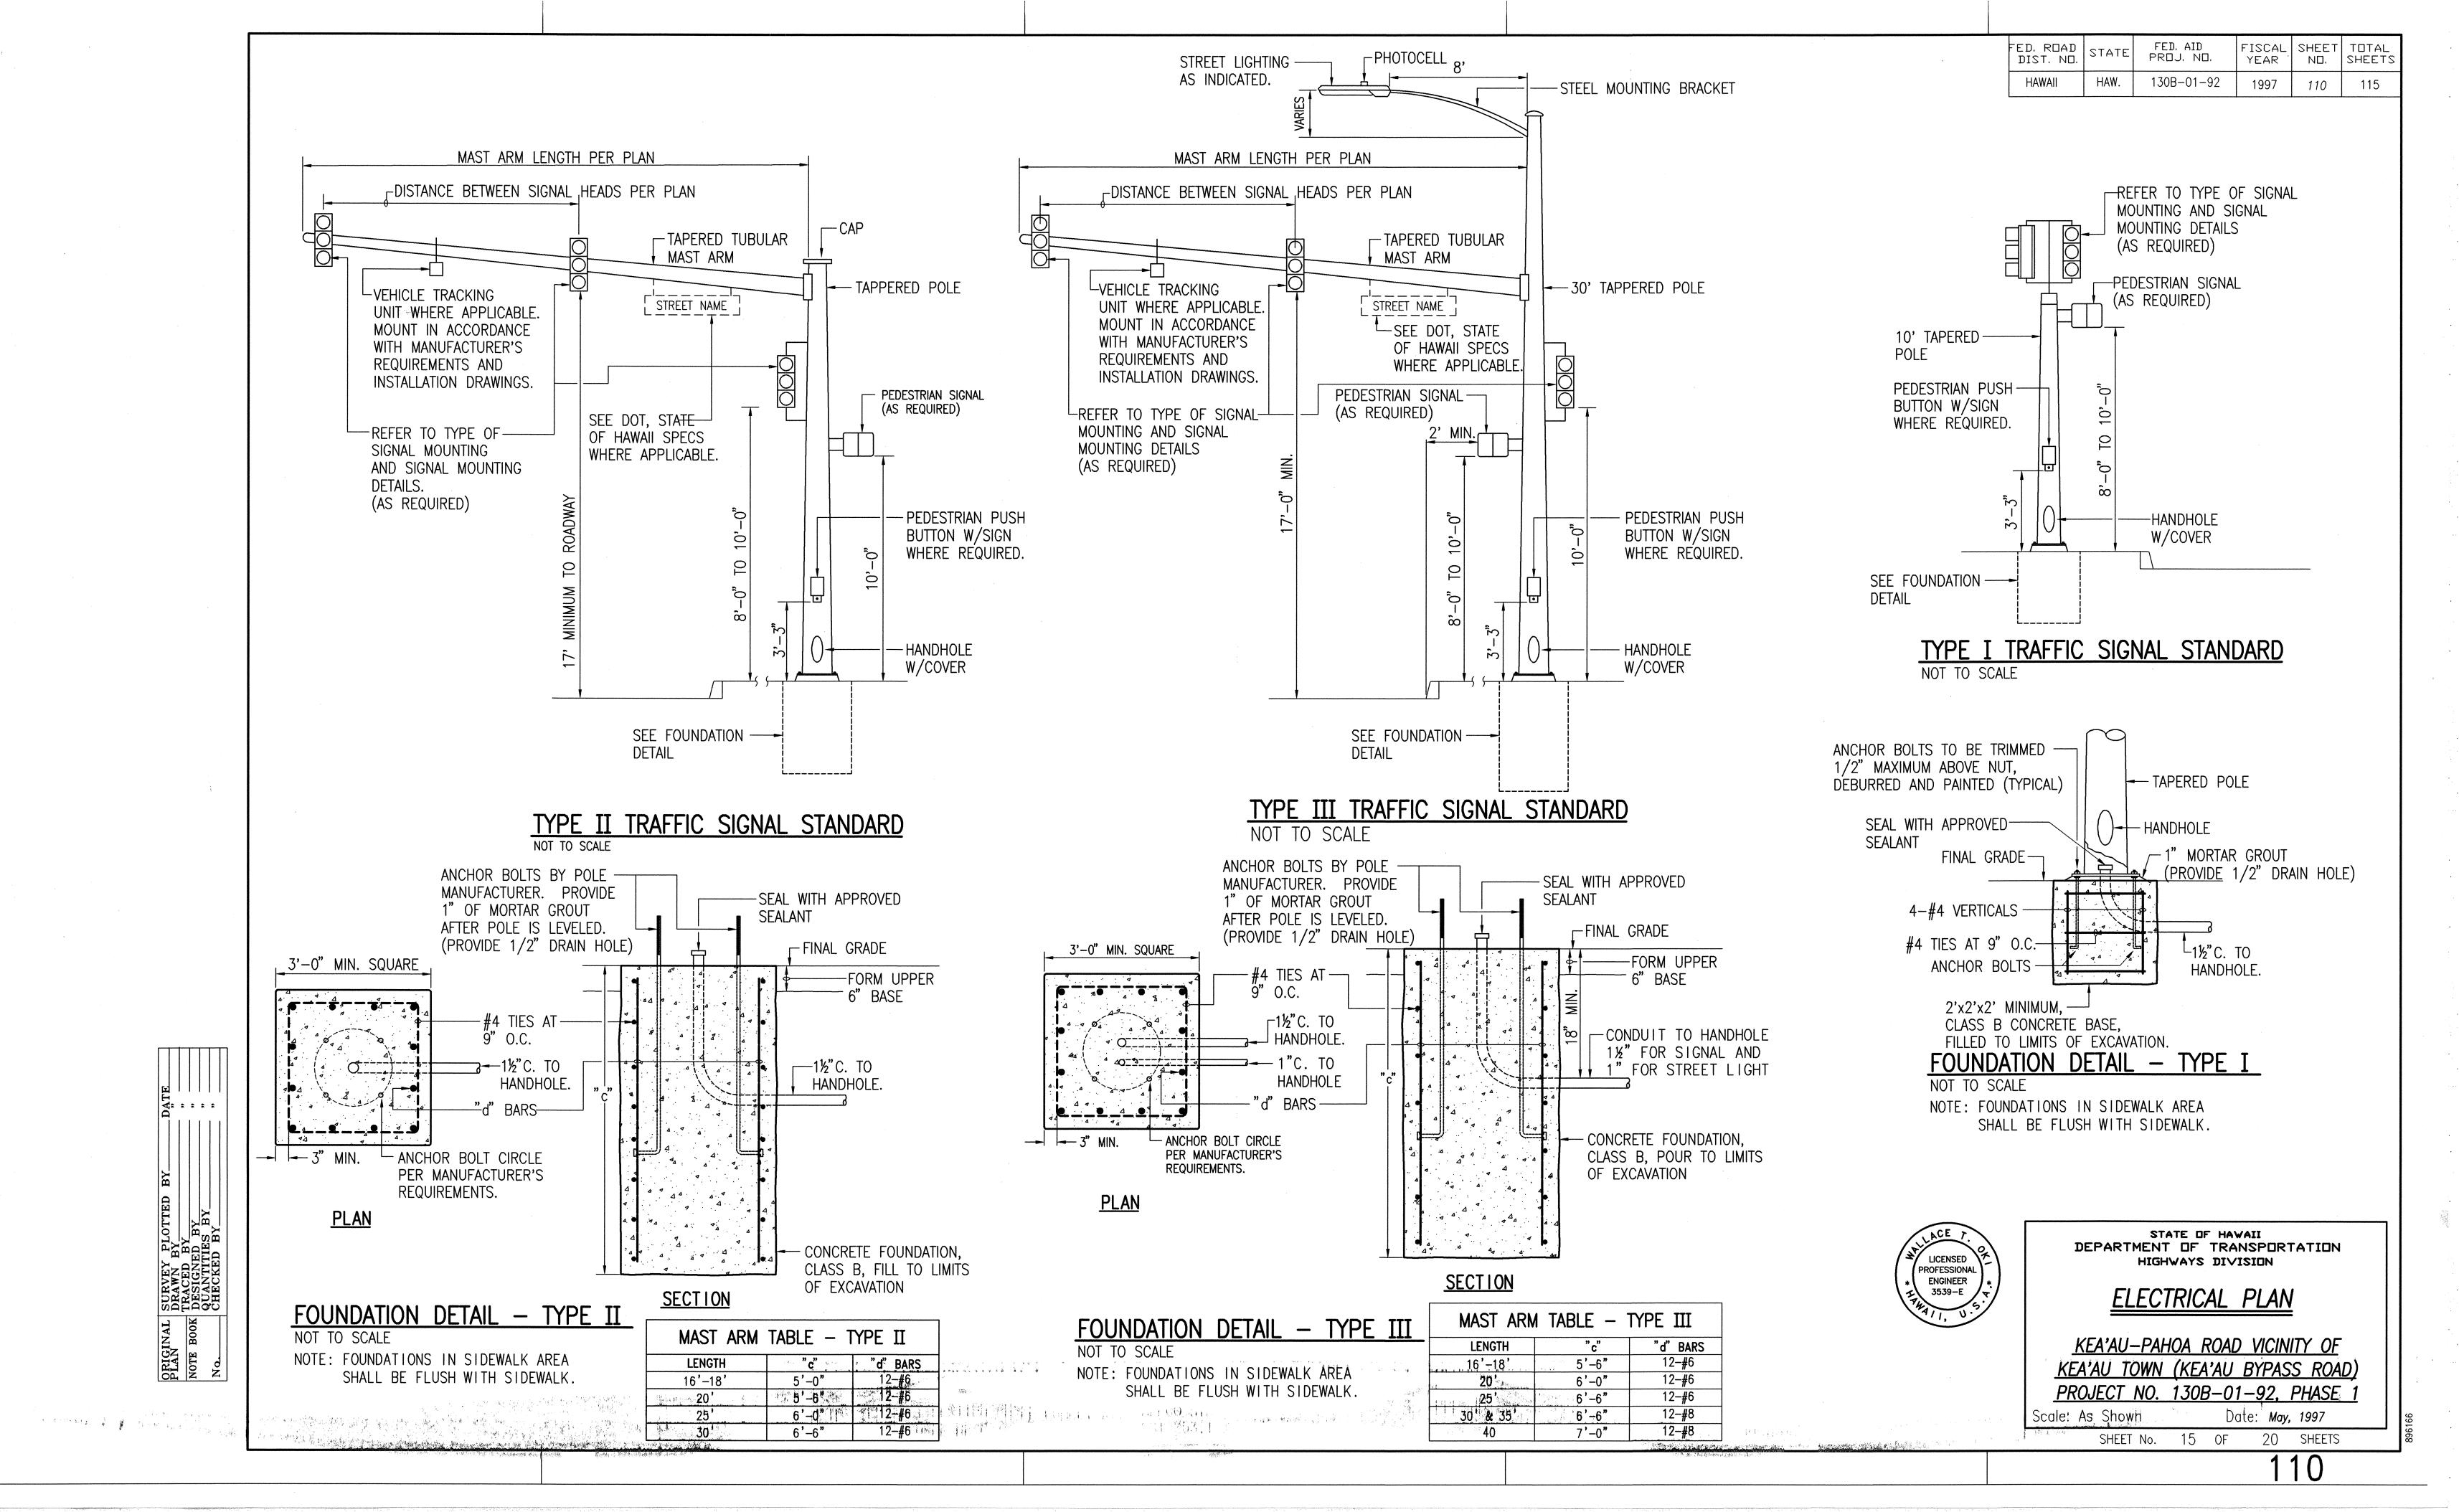

FED, ROAD DIST, NO.	STATE	FED. AID PROJ. NO.	FISCAL YEAR	1	TOTAL SHEETS
HAWAII	HAW.	130B-01-92	1997	111	115

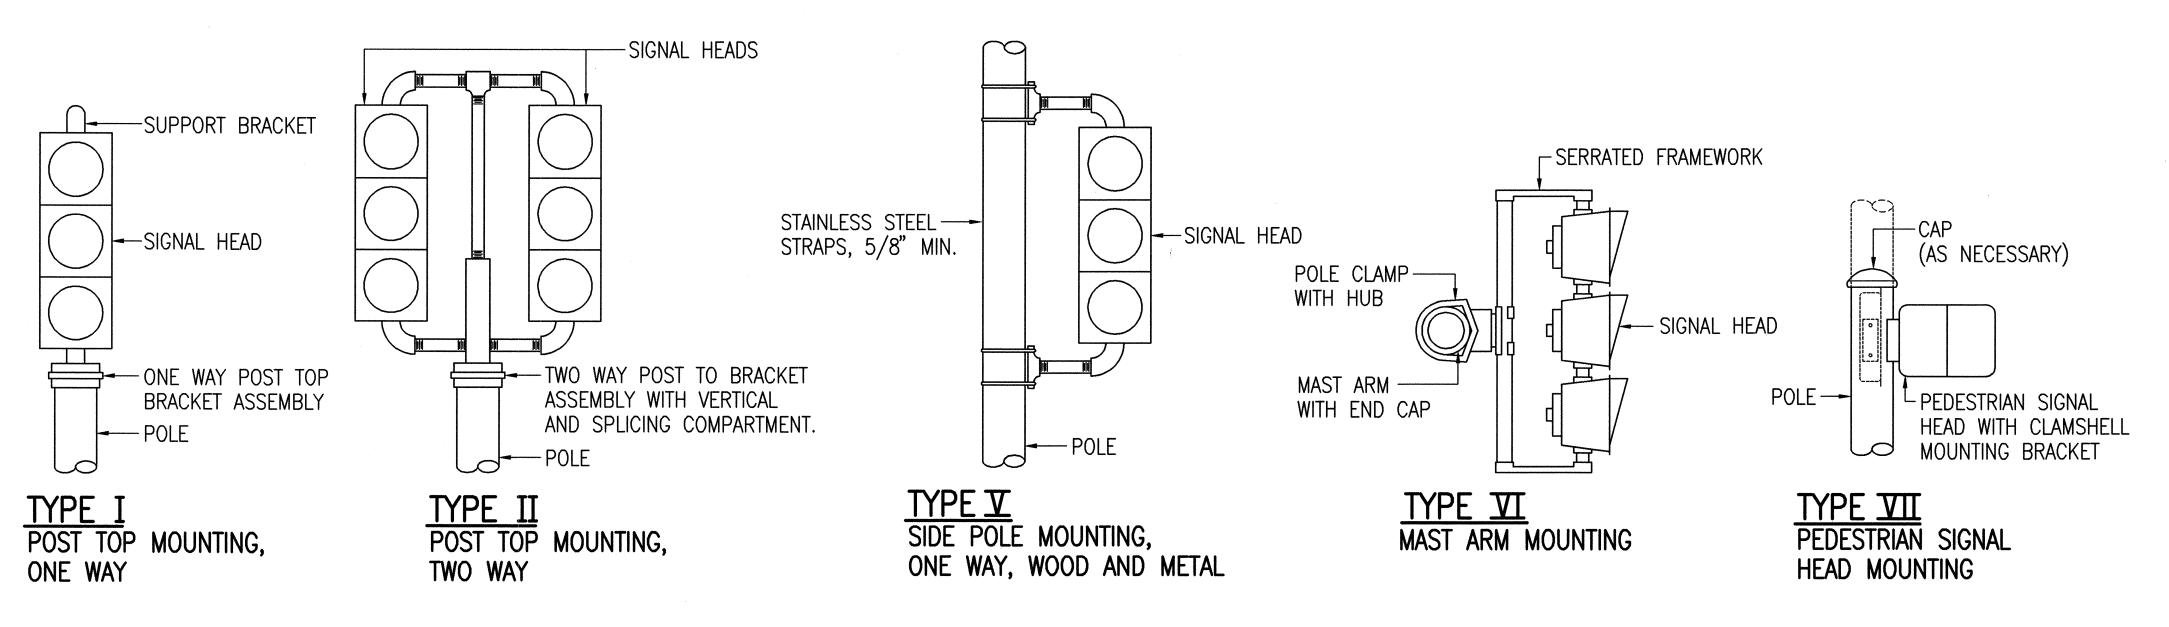


SIGNAL ASSEMBLY MOUNTING

NOT TO SCALE

NOTES:

ORIGINAL SURVEY PLOTTED DRAWN BY TRACED BY DESIGNED BY QUANTITIES BY CHECKED BY

- 1. ALL THREADED ITEMS, i.e. BOLTS, FITTINGS, SCREWS, ETC., TO BE COATED WITH AN APPROVED ANTI-SEIZE COMPOUND PRIOR TO ASSEMBLY OR INSTALLATION.
- 2. ALL CIRCULAR SIGNAL HEADS (EXCEPT FIBEROPTIC AND PROGRAMABLE) SHALL HAVE APPROVED GLASS LENSES.

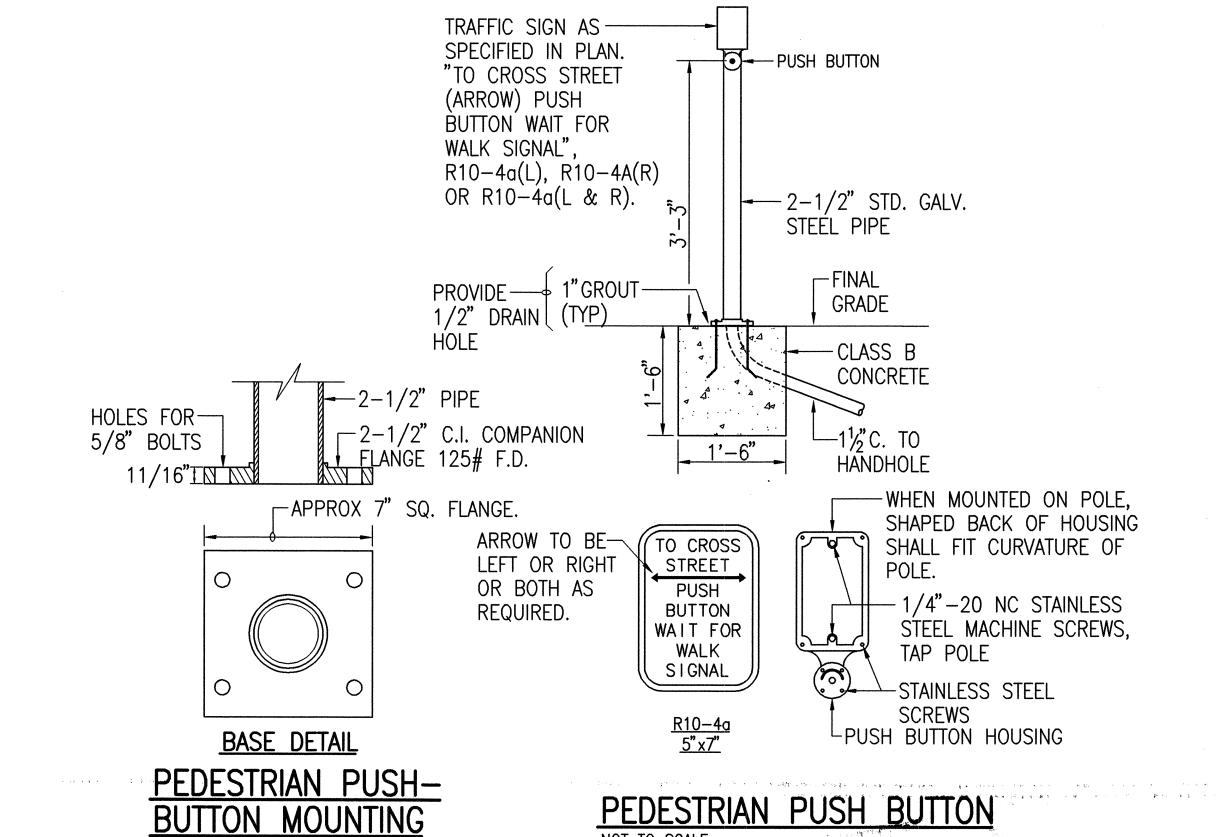



STATE OF HAWAII
DEPARTMENT OF TRANSPORTATION
HIGHWAYS DIVISION

ELECTRICAL PLAN


KEA'AU-PAHOA ROAD VICINITY OF
KEA'AU TOWN (KEA'AU BYPASS ROAD)
PROJECT NO. 130B-01-92, PHASE 1


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SHEET No.


Date: *May, 1997*DF 20 SHEETS

16 OF 20

FED. ROAD DIST. NO.	STATE	FED. AID PROJ. NO.	FISCAL YEAR		TOTAL SHEETS
HAWAII	HAW.	130B-01-92	1997	112	115

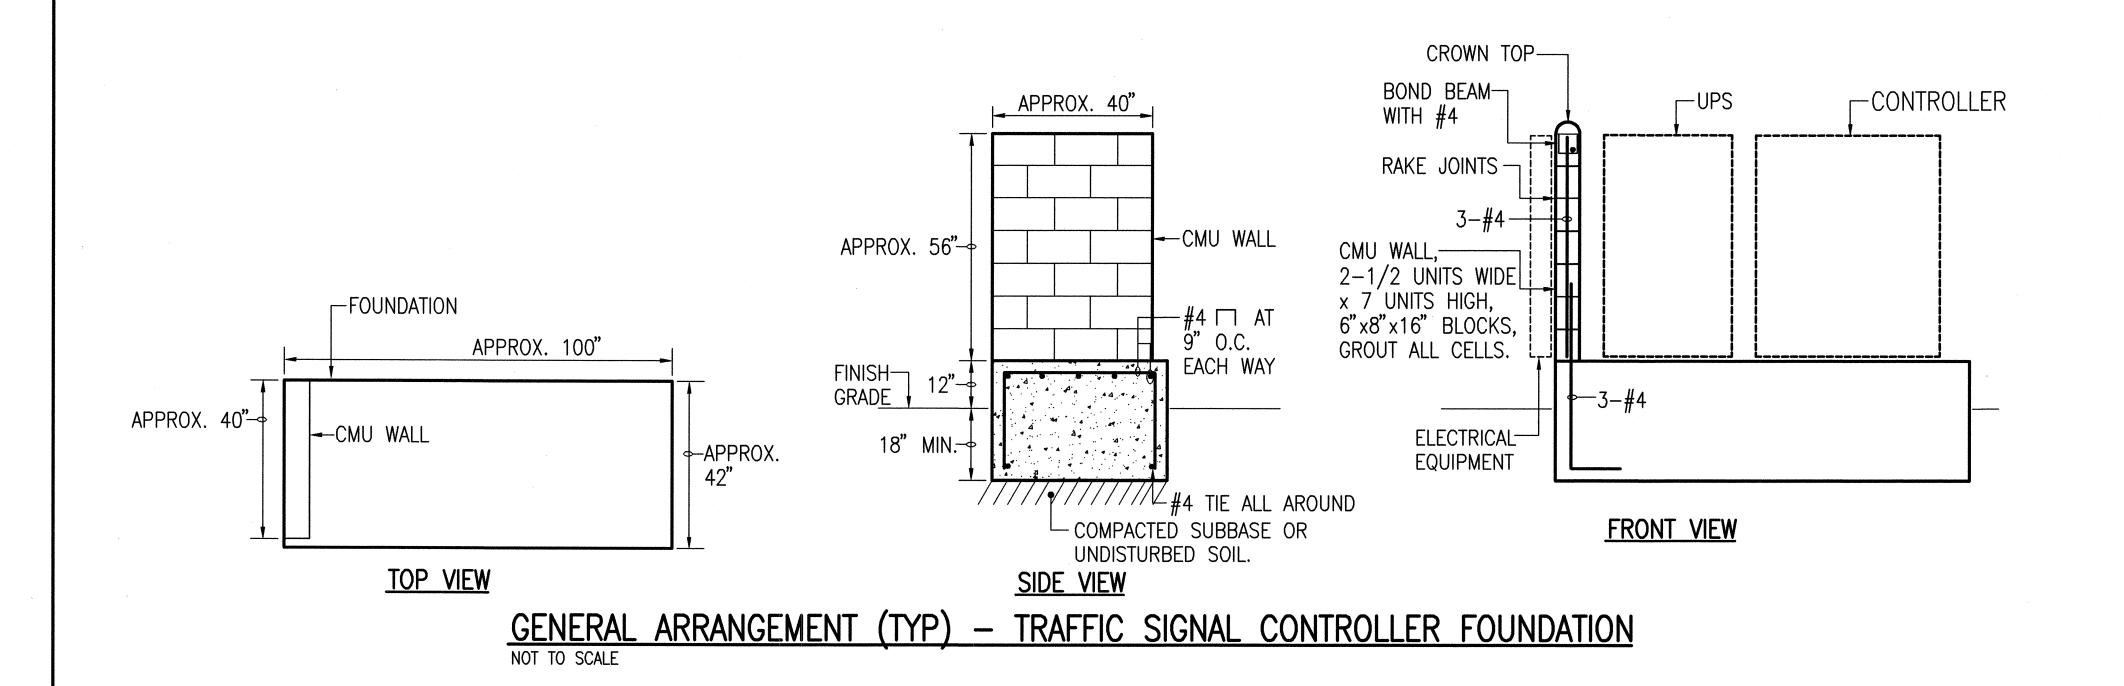

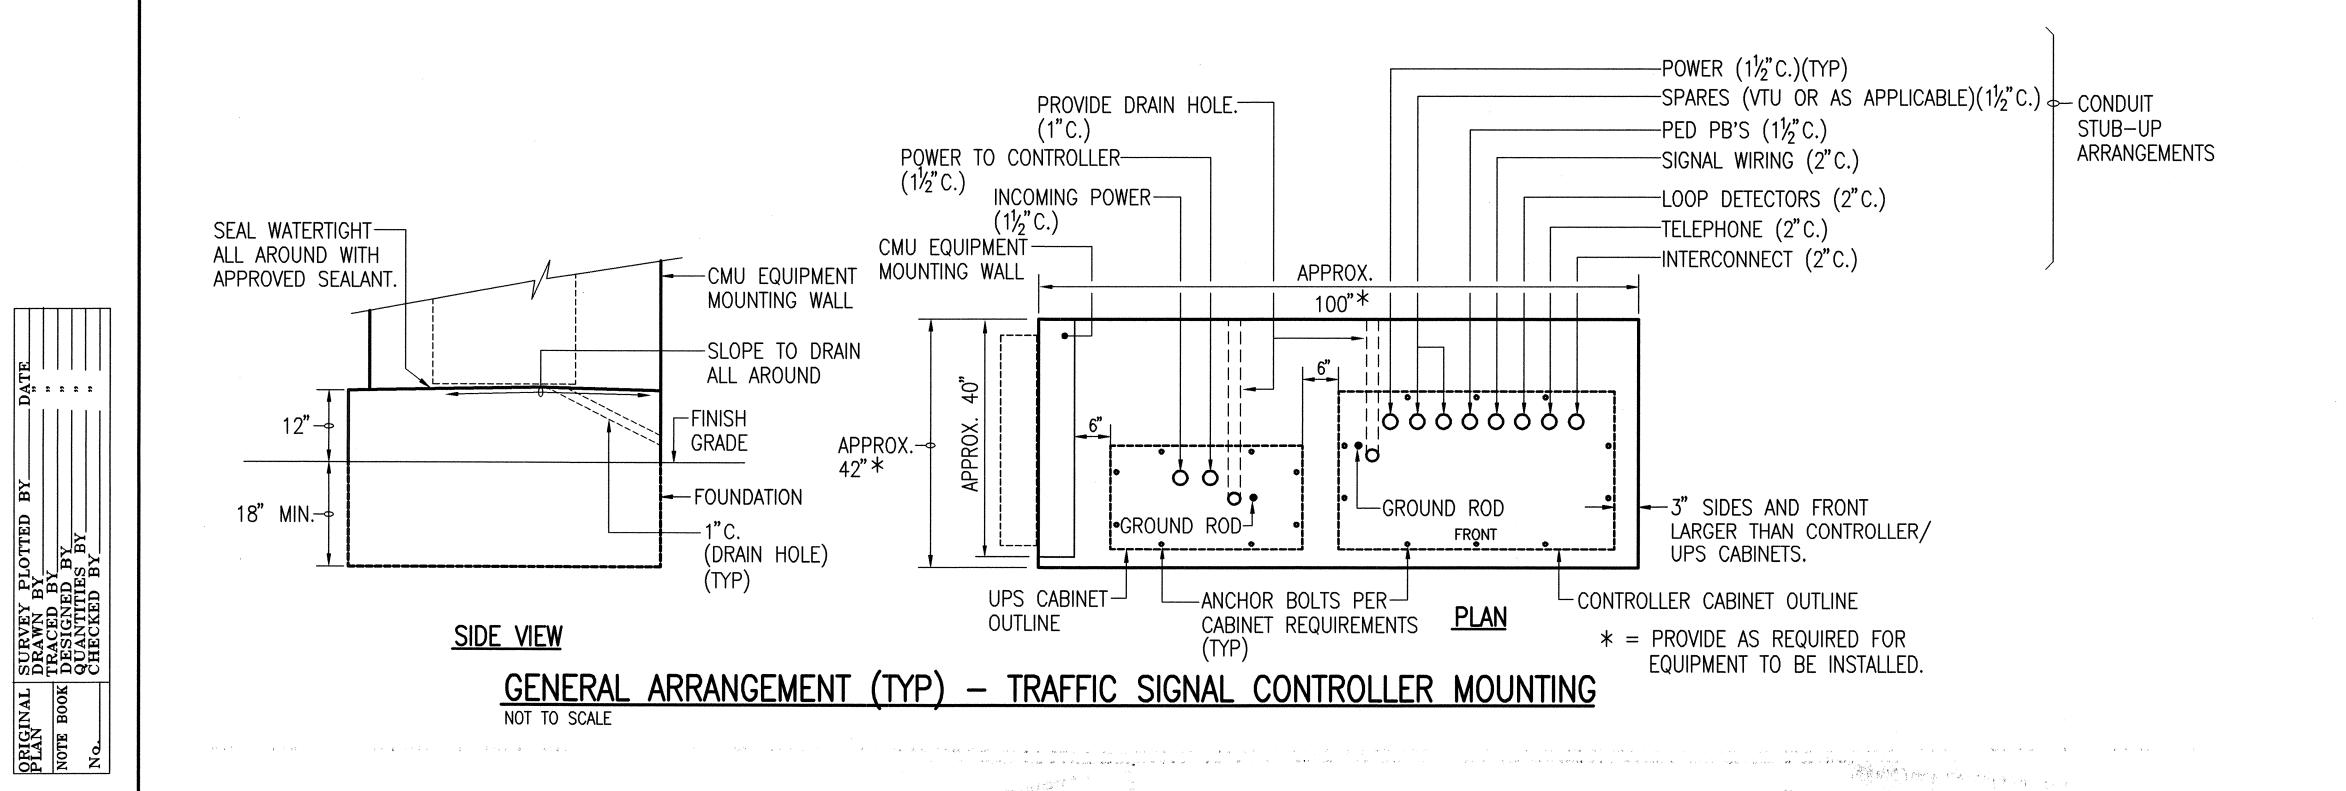

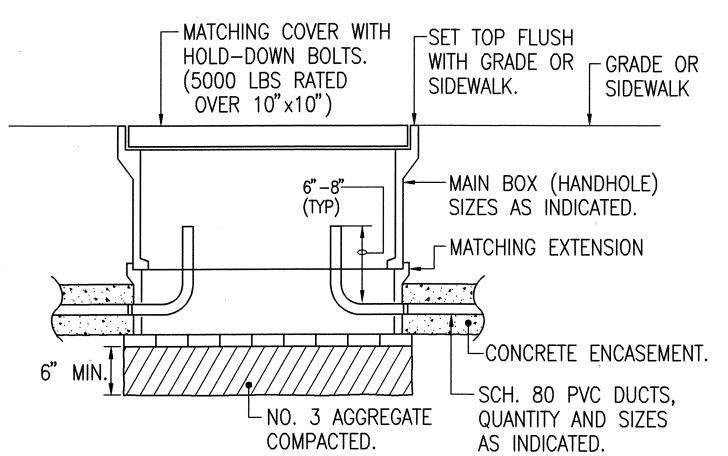

GENERAL ARRANGEMENT (TYP) -HANDHOLE (HH

NOT TO SCALE

- 1. HANDHOLE SYSTEM SHALL BE "QUAZITE COMPOSOLITE" OR APPROVED EQUAL
- 2. ALL COVERS SHALL BE MARKED WITH "TRAFFIC".

<u>EXTENSION</u> COVER PC1212BA PC1212BA PC1212WA

PG1730EA PG1730WA PG2436EA PG2436WA PG2436BA





STATE OF HAWAII
DEPARTMENT OF TRANSPORTATION HIGHWAYS DIVISION

ELECTRICAL PLAN

KEA'AU-PAHOA ROAD VICINITY OF KEA'AU TOWN (KEA'AU BYPASS ROAD) PROJECT NO. 130B-01-92, PHASE 1 Scale: As Shown Date: *May, 1997*

20 SHEETS SHEET No.

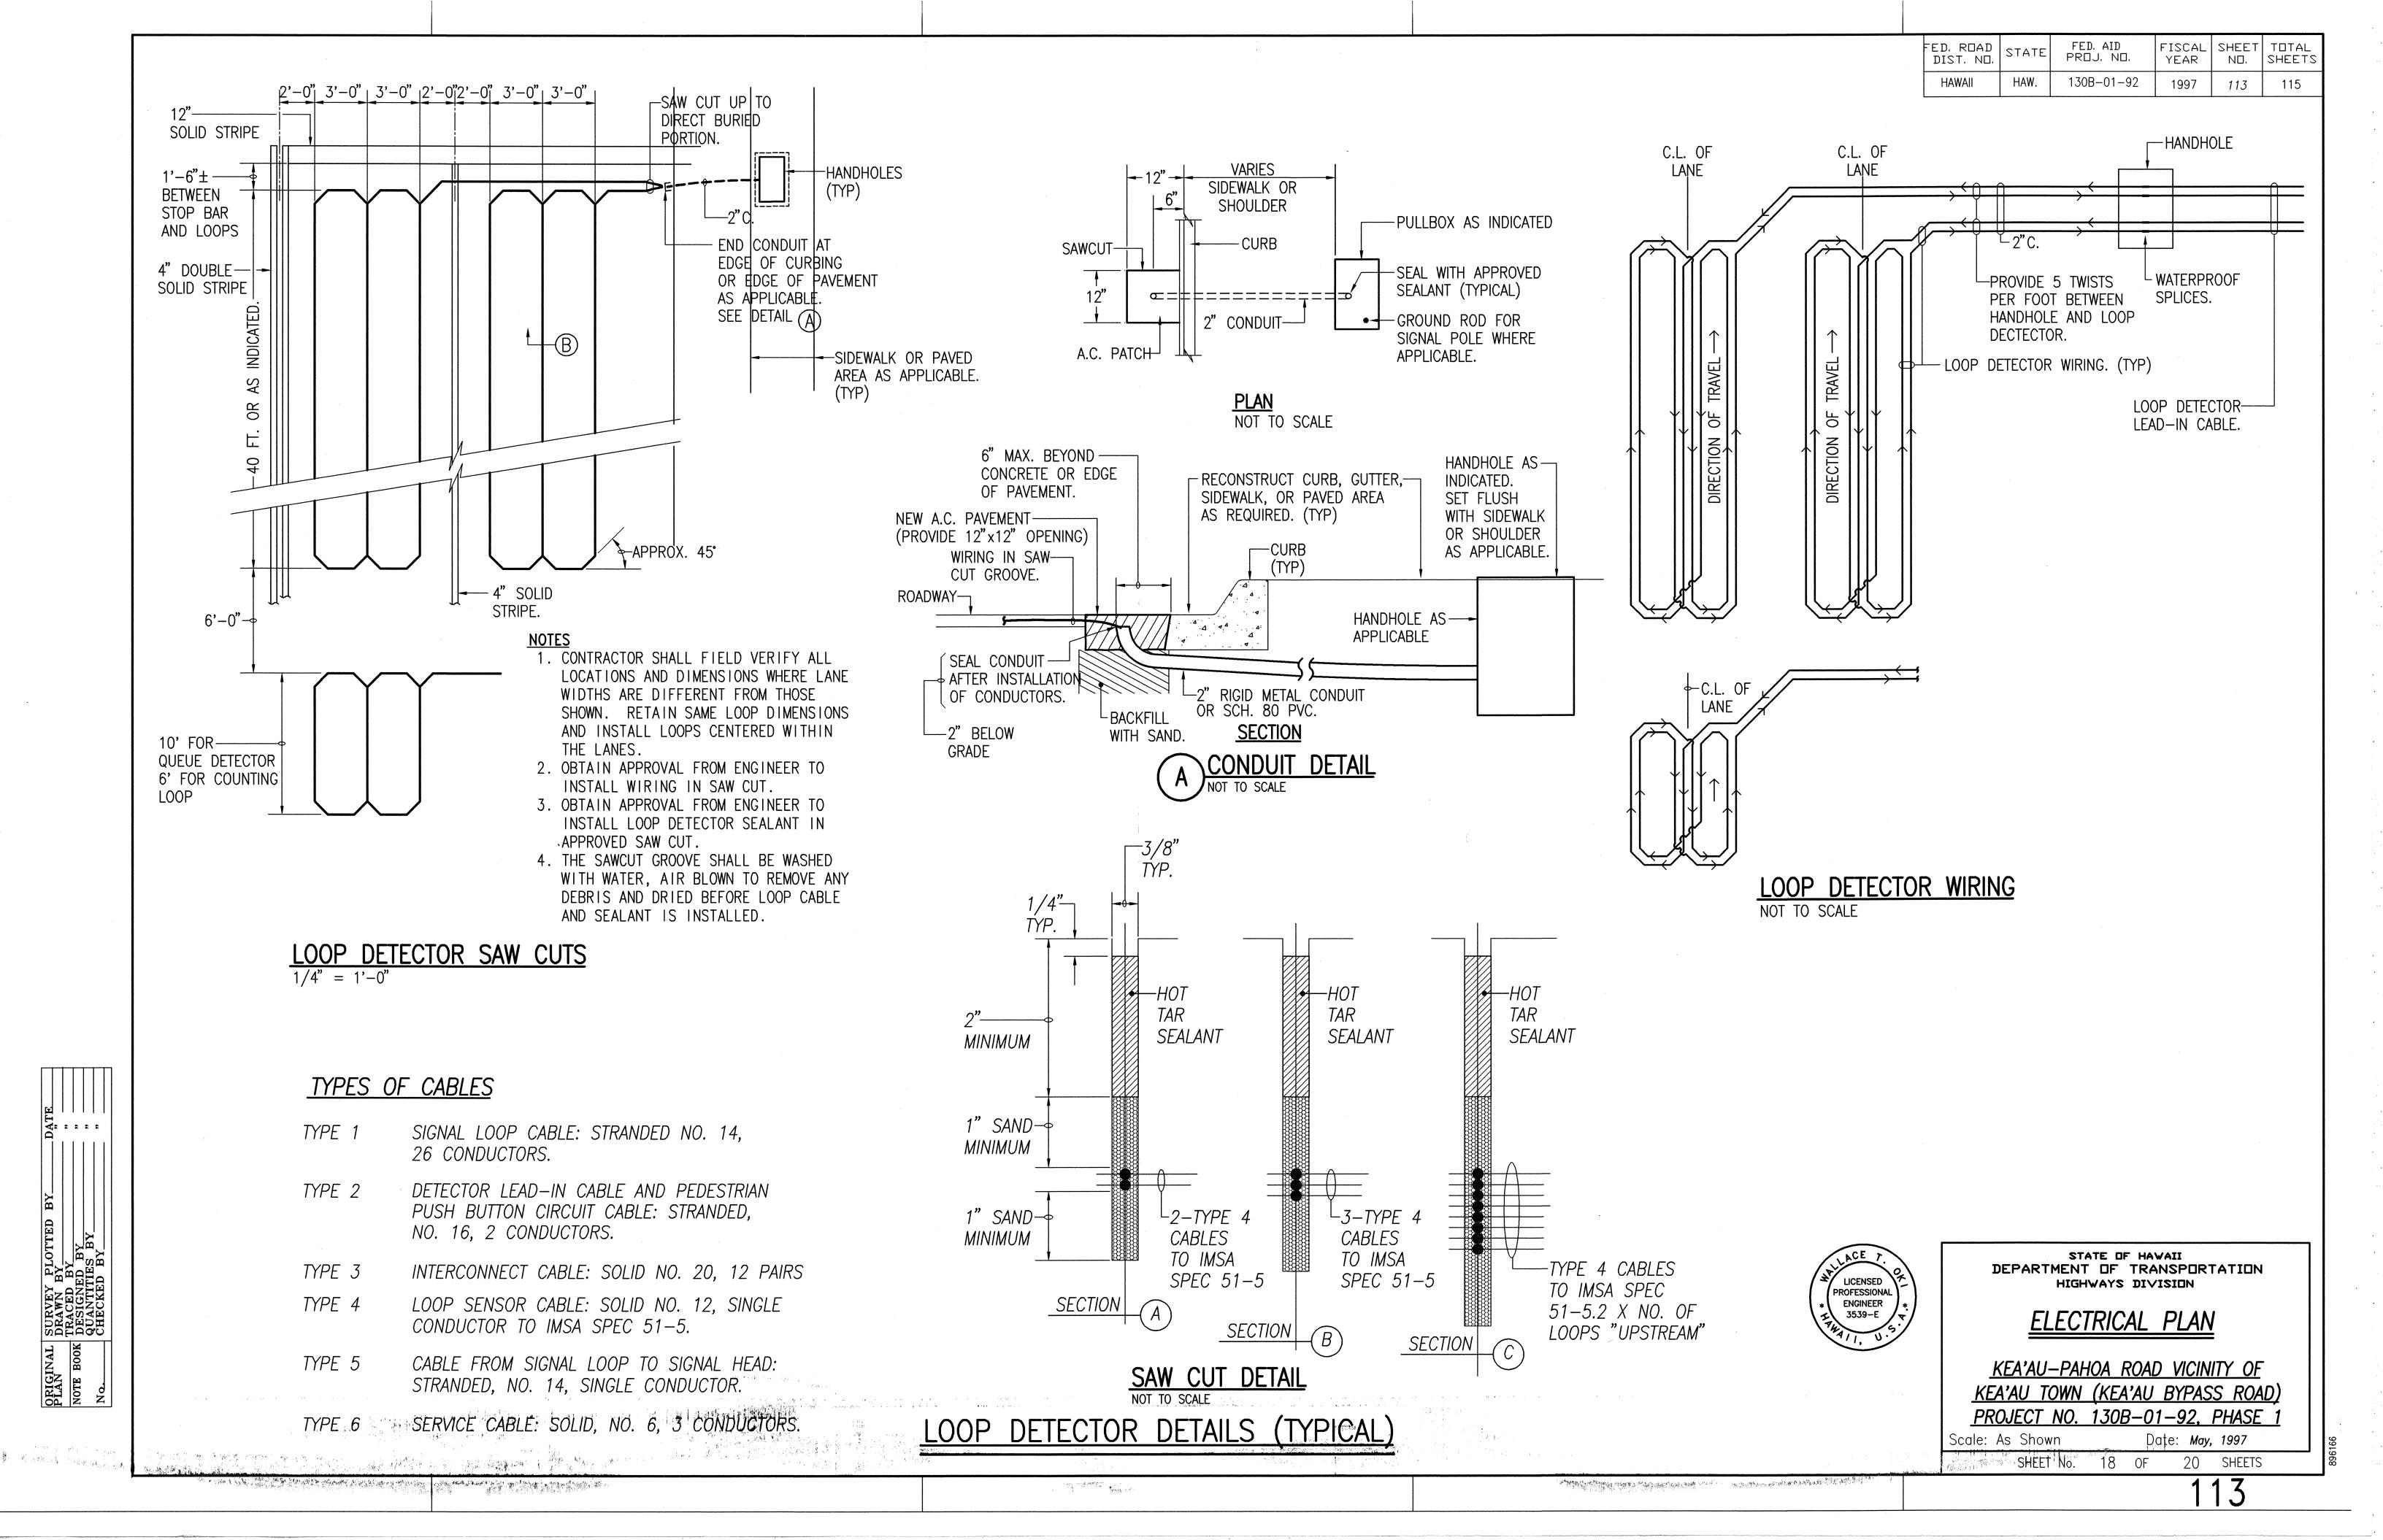

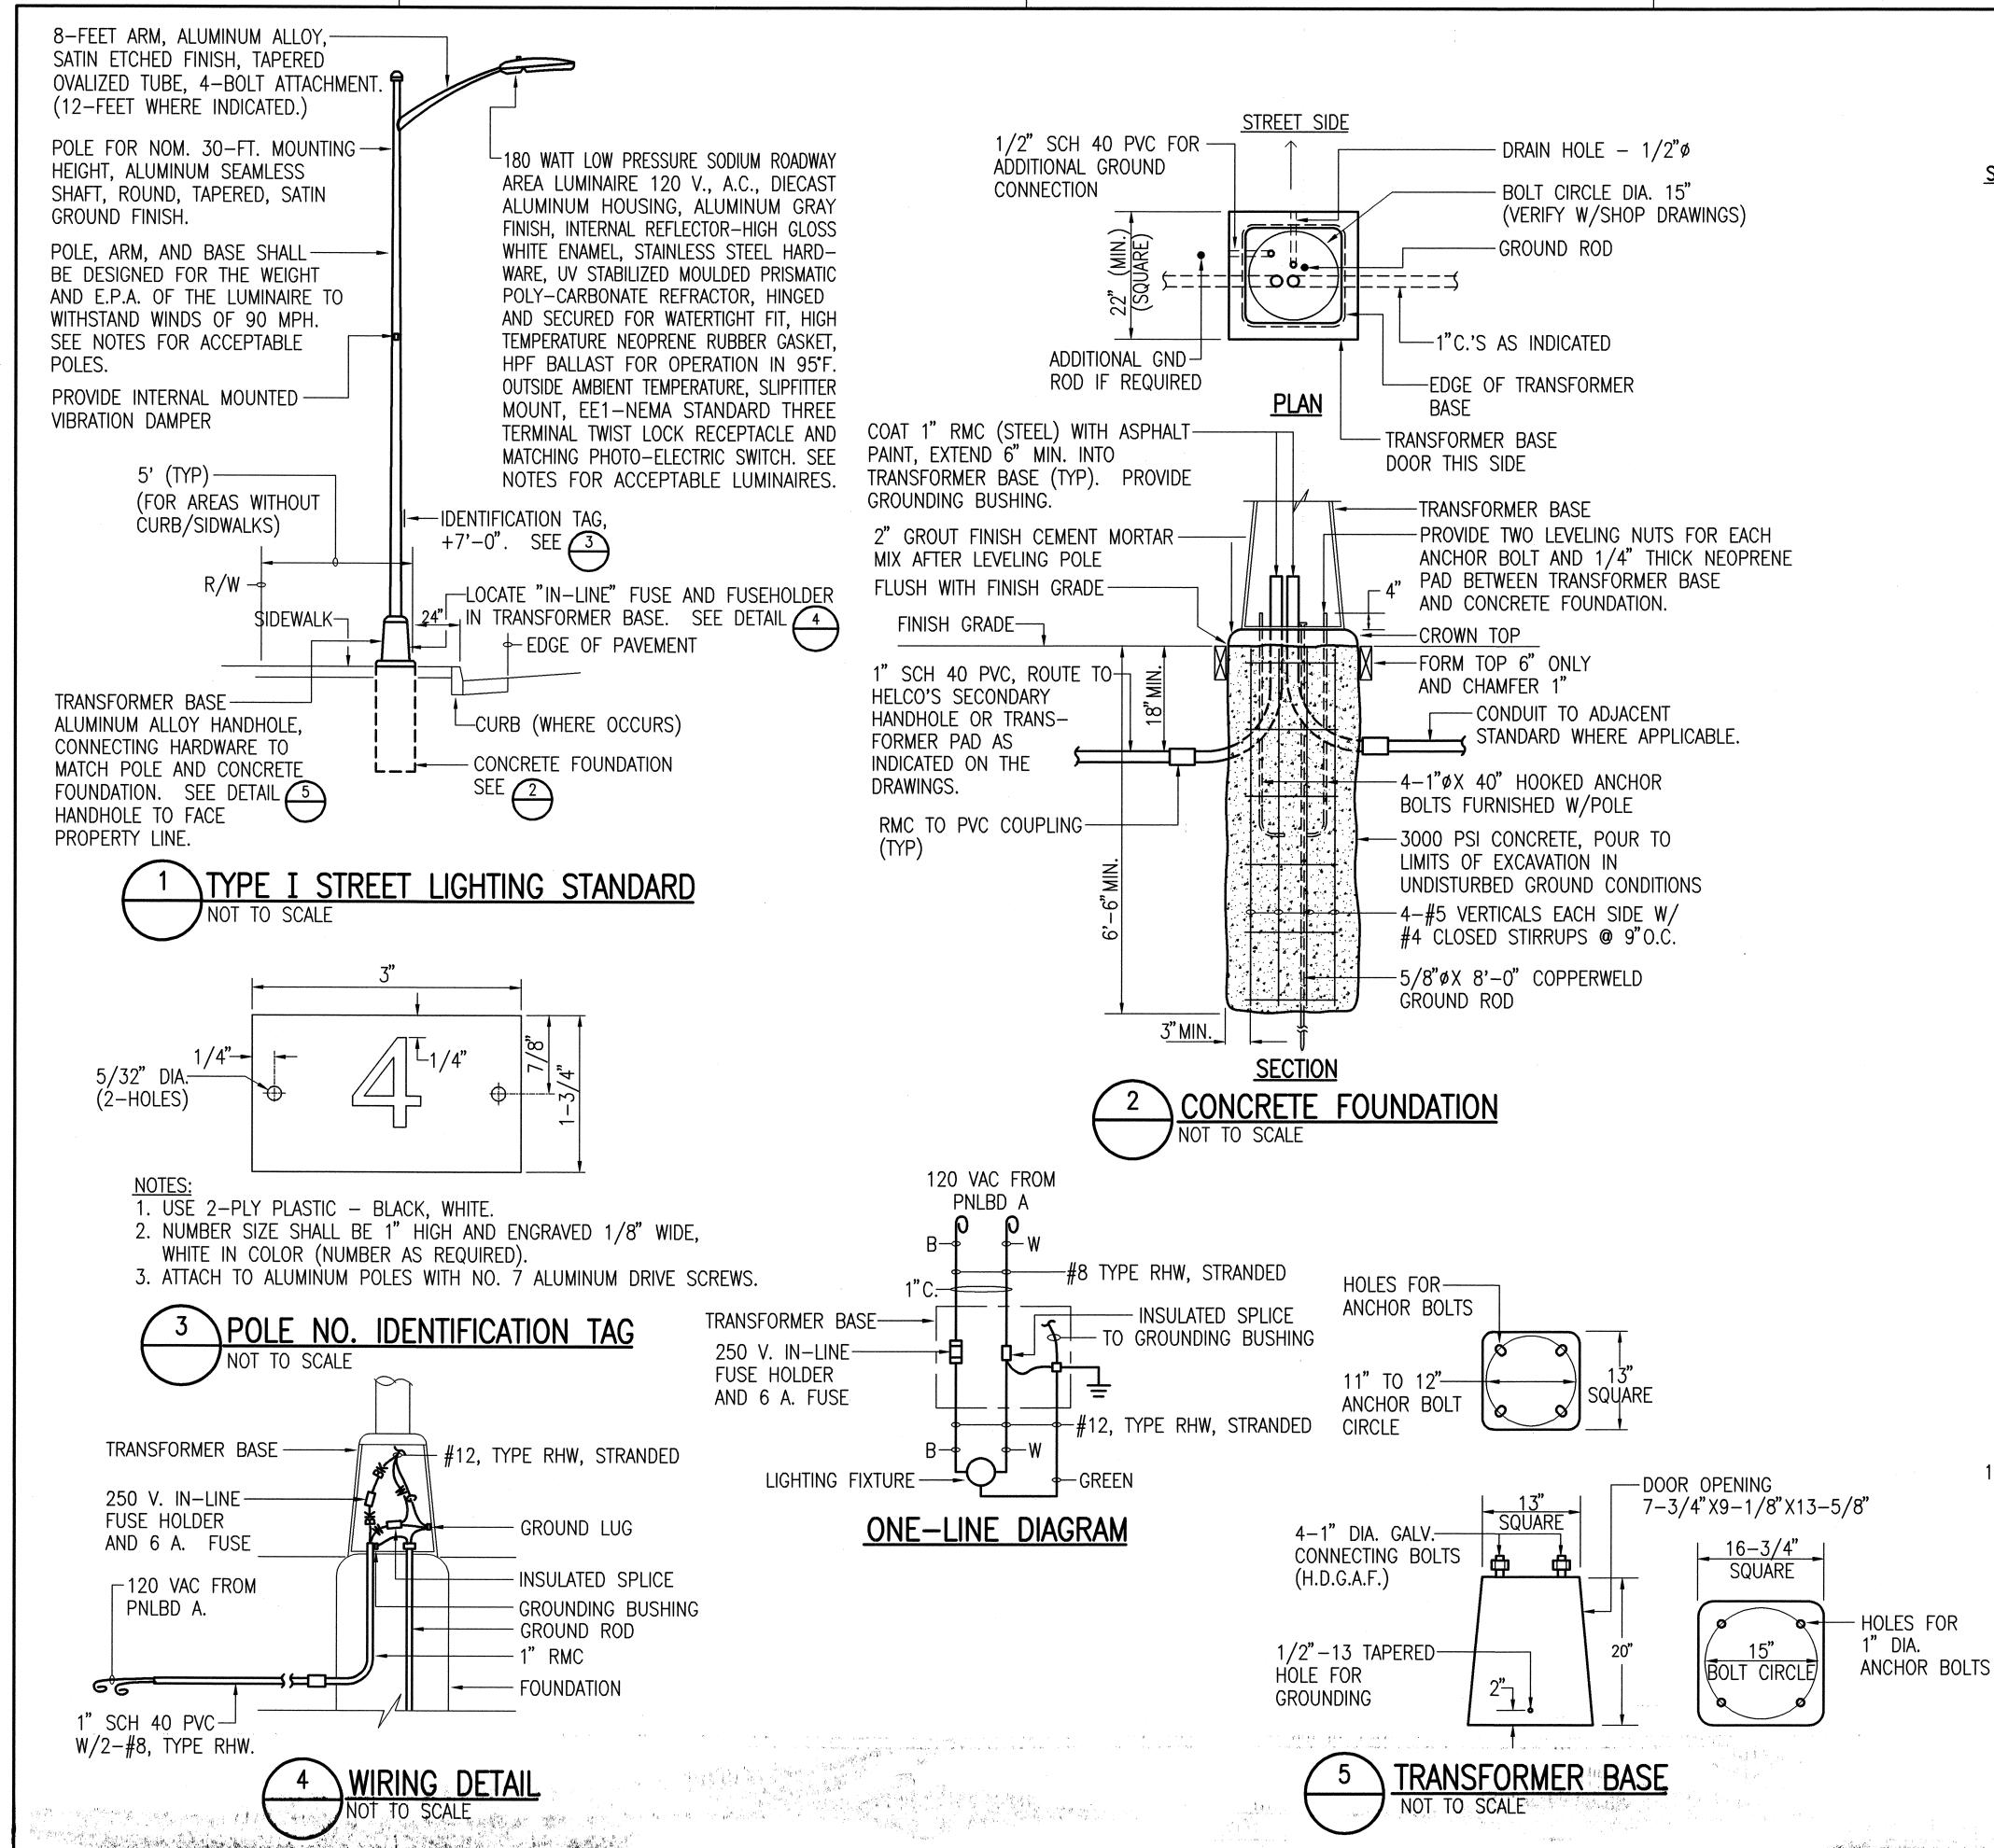

4::::

SURVEY PLOTTE
DRAWN BY
TRACED BY
DESIGNED BY
QUANTITIES BY
CHECKED BY

FED. AID PROJ. NO. FISCAL SHEET TOTAL YEAR NO. SHEETS FED. ROAD DIST. NO. HAW. 130B-01-92 1997 115 114

STREET LIGHT NOTES

- 1. NO CHANGES WILL BE ALLOWED WITHOUT PRIOR APPROVAL FROM TRAFFIC DIVISION, DEPARTMENT OF PUBLIC WORKS, COUNTY OF HAWAII.
- 2. ALL STREET LIGHT IDENTIFICATION TAG NUMBERING FOR METAL POLES SHALL START WITH "1" AND CONTINUE NUMERICALLY. ALL STREET LIGHT I.D. TAG NUMBERING FOR WOODEN POLES SHALL BE IN ACCORDANCE WITH HELCO'S NUMBERING SYSTEM.
- 3. THE CONTRACTOR SHALL PROVIDE ALL NECESSARY SECONDARY CIRCUIT EXTENSIONS TO THE INDICATED POWER SOURCE.
- 4. THE CONTRACTOR SHALL ARRANGE AND ASSUME COSTS TO ENERGIZE STREET LIGHTS A MINIMUM OF 6 HOURS FOR FINAL INSPECTION.
- 5. THE CONTRACTOR SHALL INSCRIBE THE MONTH AND YEAR OF INSTALLATION OF PHOTOCELLS AND LAMPS. ALL P.E.'S SHALL HAVE THE NORTH INDEX FACING NORTH.
- 6. ALL LABOR AND MATERIALS SHALL BE WARRANTED FOR A MINIMUM OF ONE YEAR FROM DATE OF DEDICATION TO THE COUNTY.
- 7. ACCEPTABLE STREET LIGHT MATERIALS:

LUMINAIRES:

WITH PE RECEPTACLE AND 120-240 VOLT HPF BALLAST.

1) AMERICAN ELECTRIC SP2 180 WITH POLYCARBONATE SEMI-CUTOFF LENS.

PHOTOCELLS:

COMPLETELY SOLID STATE. FAIL "ON".

1) ALR SST PV

ALUMINUM POLES:

INTERNALLY MOUNTED VIBRATION DAMPER, MINIMUM .188 WALL THICKNESS. MUST BE IN APPROVED BY F.H.W.A. TO BE IN COMPLIANCE WITH AUGUST 1985 AMENDED AND ADOPTED AASHTO SPECIFICATIONS, 11 TO 12 INCH BASE BOLT CIRCLE. ARM LENGTHS SHALL BE PER PLANS.

- LEXINGTON: 2708-45806T4, 2208-45806T4
- HAPCO: 21-305X, 21-307X, 21-585X, 21-588HD, 73892-001, 73892-002, 73892-003.

TRANSFORMER BASES:

ALUMINUM WITH 15 INCH BASE BOLT CIRCLE. MUST BE APPROVED BY F.W.H.A TO BE IN COMPLIANCE WITH AUGUST 1985 AMENDED AND ADOPTED AASHTO BREAKAWAY SPECIFICATIONS.

- 1) LEXINGTON: 08R-1315B-17.
- AKRON FOUNDRY TB1-17.
- 8. SHOP DRAWINGS SHALL BE SUBMITTED FOR APPROVAL BY TRAFFIC DIVISION.
- 9. ALL UNDERGROUND WIRING STREET LIGHTS SHALL BE GROUNDED TO PROVIDE A MINIMUM 25 OHMS TO GROUND.
- 10. ALL WORK SHALL CONFORM TO THE LATEST NATIONAL ELECTRICAL CODE.




STATE OF HAWAII DEPARTMENT OF TRANSPORTATION HIGHWAYS DIVISION

ELECTRICAL PLAN


KEA'AU-PAHOA ROAD VICINITY OF KEA'AU TOWN (KEA'AU BYPASS ROAD) PROJECT NO. 130B-01-92, PHASE Date: *May*, 1997

Scale: As Shown 19 of SHEET No.


20 SHEETS

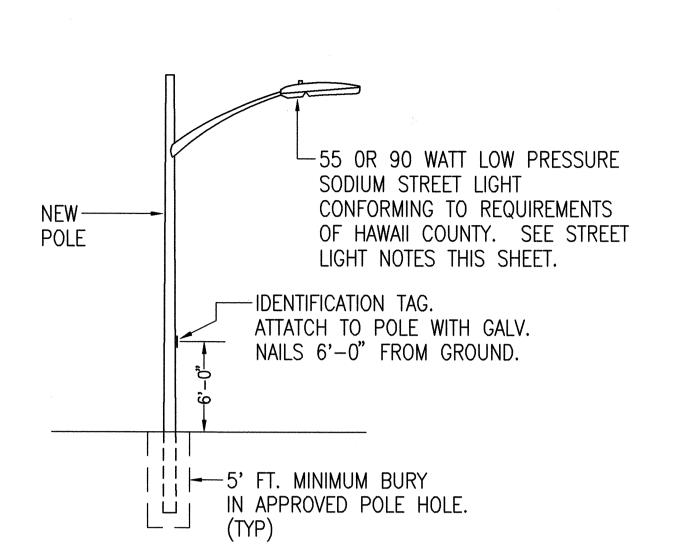

NEW STREET LIGHT ON NEW POLE NOT TO SCALE

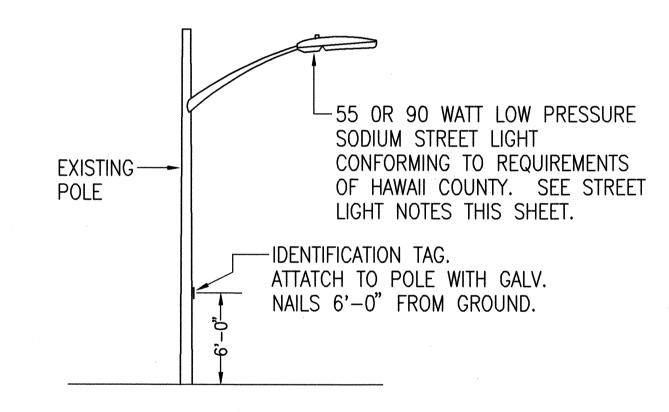

NEW STREET LIGHT ON EXISTING POLE NOT TO SCALE

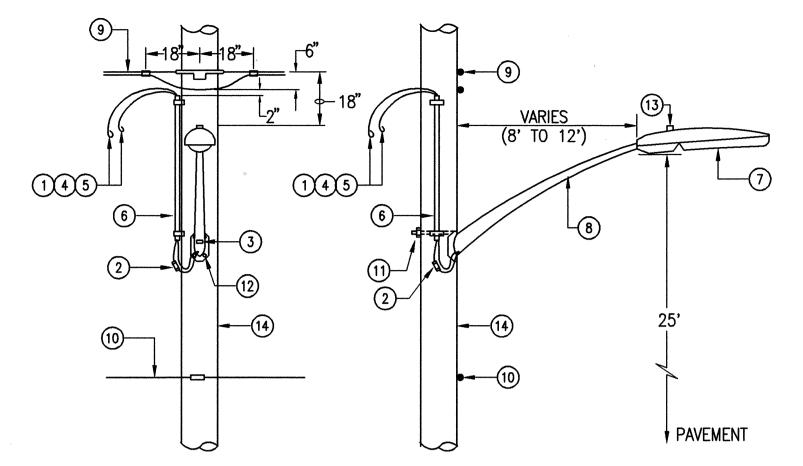

NEW STREET LIGHT ON UTILITY POLE

NOT TO SCALE

NOTES 1. JOINT POLE SHARES SHALL BE PAID BY THE CONTRACTOR.

2. SUBMIT SKETCH TO TRAFFIC DIVISION INDICATING TOTAL POLE HEIGHT, CONTACT HEIGHTS FOR H.T.CO., CATV, NEUTRALS, SECONDARY, PRIMARY, AND STREET LIGHT, AS APPLICABLE, PRIOR TO INSTALLATION. SUBMIT LETTER CONFIRMING THAT JOINT POLE SHARES HAVE BEEN PAID FOR BY THE CONTRACTOR.

NOTES

- 1 NO. 12 AWG-RHW, BLACK AND WHITE COPPER WIRE
- 2 IN-LINE FUSE HOLDER AND FUSE (7 AMP) FOR NO. 12 AWG COPPER WIRE ON LOAD SIDE.
- 3 2" X 2" REFLECTORIZED GREEN STICKER, SIGNIFYING THAT STREET LIGHTS ARE BONDED.
- 4 NO. 12 AWG-RHW BLACK, SINGLE CONDUCTOR COPPER WIRE. MINIMUM 3'.
- 5 NO. 12 AWG-RHW WHITE, SINGLE CONDUCTOR COPPER WIRE. MINIMUM 3'.
- 6 3/4" SCHEDULE 80 PVC WITH CONDUIT STRAPS
- ① LUMINAIRE, 90 & 55 WATT LOW PRESSURE SODIUM AS INDICATED.
- ® TAPERED ELLIPTICAL ALUMINUM MOUNTING BRACKET, LENGTH AS INDICATED.
- 9 SECONDARY BY HELCO, EXISTING OR NEW AS APPLICABLE.
- 10 H.T.CO. LINES (WHERE APPLICABLE)
- MACHINE BOLT, 5/8" X REQUIRED LENGTH. (1-REQ'D.)
- ② LAG SCREW, 1/2"X 4".
- 13 PHOTOCELL
- 14 UTILITY POLE, NEW OR EXISTING AS INDICATED.

FINAL CONNECTIONS TO BE MADE BY HAWAII ELECTRIC LIGHT COMPANY.



STATE OF HAVAII
DEPARTMENT OF TRANSPORTATION
HIGHWAYS DIVISION

FED. AID PROJ. NO.

130B-01-92

HAW.

FISCAL SHEET TOTAL YEAR NO. SHEETS

115

115

1997

FED. ROAD DIST. NO.

HAWAII

ELECTRICAL PLAN

KEA'AU-PAHOA ROAD VICINITY OF KEA'AU TOWN (KEA'AU BYPASS ROAD) PROJECT NO. 130B-01-92, PHASE 1

Scale: As Shown Date: May, 1997
SHEET No. 20 OF 20 SHEETS

 ORIGINAL
 SURVEY
 PLOTTED
 BY
 DATE

 PLAN
 DRAWN
 BY
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 NOTE
 BOOK
 DESIGNED
 BY
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