

Pier No. 3

FOUNDATION PLAN

Scale: 1" = 20'

To Honokaa

4'-3"

Abutment No. 2

KALAOA BRIDGE RETROFITS						
ITEM	LOCATION		ITITY TOTAL	REFERENCE DRAWINGS		
Seat Extender	Abutments No. 1, No. 2	1	2	S3.2, S3.3, S3.4 S3.5, S3.6		
Creep Block	Abutments No. 1, No. 2	5	10	S3.2, S3.3, S3.4 S3.5, S3.6		
Creep Block	Pier No. 3	10	10	S3.7, S3.8, S3.9 S3.10, S3.11		
Seat Extender	Pier No. 3	12	12	S3.7, S3.8, S3.9 S3.10, S3.11		
Type II Dual Cable Restrainer	Pier No. 3	10	10	S3.12, S5.2, S5.4 S5.5		
Diaphragm	Abutments No. 1, No. 2	5	10	S3.3, S3.4, S3.5 S3.6		
Diaphragm	Pier No. 3	10	10	S3.8, S3.9, S3.10		
Longitudinal Bumper	Abutments No. 1, No. 2	6	12	S3.2, S3.4, S3.6		



THIS WORK WAS PREPARED BY ME OR UNDER MY SUPERVISION.

STATE OF HAWAII

DEPARTMENT OF TRANSPORTATION

HIGHWAYS DIVISION

KALAOA BRIDGE

DECK PLAN, ELEVATION

AND FOUNDATION PLAN

HAWAII BELT ROAD

SEISMIC RETROFIT OF VARIOUS BRIDGES

VICINITY OF PAPAIKOU, HAWAII

PROJECT NO. BR-019-2(43)

ORIGINAL SURVEY PLOTTED BY
PLAN DRAWN BY
NOTE BOOK DESIGNED BY
QUANTITIES BY
CHECKED BY
CHECKED BY

SCALE: AS NOTED


DATE: August 12, 1999

SHEET No. S3.1 OF 59 SHEETS


To Hilo

Abutment No. 1

FISCAL SHEET TOTAL SHEETS FED. ROAD DIST. NO. FED. AID PROJ. NO. **HAW.** BR-019-2(43) 2000 29

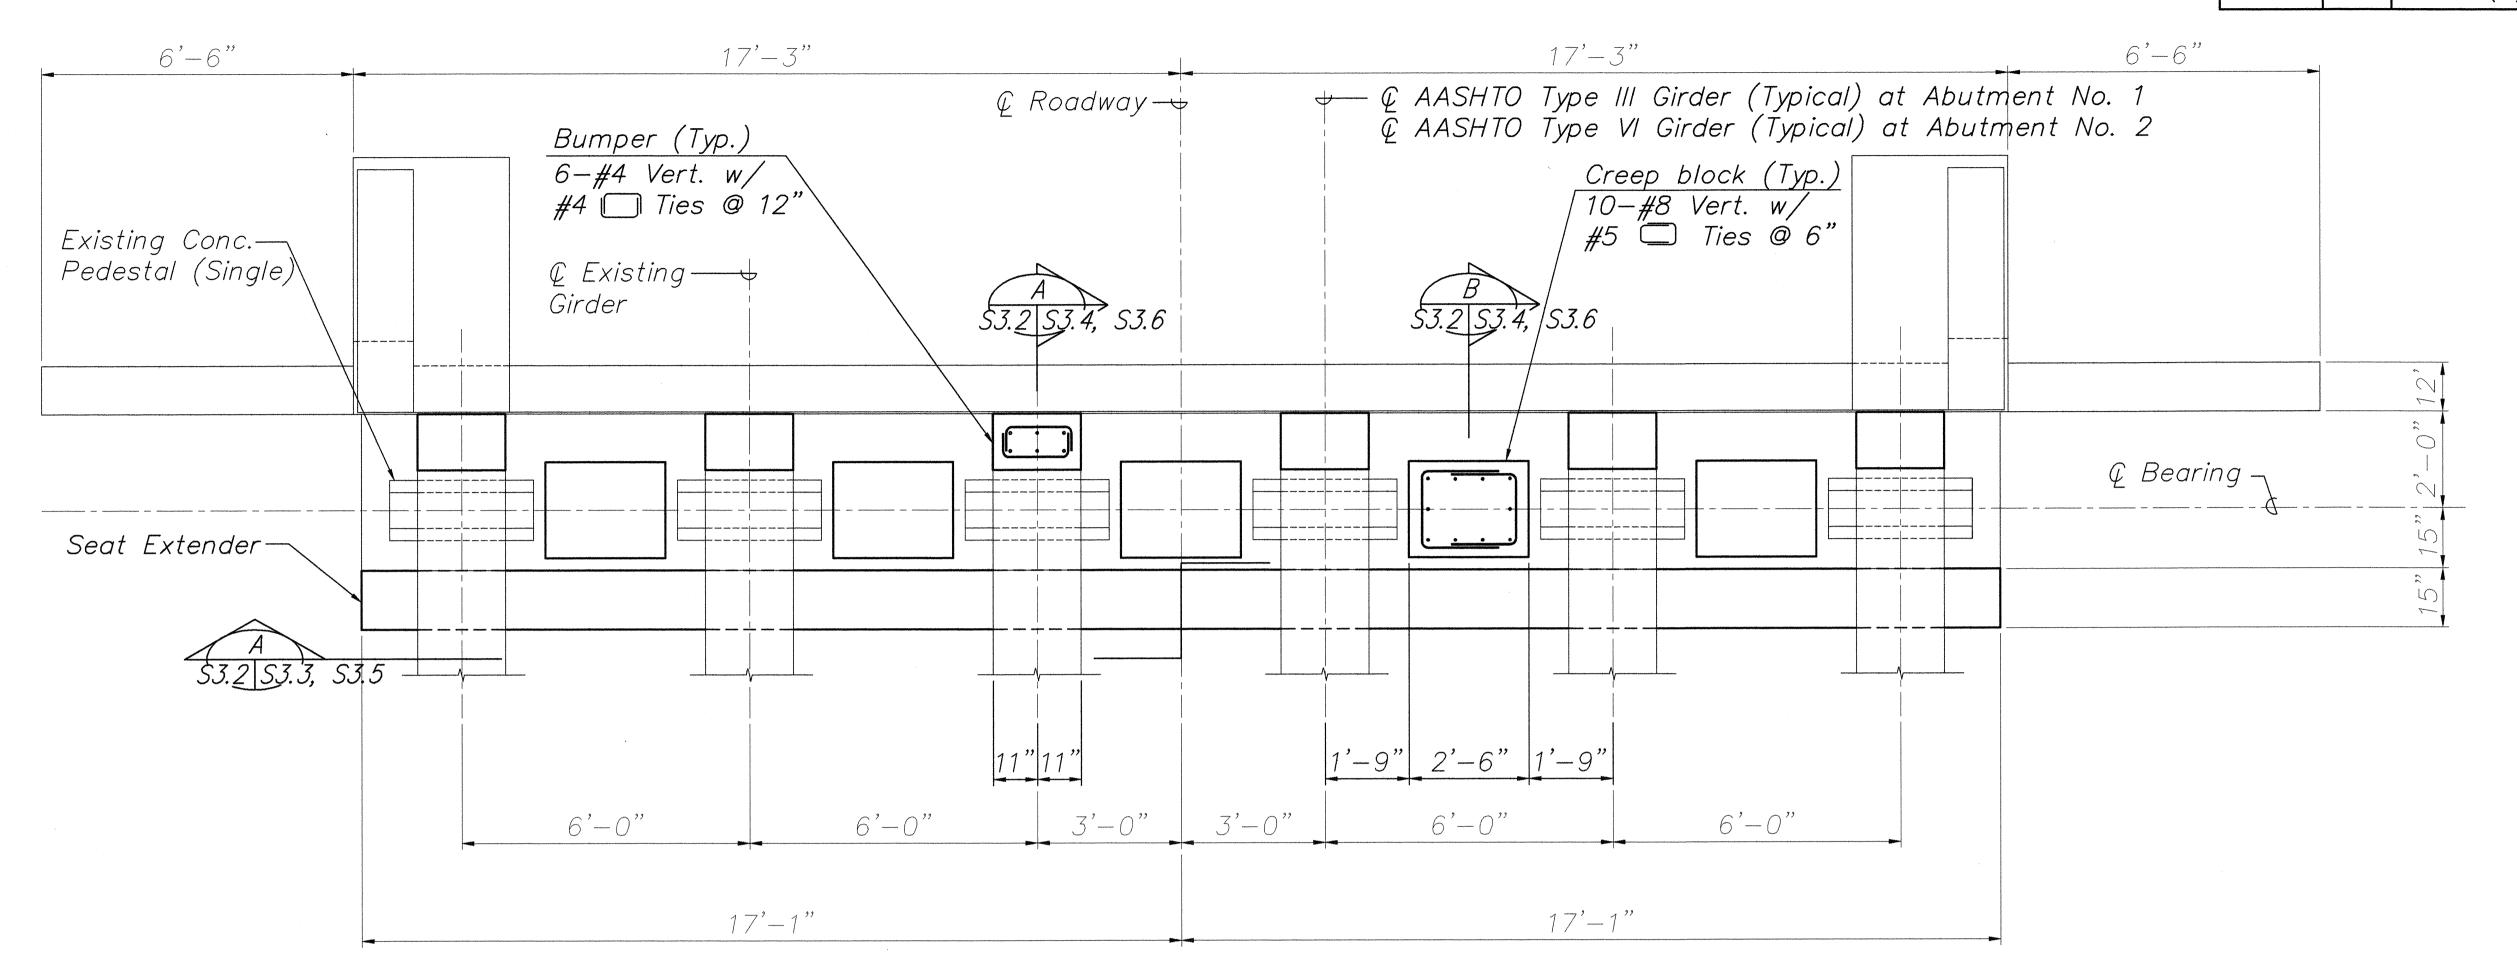

ABUTMENTS NO. 1 AND NO. 2 - PLAN Scale: 1/2" = 1'-0"

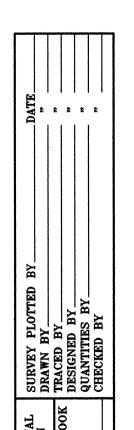

THIS WORK WAS PREPARED BY ME OR UNDER MY SUPERVISION.

STATE OF HAWAII
DEPARTMENT OF TRANSPORTATION
HIGHWAYS DIVISION

ABUTMENT OF HIGHWAYS DIVISION

KALAOA BRIDGE

ABUTMENTS NO. 1 AND NO.2

PLAN

PLAN

PFIT ROAD

HAWAII BELT ROAD

SEISMIC RETROFIT OF VARIOUS BRIDGES

VICINITY OF PAPAIKOU, HAWAII


PROJECT NO. BR-019-2(43)

SCALE: AS NOTED

DATE: August 12, 1999

SHEET No. S3.2 OF 59 SHEETS

FED. ROAD STATE FISCAL SHEET TOTAL YEAR NO. SHEETS FED. AID PROJ. NO. HAW. BR-019-2(43) 2000 30

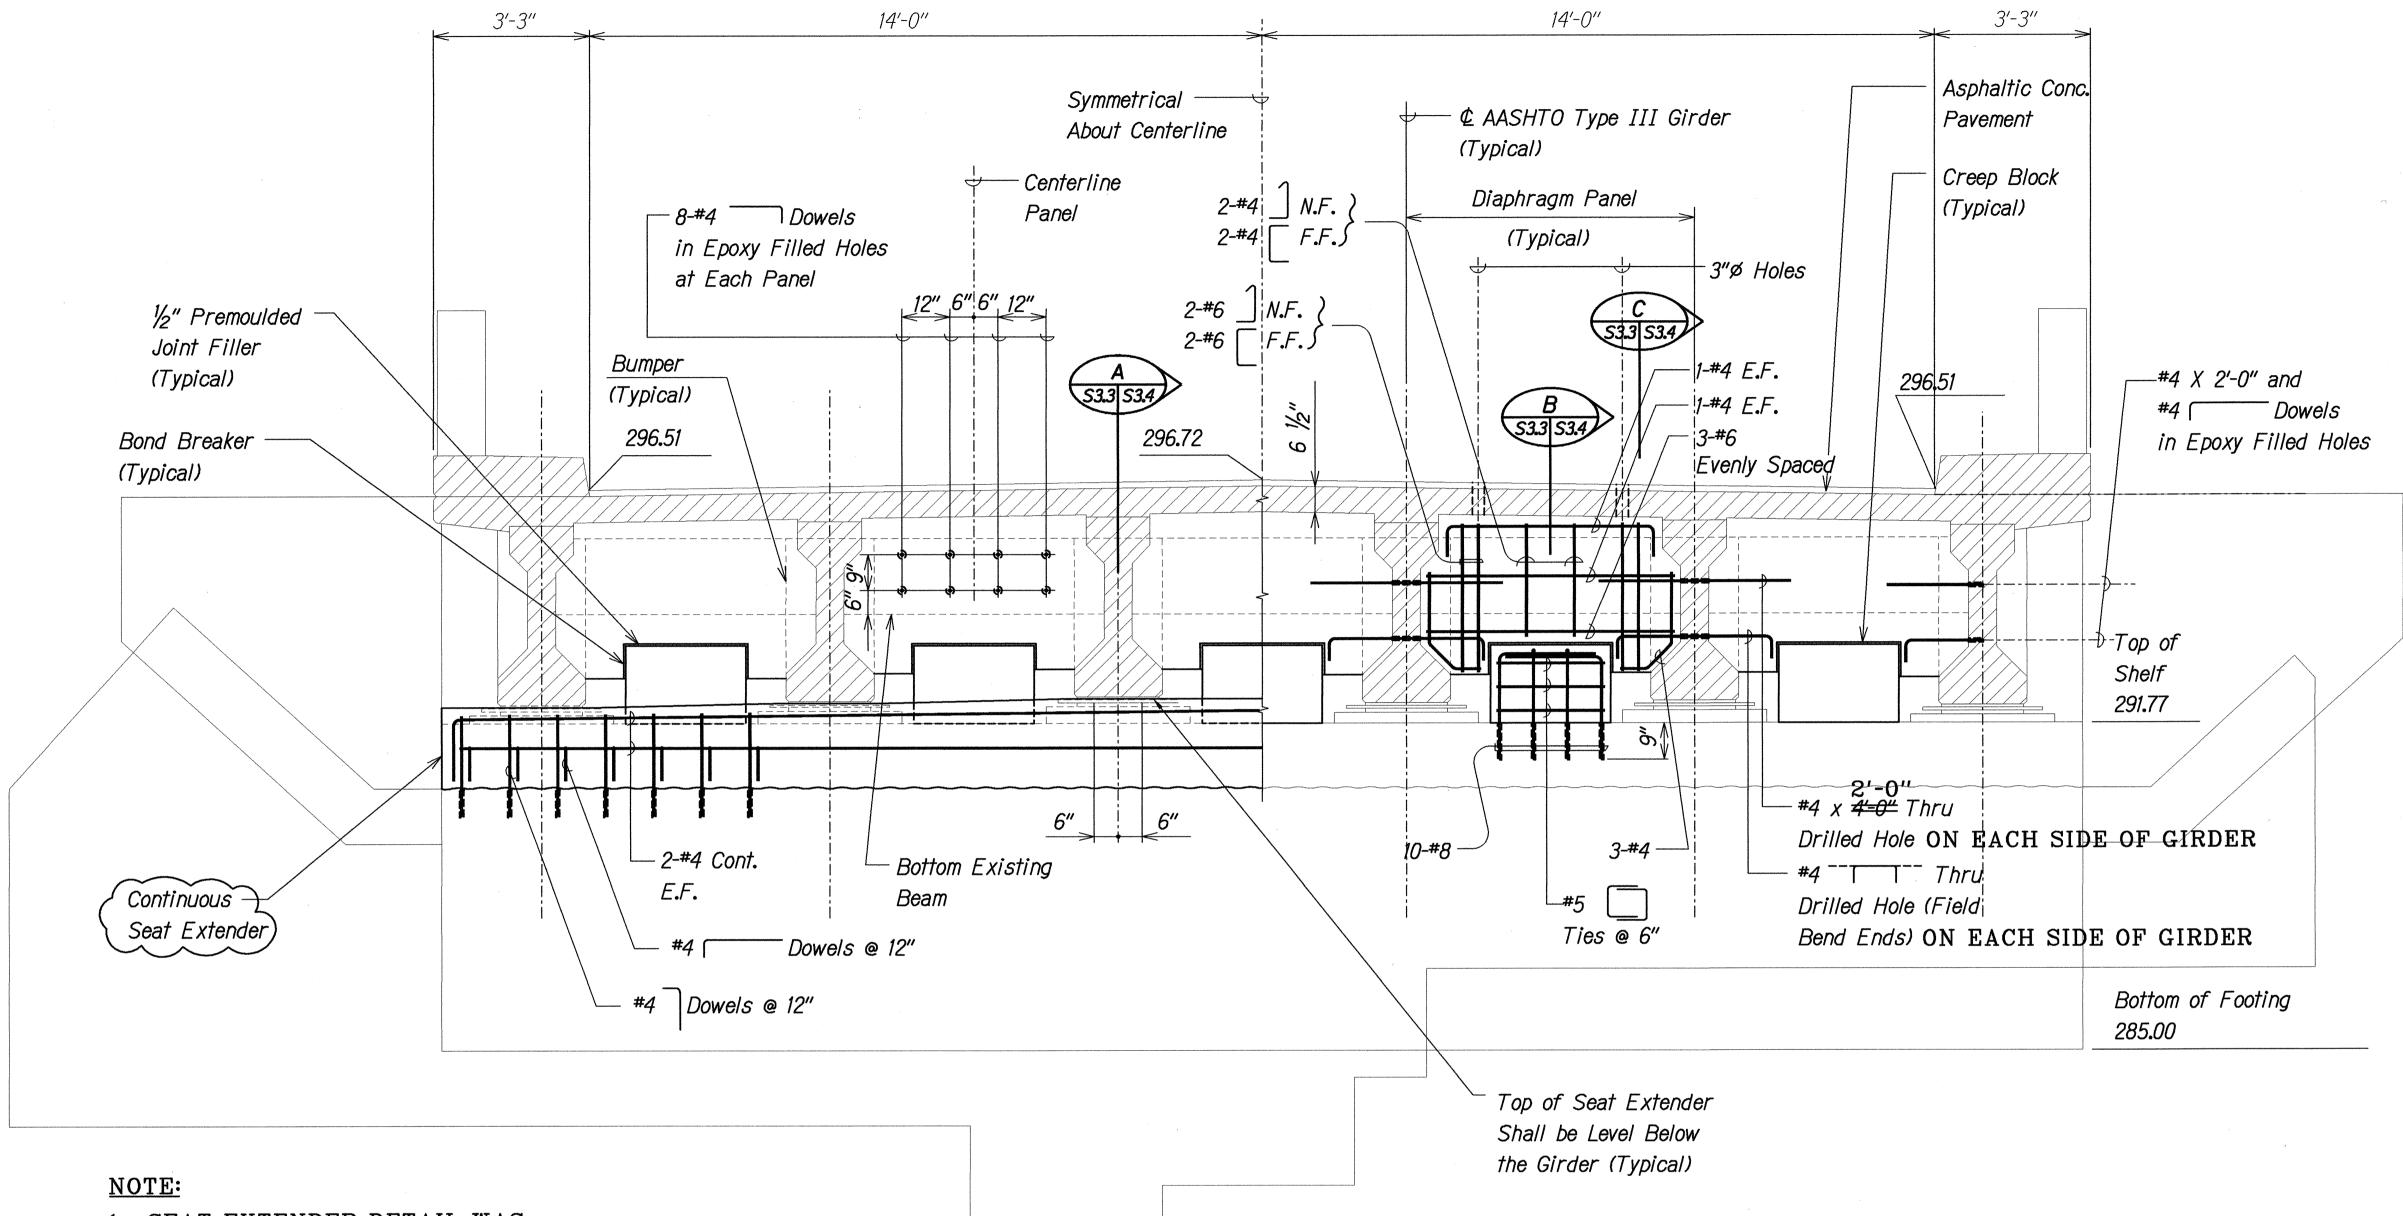

1. SEAT EXTENDER DETAIL WAS REVISED DUE TO EXISTING CONCRETE BEING HIGHER THAN SHOWN. (SEE DETAILS, SHEET 38)

ABUTMENT NO. 1 - ELEVATION Scale: 1/2" = 1'-0"



NOTES:

- 1. The Contractor Shall Verify All Controlling Field Dimensions Before Ordering or Fabricating Material.
- 2. Location of Drilled Dowel Holes Shown in Plans are Approximate. Prior to Placing Holes in Concrete, the Contractor Shall Locate All Reinforcing Steel and Adjust the Location of the Holes to Clear All Reinforcing Bars. Final Hole Locations are Subject to the Approval of the Engineer.

A \$3.2 \square \$3.3

LEGEND FOR AS-BUILT POSTINGS Squiggly line for as-built deletion **₩** 100.00 Double line for as-built deletion

Text for as-built posting Roadway

LICENSED ENGINEER

THIS WORK WAS PREPARED BY ME OR UNDER MY SUPERVISION.

STATE OF HAWAII
DEPARTMENT OF TRANSPORTATION HIGHWAYS DIVISION

KALAOA BRIDGE

ABUTMENT NO. 1 ELEVATION

HAWAII BELT ROAD
SEISMIC RETROFIT OF VARIOUS BRIDGES
VICINITY OF PAPAIKOU, HAWAII
Project No. BR-019-2(43)


Scale: As Noted


Date: August 12, 1999 SHEET No. 53.3 OF 59 SHEETS


FILE: 7008\$33.DGN PLOT: ½" = 1'-0"

"AS-BUI

FED. ROAD DIST. NO.	STATE	FED. AID PROJ. NO.	FISCAL YEAR		TOTAL SHEETS
HAWAII	HAW.	BR-019-2(43)	2000	31	65

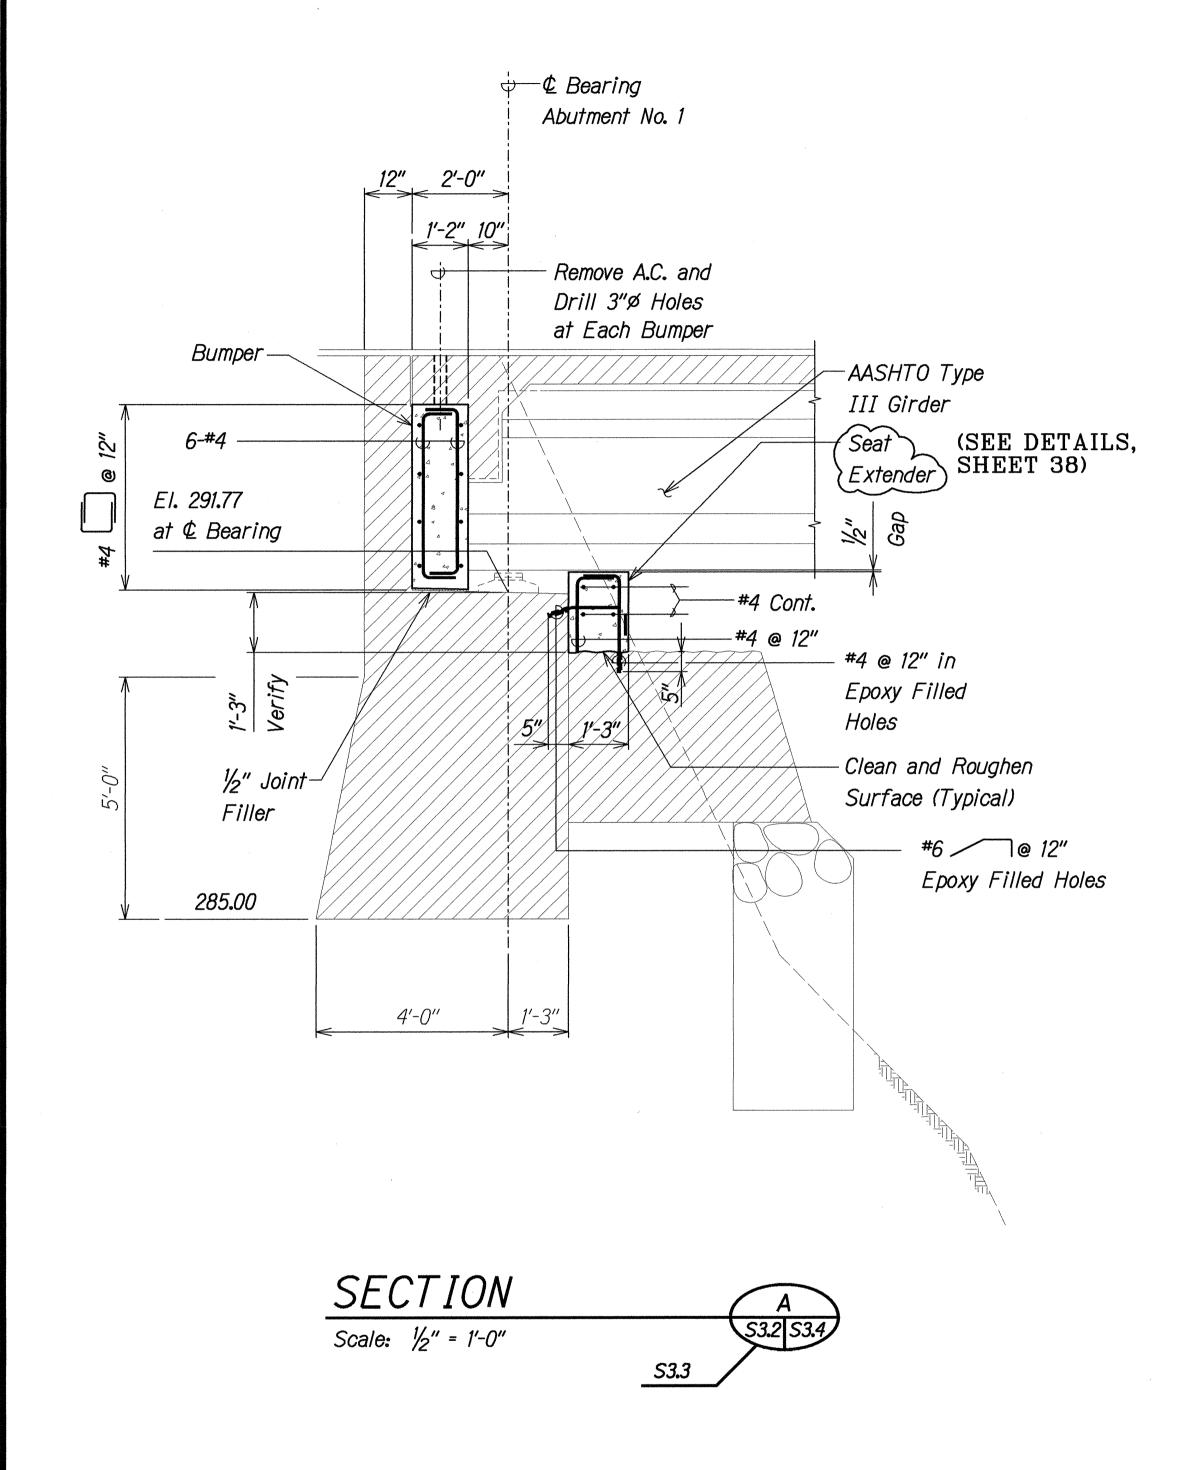

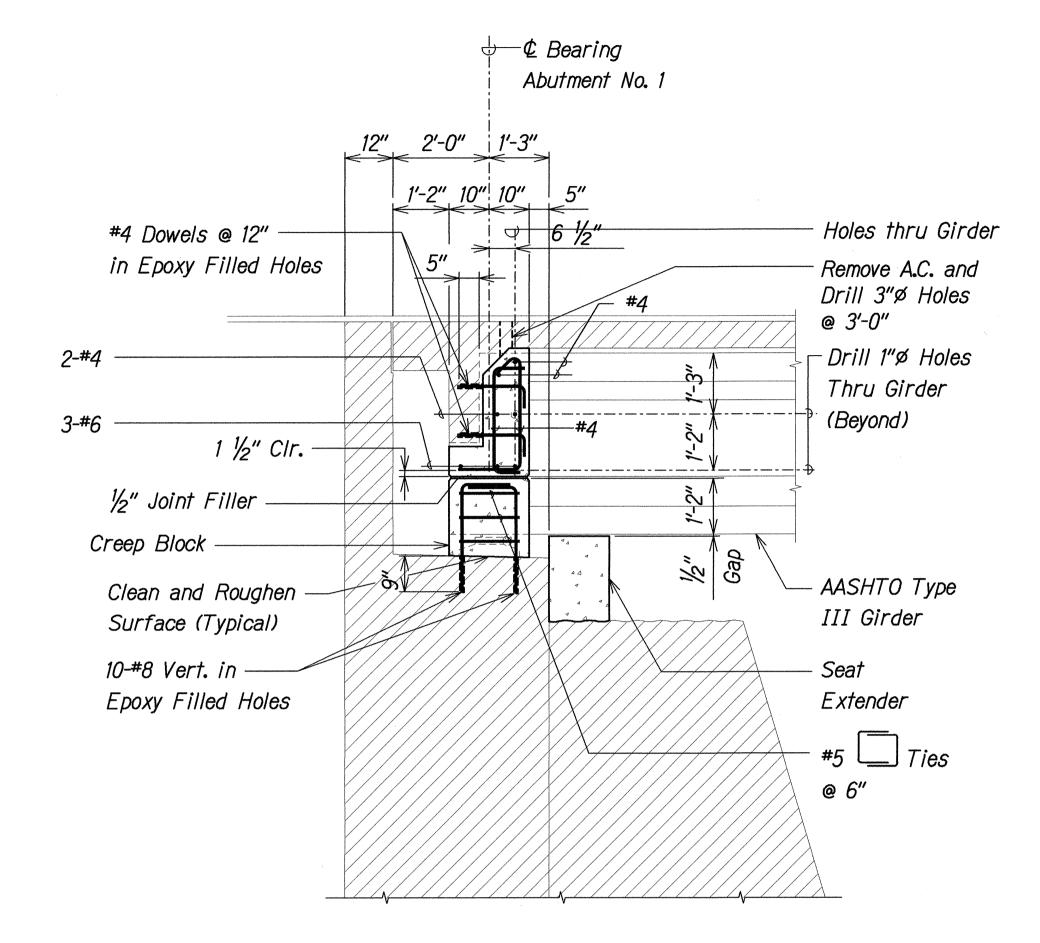

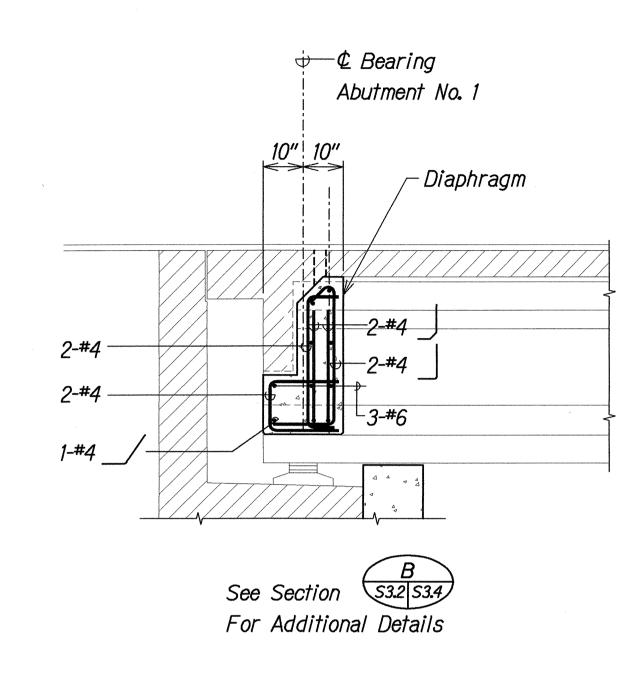

SECTION Scale: 1/2" = 1'-0"



SECTION Scale: 1/2" = 1'-0"


NOTES:

- 1. The Contractor Shall Verify All Controlling Field Dimensions Before Ordering or Fabricating Material.
- 2. Location of Drilled Dowel Holes Shown in Plans are Approximate. Prior to Placing Holes in Concrete, the Contractor Shall Locate All Reinforcing Steel and Adjust the Location of the Holes to Clear All Reinforcing Bars. Final Hole Locations are Subject to the Approval of the Engineer.
- 3. When Pouring Concrete Thru 3" Diameter Holes There Shall Be No Void Spaces, Entrapped Air, or Entrapped Water.
- 4. After Pouring Concrete to Top of Deck, A.C. shall be Replaced to Original Elevation. Do not Place A.C. Until Concrete has Sufficiently Hardened.
- 5. For Lane Closures, see Specifications.

LEGEND FOR AS-BUILT POSTINGS Squiggly line for as-built deletion

√ 100.00 Double line for as-built deletion

Text for as-built posting Roadway

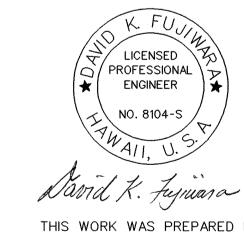

THIS WORK WAS PREPARED BY ME OR UNDER MY SUPERVISION

STATE OF HAWAII
DEPARTMENT OF TRANSPORTATION HIGHWAYS DIVISION KALAOA BRIDGE


ABUTMENT NO. 1 SECTIONS


HAWAII BELT ROAD
SEISMIC RETROFIT OF VARIOUS BRIDGES
VICINITY OF PAPAIKOU, HAWAII
Project No. BR-019-2(43) Scale: As Noted Date: August 12, 1999

SHEET No. 53.4 OF 59 SHEETS

FILE: 7008S34.DGN PLOT: ½" = 1'-0"

FED. ROAD DIST. NO.	STATE	FED. AID PROJ. NO.	FISCAL YEAR	SHEET NO.	TOTAL SHEETS
HAWAII	HAW.	BR-019-2(43)	2000	32	65

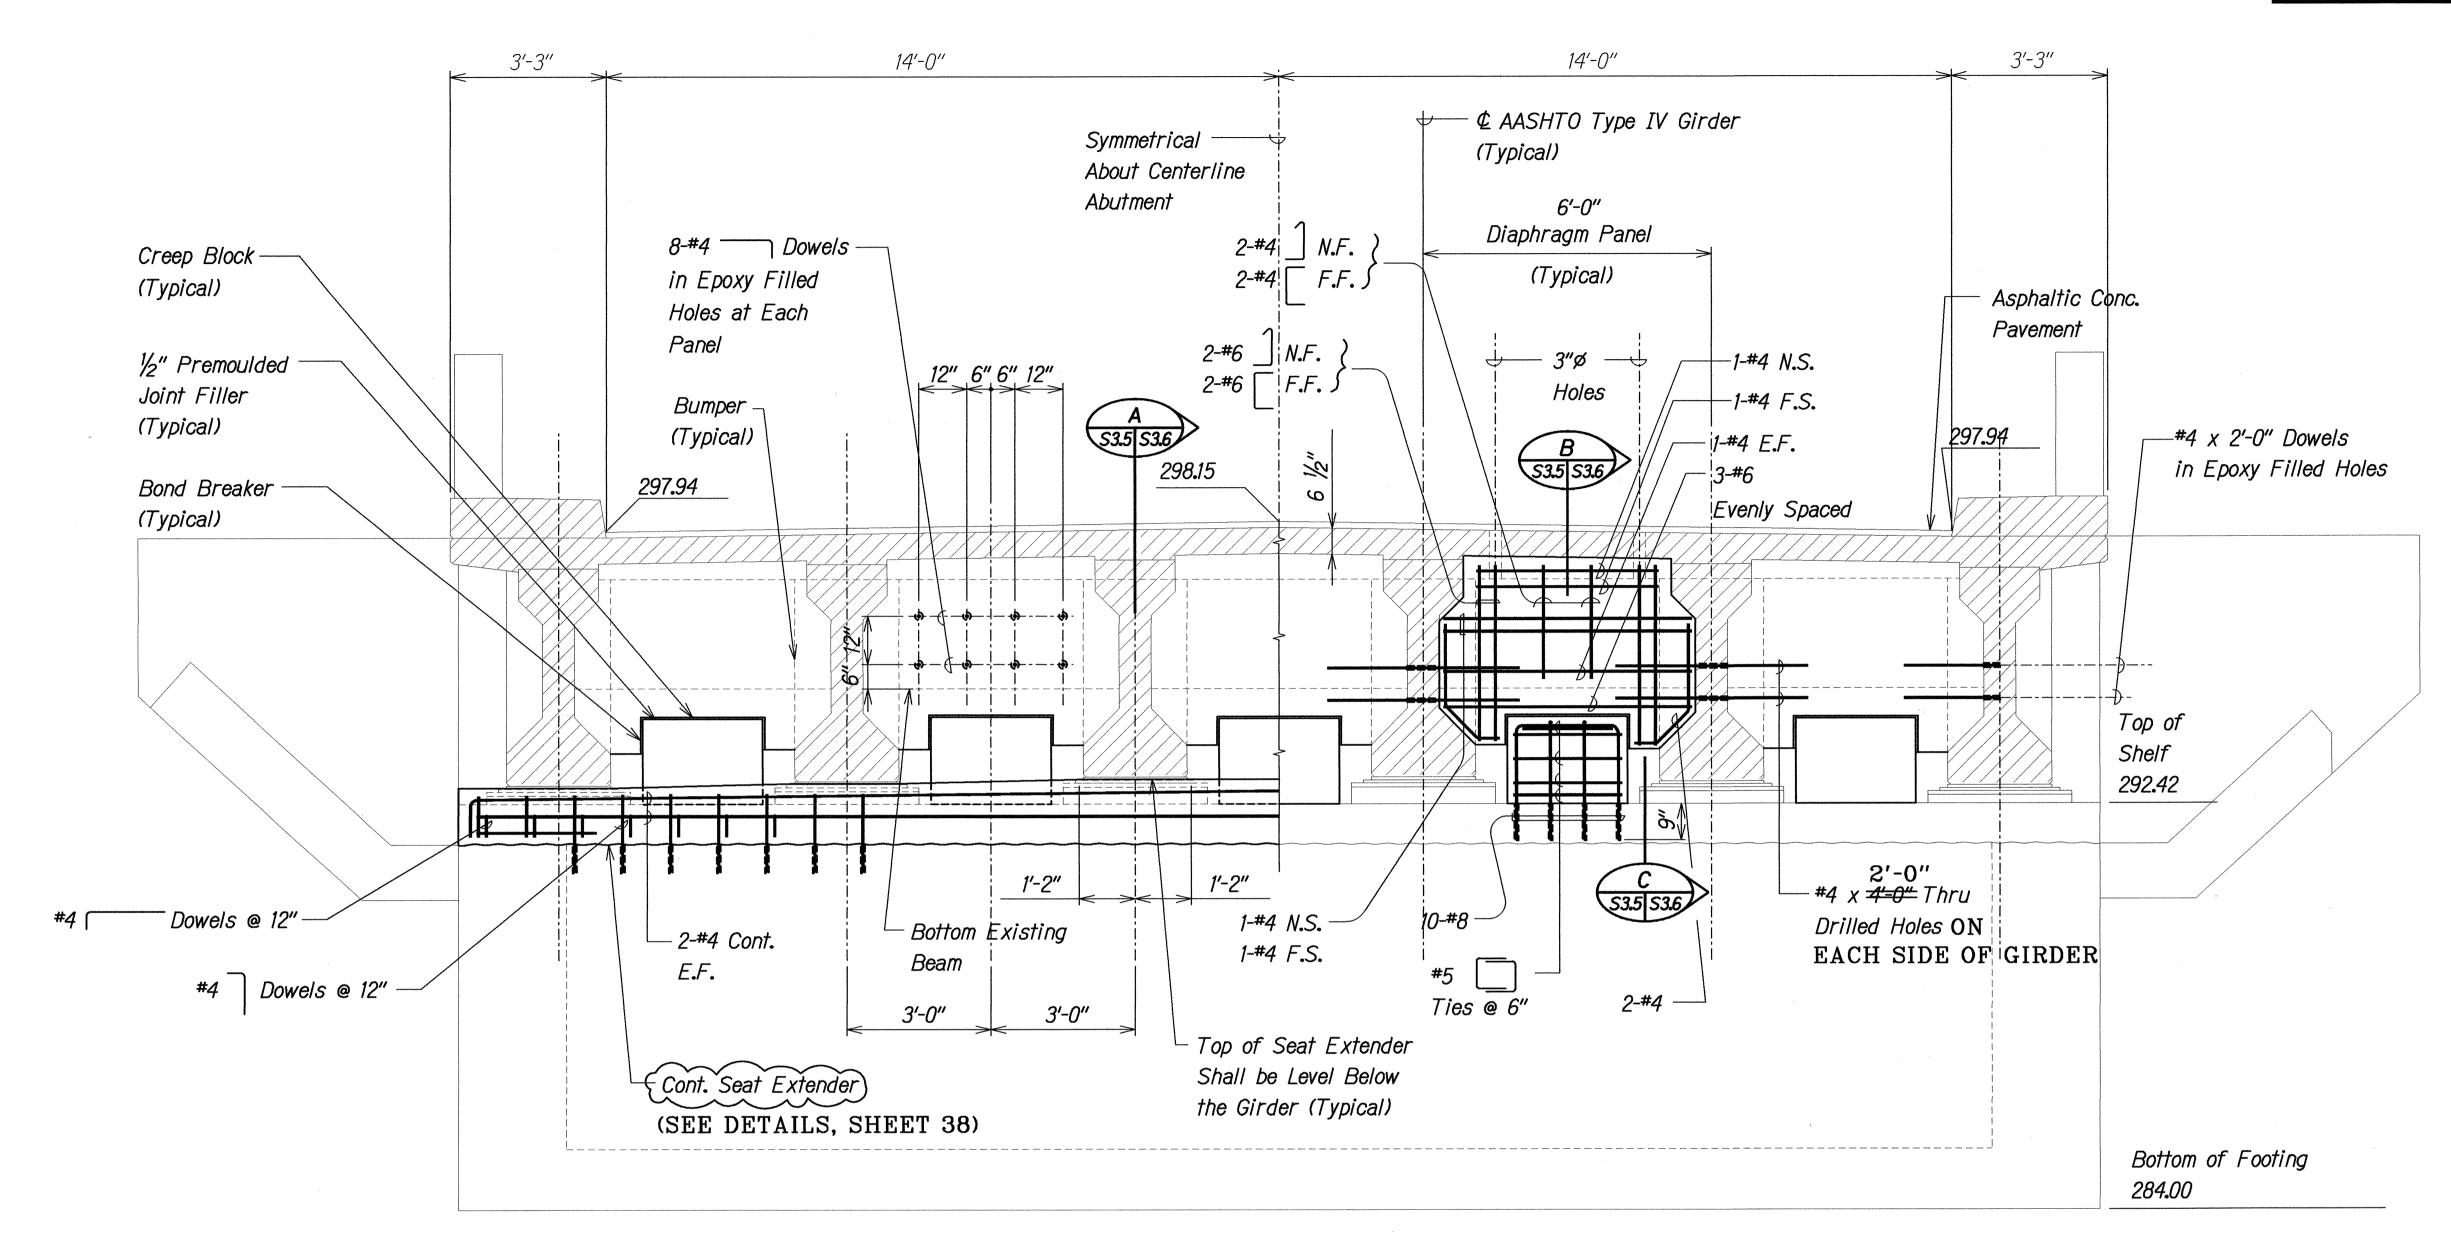

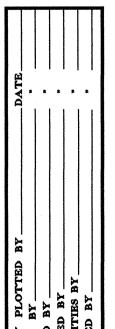

NOTES:

1. The Contractor Shall Verify All Controlling Field Dimensions Before Ordering or Fabricating Material.

2. Location of Drilled Dowel Holes Shown in Plans are Approximate. Prior to Placing Holes in Concrete, the Contractor Shall Locate All Reinforcing Steel and Adjust the Location of the Holes to Clear All Reinforcing Bars. Final Hole Locations are Subject to the Approval of the Engineer.

ABUTMENT NO. 2 - ELEVATION

Scale: 1/2" = 1'-0"



STATE OF HAWAII
DEPARTMENT OF TRANSPORTATION HIGHWAYS DIVISION

KALAOA BRIDGE

ABUTMENT NO. 2 ELEVATION

HAWAII BELT ROAD
SEISMIC RETROFIT OF VARIOUS BRIDGES
VICINITY OF PAPAIKOU, HAWAII
Project No. BR-019-2(43)

Scale: As Noted Date: August 12, 1999 SHEET No. S3.5 OF 59 SHEETS

LEGEND FOR AS-BUILT POSTINGS

Squiggly line for as-built deletion **₩** Double line for as-built deletion 100.00


Text for as-built posting Roadway


FILE: 7008S35.DGN PLOT: ½" = 1'-0"


ENGINEER

THIS WORK WAS PREPARED BY ME OR UNDER MY SUPERVISION.

FED. ROAD DIST. NO.	STATE	FED. AID PROJ. NO.	FISCAL YEAR		TOTAL SHEETS
HAWAII	HAW.	BR-019-2(43)	2000	33	65

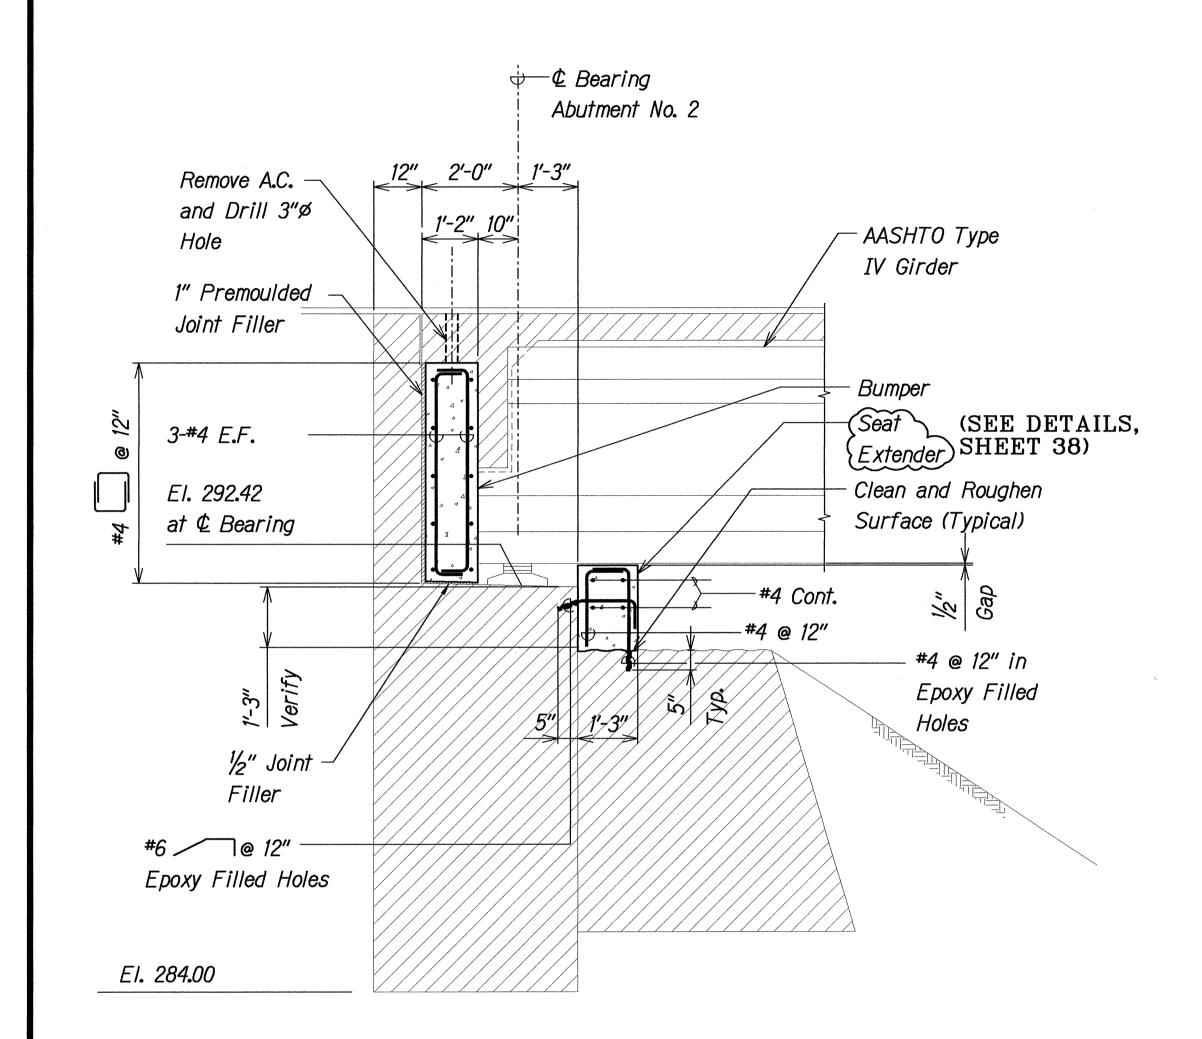

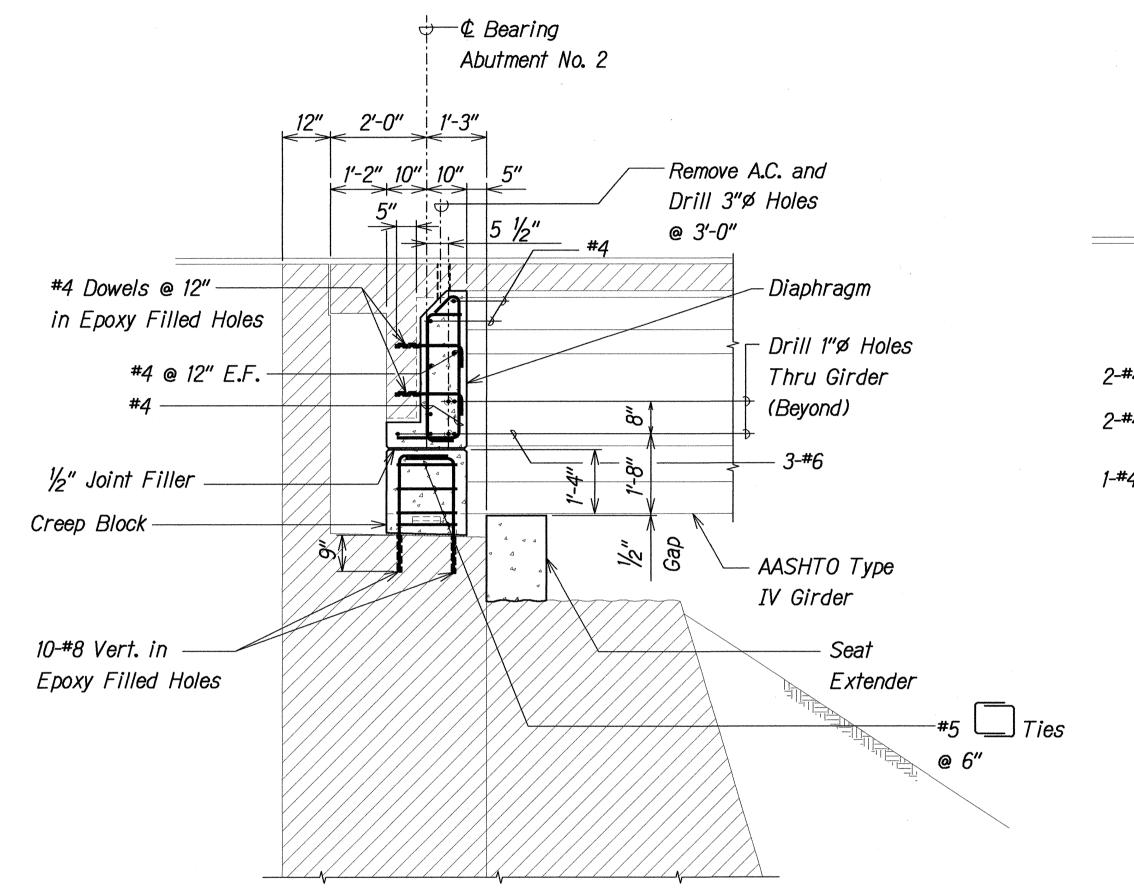

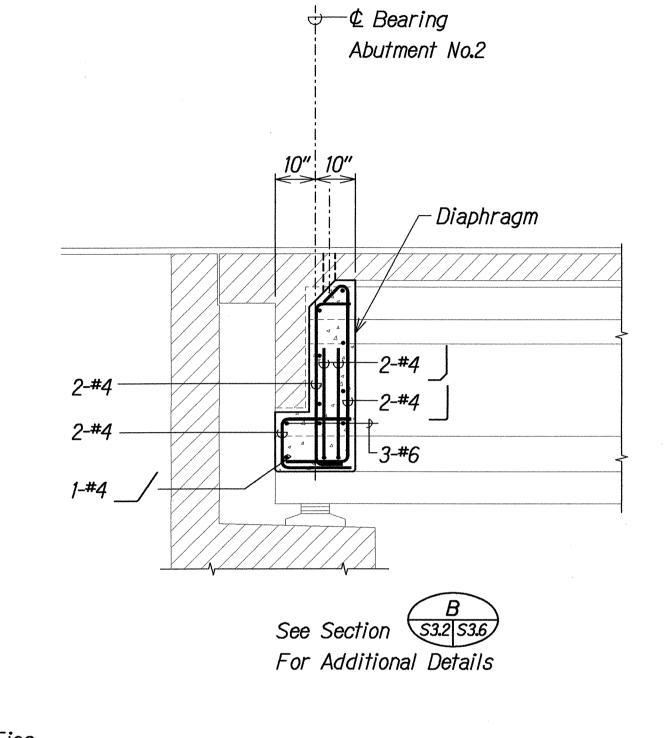

SECTION


Scale: 1/2" = 1'-0"

SECTION

Scale: 1/2" = 1'-0"

S3.2 S3.6

SECTION Scale: 1/2" = 1'-0"

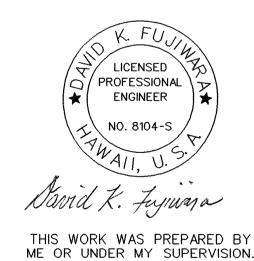

S3.5 S3.6

NOTES:

- 1. The Contractor Shall Verify All Controlling Field Dimensions Before Ordering or Fabricating Material.
- 2. Location of Drilled Dowel Holes Shown in Plans are Approximate. Prior to Placing Holes in Concrete, the Contractor Shall Locate All Reinforcing Steel and Adjust the Location of the Holes to Clear All Reinforcing Bars. Final Hole Locations are Subject to the Approval of the Engineer.
- 3. When Pouring Concrete Thru 3" Diameter Holes There Shall Be No Void Spaces, Entrapped Air, or Entrapped Water.
- 4. After Pouring Concrete to Top of Deck, A.C. shall be Replaced to Original Elevation. Do not Place A.C. Until Concrete has Sufficiently Hardened.
- 5. For Lane Closures, see Specifications.

LEGEND FOR AS-BUILT POSTINGS

Squiggly line for as-built deletion

Double line for as-built deletion

Roadway Text for as-built posting

S3.2 S3.6

TS |

ABUTMENT NO. 2 SECTIONS

HAWAII BELT ROAD
SEISMIC RETROEIT OF VARIOUS BRIDGES

STATE OF HAWAII
DEPARTMENT OF TRANSPORTATION

HIGHWAYS DIVISION

KALAOA BRIDGE

HAWA!! BELT ROAD
SEISMIC RETROFIT OF VARIOUS BRIDGES
VICINITY OF PAPAIKOU, HAWA!!
Project No. BR-019-2(43)
Scale: As Noted

Date: August 12, 1999


SHEET No. 53.6 OF 59 SHEETS

FILE: 7008536.DGN PLOT: ½" = 1'-0"

SURVEY PLOTTED BYDRAWN BY
TRACED BY
DESIGNED BY
QUANTITIES BY
CHECKED BY

"AS-BUILT"

FED. ROAD DIST. NO.	STATE	FED. AID PROJ. NO.	FISCAL YEAR		TOTAL SHEETS
HAWAII	HAW.	BR-019-2(43)	2000	34	65

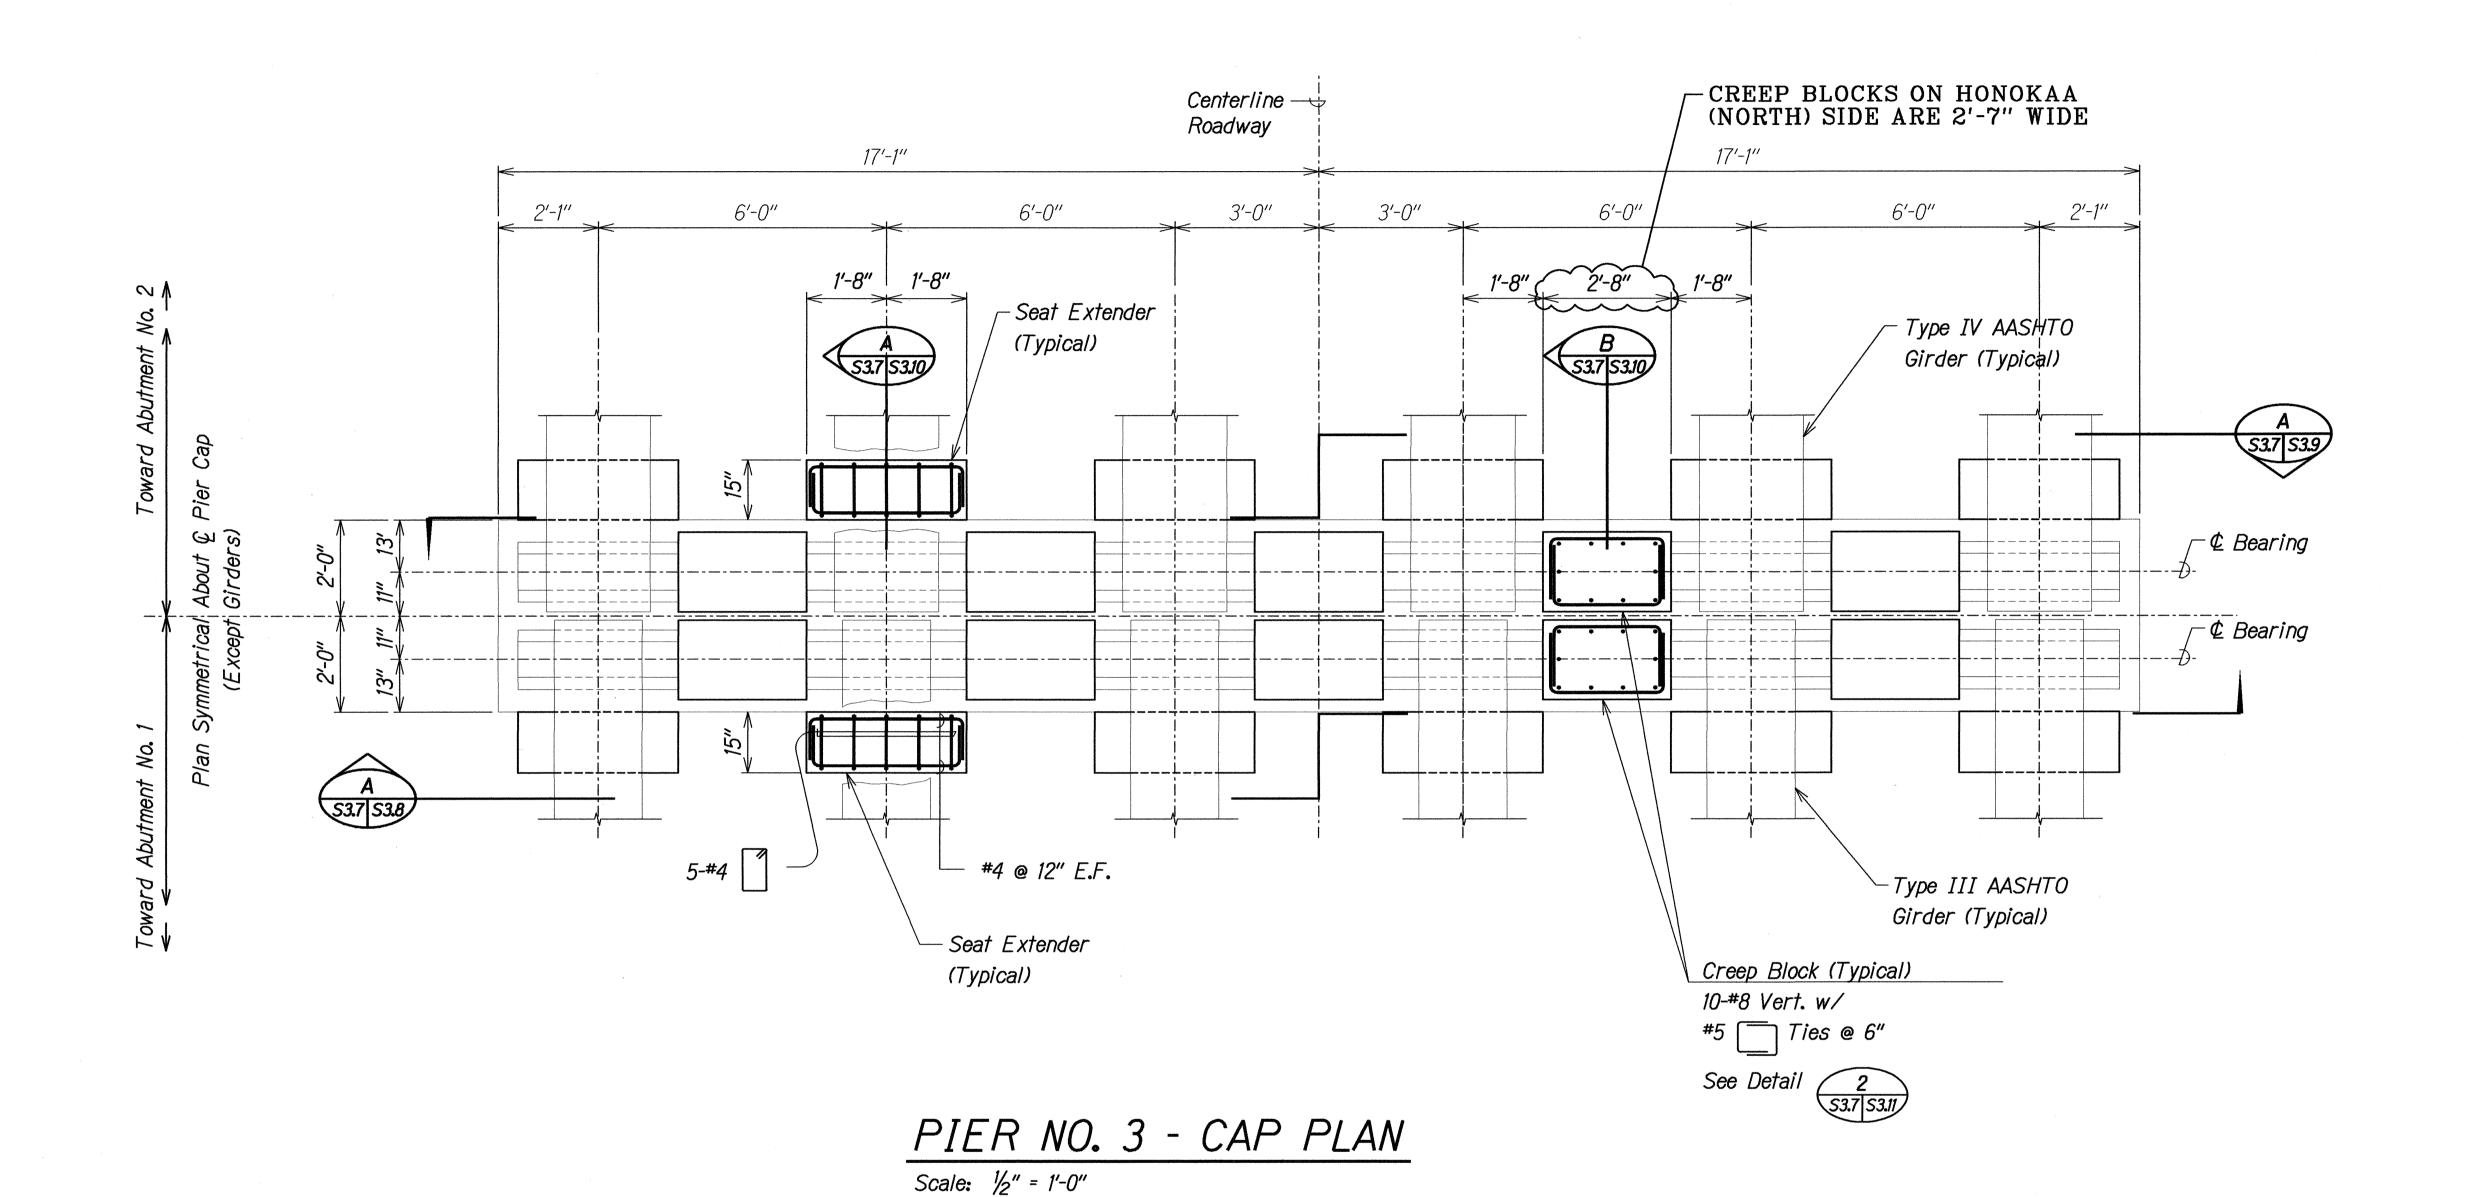

NOTES:

1. The Contractor Shall Verify All Controlling Field Dimensions Before Ordering or Fabricating Material.

2. Location of Drilled Dowel Holes Shown in Plans are Approximate. Prior to Placing Holes in Concrete, the Contractor Shall Locate All Reinforcing Steel and Adjust the Location of the Holes to Clear All Reinforcing Bars. Final Hole Locations are Subject to the Approval of the Engineer.

LEGEND FOR AS-BUILT POSTINGS

Squiggly line for as-built deletion **√√** 100.00 Double line for as-built deletion

Text for as-built posting Roadway

LICENSED PROFESSIONAL ENGINEER

THIS WORK WAS PREPARED BY ME OR UNDER MY SUPERVISION.


STATE OF HAWAII
DEPARTMENT OF TRANSPORTATION HIGHWAYS DIVISION


KALAOA BRIDGE

PIER NO. 3 CAP PLAN

HAWAII BELT ROAD
SEISMIC RETROFIT OF VARIOUS BRIDGES
VICINITY OF PAPAIKOU, HAWAII
Project No. BR-019-2(43) Scale: As Noted Date: August 12, 1999

SHEET No. S3.7 OF 59 SHEETS

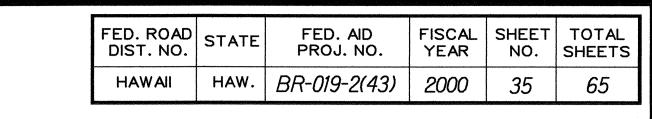

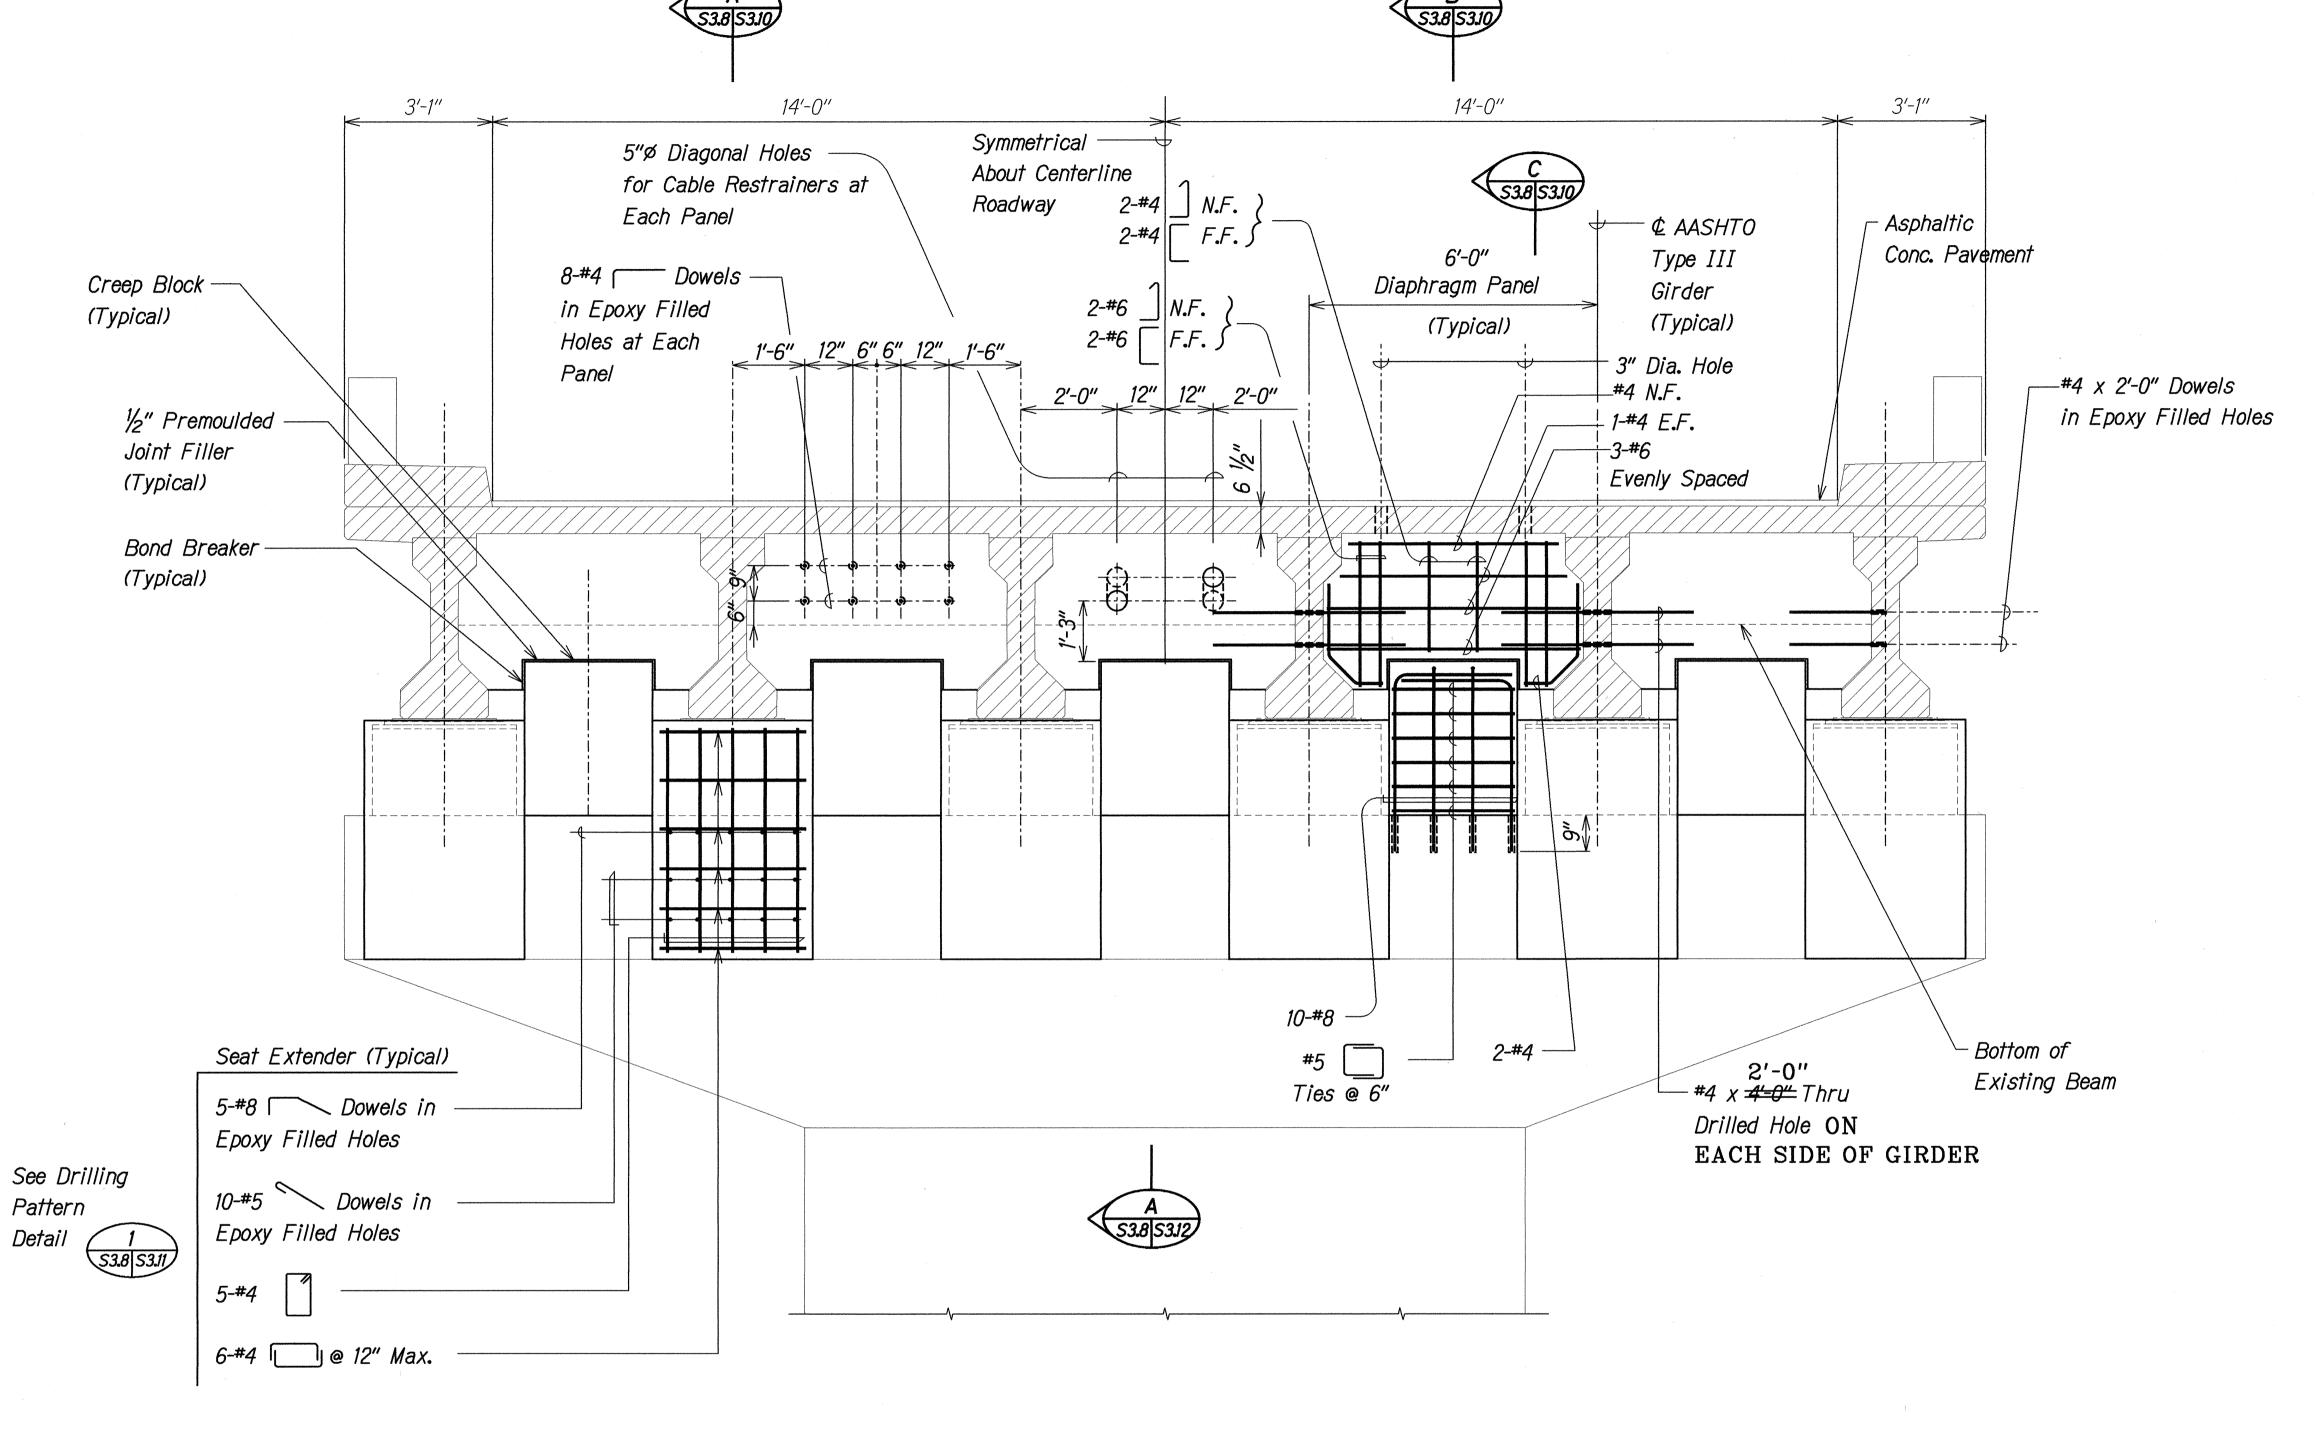


NOTES:

1. The Contractor Shall Verify All Controlling Field Dimensions Before Ordering or Fabricating Material.

2. Location of Drilled Dowel Holes Shown in Plans are Approximate. Prior to Placing Holes in Concrete, the Contractor Shall Locate All Reinforcing Steel and Adjust the Location of the Holes to Clear All Reinforcing Bars. Final Hole Locations are Subject to the Approval of the Engineer.

PIER NO. 3 - CAP ELEVATION

Scale: 1/2" = 1'-0"

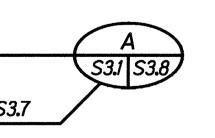

LEGEND FOR AS-BUILT POSTINGS

Squiggly line for as-built deletion

Double line for as-built deletion

Roadway Text for as-built posting

PROFESSIONAL ENGINEER

NO. 8104-S

NO. 8104-S

AII, U.S.

Lavid K. Fujiwara

THIS WORK WAS PREPARED

THIS WORK WAS PREPARED BY ME OR UNDER MY SUPERVISION.

STATE OF HAWAII

DEPARTMENT OF TRANSPORTATION

HIGHWAYS DIVISION

KALAOA BRIDGE


PIER NO. 3 CAP ELEVATION

HAWAII BELT ROAD
SEISMIC RETROFIT OF VARIOUS BRIDGES
VICINITY OF PAPAIKOU, HAWAII
Project No. BR-019-2(43)

Scale: As Noted Date: August 12, 1999


SHEET No. 53.8 OF 59 SHEETS

FILE: 7008\$38.DGN PLOT: ½" = 1'-0" "AS-BUILT"

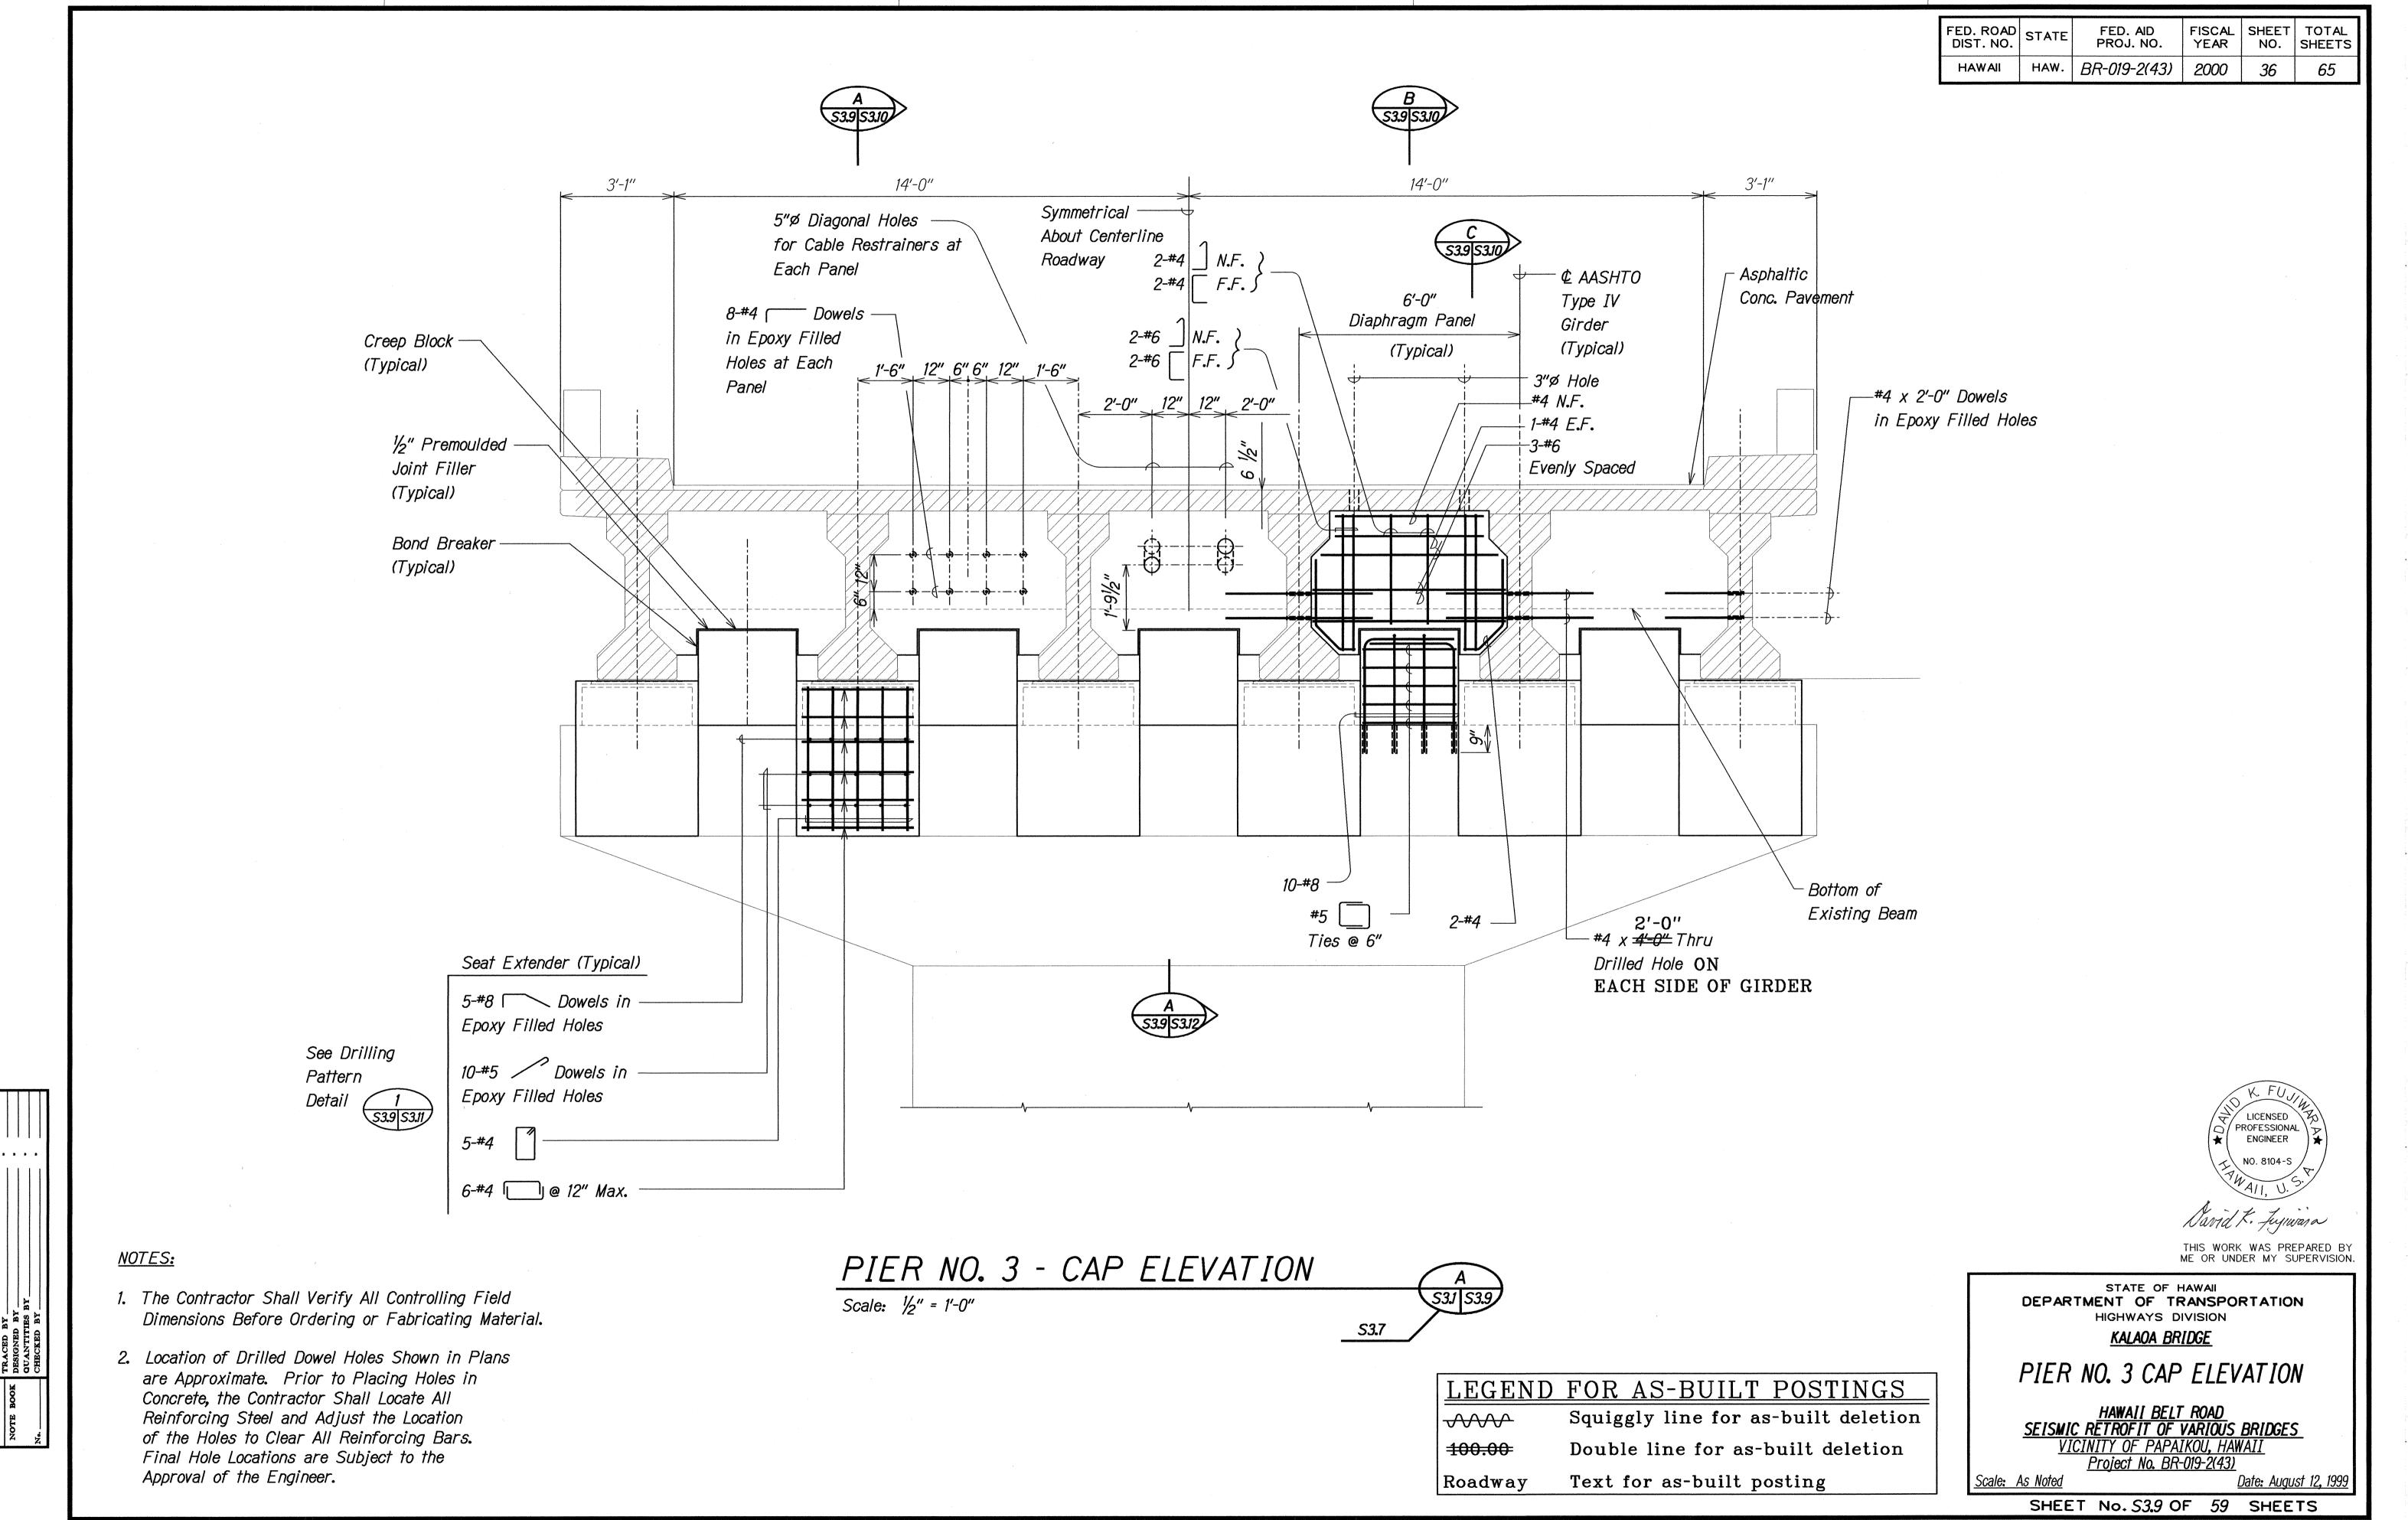


BUILT" **36**

FILE: 7008S39.DGN PLOT: ½" = 1'-0"

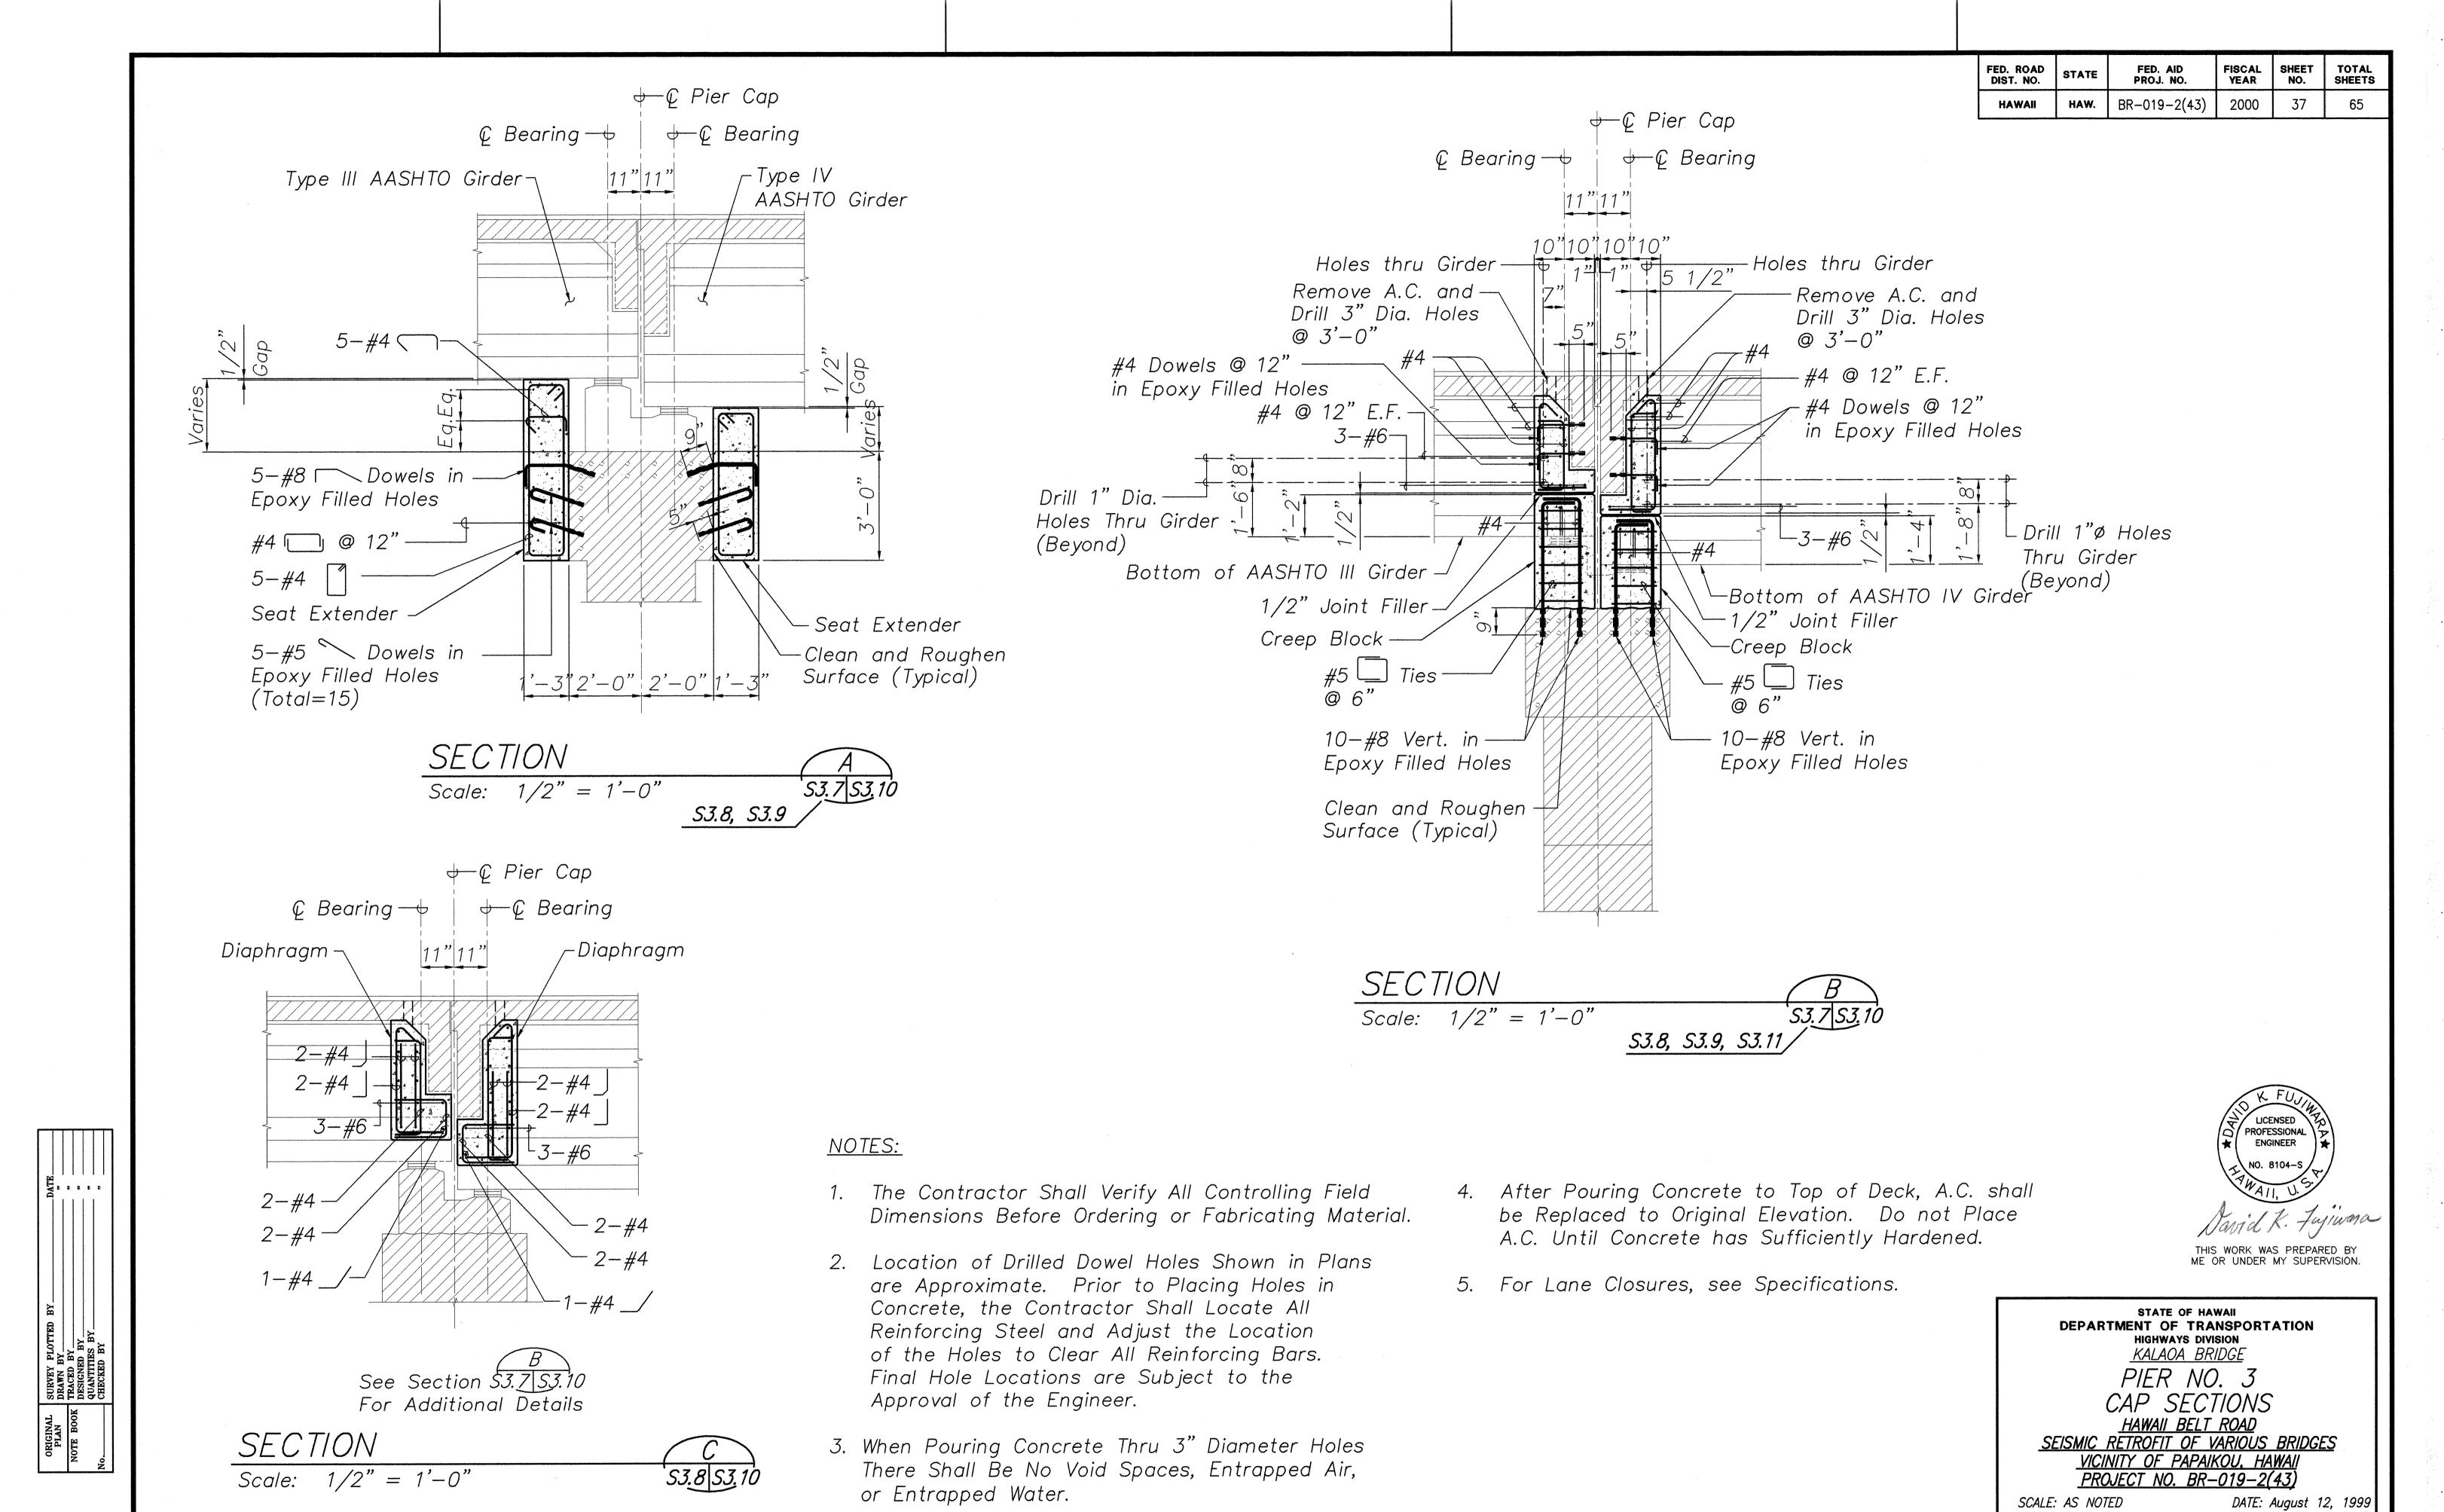


FILE: 7008S37.DWG PLOT: 1 = 1 37

SHEET No. S3.10 OF 59 SHEETS

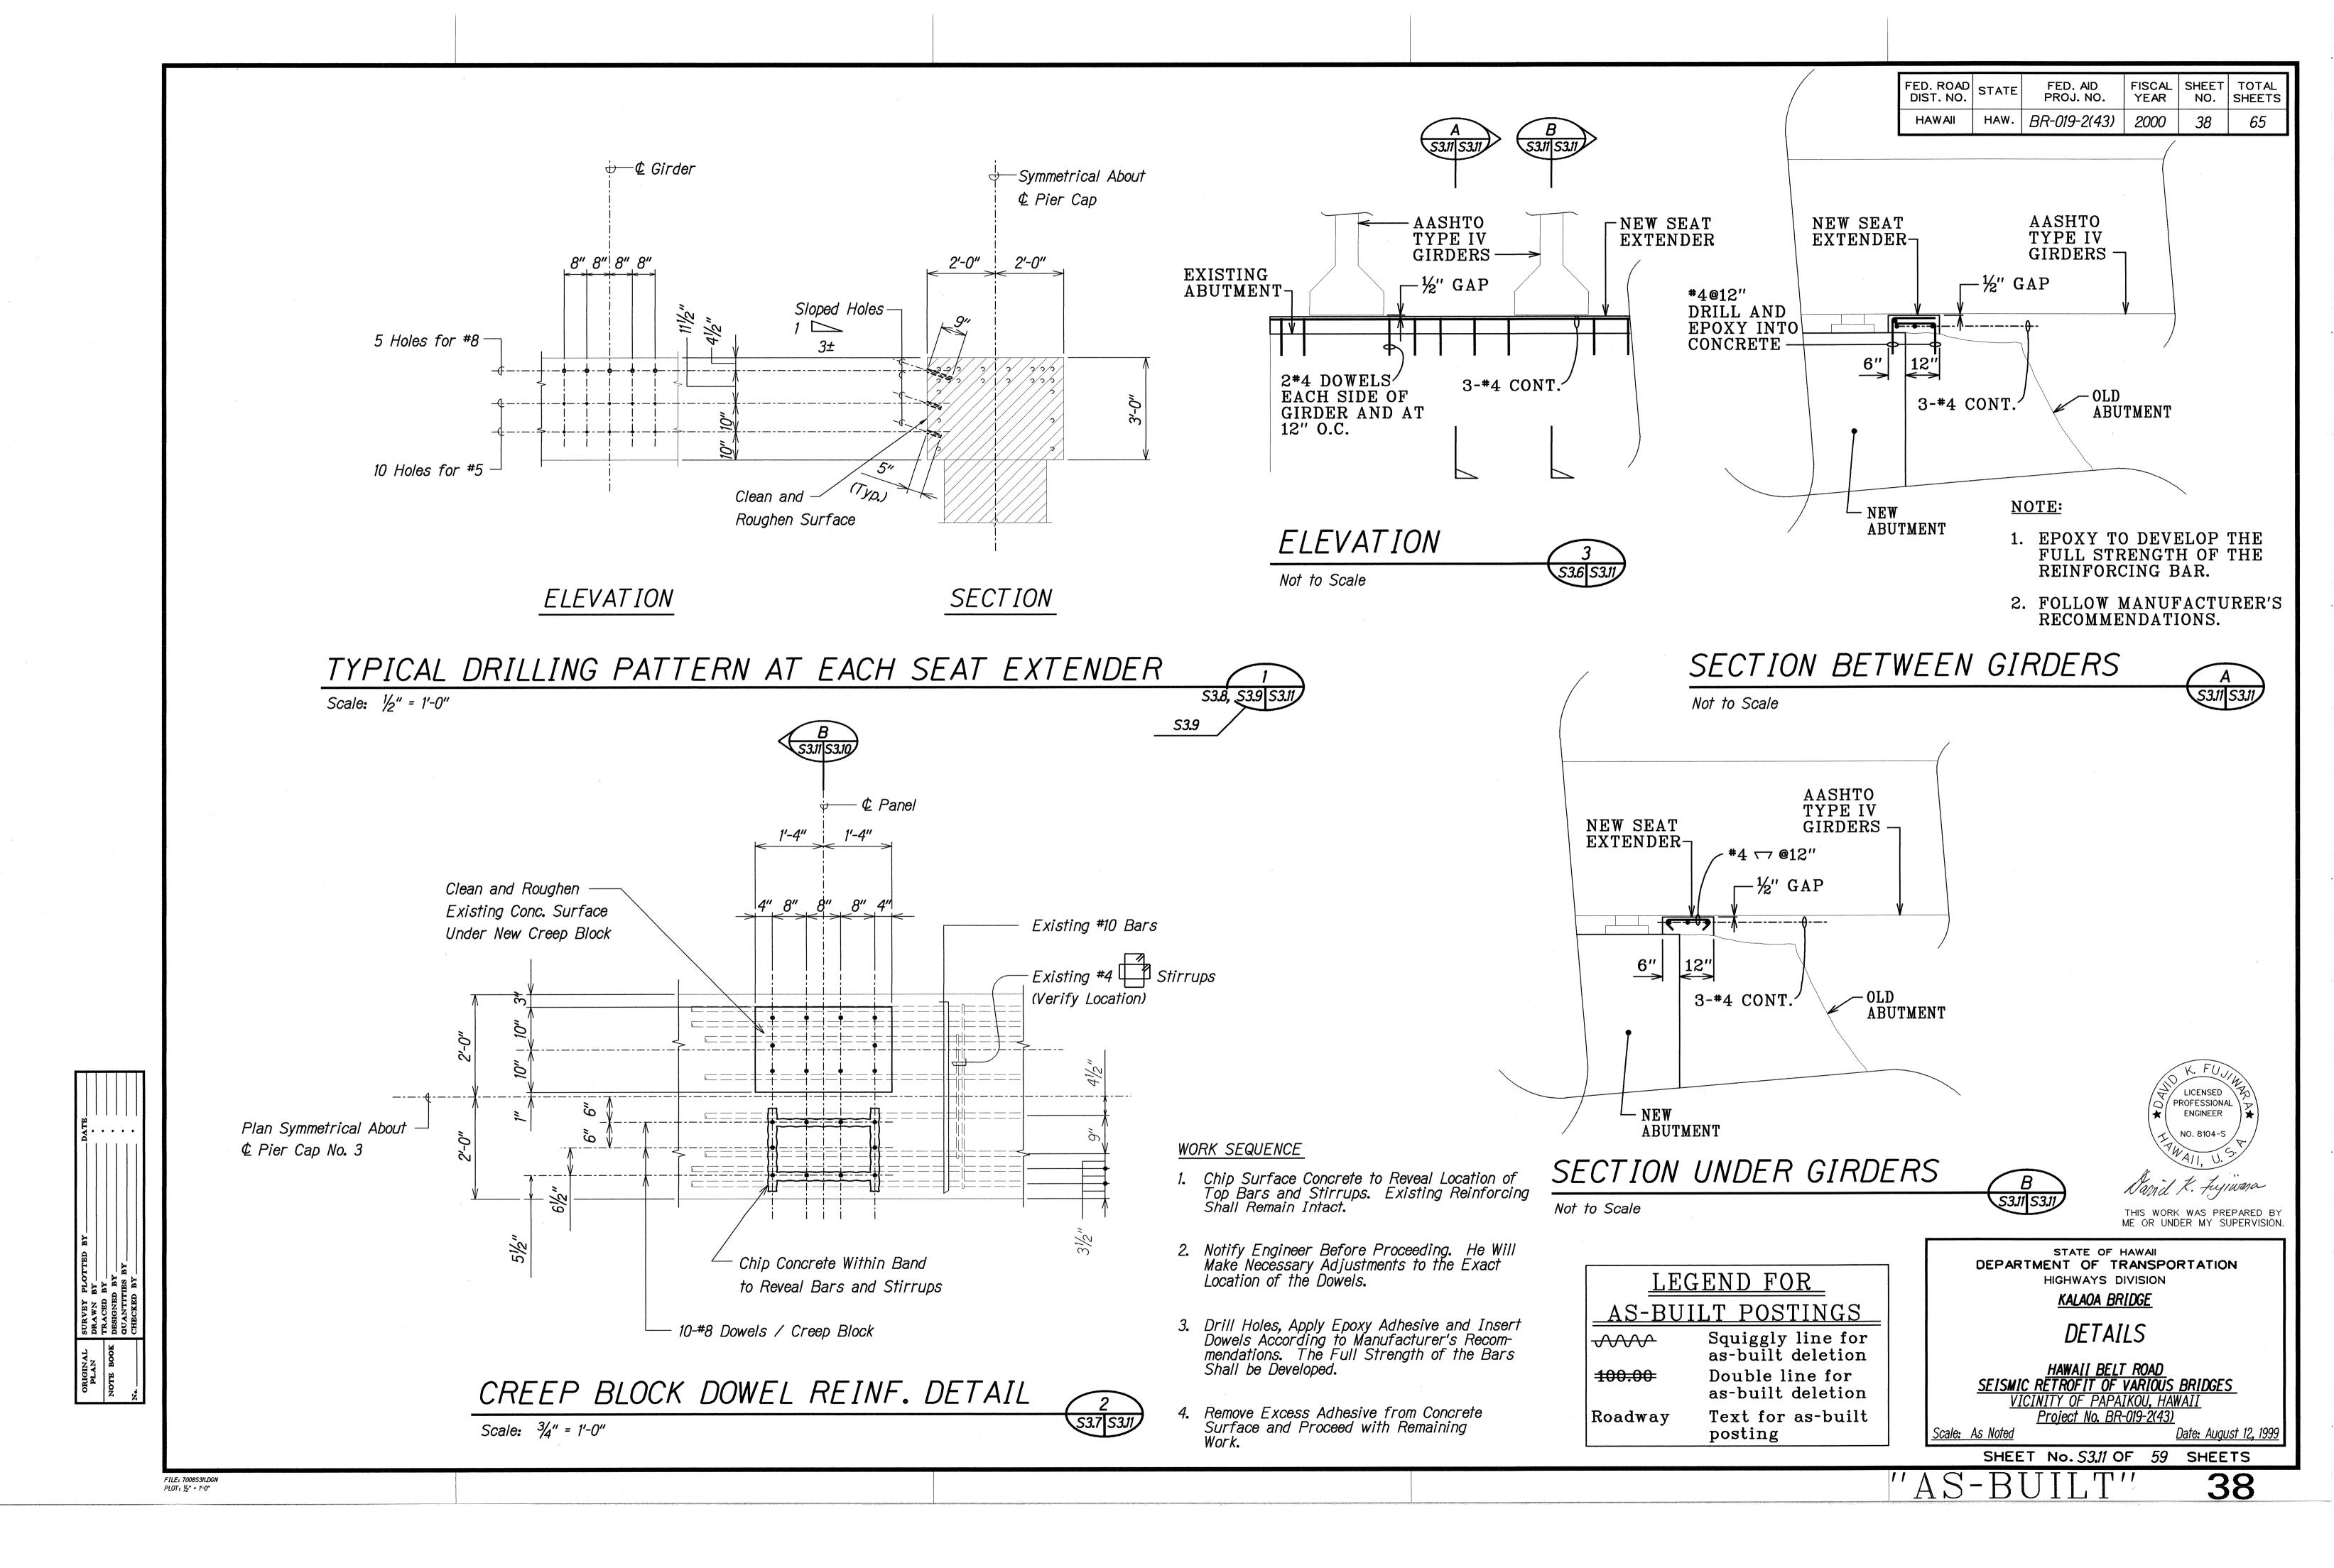

FISCAL SHEET TOTAL YEAR NO. SHEETS FED. ROAD STATE FED. AID PROJ. NO. HAW. BR-019-2(43) 2000 39

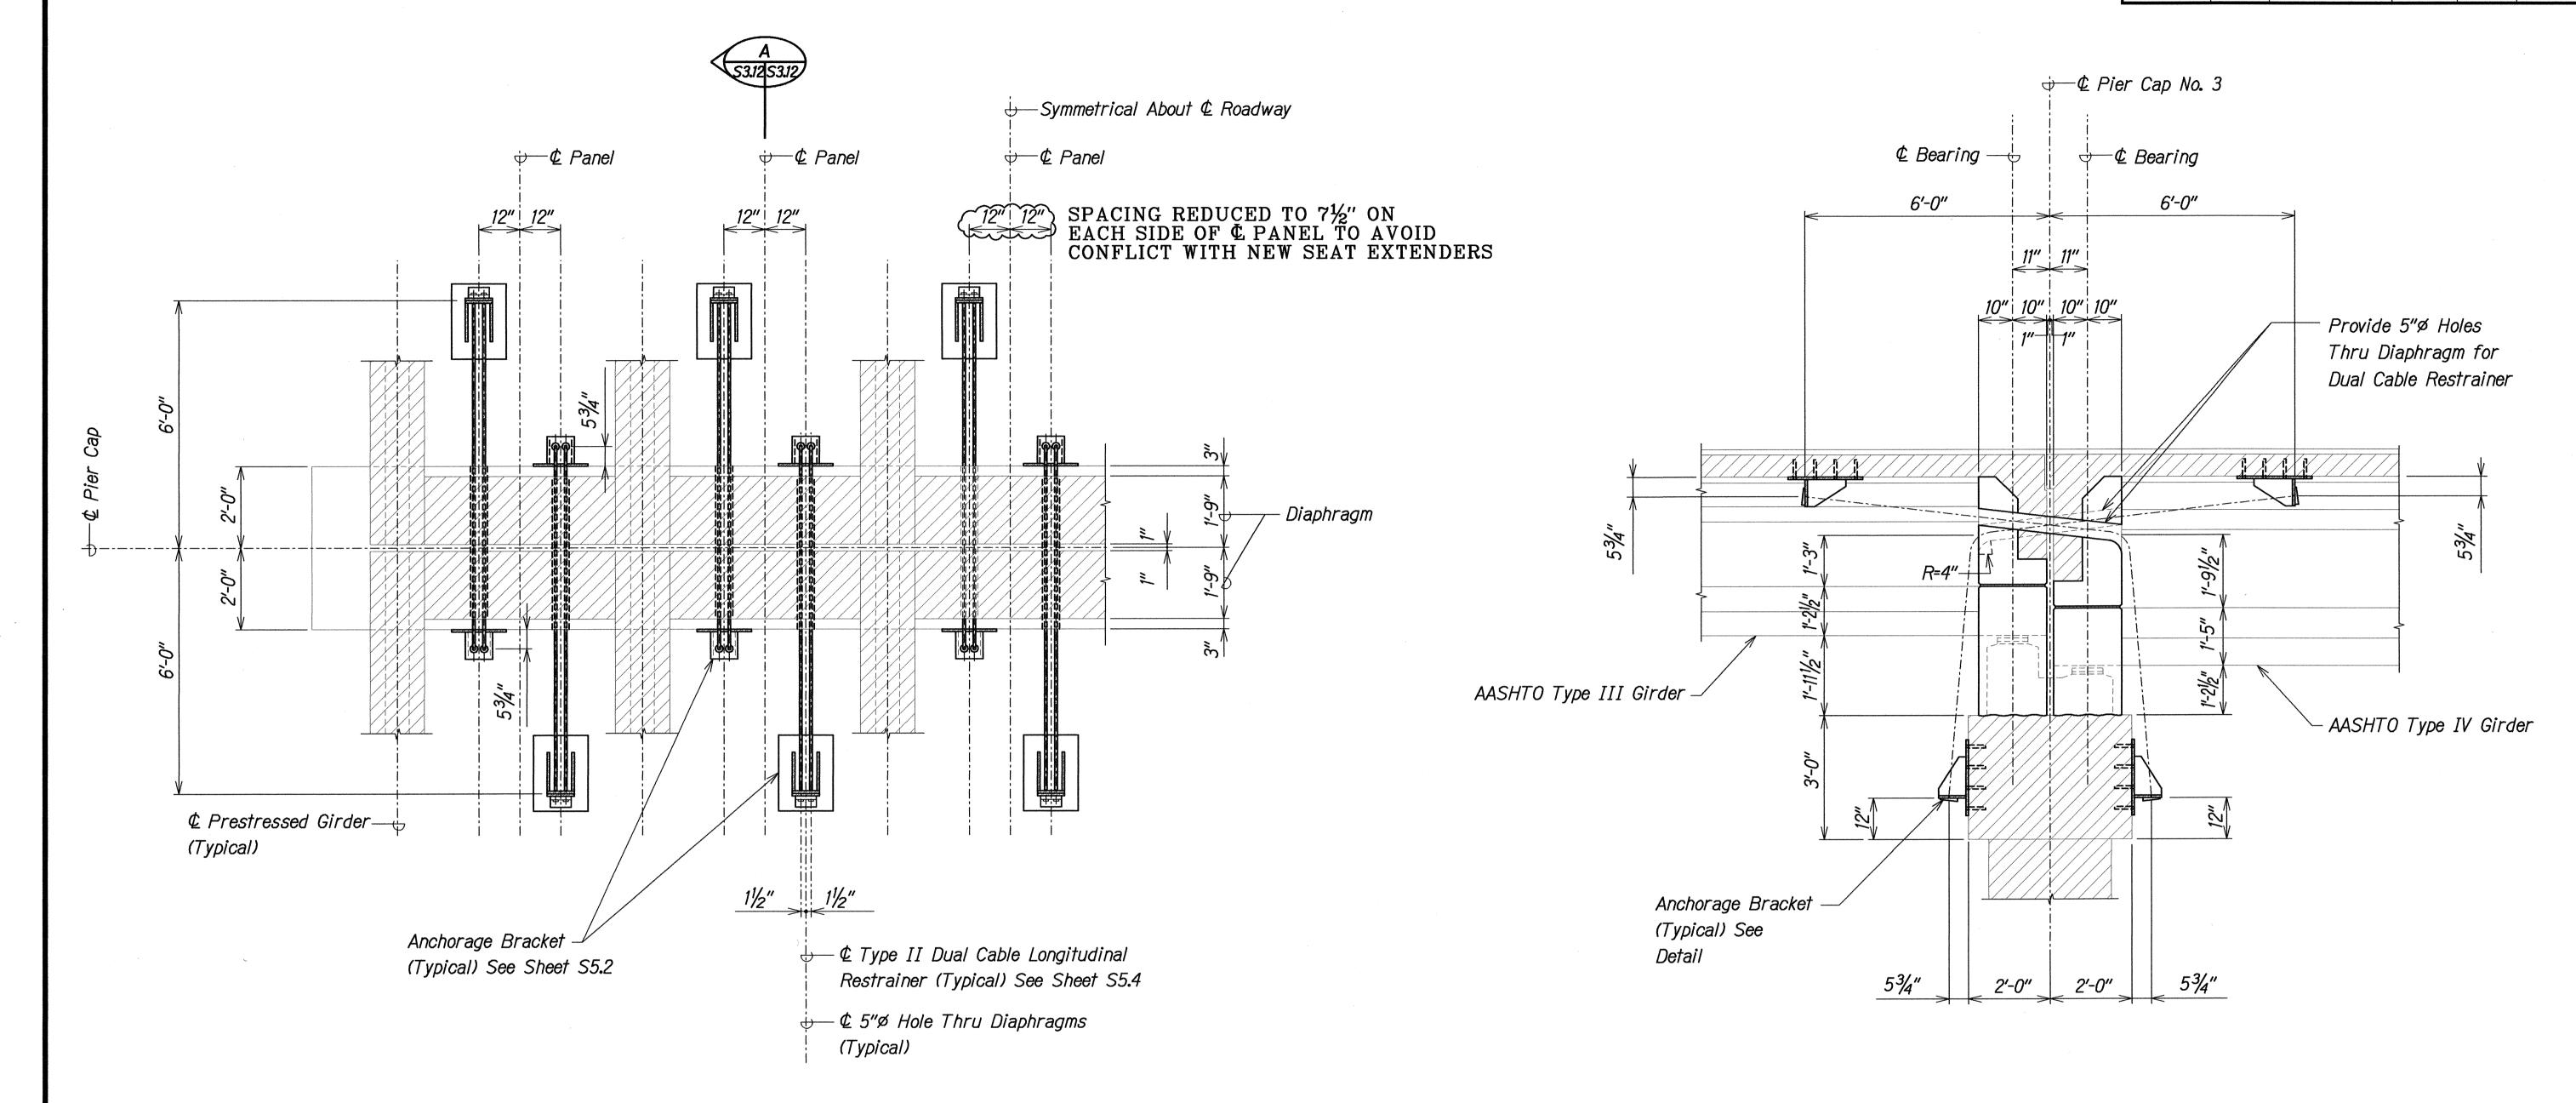

NOTES:

1. The Contractor Shall Verify All Controlling Field Dimensions Before Ordering or Fabricating Material.


Scale: 1/2" = 1'-0"

PLAN - PIER CAP RESTRAINER

2. Location of Drilled Dowel Holes Shown in Plans are Approximate. Prior to Placing Holes in Concrete, the Contractor Shall Locate All Reinforcing Steel and Adjust the Location of the Holes to Clear All Reinforcing Bars. Final Hole Locations are Subject to the Approval of the Engineer.



Scale: 1/2" = 1'-0"

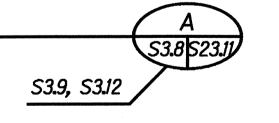

LICENSED PROFESSIONAL ENGINEER √\ NO. 8104-S

THIS WORK WAS PREPARED BY ME OR UNDER MY SUPERVISION.

STATE OF HAWAII
DEPARTMENT OF TRANSPORTATION HIGHWAYS DIVISION

KALAOA BRIDGE

CABLE RESTRAINER SECTIONS

HAWAII BELT ROAD
SEISMIC RETROFIT OF VARIOUS BRIDGES
VICINITY OF PAPAIKOU, HAWAII
Project No. BR-019-2(43) Scale: As Noted Date: August 12, 1999

SHEET No. S3.12 OF 59 SHEETS

Text for as-built posting

Squiggly line for as-built deletion

Double line for as-built deletion

LEGEND FOR AS-BUILT POSTINGS

 $\overline{}$

100.00

Roadway