



FOUNDATION PLAN

SCALE : 1"=10'


All finish elevations, stations and azimuths are approximate only. They are based on the original contract drawings dated March 1933. Contractor shall verify elevations, stations and azimuths as required.

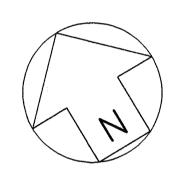

SCALE IN FEET

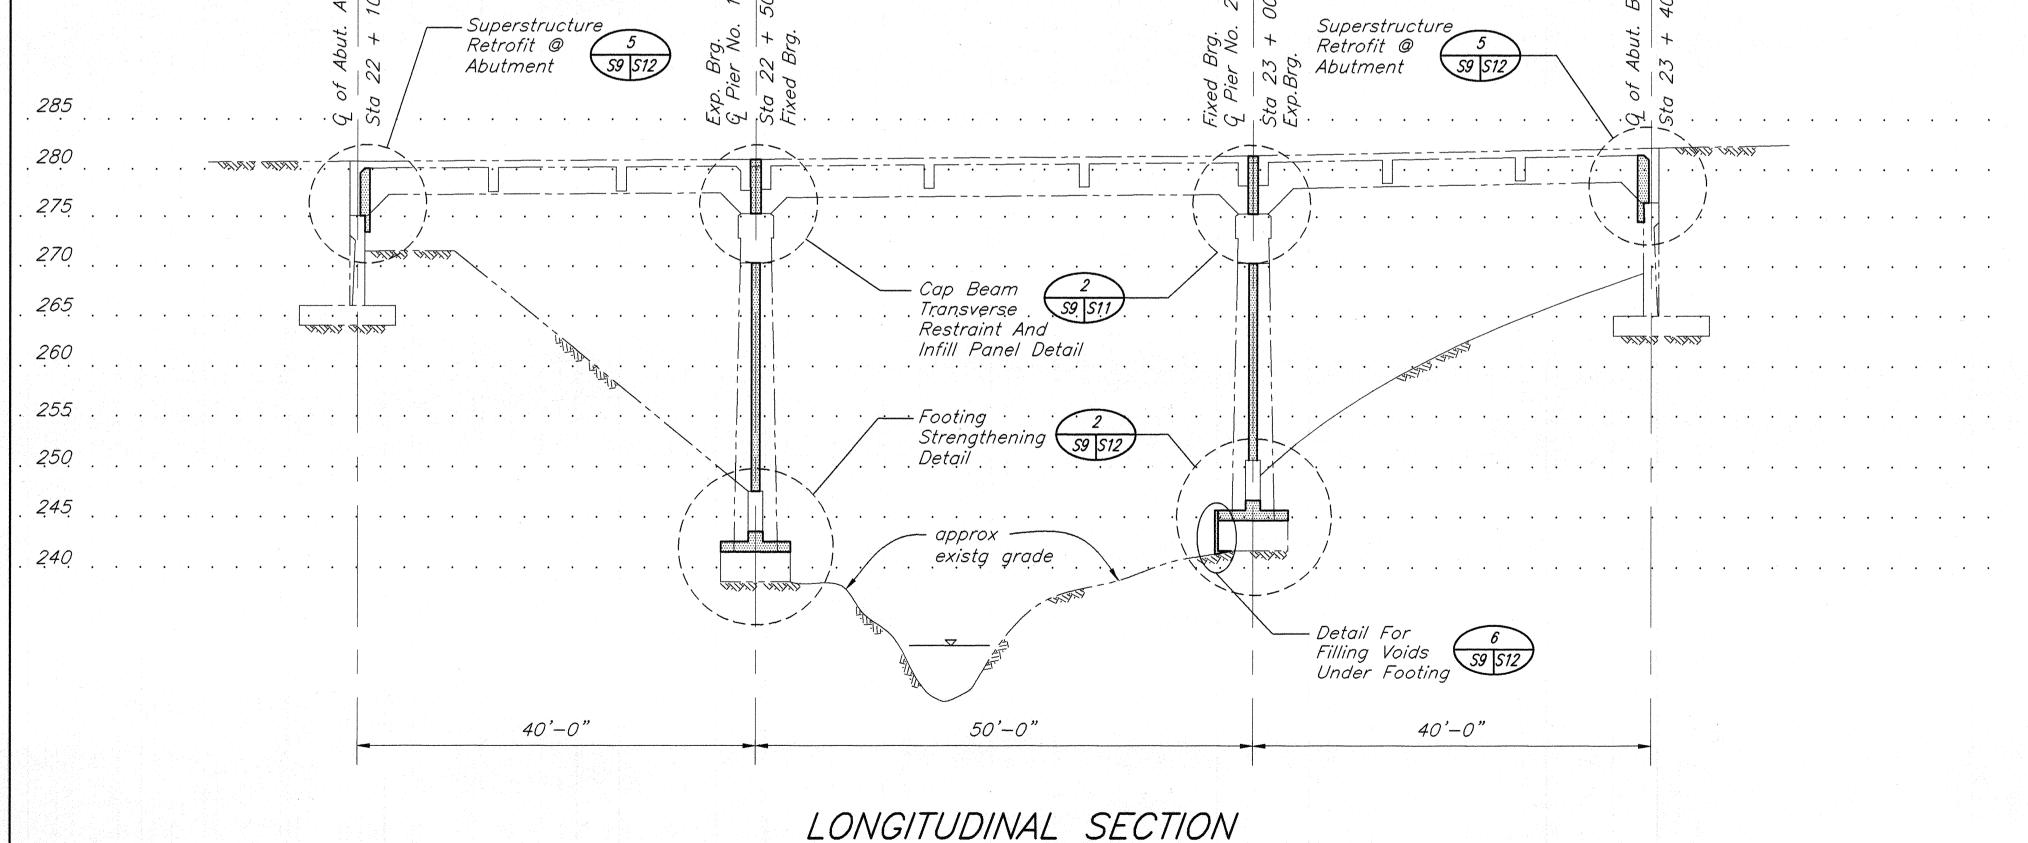

SCALE : 1"=10"

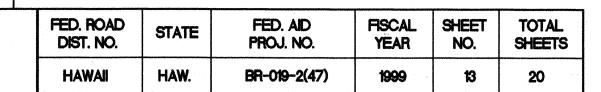

GENERAL:

- 1. The Existing Bridge Information Shown In This Drawings Was Obtained From The Original Bridge Drawings And Is Presented For Reference Purposes Only. No Responsibility Is Assumed For The Accuracy Of The Existing Information Presented. It Is The Contractor's Responsibility To Verify Independently All of The As-Built Information.
- 2. The Contractor Shall Visit The Construction Site And Shall Verify All Dimensions And Conditions Prior To Starting Any Work And Shall Be Responsible For Coordination Of All Work And Materials Including Those Furnished By Sub-Contractors. The Hawaii Department Of Transportation (D.O.T.) Representative Shall Be Notified Immediately Of Any Discrepancies Found
- 3. The Contract Structural Drawings And Specifications Represent The Finished Structure. They Do Not Indicate The Method Of Construction. The Contractor Shall Provide All Measures Necessary To Protect The Structure During Construction.
- 4. The Contractor Shall Provide Adequate Shoring For All Existing Adjacent Structures. Shoring For Construction Loads Shall Be Designed By a Hawaii Licensed Structural Engineer Experienced In This Kind Of Work.

BASIS FOR SEISMIC RETROFIT:

- 1. The Proposed Retrofit Work Addresses Two Apparent Weaknesses: A. The Possibility Of The Superstructure Sliding Transversely Off The Substructure During An Earthquake
- B. The Possibility Of The Superstructure Sliding Longitudinally At
- 2. The Goal Of The Proposed Retrofit Work Is To Reduce The Risk Of Collapse During An Earthquake And Not The Prevention Of All Structural And Non-Structural Damage.
- 3. The Earthquake Loading Considered Is The ARS Curve For 5% Damping At O Feet To 10 Feet By Caltrans With An Expected Maximum Acceleration At Bedrock Of A = 0.4g.
- 4. The Design Methodology Is Per The Bridge Memo To Designers By The California Department Of Transportation, December 31, 1995.

GENERAL NOTES:

- 1. General Specifications: Hawaii Department Of Transportation Standard Specification For Road, Bridge And Public Works Construction, 1994 Together With Special Provisions Prepared For This Contract.
- 2. Design Specifications: AASHTO, Standard Specifications For Highway Bridges, 16th Edition (1996)
- 3. Caltrans Memo To Designers 20-4.
- 4. Seismic Loading:

5. Concrete:

- A. Existing:
- Footings \dots for f(x) = 3,000 psi

6. Reinforcing Steel:

- A. Existing:
 All Reinforcing Steel (Assumed) fy = 44,000 psi
- All Bars, Dowels & Stirrups fy = 60,000 psi


LICENSED PROFESSIONAL **ENGINEER** No. 1399-S Wardfamments THIS WORK WAS PREPARED BY ME OR UNDER MY SUPERVISION

DEPARTMENT OF TRANSPORTATION


KAPEHU BRIDGE-FOUNDATION PLAN AND LONGITUDINAL SECTION

HAWAII BELT ROAD, SEISMIC RETROFIT OF VARIOUS BRIDGES,
WEST OF NINOLE
FEDERAL AID PROJECT NO. BR-019-2(47) SCALE: AS NOTED DATE: November 1998


SHEET No. S9 OF 16 SHEETS

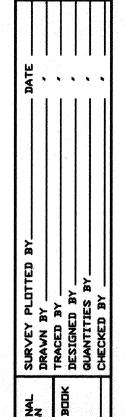



FED. ROAD DIST. NO.	STATE	FED. AID PROJ. NO.	FISCAL YEAR	SHEET NO.	TOTAL SHEETS
HAWAII	HAW.	BR-019-2(47)	1999	14	20

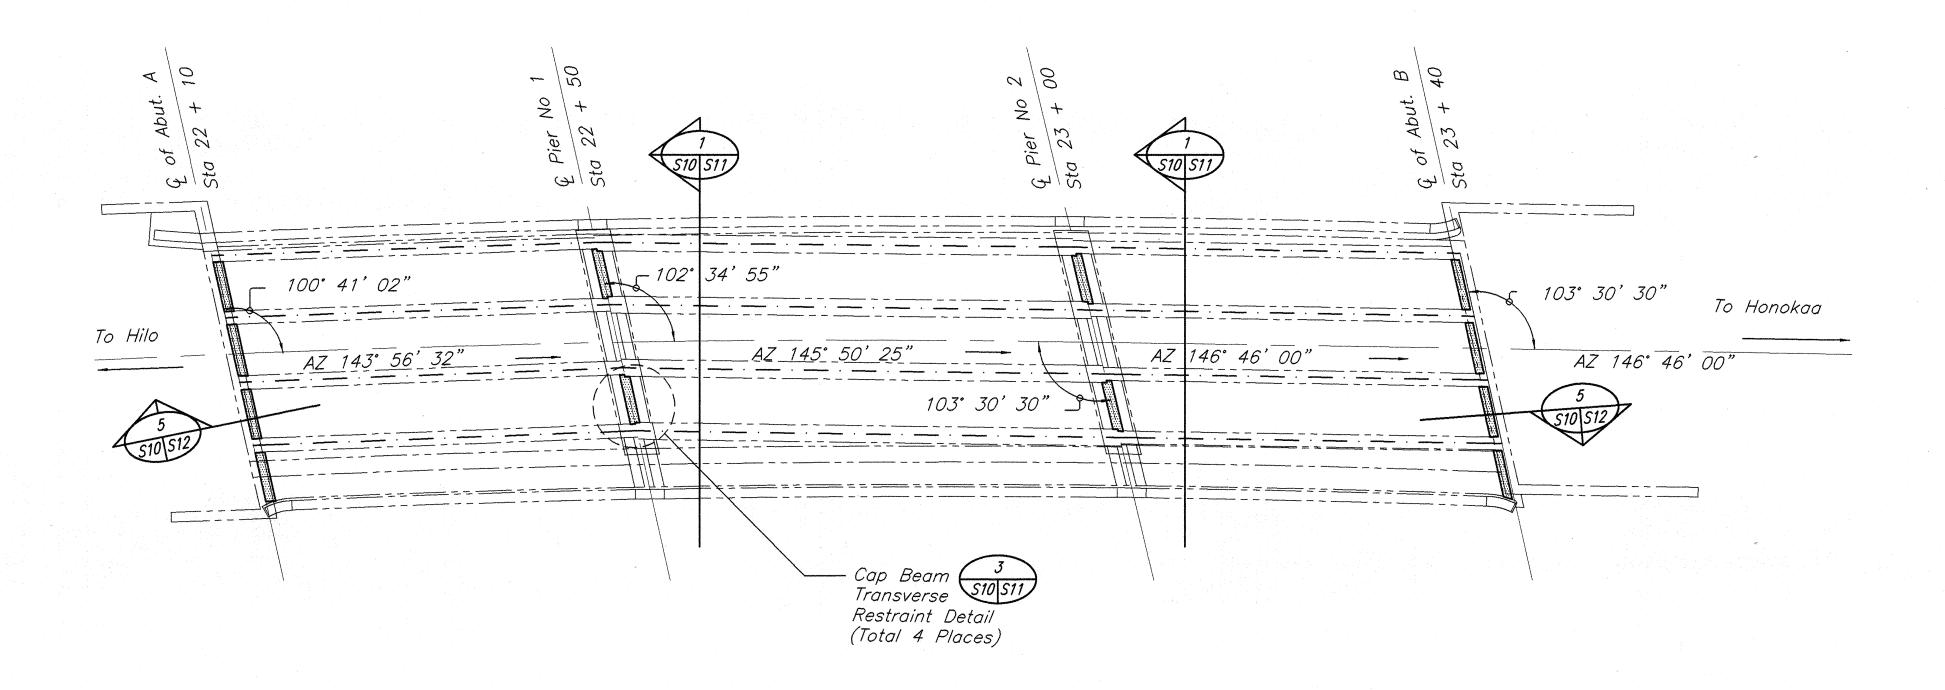


FRAMING PLAN SCALE : 1"=10'

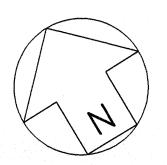

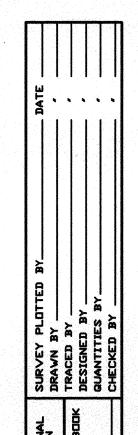

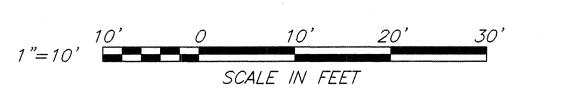

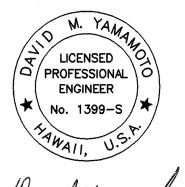

THIS WORK WAS PREPARED BY ME OR UNDER MY SUPERVISION

STATE OF HAWAI DEPARTMENT OF TRANSPORTATION HIGHWAYS DWISION

KAPEHU BRIDGE - FRAMING PLAN

HAWAII BELT ROAD, SEISMIC RETROFIT OF VARIOUS BRIDGES,

WEST OF NINOLE


FEDERAL AID PROJECT NO. BR-019-2(47)

SCALE: AS NOTED

DATE: November 1998

DATE: November 1998 SHEET No. S10 OF 16 SHEETS

14

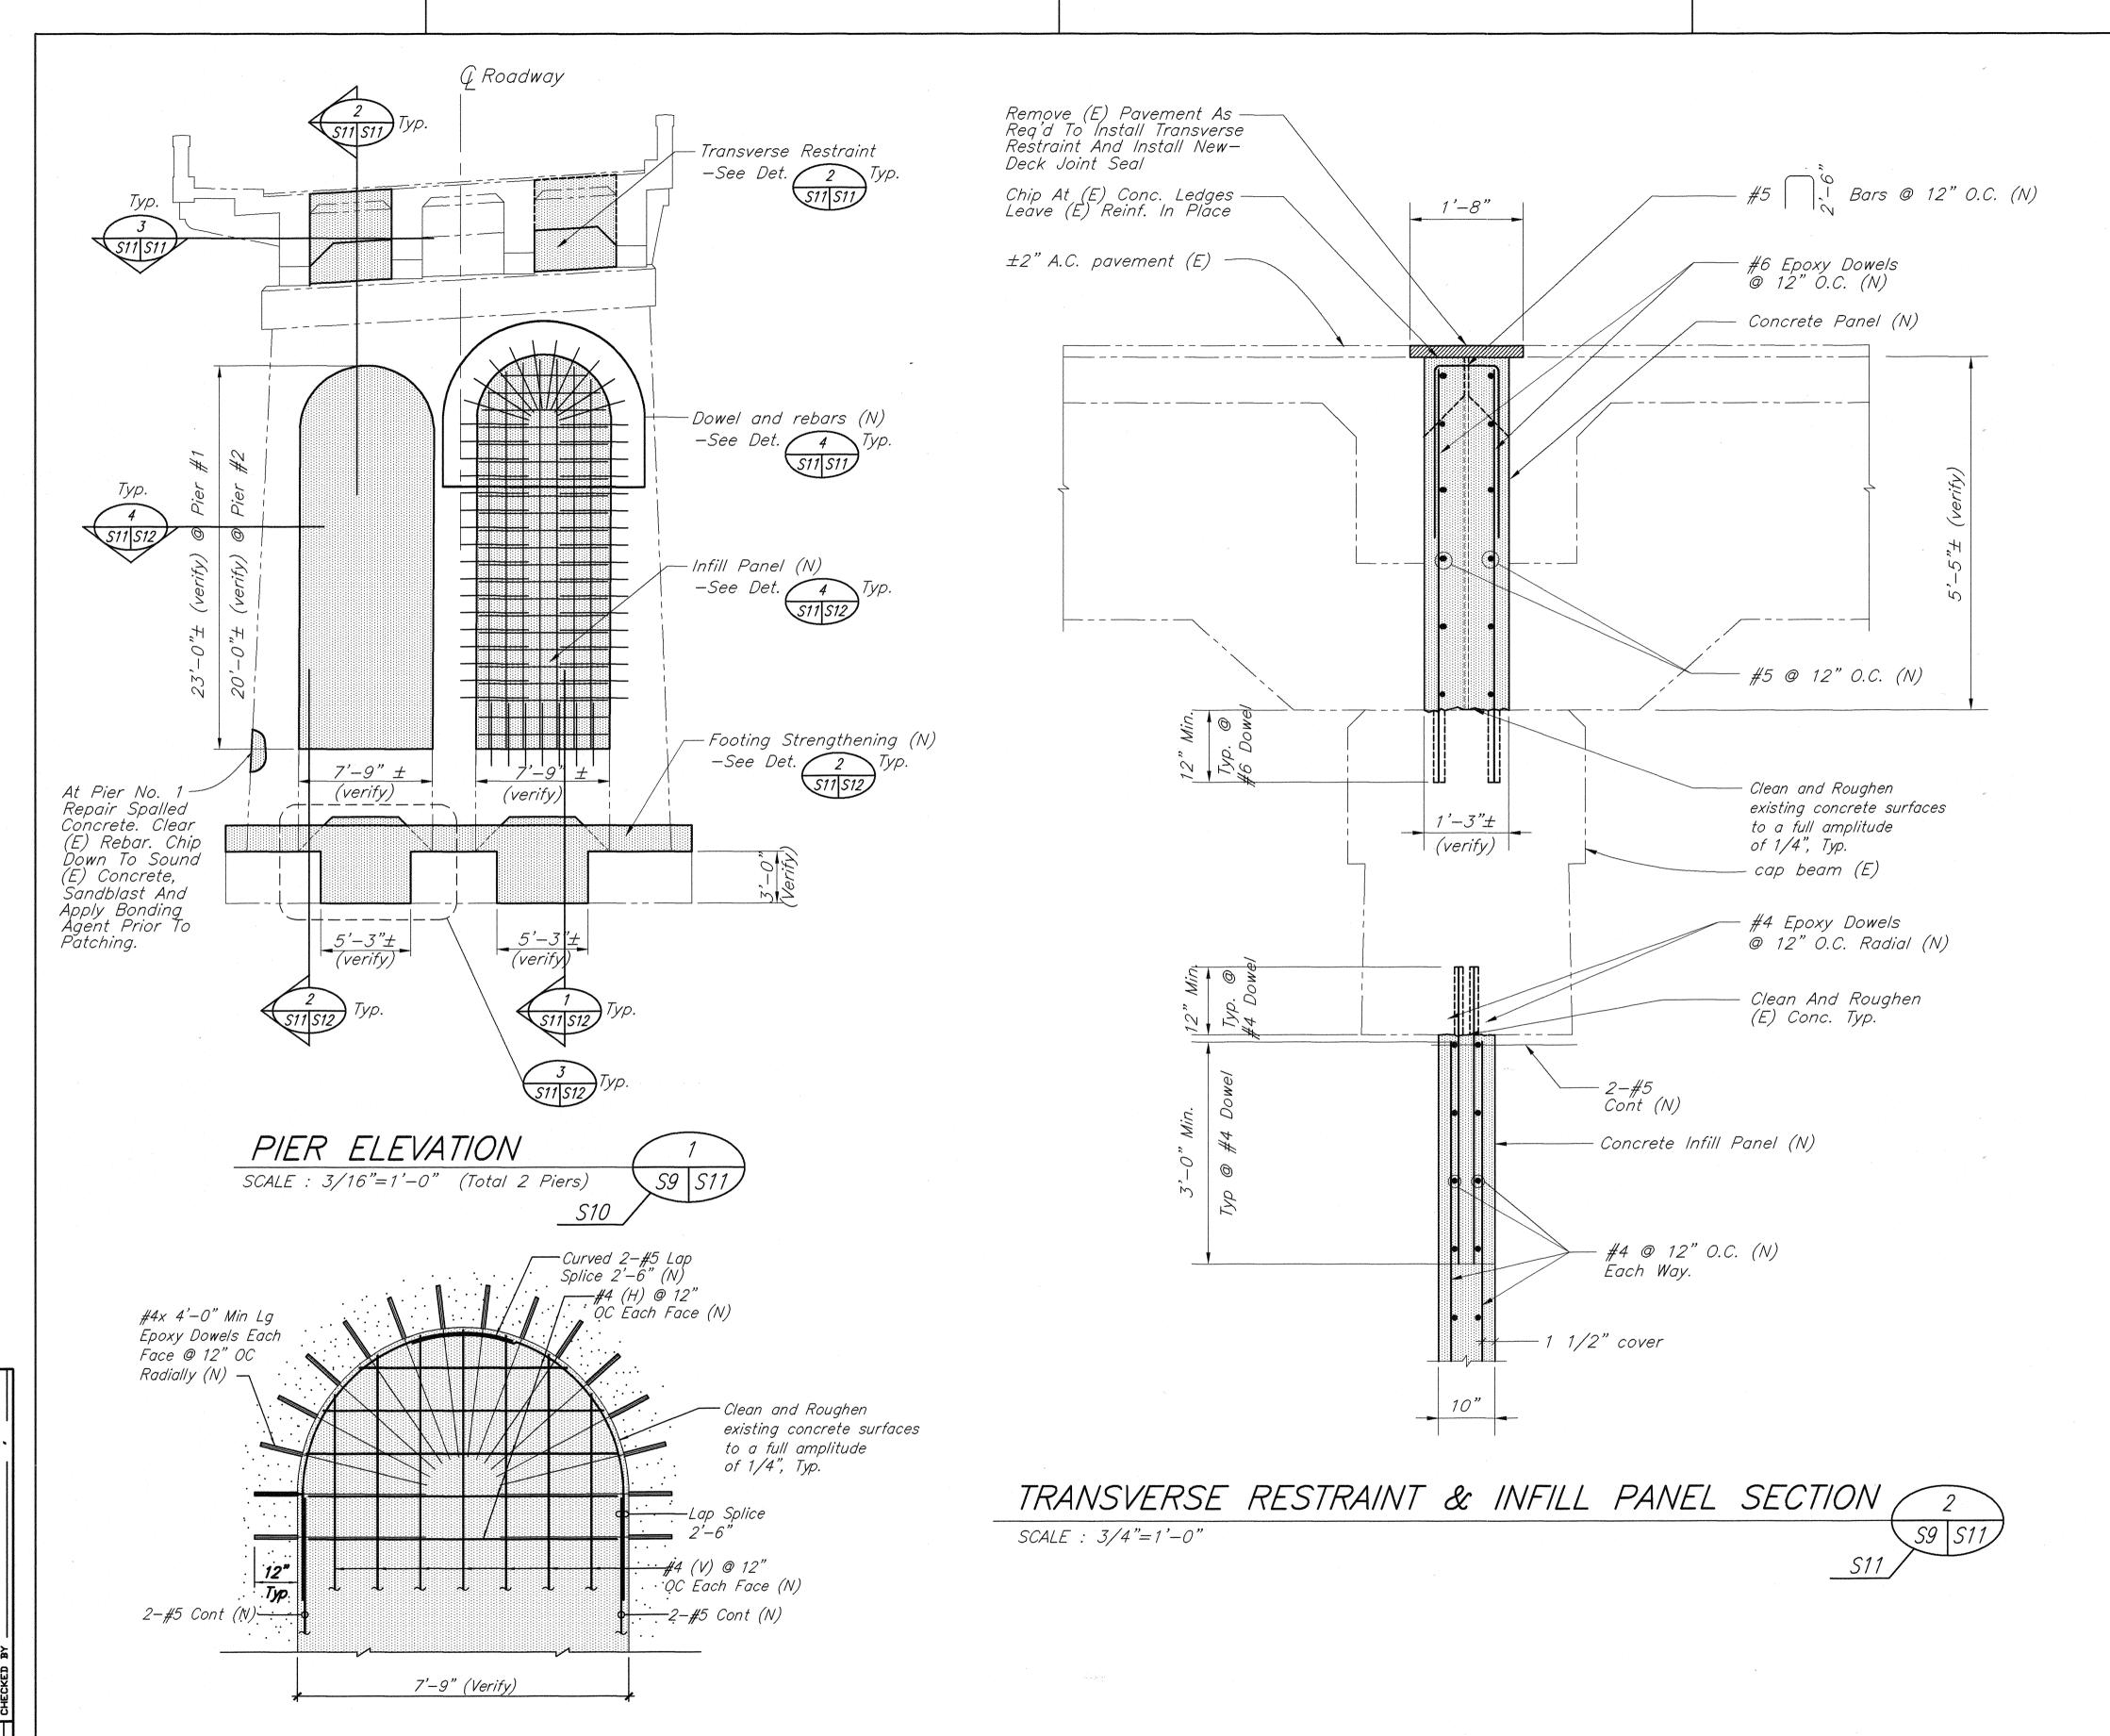


DOWELING / REINFORCING DETAIL /

SCALE : 1/2"=1'-0"


FED. ROAD DIST. NO. STATE PROJ. NO. FISCAL SHEET TOTAL SHEETS

HAWAII HAW. BR-019-2(47) 1999 15 20

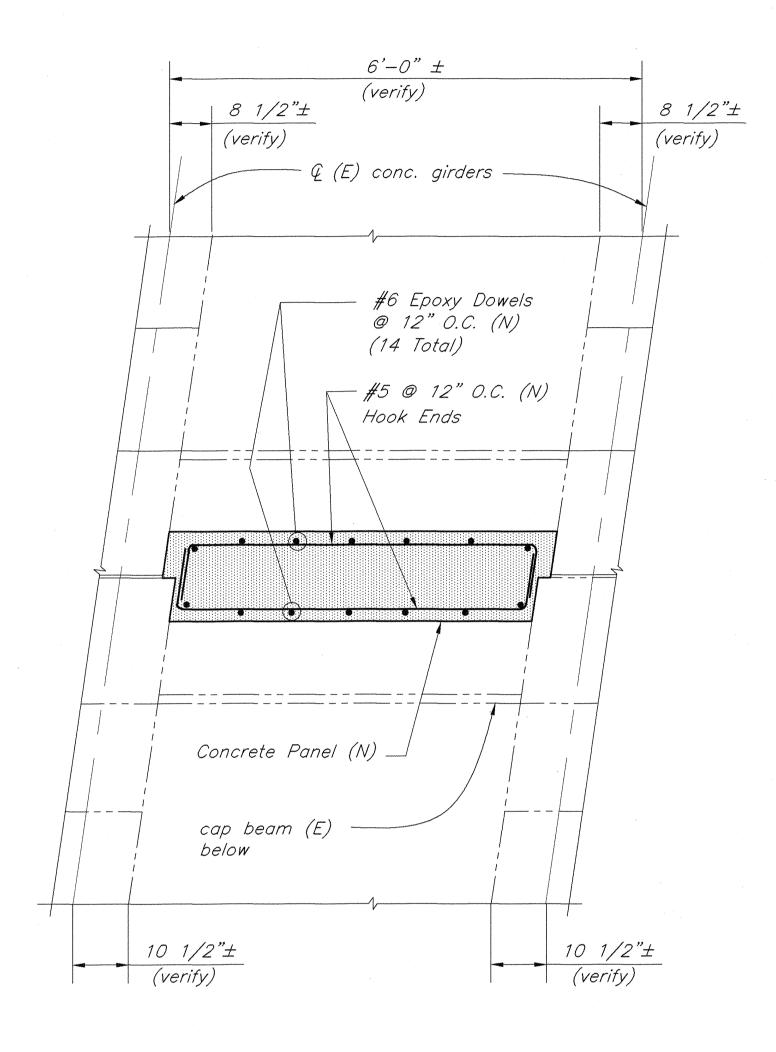

(N) = New(E) = Existing

TRANSVERSE RESTRAINT PLAN

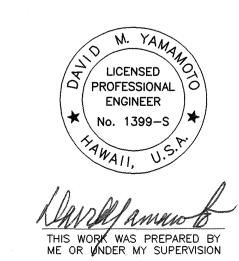

SCALE : 3/4"=1'-0"

STATE OF HAWAII
DEPARTMENT OF TRANSPORTATION
HIGHWAYS DIVISION

KAPEHU BRIDGE - PIER ELEVATION AND RETROFIT DETAILS

HAWAII BELT ROAD, SEISMIC RETROFIT OF VARIOUS BRIDGES,

WEST OF NINOLE

FEDERAL AID PROJECT NO. BR-019-2(47)

SCALE: AS NOTED

DATE: November 1998

SHEET No. Stil OF S16 SHEETS

15

