




FED. ROAD DIST. NO.	STATE	FED. AID PROJ. NO.	FISCAL YEAR	SHEET NO.	TOTAL SHEETS
HAWAII	HAWAII	HES-0100(20)	1986	34	67

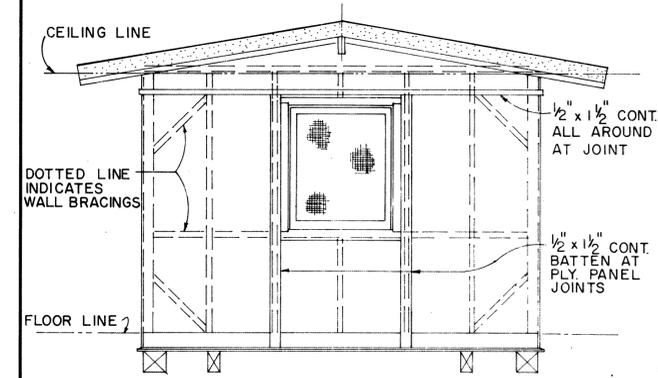


ELEVATION B
ELEVATION D SIMILAR
SCALE: 3/8" = 1'-0"

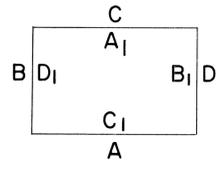


EXTERIOR & INTERIOR KEY

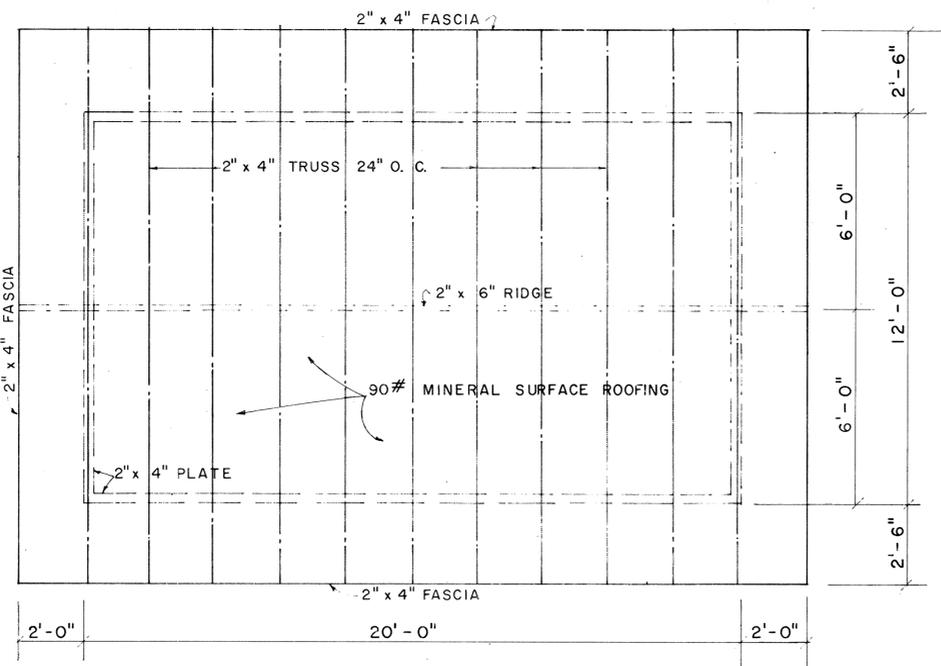


ROOF FRAMING PLAN
SCALE: 3/8" = 1'-0"

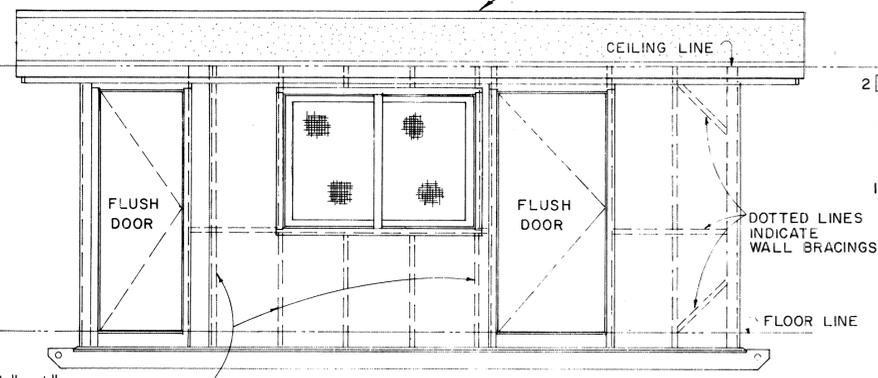


ELEVATION A
SCALE: 3/8" = 1'-0"

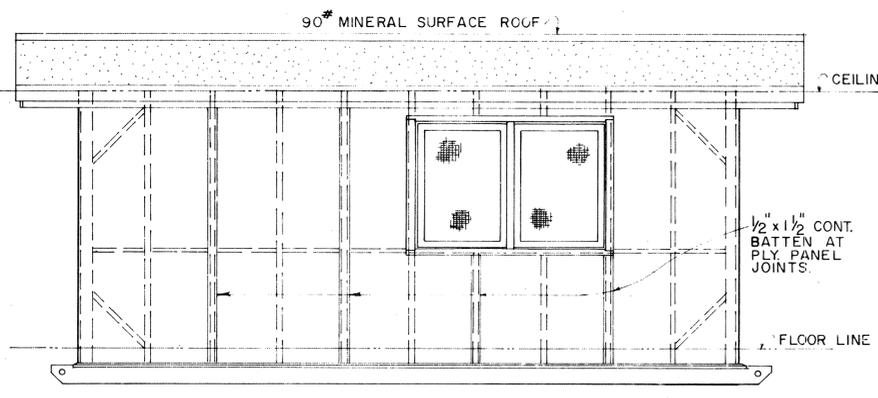


ELEVATION C
SCALE: 3/8" = 1'-0"

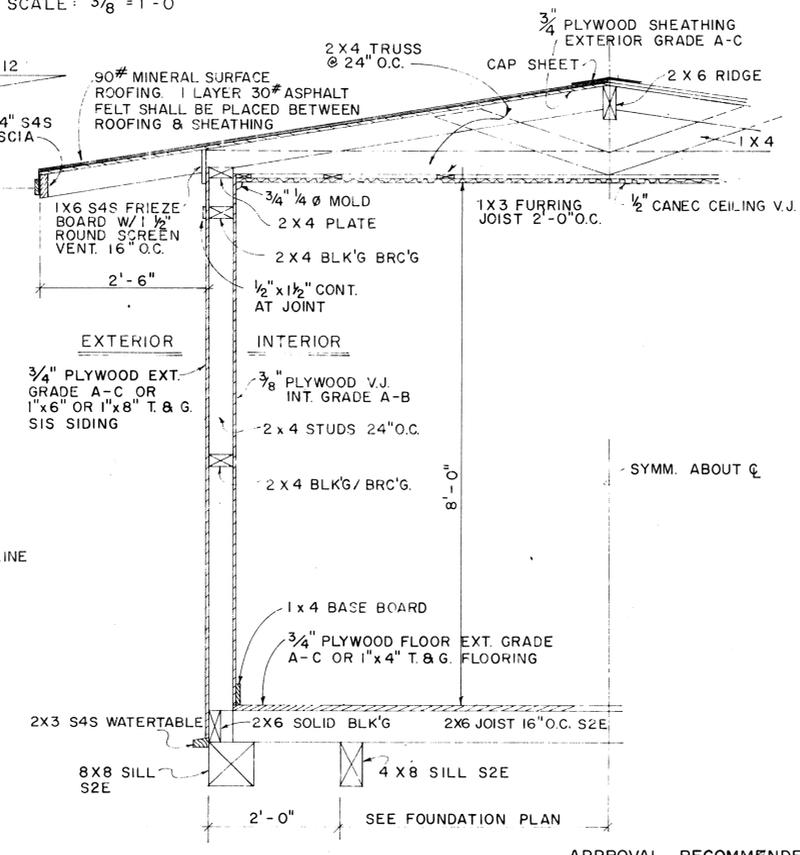

TYPICAL WALL SECTION
SCALE: 3/8" = 1'-0"

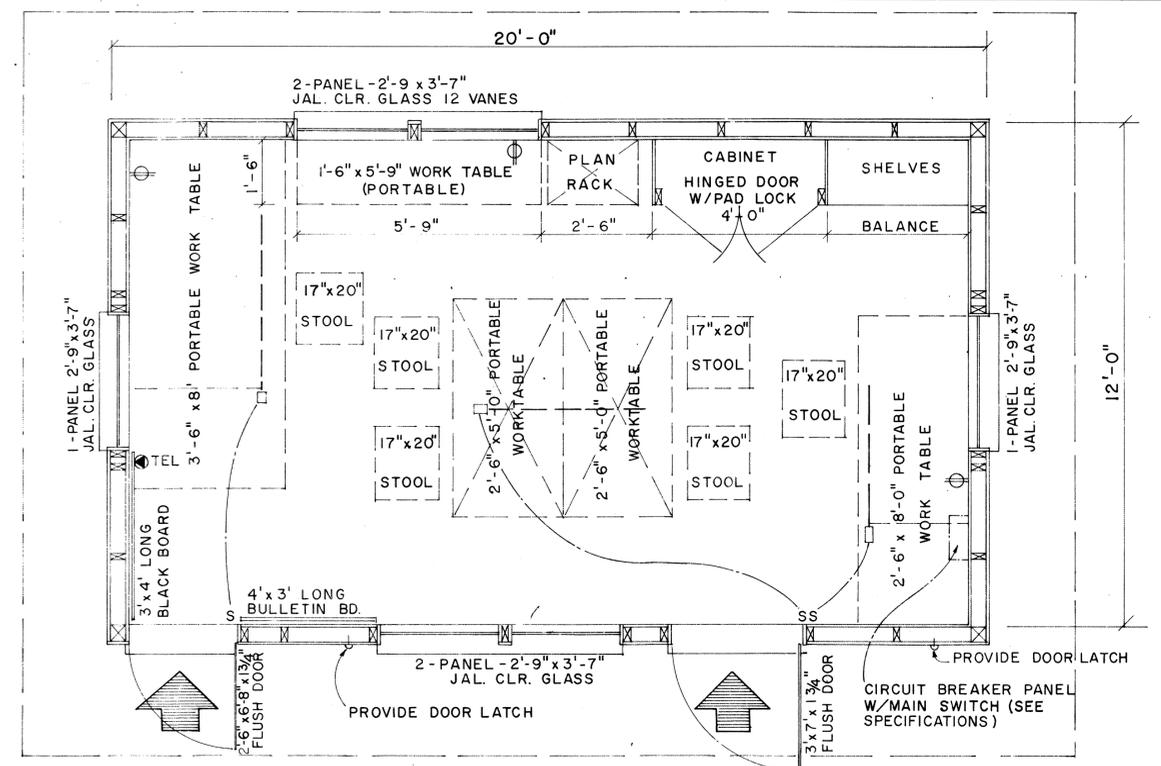

FLOOR PLAN
SCALE: 1/2" = 1'-0"

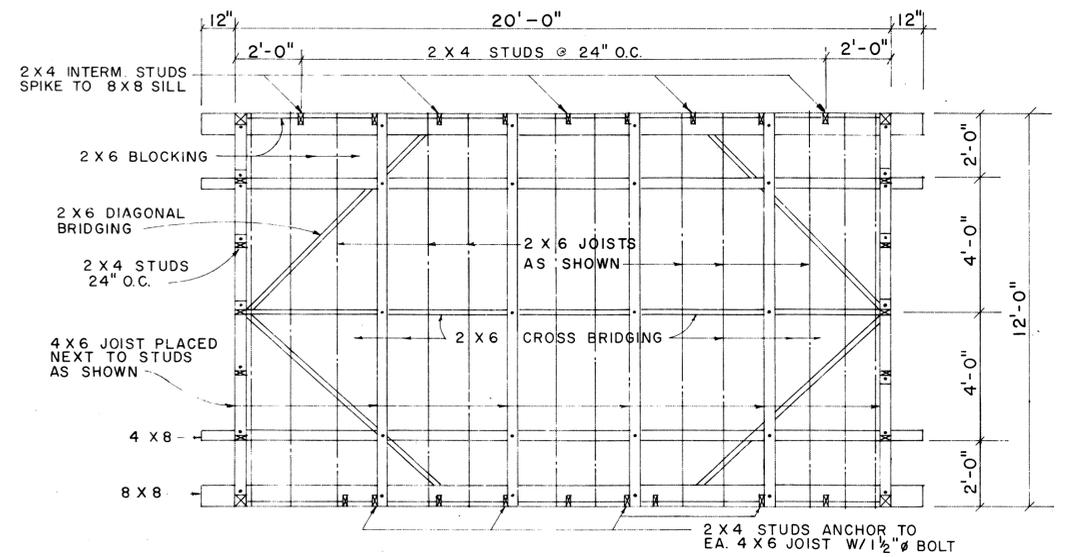

FOUNDATION FRAMING PLAN
SCALE: 3/8" = 1'-0"

SURVEY PLOTTED BY	DATE
DRAWN BY	
DESIGNED BY	
CHECKED BY	
NO.	

APPROVAL RECOMMENDED:
M. Hirozumi
 HIGHWAY DESIGN ENGINEER 12-4-69 DATE

APPROVED:
John P. ...
 ASSISTANT CHIEF, ENGINEERING 12-10-69 DATE

NO.	REVISION	APPROVED BY	DATE


STATE OF HAWAII
 DEPARTMENT OF TRANSPORTATION
 HIGHWAYS DIVISION

FIELD OFFICE


Scale: As Noted

SHEET NO. OF SHEETS DD 636.1


FED. ROAD DIST. NO.	STATE	FED. AID PROJ. NO.	FISCAL YEAR	SHEET NO.	TOTAL SHEETS
HAWAII	HAWAII	HES-0100(28)	1986	35	67

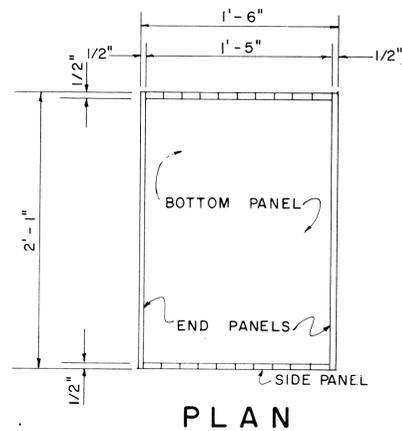

PLAN

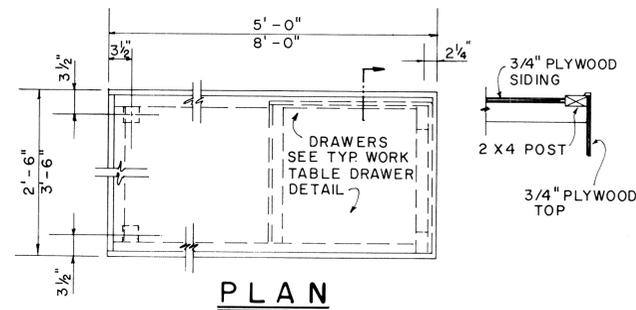

PLAN

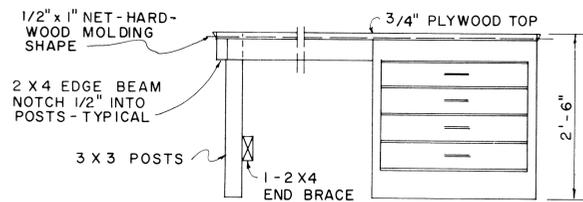


ELEVATION


2'-6" x 5'-0" 2 REQ'D
3'-6" x 8'-0" 1 REQ'D
2'-6" x 8'-0" 1 REQ'D

PORTABLE WORK TABLE DETAIL

SCALE: 3/4" = 1'-0"

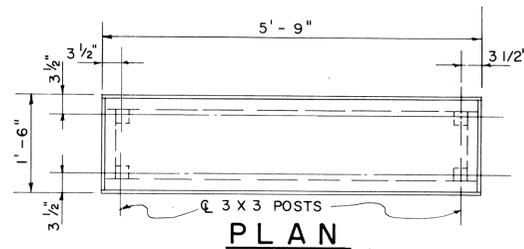


PLAN

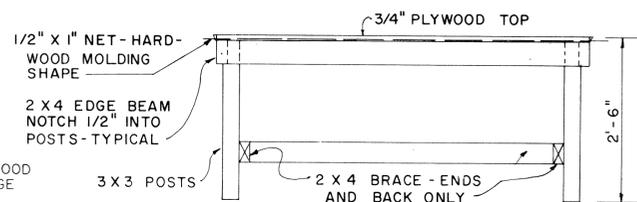

ELEVATION

1'-6" x 5'-9" PORTABLE WORK TABLE DETAIL

SCALE: 3/4" = 1'-0"

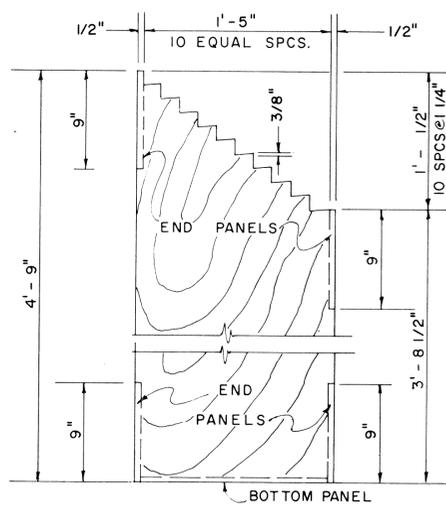


END ELEVATION

PLAN RACK DETAIL

SCALE: 1/2" = 1'-0"


(ONE REQUIRED)

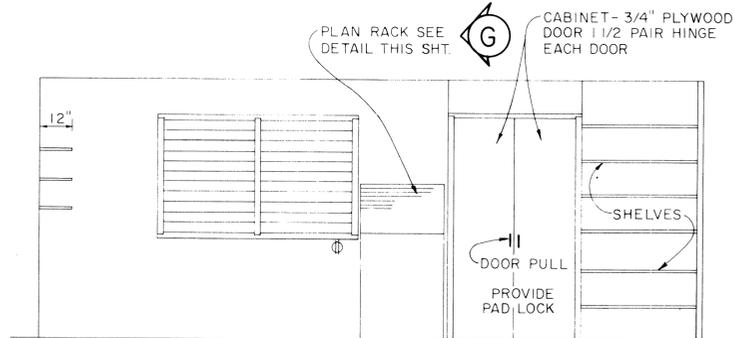

ELEVATION

(A1)

SCALE: 3/8" = 1'-0"

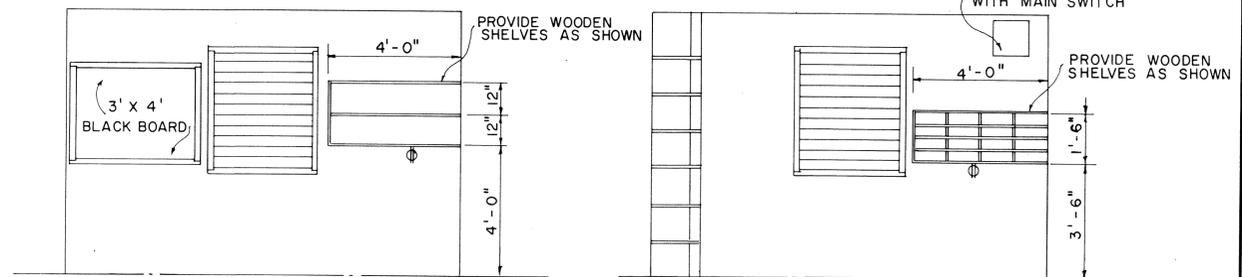

ELEVATION


SCALE: 3/8" = 1'-0"

(D1)

ELEVATION

SCALE: 3/8" = 1'-0"

(B1)

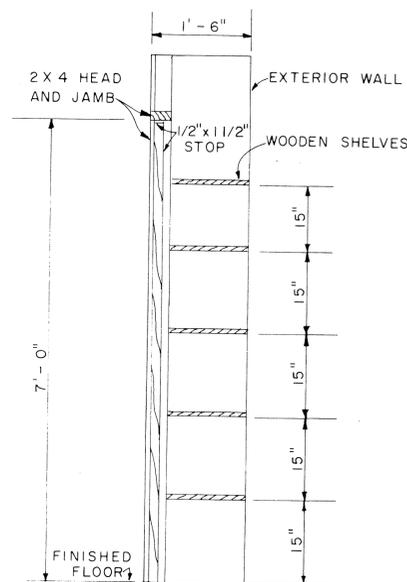

SECTION G

SCALE: 3/4" = 1'-0"

APPROVAL RECOMMENDED.
[Signature] 12-9-69
HIGHWAY DESIGN ENGINEER DATE

APPROVED
[Signature] 12-10-69
ASSISTANT CHIEF, ENGINEERING DATE

NO.	REVISION	APPROVED BY	DATE


STATE OF HAWAII
DEPARTMENT OF TRANSPORTATION
HIGHWAYS DIVISION

FIELD OFFICE


Scale: As Noted

DATE: _____
SURVEY PLATTED BY: _____
DRAWN BY: _____
CHECKED BY: _____
NO. _____


FED. ROAD DIST. NO.	STATE	FED. AID PROJ. NO.	FISCAL YEAR	SHEET NO.	TOTAL SHEETS
HAWAII	HAW.	HS-0100(28)	1986	36	67

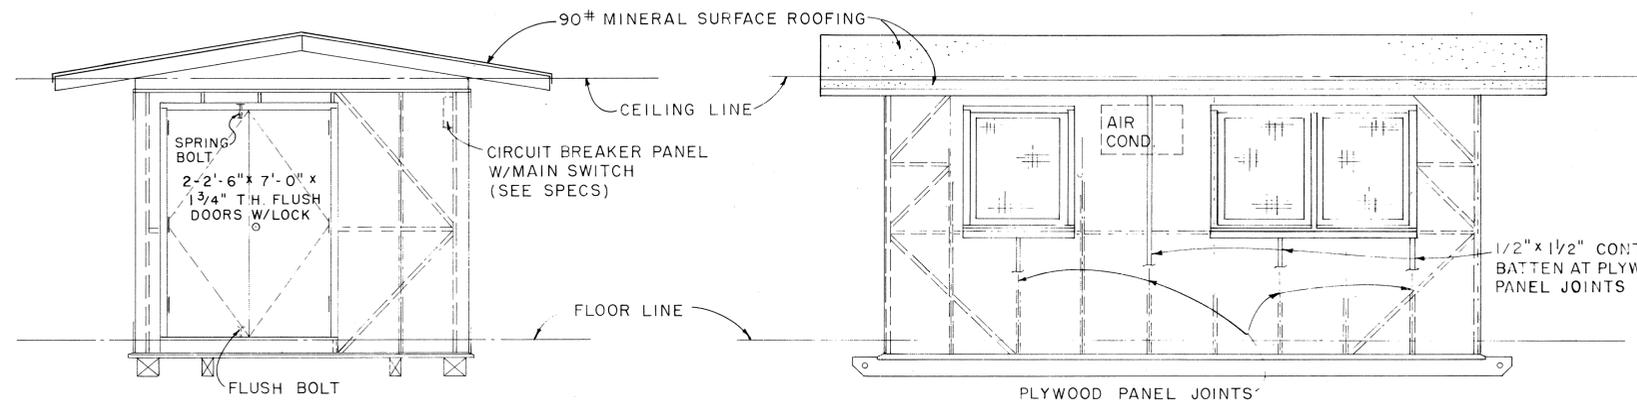

ELEVATION A
SCALE: 3/8" = 1'-0"

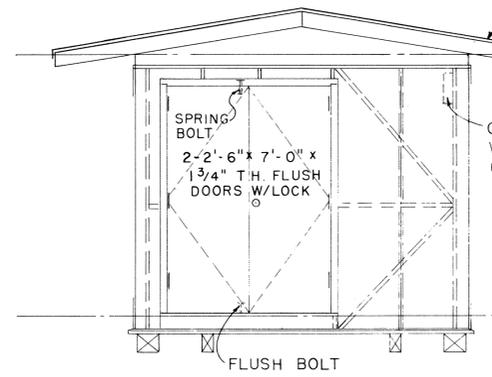


ELEVATION B
SCALE: 3/8" = 1'-0"

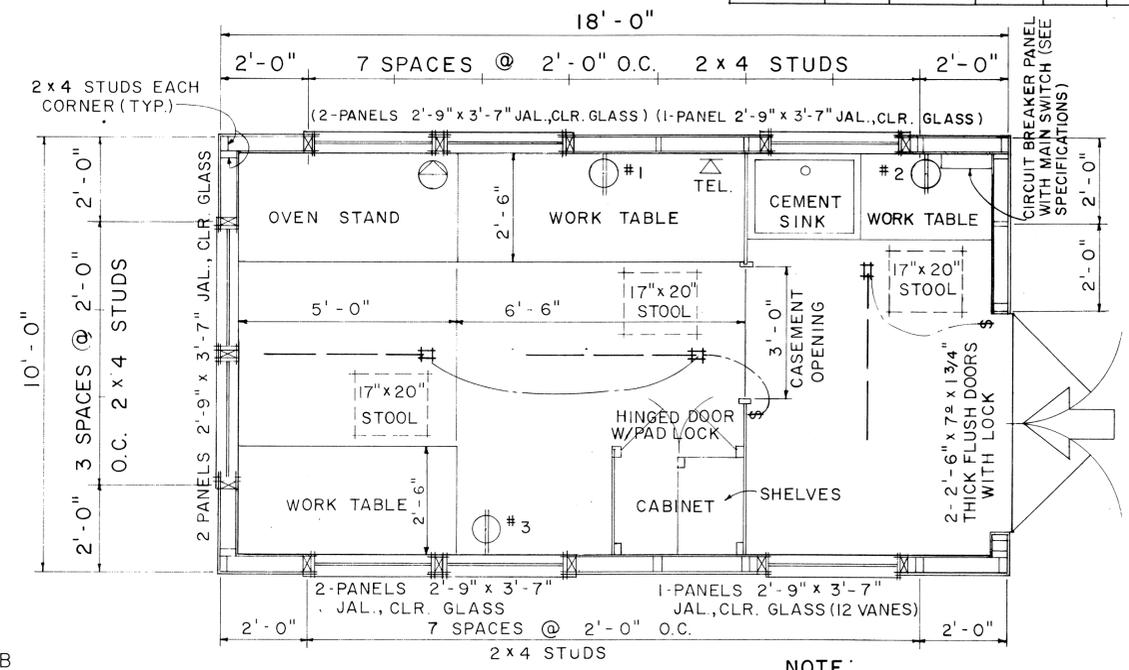


FLOOR PLAN
SCALE: 1/2" = 1'-0"

- NOTE:**
1. FLUORESCENT FIXTURE SHALL BE 48", 2 LAMP, 40 WATT, RAPID START.
 2. TELEPHONE AND WALL OUTLET 4'-0" ABOVE FLOOR.

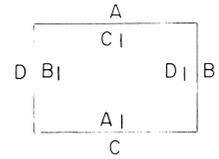


EXTERIOR & INTERIOR KEY

1-LAYER 30# ASPHALT FELT SHALL BE PLACED BETWEEN ROOFING AND SHEATHING.

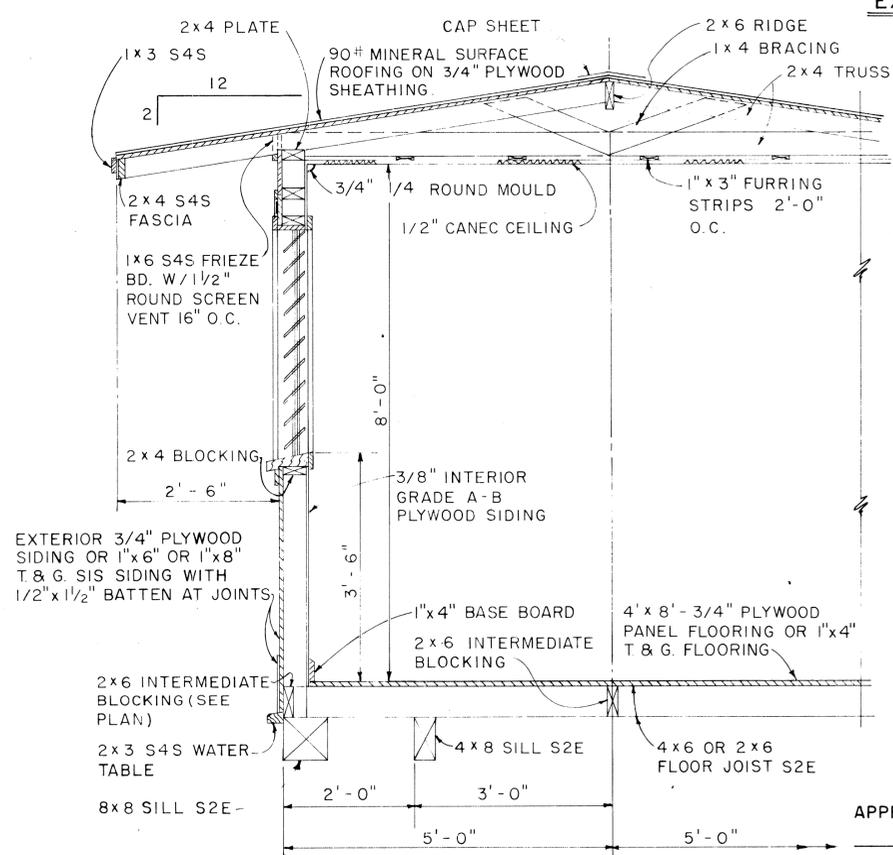

TYPICAL SECTION
SCALE: 3/4" = 1'-0"

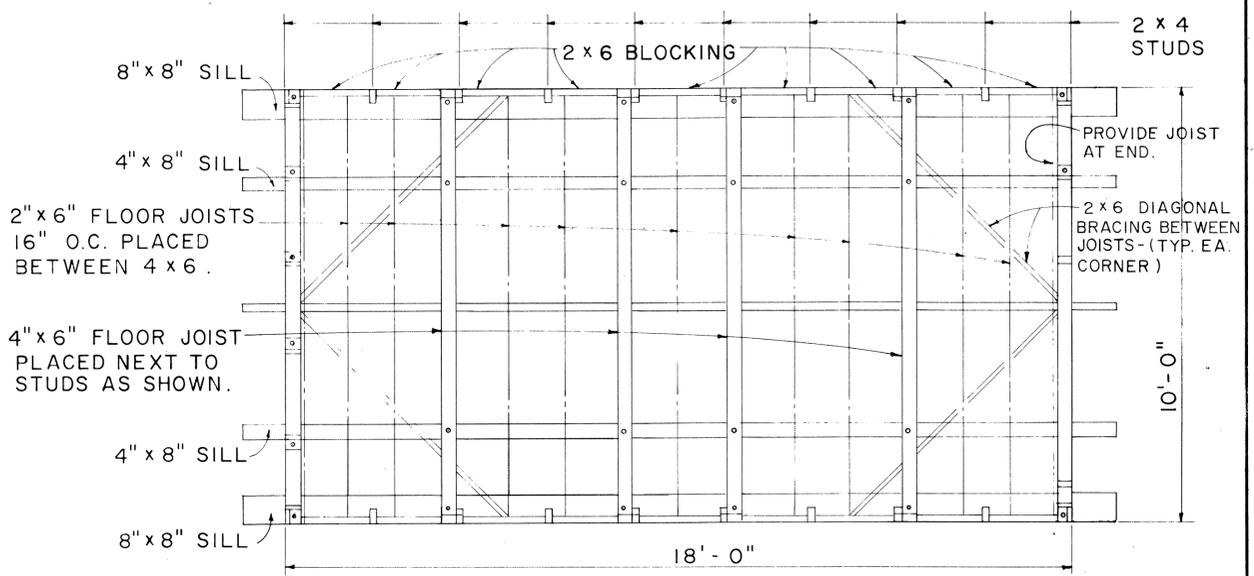

FLOOR FRAMING PLAN
SCALE: 1/2" = 1'-0"

APPROVAL RECOMMENDED:
[Signature]
HIGHWAY DESIGN ENGINEER
DATE: 12-4-69

APPROVED:
[Signature]
ASSISTANT CHIEF, ENGINEERING
DATE: 12-10-69

NO.	REVISION	APPROVED BY	DATE

STATE OF HAWAII
DEPARTMENT OF TRANSPORTATION
HIGHWAYS DIVISION







PROJECT SITE LABORATORY

Scale: As Noted

NOTE:
ALL 3/4" PLYWOOD SHALL BE EXTERIOR GRADE A-C OR BETTER.

DATE: _____
SURVEY PLOTTED BY: _____
DRAWN BY: _____
DESIGNED BY: _____
CHECKED BY: _____
ORIGINAL PLAN: _____
NOTE BOOK: _____
No. _____

FED. ROAD DIST. NO.	STATE	FED. AID PROJ. NO.	FISCAL YEAR	SHEET NO.	TOTAL SHEETS
HAWAII	HAW.	HE5-0100(20)	1986	37	67

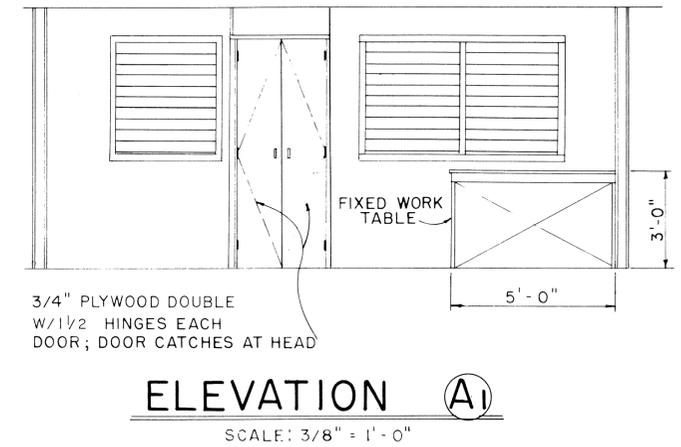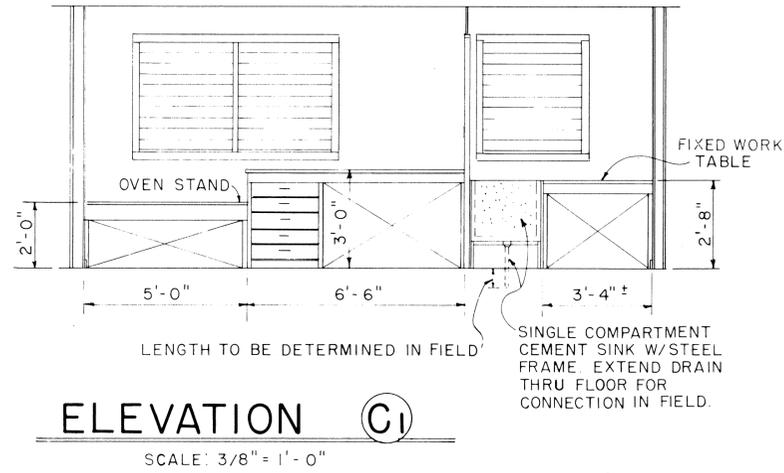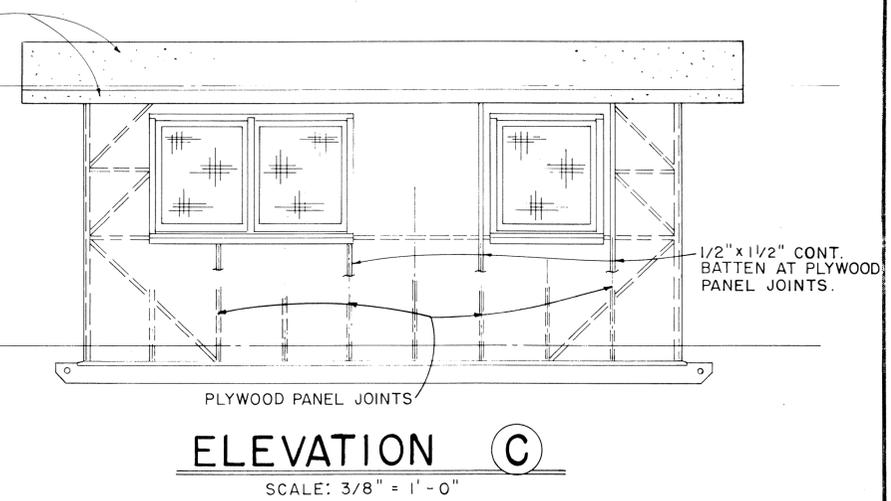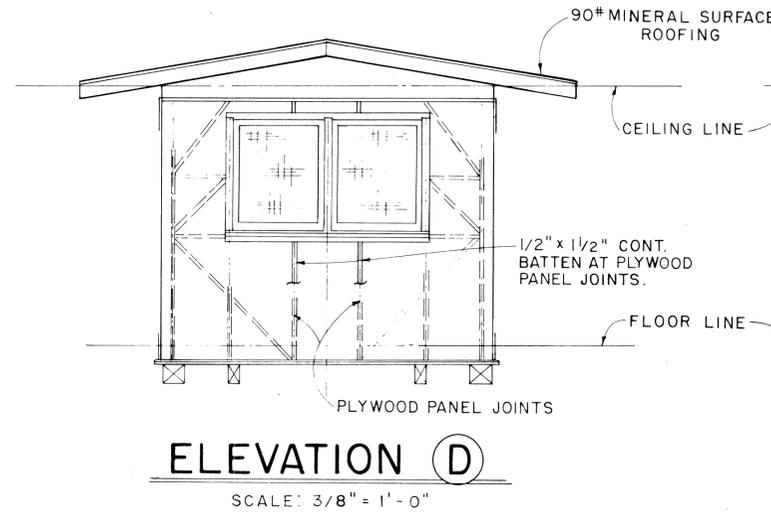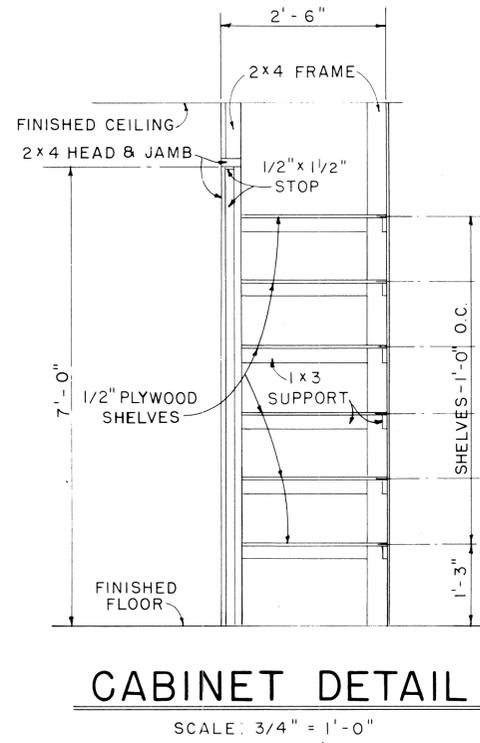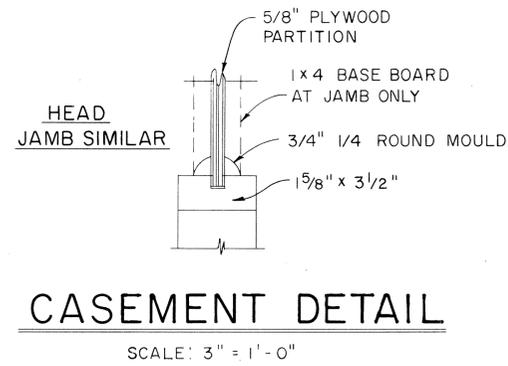

ORIGINAL PLAN
NO. _____
SURVEY PLOTTED BY _____
DRAWN BY _____
DESIGNED BY _____
QUANTITIES BY _____
CHECKED BY _____
DATE _____

APPROVAL RECOMMENDED:
[Signature] 12-4-69
HIGHWAY DESIGN ENGINEER DATE

APPROVED:
[Signature] 12-10-69
ASSISTANT CHIEF, ENGINEERING DATE


NO.	REVISION	APPROVED BY	DATE

STATE OF HAWAII
DEPARTMENT OF TRANSPORTATION
HIGHWAYS DIVISION

PROJECT SITE LABORATORY


Scale: As Noted

FED. ROAD DIST. NO.	STATE	FED. AID PROJ. NO.	FISCAL YEAR	SHEET NO.	TOTAL SHEETS
HAWAII	HAWAII	HES-0100(28)	1986	38	67

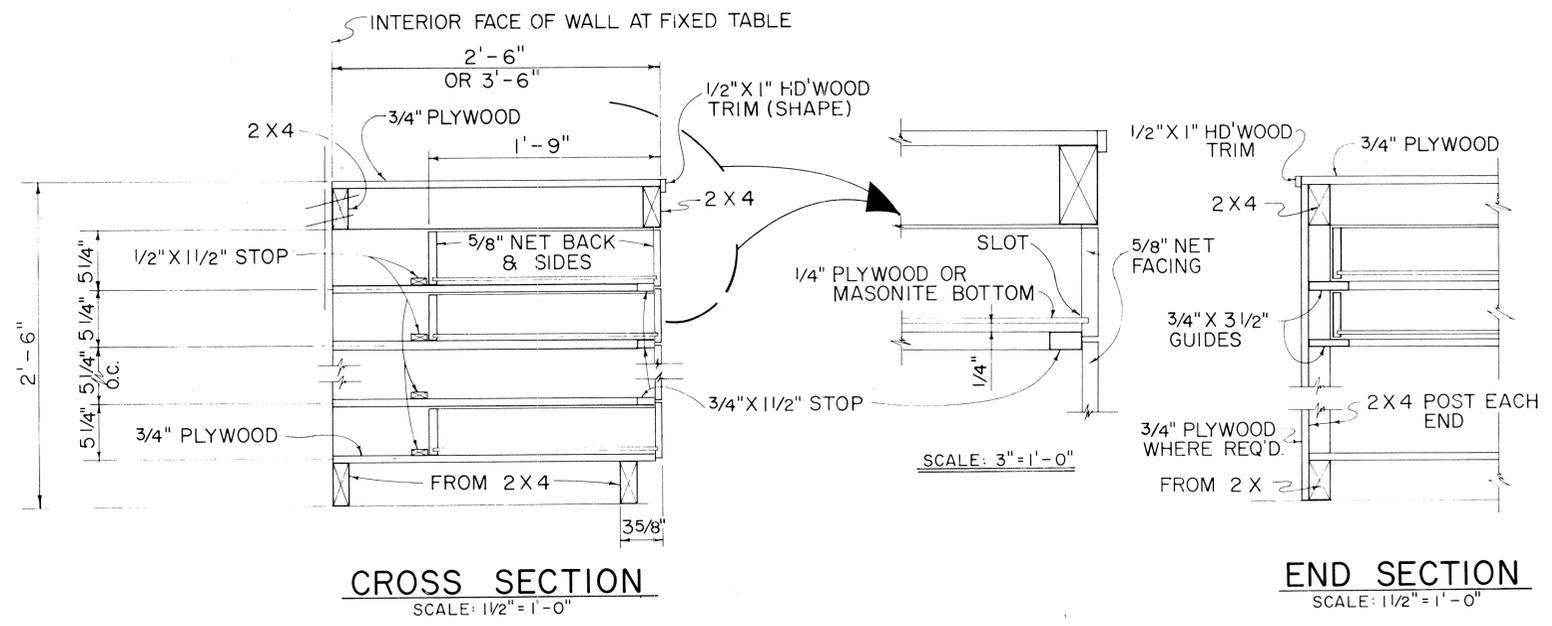


CROSS SECTION SCALE: 1/2" = 1'-0"
END SECTION SCALE: 1/2" = 1'-0"

TYPICAL WORK TABLE DRAWER DETAIL

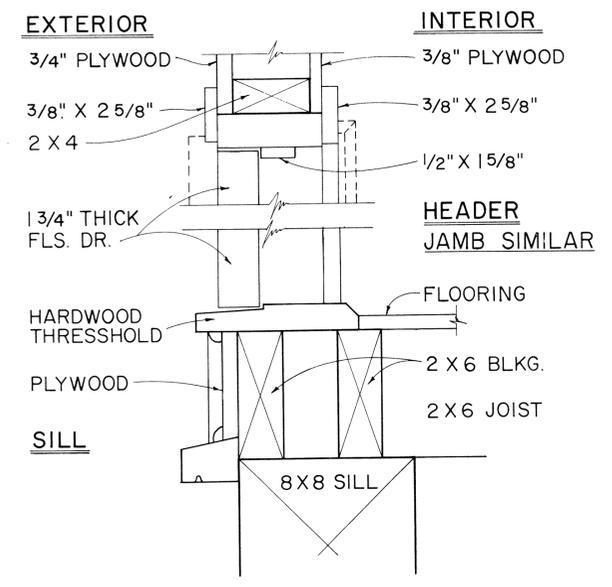


TYP. SWING OUT DOOR
TYPICAL SINGLE OR DOUBLE EXTERIOR DOOR DETAIL

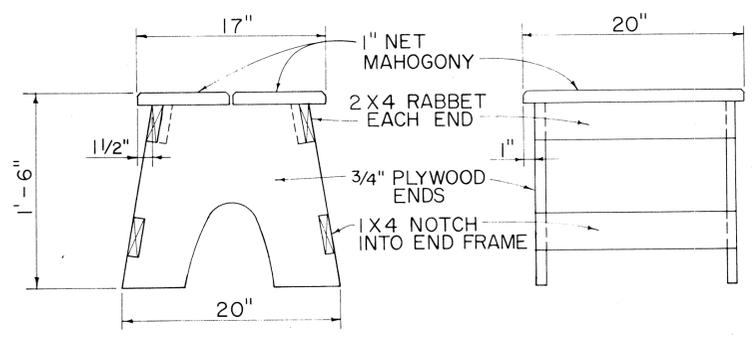

TYPICAL STOOL DETAIL SCALE: 1/2" = 1'-0"


NOTE: CONTRACTOR MAY WITH THE APPROVAL OF THE ENGINEER FURNISH THE FIELD OFFICE OR PROJECT SITE LABORATORY WITH STOOLS OTHER THAN THE TYPE SHOWN IN THE DETAIL.

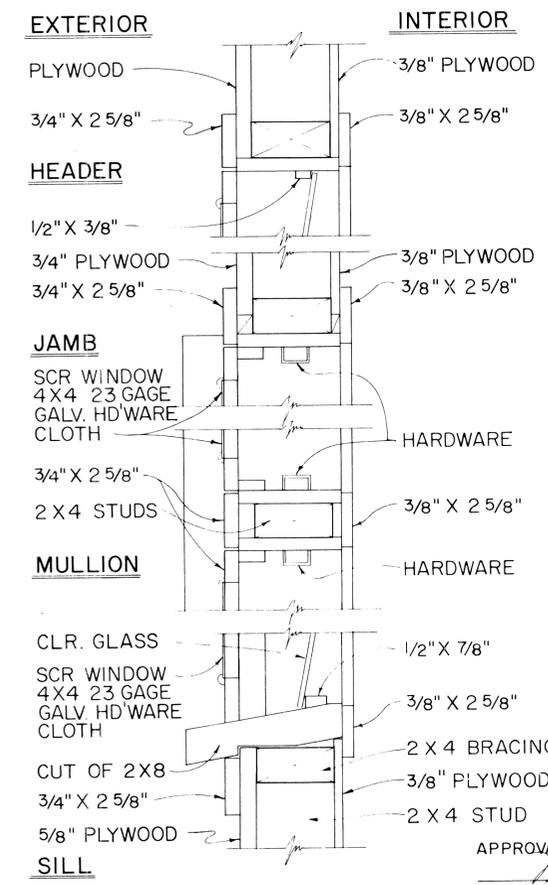

TYPICAL DETAIL JALOUSIES WINDOWS SCALE: 3" = 1'-0"

APPROVAL RECOMMENDED:
M. Hironaka 12-4-69
HIGHWAY DESIGN ENGINEER DATE

APPROVED:
John S. Saha 12-10-69
ASSISTANT CHIEF, ENGINEERING DATE

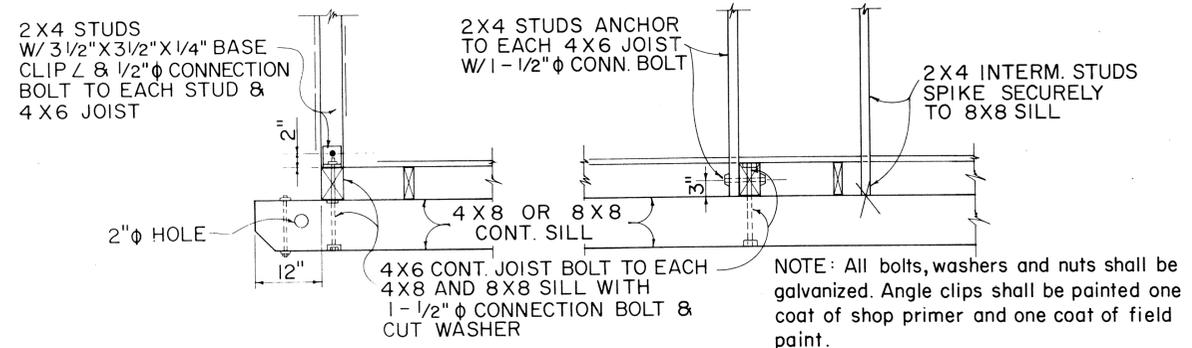

TYPICAL 2X4 STUD & 4X6 FLOOR JOIST BASE CONNECTION DETAILS
AT ENDS OF BLDG. ALONG SIDES OF BLDG.

NO.	REVISION	APPROVED BY	DATE

STATE OF HAWAII
DEPARTMENT OF TRANSPORTATION
HIGHWAYS DIVISION

FIELD OFFICE
&
PROJECT SITE LABORATORY

Scale: As Noted

DATE: _____
DRAWN BY: _____
CHECKED BY: _____
DESIGNED BY: _____
NOTED BY: _____
No. _____

FED. ROAD DIST. NO.	STATE	FED. AID PROJ. NO.	FISCAL YEAR	SHEET NO.	TOTAL SHEETS
HAWAII	HAW.	HES-0100(28)	1986	39	67

A or A ₁	C	C ₁
36"	6"	-
48"	9"	19"
60"	12"	24"

NOTE: Frame stiffeners are required when D is greater than 24". See Gen. Note 4.

GENERAL NOTES

- Sign posts and base posts shall be flanged channel type structural steel conforming to ASTM A 499 and galvanized in accordance with ASTM A 123.
NOMINAL DIMENSIONS:
2.50 lbs./ft. - 3.125" x 1.562"
4.00 lbs./ft. - 3.500" x 1.750"
- Retainer - Spacer Strap shall be AISI 1020 steel and galvanized in accordance with ASTM A 123.
- Retainer and Connector Bolts shall be 5/16 - 18 UNC x 1.75" long hex. head, integral flange conforming to ASTM A 354 Grade BC. Nuts shall be 5/16 - 18 UNC hex. head, integral flange conforming to ASTM A 563 Grade D. All bolts and nuts shall be cadmium plated per Federal spec. QQP 416 B, Class 2, Type 2.
- All accessories, fittings and stiffener details (as required) shall be submitted to Engineer for approval 20 days prior to installation.
- For additional details see sht. DT 100.
- Basic formulas for use with the windload charts:
Factor = A x B x H
Therefore, if sign area (A x B) is known,
Maximum H = $\frac{\text{Factor}}{\text{sign area (A x B)}}$
and if H is known,
Maximum sign area (A x B) = $\frac{\text{Factor}}{H}$

APPROVAL RECOMMENDED:

Eichi Tanaka 9/21/82
TRAFFIC ENGINEER DATE


APPROVED:

ASSISTANT CHIEF, ENGINEERING DATE

STATE OF HAWAII
DEPARTMENT OF TRANSPORTATION
HIGHWAYS DIVISION

STANDARD DETAILS
GALVANIZED FLANGED CHANNEL
SIGN POST MOUNTING

Scale: As Shown Date: Sept. 1982
SHEET No. OF SHEETS DT 100A

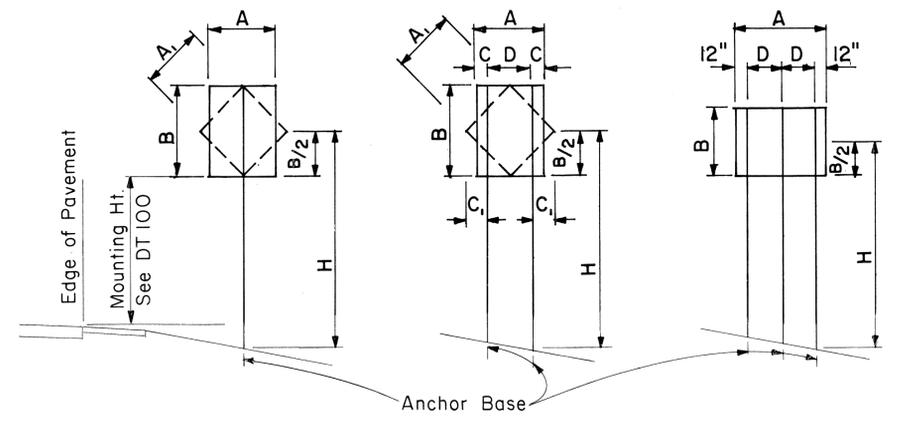

1-POST Sign area 10 sq. ft. and less
2-POST Sign area greater than 10 sq. ft. or A = 48" - 60"
3-POST A = greater than 60"

TYPICAL INSTALLATION
Not to Scale

FLANGED CHANNEL: 1-POST INSTALLATION

Post Size	A x B x H (Factor)	H = Ground Level to Midpoint (ft.)						A x B (Area, sq. ft.)
		7	8	9	10	11	12	
2.50 lbs./ft.	57	8.14	7.13	6.33	5.70	5.18	4.75	A x B (Area, sq. ft.)
4.00 lbs./ft.	112	-	-	-	-	-	9.33	

FLANGED CHANNEL: 2-POST INSTALLATION


Post Size	A x B x H (Factor)	H = Ground Level to Midpoint (ft.)						A x B (Area, sq. ft.)
		7	8	9	10	11	12	
2.50 lbs./ft.	124	17.71	15.50	13.77	12.40	11.27	10.33	A x B (Area, sq. ft.)
4.00 lbs./ft.	241	34.43	30.13	26.78	24.10	21.91	20.08	

FLANGED CHANNEL: 3-POST INSTALLATION


Post Size	A x B x H (Factor)	H = Ground Level to Midpoint (ft.)						A x B (Area, sq. ft.)
		7	8	9	10	11	12	
2.50 lbs./ft.	187	26.71	23.38	20.78	18.70	17.00	15.58	A x B (Area, sq. ft.)
4.00 lbs./ft.	362	51.71	45.25	40.22	36.20	32.91	30.17	

WINDLOAD CHARTS

NO.	REVISION	APPROVED BY	DATE

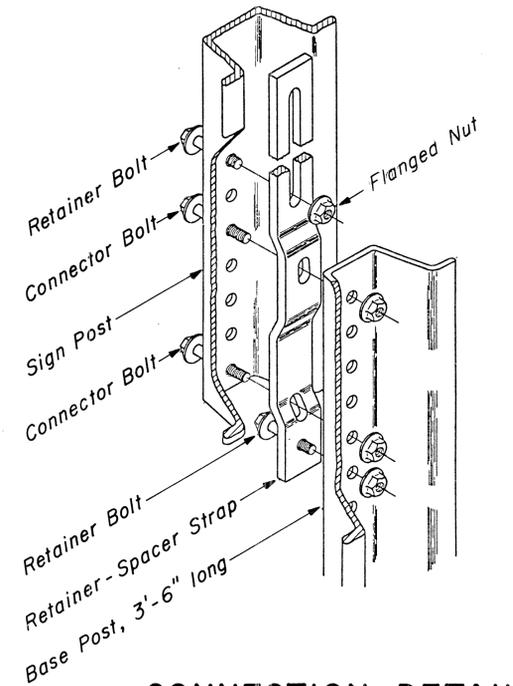


CONNECTION DETAIL
Not to Scale

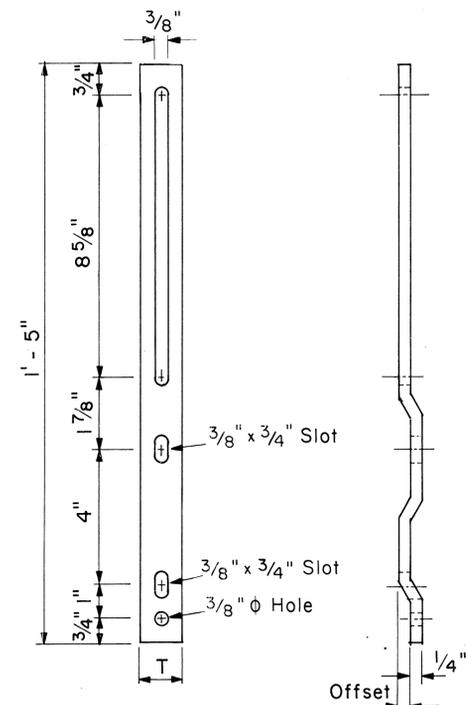

RETAINER-SPACER STRAP
Not to Scale

RETAINER-SPACER STRAP

Post Size	T	Offset
2.50 lbs./ft.	1.00"	0.145"
4.00 lbs./ft.	1.12"	0.280"

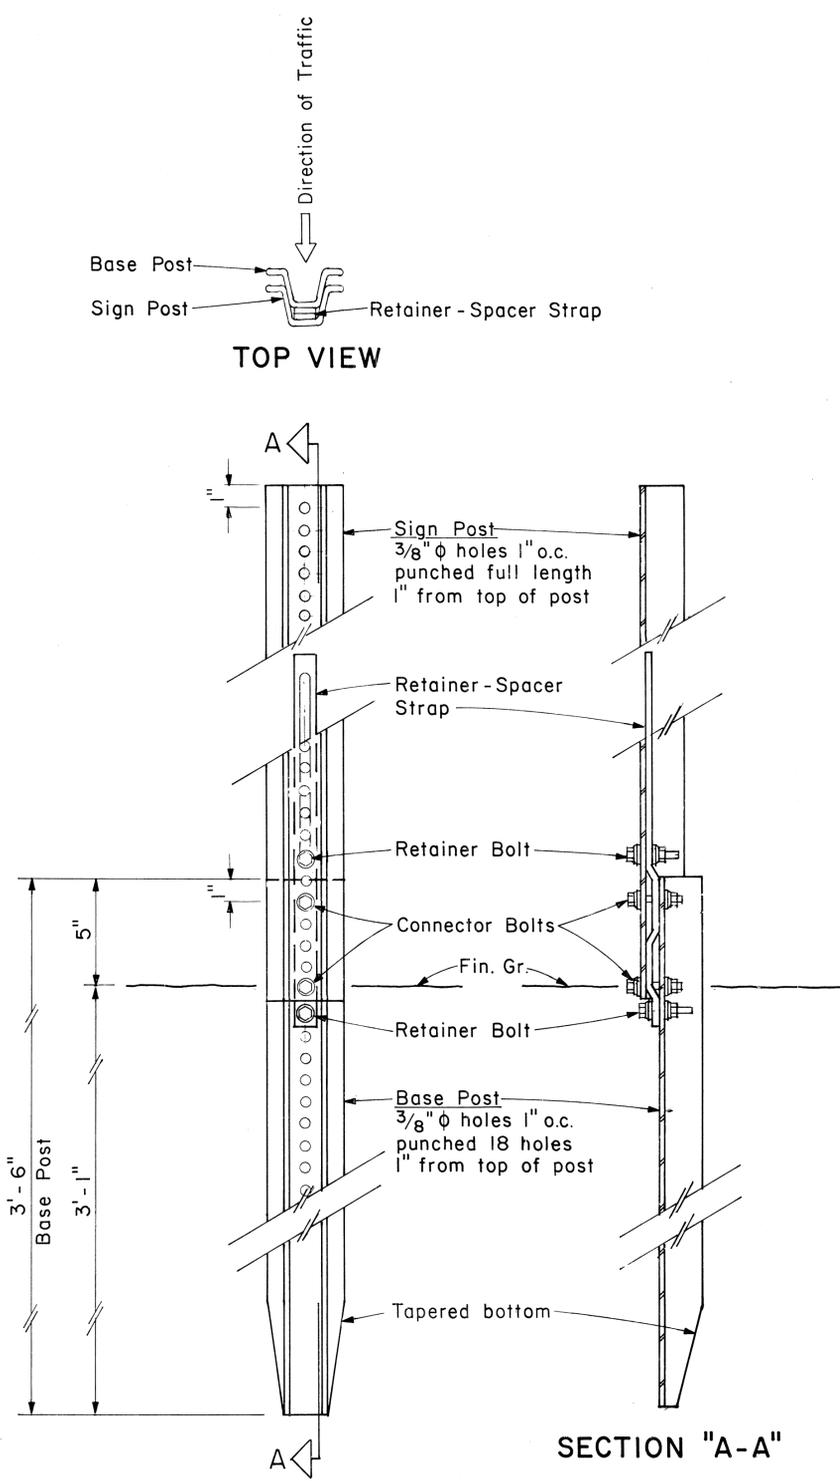

BACK VIEW

ANCHOR BASE DETAIL

Scale: 3" = 1'-0"


ORIGINAL PLAN
DATE: _____
DRAWN BY: _____
CHECKED BY: _____
DESIGNED BY: _____
DATE: _____
NO. _____

GENERAL NOTES

- Square tube sign posts shall conform to Subsection 713.11(C) Square Tube Posts of the Specifications.
- All accessories, fittings and stiffener details (as required) shall be submitted to Engineer for approval 20 days prior to installation.
- Square tube posts shall be perforated with $\frac{7}{16}$ " ϕ holes, 1" o.c., 4 sides, along entire length of post.
- All posts shall be 12 gage unless otherwise specified or shown on the plans.
- For additional details see sht. DT 100.
- Basic formulas for use with the windload charts:
 $Factor = A \times B \times H$
Therefore, if sign area (A x B) is known,
 $Maximum\ H = \frac{Factor}{sign\ area(A \times B)}$
and if H is known,
 $Maximum\ sign\ area(A \times B) = \frac{Factor}{H}$

A or A ₁	C	C ₁
36"	6"	-
48"	9"	19"
60"	12"	24"

NOTE: Frame stiffeners are required when D is greater than 24". See Gen. Note 2.

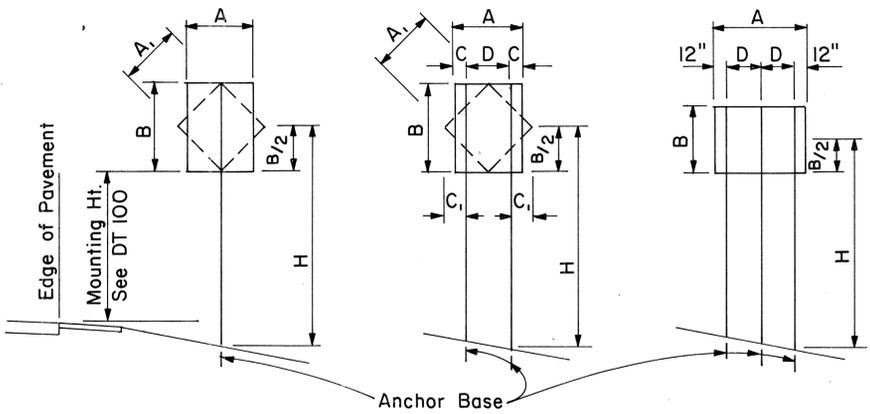

1 - POST Sign area 10 sq. ft. and less
2 - POST Sign area greater than 10 sq. ft. or A = 48" - 60"
3 - POST A = greater than 60"

TYPICAL INSTALLATION


Not to Scale

SQUARE TUBE: 1-POST INSTALLATION		H = Ground Level to Midpoint (ft.)						A x B (Area, sq. ft.)
Post Size	A x B x H (Factor)	7	8	9	10	11	12	
2"	62	8.8	7.7	6.8	6.1	5.6	4.8	A x B (Area, sq. ft.)
2 1/2"	107	-	-	-	-	9.6	8.8	


SQUARE TUBE: 2-POST INSTALLATION		H = Ground Level to Midpoint (ft.)						A x B (Area, sq. ft.)
Post Size	A x B x H (Factor)	7	8	9	10	11	12	
2"	122	17.4	15.2	13.5	12.2	11.0	10.1	A x B (Area, sq. ft.)
2 1/2"	212	30.2	26.5	23.5	21.1	19.2	17.6	
2 1/2", 10 ga.	260	37.0	32.0	28.6	26.0	23.5	21.5	

SQUARE TUBE: 3-POST INSTALLATION		H = Ground Level to Midpoint (ft.)						A x B (Area, sq. ft.)
Post Size	A x B x H (Factor)	7	8	9	10	11	12	
2"	183	26.0	22.8	20.3	18.2	16.6	15.2	A x B (Area, sq. ft.)
2 1/2"	318	45.4	39.5	35.2	31.5	28.8	26.5	
2 1/2", 10 ga.	388	55.0	48.5	43.0	38.5	35.0	32.0	

WINDLOAD CHARTS

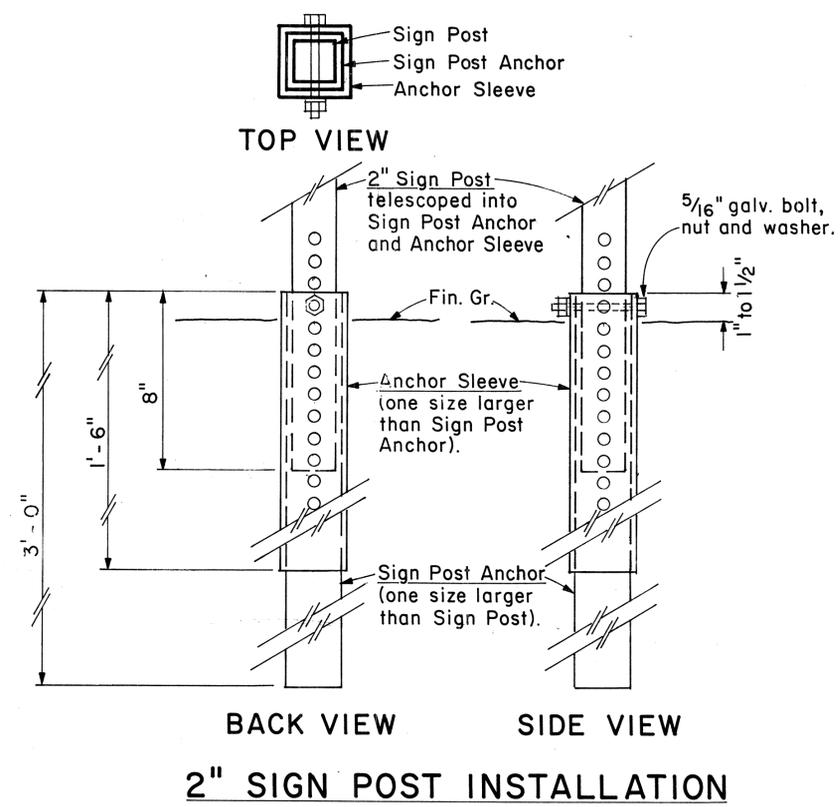

2" SIGN POST INSTALLATION

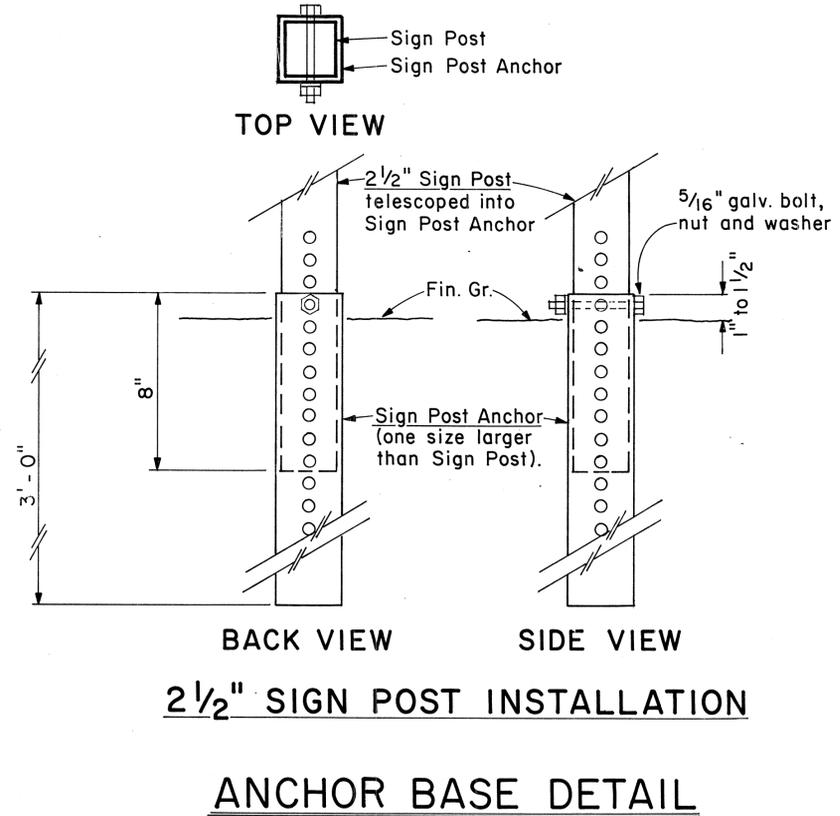

2 1/2" SIGN POST INSTALLATION
ANCHOR BASE DETAIL

Scale: 3" = 1'-0"

SURVEY PLOTTED BY: _____ DATE: _____
 DRAWN BY: _____
 TRACED BY: _____
 NOTE BOOK: _____
 QUANTITIES BY: _____
 CHECKED BY: _____
 ORIGINAL PLAN No. _____

NO.	REVISION	APPROVED BY	DATE

APPROVAL RECOMMENDED:
Eishi Tanaka 9/2/82
TRAFFIC ENGINEER DATE


APPROVED:
Robert S. Saito 9/22/82
ASSISTANT CHIEF, ENGINEERING DATE


STATE OF HAWAII
DEPARTMENT OF TRANSPORTATION
HIGHWAYS DIVISION


STANDARD DETAILS
GALVANIZED SQUARE TUBE
SIGN POST MOUNTING

Scale: As Shown Date: Sept. 1982
SHEET No. OF SHEETS DT100B

FED. ROAD DIST. NO.	STATE	FED. AID PROJ. NO.	FISCAL YEAR	SHEET NO.	TOTAL SHEETS
HAWAII	HAW.	HES-0100(28)	1986	41	67

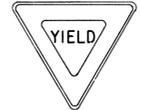
 R1-1 30"x30" R1-1-A 36"x36" R1-3 12"x6" R1-3-A 18"x9"	 R1-2 36"x36"x36" R1-2-A 48"x48"x48"	 R2-1(50) 24"x30" R2-1(50)-A 48"x60"	 R2-2(40) 24"x24" R2-2(40)-A 48"x48"	 R2-4a(50/40) 24"x48" R2-4a(50/40)-A 48"x96"	 R2-5b(30) 24"x30" R2-5b(30)-A 48"x60"	 R3-1 24"x24" 24"x18" R3-1-A 48"x48" 48"x36"	 R3-2 24"x24" 24"x18" R3-2-A 48"x48" 48"x36"	 R3-3 24"x24" R3-3-A 48"x48"	 R3-4 24"x24" 24"x18" R3-4-A 48"x48" 48"x36"	 R3-5(L) 30"x36" R3-5(L)-A 48"x60"	 R3-6(L) 30"x36" R3-6(L)-A 48"x60"
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 R3-7(R) 30"x30" R3-7(R)-A 48"x48"	 R3-8(L) 30"x30" R3-6(L)-A 36"x36" R3-8(L)-B 48"x48"	 R3-9 24"x30"	 R4-1 24"x30" R4-1-A 48"x60"	 R4-2 24"x30" R4-2-A 48"x60"	 R4-3 24"x30" R4-3-A 48"x60"	 R4-5 24"x30" R4-5-A 48"x60"	 R4-6(500) 24"x30" R4-6(500)-A 48"x60"	 R4-7 24"x30" 24"x18" R4-7-A 48"x60"	 R4-8 24"x30" 24"x18" R4-8-A 48"x60"	 R5-1 30"x30" R5-1-A 48"x48"	 R5-2 24"x24" 24"x18"
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 R5-4 24"x30" R5-4-A 48"x60"	 R5-6 24"x24" 24"x18"	 R5-9 36"x24"	 R6-1(R) 36"x12"	 R6-2(R) 18"x24"	 R7-1 12"x18" R7-1-A 24"x30"	 R7-4 12"x18" R7-4-A 24"x30"	 R7-107(R) 12"x18"	 R7-108 12"x18"	 R7-201 12"x6" R7-201-A 24"x12"	 R8-1 24"x30" R8-1-A 48"x60"	 R8-2 24"x30" R8-2-A 48"x60"
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 R8-3 24"x30" R8-3-A 48"x48"	 R8-4 30"x24" R8-4-A 48"x36"	 R8-5 24"x30" R8-5-A 48"x60"	 R8-6 24"x30" R8-6-A 48"x60"	 R8-7 30"x24" R8-7-A 48"x36"	 R9-1 18"x24"	 R9-2 12"x18"	 R9-3 12"x18"	 R9-4 18"x24"	 R10-1 12"x18"	 R10-2 12"x18"	 R10-3 9"x12"
-----------------------------------------------------------------------------------------------------------------------	-----------------------------------------------------------------------------------------------------------------------	-----------------------------------------------------------------------------------------------------------------------	------------------------------------------------------------------------------------------------------------------------	-------------------------------------------------------------------------------------------------------------------------	-------------------------------------------------------------------------------------------------------	-------------------------------------------------------------------------------------------------------	-------------------------------------------------------------------------------------------------------	-------------------------------------------------------------------------------------------------------	--------------------------------------------------------------------------------------------------------	--------------------------------------------------------------------------------------------------------	-------------------------------------------------------------------------------------------------------

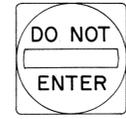 R10-4 9"x12"	 R10-5 24"x30"	 R10-6 24"x36"	 R10-7 24"x30"	 R10-8 24"x30"	 R10-9 24"x30"	 R10-10 24"x30"
-----------------------------------------------------------------------------------------------------	------------------------------------------------------------------------------------------------------	------------------------------------------------------------------------------------------------------	-------------------------------------------------------------------------------------------------------	--------------------------------------------------------------------------------------------------------	--------------------------------------------------------------------------------------------------------	---------------------------------------------------------------------------------------------------------

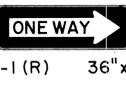 R11-1 24"x30"	 R11-2 48"x30"	 R11-3(10) 60"x30"	 R11-4 60"x30"	 R12-1(10) 24"x30"
------------------------------------------------------------------------------------------------------	------------------------------------------------------------------------------------------------------	----------------------------------------------------------------------------------------------------------	--------------------------------------------------------------------------------------------------------	------------------------------------------------------------------------------------------------------------

GENERAL NOTES

1. Sign details shall conform to the latest editions of FHWA publications "Manual on Uniform Traffic Control Devices for Streets and Highways," "Standard Alphabets for Highway Signs," and "Standard Highway Signs," and as amended.
2. All regulatory signs shall be reflectorized unless otherwise specified.
3. All regulatory signs shall have 3/8" bolt holes drilled at appropriate locations.
4. Numerals in () indicates numerals to be inserted for sign message. (R) or (L) indicates right or left.
5. All signs shall be erected without educational plaques unless called for in the plans.

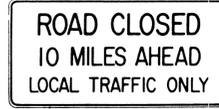APPROVAL RECOMMENDED:
Enishi Tanaka 3/17/72
 TRAFFIC ENGINEER DATE

APPROVED:
Julius J. Jansen 3-22-72
 ASSISTANT CHIEF, ENGINEERING DATE

NO.	REVISION	APPROVED BY	DATE
1	Supersedes Sht. DT 101 Approved 12-30-69	H.T.	2/20/72
2	Revised General Note 1	H.T.	10/12/74
3	Added General Note 5	H.T.	11/2/75
4	Revised Signs and General Note 1	E.T.	3/18/85

STATE OF HAWAII
 DEPARTMENT OF TRANSPORTATION
 HIGHWAYS DIVISION

STANDARD DETAILS
REGULATORY SIGNS

NOT TO SCALE

SHEET No. OF SHEETS DT 101

DATE
 SURVEY PLOTTED BY
 DRAWN BY
 DESIGNED BY
 QUANTITIES BY
 CHECKED BY
 ORIGINAL PLAN
 NOTE BOOK
 No.

FED. ROAD DIST. NO.	STATE	FED. AID PROJ. NO.	FISCAL YEAR	SHEET NO.	TOTAL SHEETS
HAWAII	HAW.	HE5-0100(2d)	1986	42	67



CW20-1a 48" x 48"



CW20-2d 48" x 48"



CW20-3b 48" x 48"



CW20-4d 48" x 48"



CW20-5d(L) 48" x 48"



CW21-1 30" x 30"



CW21-2 30" x 30"



CW20-7c 36" x 36"
24" x 18"
CW20-7c-A 48" x 48"
24" x 18"



CW21-3 36" x 36"



CW21-4 36" x 36"



CW21-5 30" x 30"



CW21-6 30" x 30"



CW22-1b 48" x 48"



CW22-2 42" x 36"



CW22-3 42" x 36"



CG20-1(5) 60" x 36"



CG20-2 60" x 24"



CM4-9(R) 30" x 24"



CM4-10(R) 48" x 18"



CG20-4 36" x 18"



CW23-1 36" x 36"



CW23-2b 48" x 48"



CW23-3(R) 48" x 48"

GENERAL NOTES

- Sign details shall conform to the latest editions of FHWA publications "Manual on Uniform Traffic Control Devices for Streets and Highways," "Standard Alphabets for Highway Signs," and "Standard Highway Signs," and as amended.
- All construction signs shall be reflectorized.
- All construction signs shall have 3/8" bolt holes drilled at appropriate locations.
- Numerals in () indicates numerals to be inserted for sign message. (R) or (L) indicates right or left.
- For "CW" series signs, suffixes a, b, c and d are as follows:
a-1500 FT, b-1000 FT,
c-500 FT and d-AHEAD.

APPROVAL RECOMMENDED:
Erica Tanaka 3/21/72
TRAFFIC ENGINEER DATE

APPROVED:
Walter Salsich 3/23/72
ASSISTANT CHIEF, ENGINEERING DATE

NO.	REVISION	APPROVED BY	DATE
1	Supersedes Sht. DT 104 Approved 12-30-69	H.T.	3/25/72
2	Revised General Note 1	H.T.	10/16/74
3	Revised General Note 2	M.H.	9-16-75
4	Revised General Note 2 and sign CG20-1(5)	H.T.	9-14-76
5	Revised General Note 1 and sign CW20-7c	E.T.	9/18/85

STATE OF HAWAII
DEPARTMENT OF TRANSPORTATION
HIGHWAYS DIVISION

STANDARD DETAILS
CONSTRUCTION SIGNS


NOT TO SCALE

SURVEY PLOTTED BY	DATE
DRAWN BY	" "
TRACED BY	" "
QUANTITIES BY	" "
CHECKED BY	" "
ORIGINAL PLAN	No. _____
NOTE BOOK	No. _____


FED. ROAD DIST. NO.	STATE	FED. AID PROJ. NO.	FISCAL YEAR	SHEET NO.	TOTAL SHEETS
HAWAII	HAW.	HE5-0100(28)	1986	43	67

GENERAL NOTES:


1. Clearance markers (RM-3, RM-4) shall be installed with the edge of the marker in line with the inner edge of the obstruction.
2. (R) or (L) indicates right or left and shall be as shown on the plans.
3. Reflector markers RM-1 and RM-2 shall be:
 - a) Yellow if placed along the left edge of divided roadways, one-way roadways, and ramps in the direction of travel.
 - b) White if placed along the right edge of divided roadways, one-way roadways, and ramps in the direction of travel.
4. For RM-4, the stripes shall slope downward at an angle of 45° toward the side of the obstruction that traffic is to pass.
5. For reflector marker RM-9, reflective sheeting material may be used as an alternate.
6. (H) indicates horizontal mounting of reflector marker.
7. Height = 4'-0" min. for RM-1, RM-2 and RM-3.
Height = 5'-6" min. for RM-4 and RM-9.
8. Final locations of reflector markers shall be approved by the Engineer.

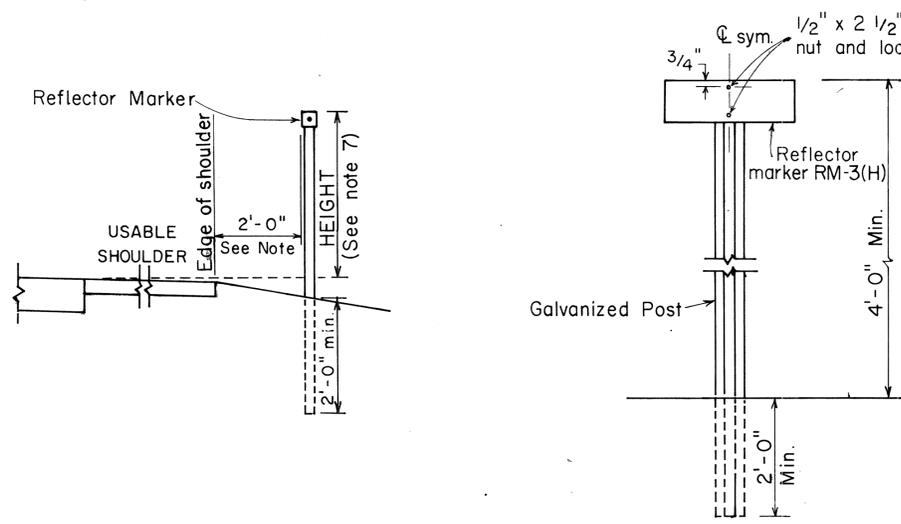

REFLECTOR MARKER MOUNTING DETAIL

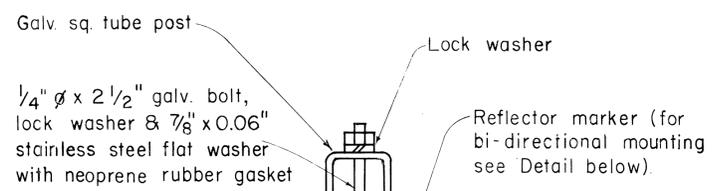


GALVANIZED SQUARE TUBE POST

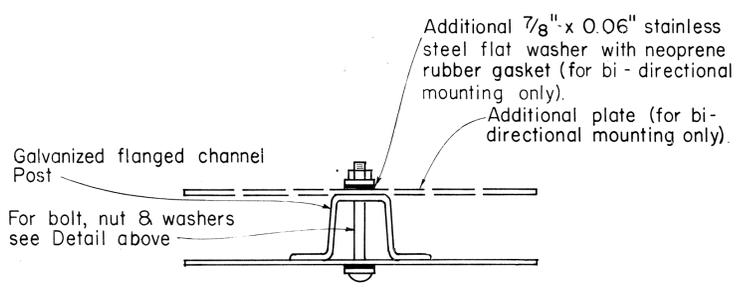

GALVANIZED FLANGED CHANNEL POST

TYPICAL MOUNTING DETAILS

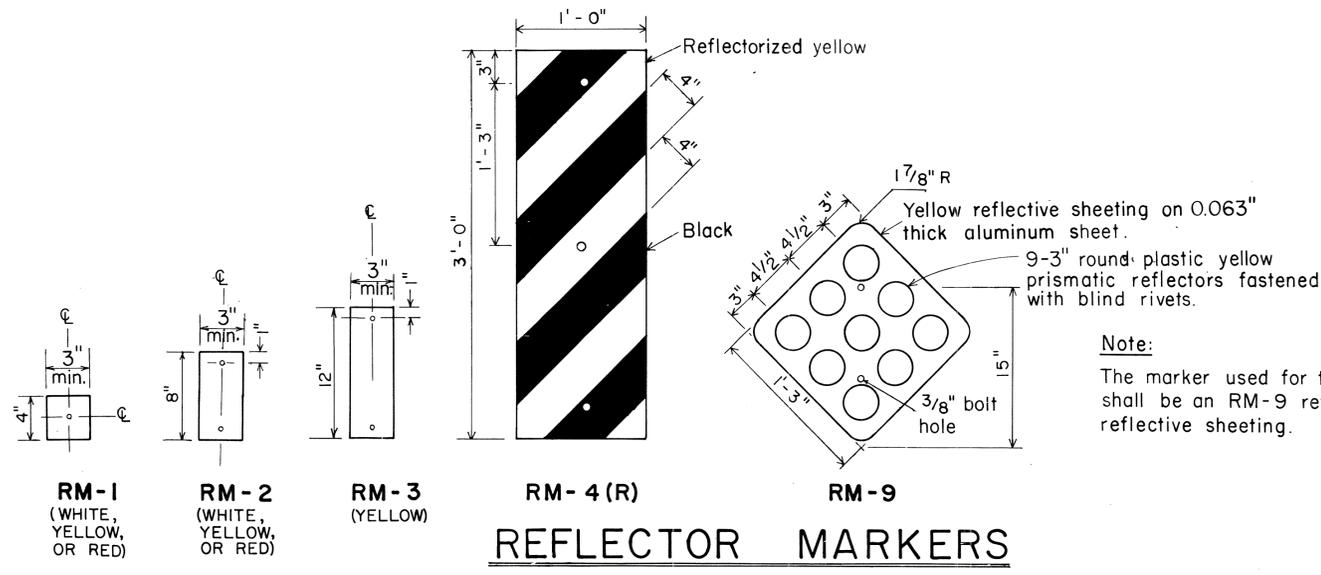

REFLECTOR MARKERS

APPROVAL RECOMMENDED:
Euski Tanaka 11/7/77
 TRAFFIC ENGINEER DATE

APPROVED:
Hubert S. Sakai 11/15/77
 ASSISTANT CHIEF, ENGINEERING DATE

NO.	REVISION	APPROVED BY	DATE
1	Revised Mounting Details	H.H.	4/23/80
2	Revised General Notes, Mounting Details and Reflector Markers.	P.D.	2-28-83
3	Eliminated White for RM-4	P.D.	1-30-85

STATE OF HAWAII
 DEPARTMENT OF TRANSPORTATION
 HIGHWAYS DIVISION

STANDARD DETAILS
 MISCELLANEOUS REFLECTOR MARKERS


Not to scale June, 1977
 SHEET No. OF SHEETS DT 110

DATE	_____
SURVEY PLOTTED BY	_____
DRAWN BY	_____
DESIGNED BY	_____
NOTE BOOK	_____
QUANTITIES BY	_____
CHECKED BY	_____
No.	_____


FED. ROAD DIST. NO.	STATE	FED. AID PROJ. NO.	FISCAL YEAR	SHEET NO.	TOTAL SHEETS
HAWAII	HAW.	HES-0100(28)	1986	44	67

GENERAL NOTES


- All objects (utility poles or trees) that are within the State highway right of way and within 30 feet of the roadway edge of pavement shall be marked as directed by the Engineer.
- The Contractor shall prepare the mounting surface of each object as directed by the Engineer and place the Type II Object Marker as shown on this plan.
- Type II Object Markers shall be mounted on utility poles and trees with 1 3/4" galv. roofing nails (4 ea.).
- Branches of trees which obscure the object markers shall be trimmed. (Payment shall be incidental to Type II Object Markers as shown in the proposal).
- Type II Object Markers for utility poles and trees, etc., shall be made of amber reflective sheeting material overlayed on 0.020" aluminum sheeting.
- Objects such as concrete posts, concrete or rock walls and boxes, metal posts (greater than 2" in diameter), or metal boxes shall be marked with post mounted object markers. Post mounted Type II Object Markers shall conform to the following requirements:
 - It shall consist of amber reflective sheeting material overlayed on 0.063" thick sheet aluminum backing of the dimensions shown on the plans.
 - It shall be mounted on either metal posts or flexible delineator posts with 1/4" x 2" galv. bolts, nuts and washers. Metal posts shall be galvanized and shall be either 1 1/2" x 1 1/2", 12 gage square tube posts or 1.12 lbs. per ft. flanged channel posts.

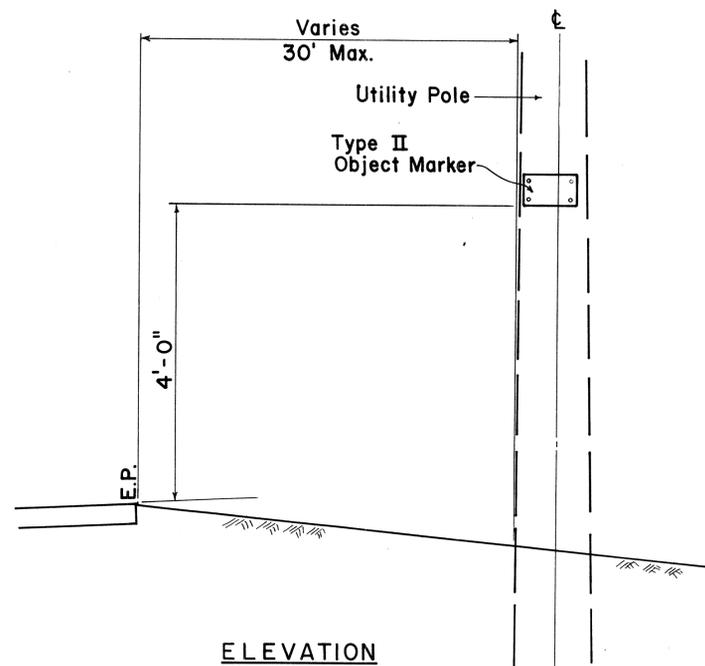


ELEVATION

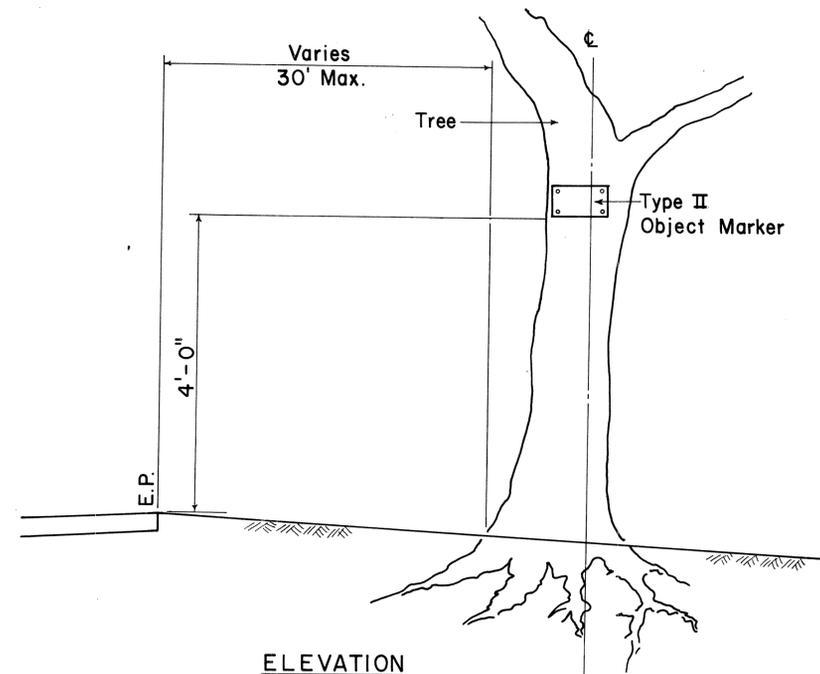

ELEVATION

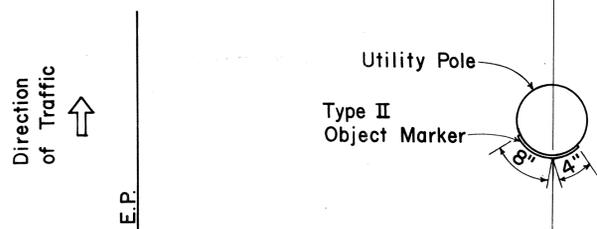


PLAN

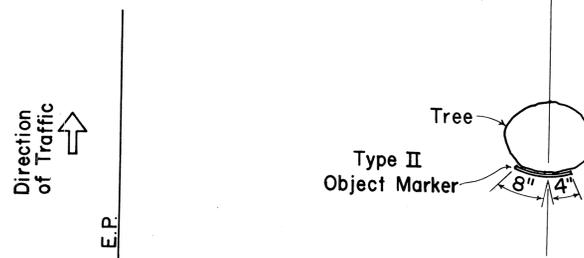


PLAN


TYPICAL TYPE II OBJECT MARKER MOUNTING DETAIL

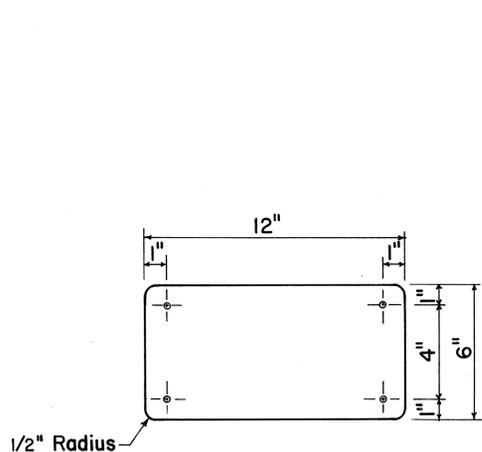

TYPE II OBJECT MARKER

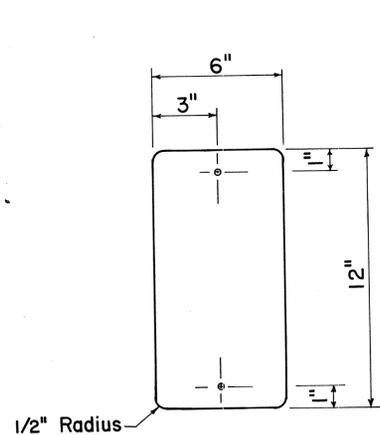

TYPE II OBJECT MARKER POST MOUNTED

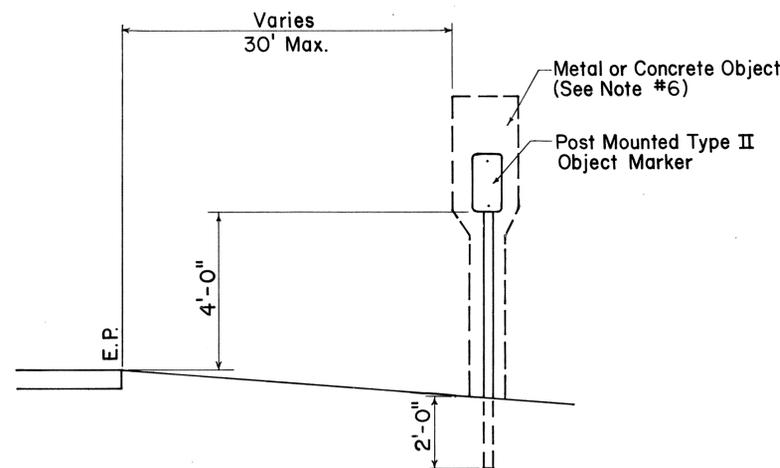

POST MOUNTED TYPE II OBJECT MARKER DETAIL

APPROVAL RECOMMENDED:

Eiichi Tanaka 3/30/83
TRAFFIC ENGINEER DATE

APPROVED:

S. Fujiyama 3-31-83
ASSISTANT CHIEF, ENGINEERING DATE

NO.	REVISION	APPROVED BY	DATE

STATE OF HAWAII
DEPARTMENT OF TRANSPORTATION
HIGHWAYS DIVISION


STANDARD DETAILS

TYPE II OBJECT MARKERS


Scale: Not to scale Date: March 1983
SHEET NO. OF SHEETS DT III

SURVEY PLOTTED BY	DATE
DRAWN BY	
DESIGNED BY	
CHECKED BY	
ORIGINAL PLAN	
NOTE BOOK	
No.	


FED. ROAD DIST. NO.	STATE	FED. AID PROJ. NO.	FISCAL YEAR	SHEET NO.	TOTAL SHEETS
HAWAII	HAW.	115-0100(20)	1986	45	67

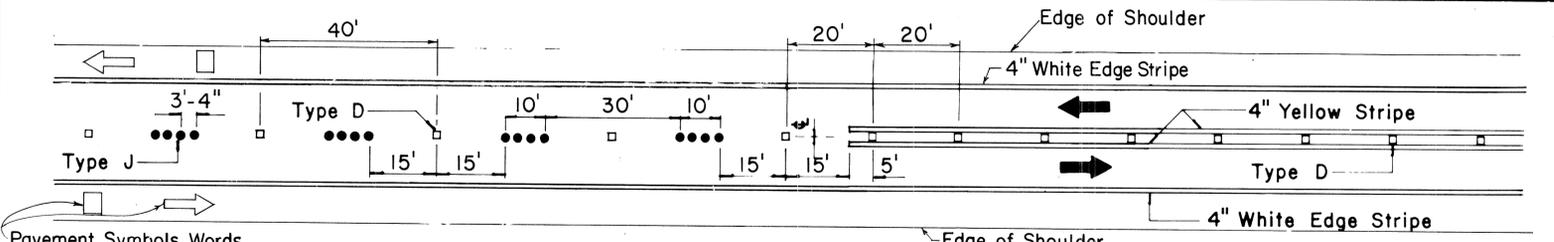


Pavement Symbols, Words, Arrows, and Legends for Bike Route as Required on Plans. **PASSING PERMITTED AND PASSING PROHIBITED**

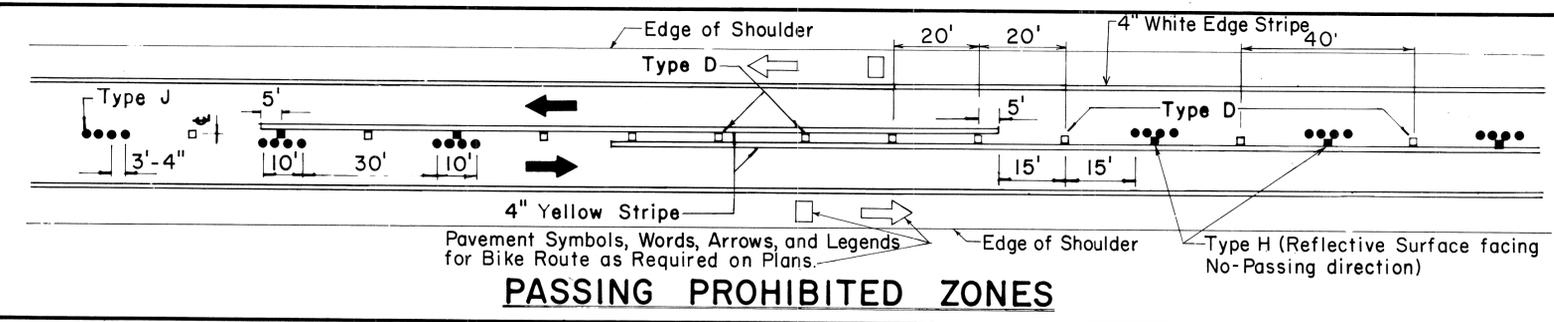


Pavement Symbols, Words, Arrows, and Legends for Bike Route as Required on Plans. **PASSING PROHIBITED ZONES**

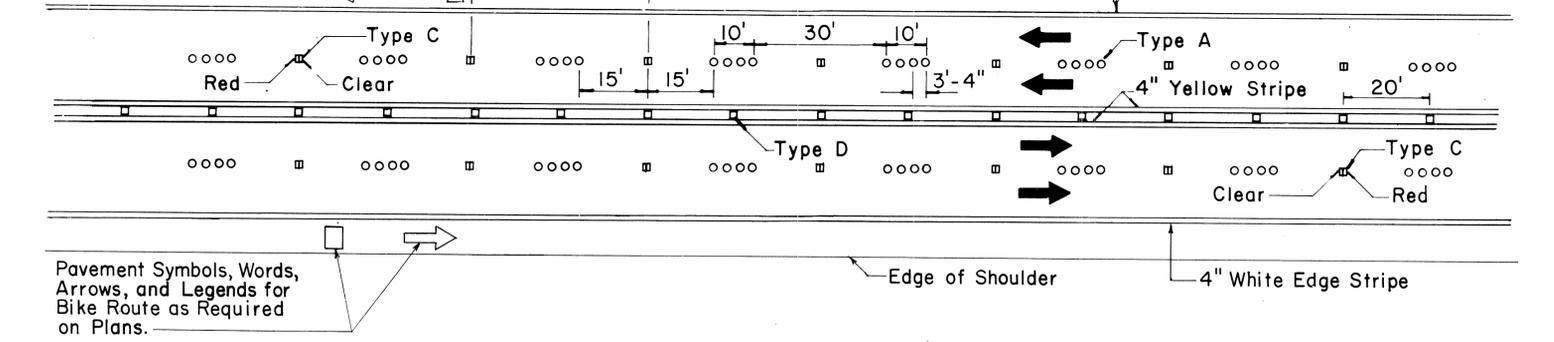


Pavement Symbols, Words, Arrows, and Legends for Bike Route as Required on Plans. **MULTI-LANE**

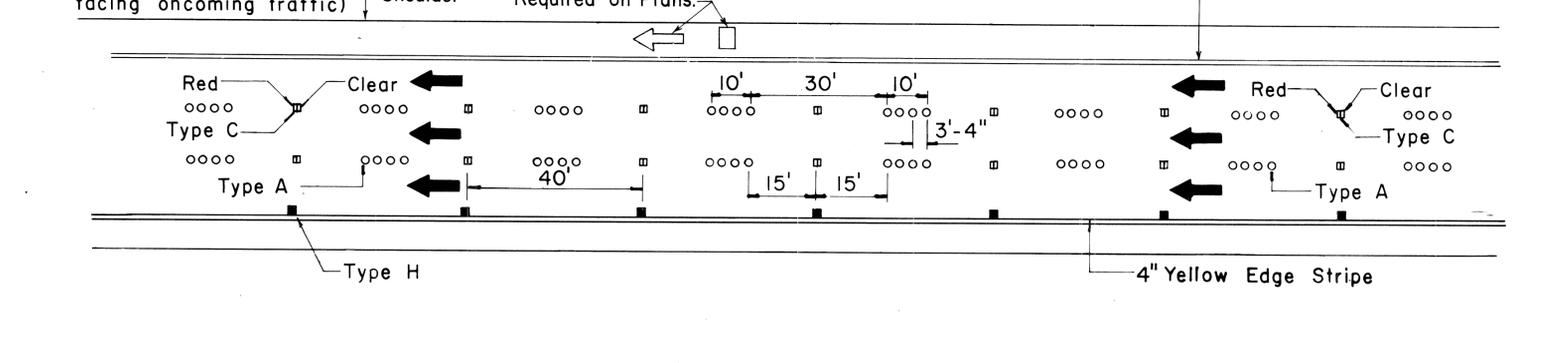

NOTE: Type H (Reflective Surface facing oncoming traffic) Pavement Symbols, Words, Arrows, and Legends for Bike Route as Required on Plans. **DIVIDED HIGHWAY AND FREEWAY**

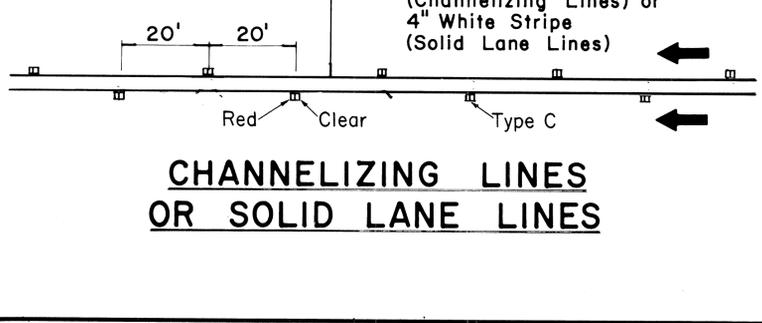

CHANNELIZING LINES OR SOLID LANE LINES

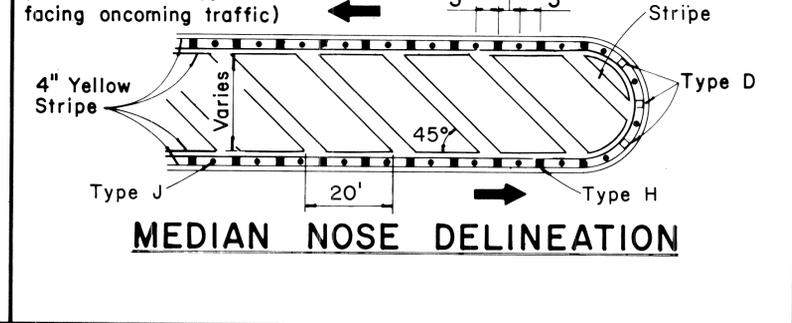


NOTE: Type H (Reflective surface facing oncoming traffic) **MEDIAN NOSE DELINEATION**

TWO - LANE


MULTI - LANE

DIVIDED HIGHWAY AND FREEWAY


MISCELLANEOUS

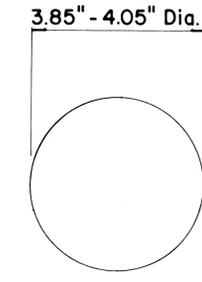


TYPE A
NON-REFLECTIVE WHITE MARKER

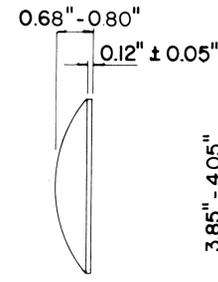


TYPE J
NON-REFLECTIVE YELLOW MARKER

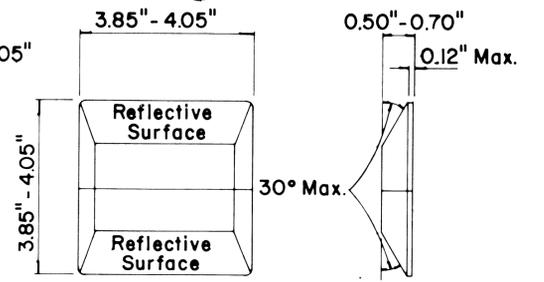

TYPE C
RED-CLEAR REFLECTIVE MARKER

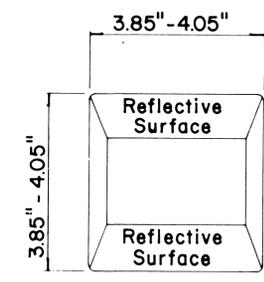

TYPE D
TWO-WAY YELLOW REFLECTIVE MARKER

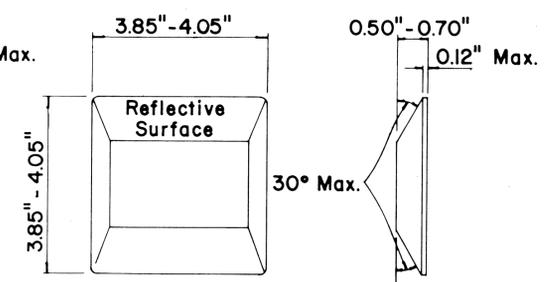

TYPE H
ONE-WAY YELLOW REFLECTIVE MARKER

GENERAL NOTES

1. Pavement marking and striping shall conform to the latest "Manual on Uniform Traffic Control Devices for Streets and Highways," and as amended.
2. Layout and installation of pavement marking and striping shall be done by the Contractor. The Contractor shall check the layouts with the Engineer prior to performing work.
3. Edge lines shall not be continued through intersections and shall not be broken for driveways unless otherwise shown or directed.

LEGEND

- Type A
- Type C
- Type D
- Type H
- Type J

APPROVAL RECOMMENDED:
Eiichi Tanaka 7/21/78
TRAFFIC ENGINEER DATE

APPROVED:
Herbert S. Zakiyah 1/24/78
ASSISTANT CHIEF, ENGINEERING DATE

No.	REVISION	APPROVED BY	DATE
1	Supersedes DT 300 approved 11/18/71.	H.T.	1/24/78
2	Delete Type A Markers from Bike Route Delineation.	H.T.	10/15/79
3	Added General Note 3. Revised left edge stripe.	H.T.	9-28-83
4	Revised Channelizing Lines or Solid Lane Lines.	H.T.	9/12/85

STATE OF HAWAII
DEPARTMENT OF TRANSPORTATION
HIGHWAYS DIVISION

STANDARD DETAILS
RAISED PAVEMENT MARKERS
AND STRIPING


Not to Scale July 1978
SHEET No. OF SHEETS DT 300

DATE
SURVEY PLOTTED BY
DRAWN BY
TRACED BY
NOTE BOOK
CHECKED BY
No.


FED. ROAD DIST. NO.	STATE	FED. AID PROJ. NO.	FISCAL YEAR	SHEET NO.	TOTAL SHEETS
HAWAII	HAW.	HE5-0100(28)	1986	46	67

GENERAL NOTES

- Both of the alternate type posts may be used on any one project however, only one type of post shall be used in any single run of guardrail.
- All hardware, posts and blocks shall be galvanized. No punching, drilling or cutting will be permitted after galvanizing.
- Connection details for bent plate post and block shall be similar to the details shown for structural shape post, and block.
- Where conditions require, special post lengths in increments of 6 inches may be specified.
- For details of rail elements, bolts and nuts, see sheet DT 501.
- All fasteners, posts, blocks and rail elements shall conform to the latest edition and amendments of "A Guide to Standardized Highway Barrier Rail Hardware," a report prepared and approved by the AASHTO-AGC-ARTBA Joint Cooperative Committee.

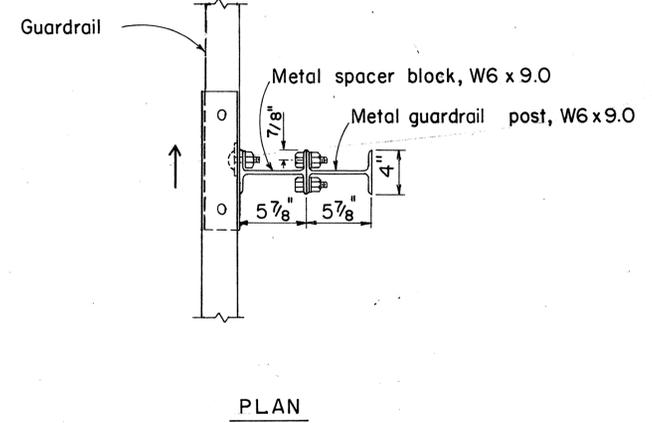


PLAN

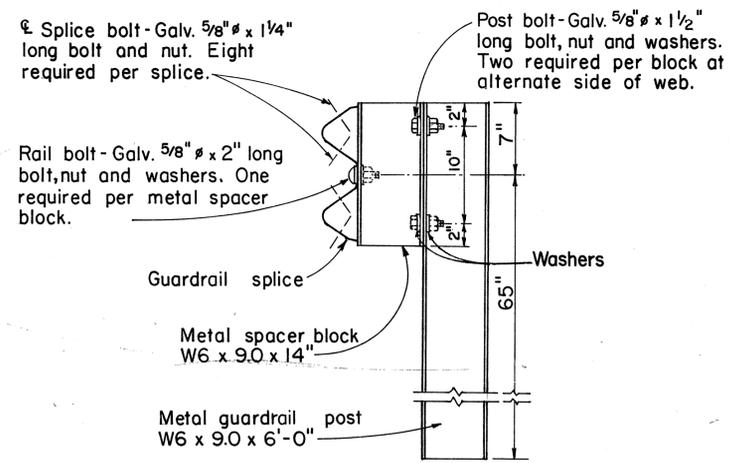

ELEVATION

SINGLE METAL GUARDRAIL ON METAL POST WITH METAL SPACER BLOCK

SCALE: 1/2" = 1'-0"

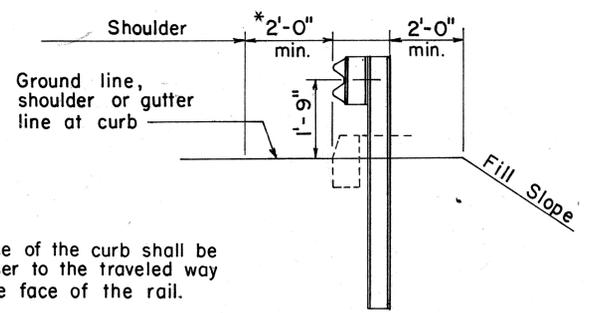


AT SHOULDER SECTION


TYPICAL METAL GUARDRAIL DETAIL

SCALE: 1/2" = 1'-0"


Note:
The face of the curb shall be no closer to the traveled way than the face of the rail.

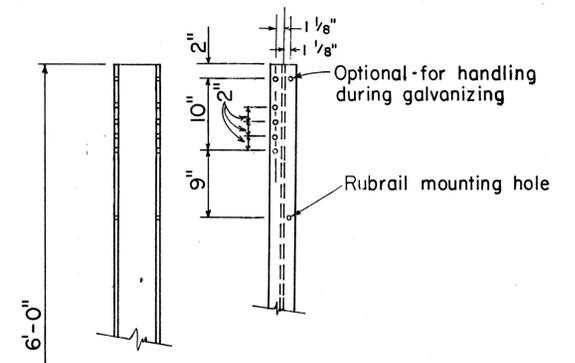

NOTE:
All holes 1 3/16" ø. Bolt hole pattern is symmetrical with respect to the vertical axis of the post.

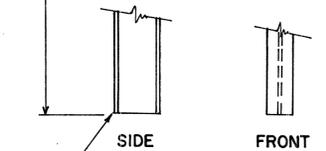


POST

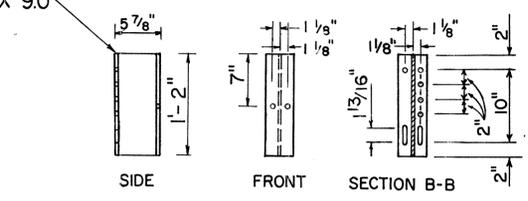


BLOCK

STRUCTURAL SHAPE POST AND BLOCK


SCALE: 1" = 1'-0"

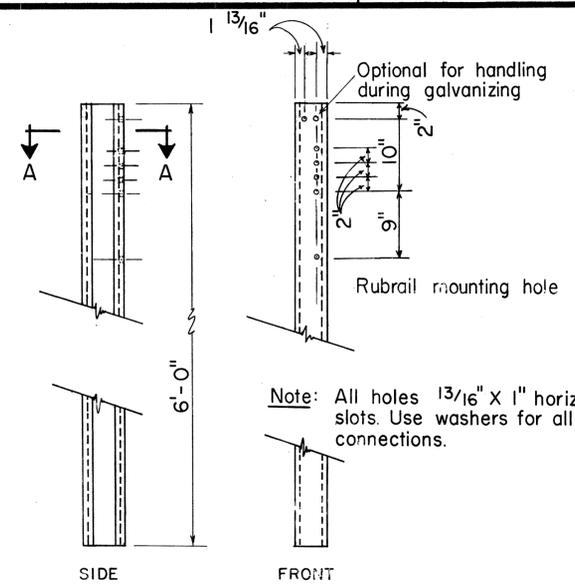

POST

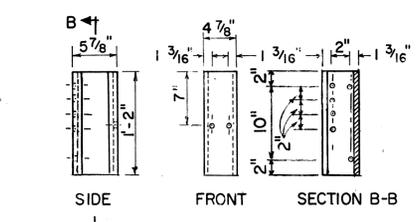


BLOCK

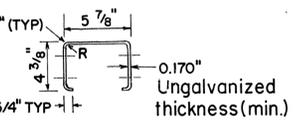


SECTION A-A
N.T.S.

BENT PLATE POST AND BLOCK

SCALE: 1" = 1'-0"

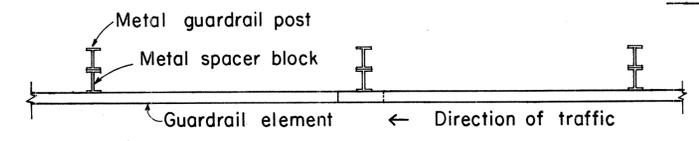



PLAN

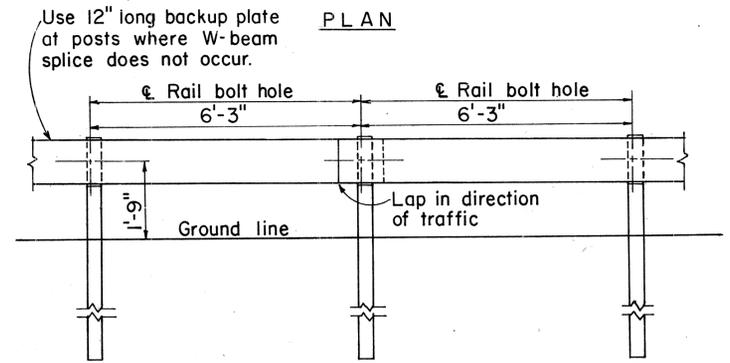

ELEVATION

METAL GUARDRAIL ON METAL POST WITH METAL SPACER BLOCK

SCALE: 1/2" = 1'-0"

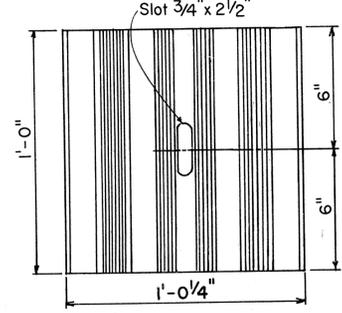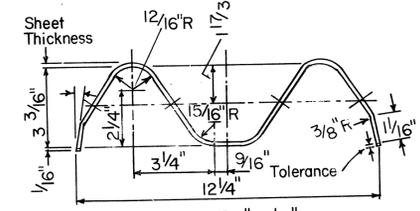

BACK-UP-PLATE
N.T.S.

APPROVAL RECOMMENDED:
Eishi Tanaka 9/7/82
TRAFFIC ENGINEER DATE

APPROVED:
Herbert Zalski 9/22/82
ASSISTANT CHIEF, ENGINEERING DATE

NO.	REVISION	APPROVED BY	DATE
1	Supersedes sht. DT 500 approved 12/30/69.	H.T.	9/22/82
2	Added General Notes No. 6	J.D.	9-28-83
3	Added details for adjusting guardrail height and added Back-up Plate and washer	E.T.	9/18/85


STATE OF HAWAII
DEPARTMENT OF TRANSPORTATION
HIGHWAYS DIVISION

STANDARD DETAILS
METAL GUARDRAIL

Scale: As Shown July, 1982
SHEET No. OF SHEETS DT 500


SURVEY PLOTTED BY: _____
 DATE: _____
 DRAWN BY: _____
 TRACED BY: _____
 NOTE BOOK DESIGNED BY: _____
 QUANTITIES BY: _____
 CHECKED BY: _____
 No. _____

FED. ROAD DIST. NO.	STATE	FED. AID PROJ. NO.	FISCAL YEAR	SHEET NO.	TOTAL SHEETS
HAWAII	HAW.	HE5-0100(28)	1986	47	67


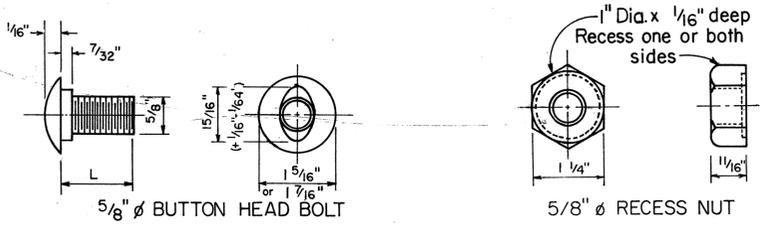


L	Thread Length	Intended Use
1 1/4"	Full length thread	Splice rail elements
2"	1 1/2" min. thread len.	Fasten rails to posts



5/8" BUTTON HEAD BOLT AND RECESS NUT
Scale: N.T.S.

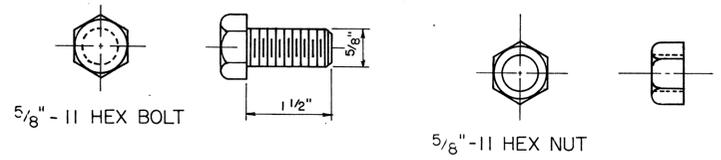


5/8" HEX POST BOLT AND NUT
Scale: N.T.S.

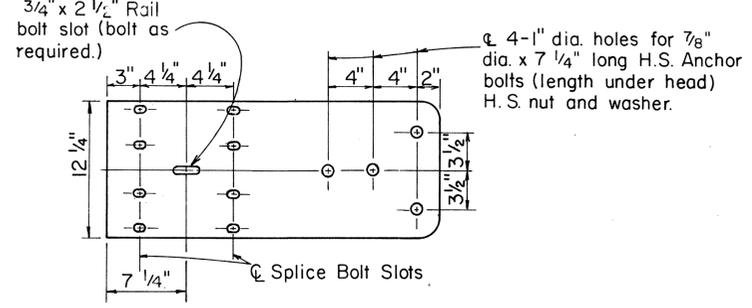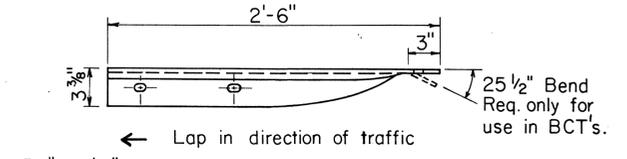


W BEAM TERMINAL CONNECTOR
Scale: 1 1/2" = 1'-0"

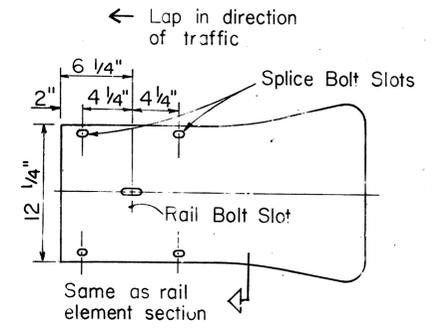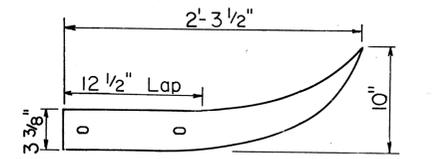


W BEAM END SECTION (FLARED)
Scale: 1 1/2" = 1'-0"

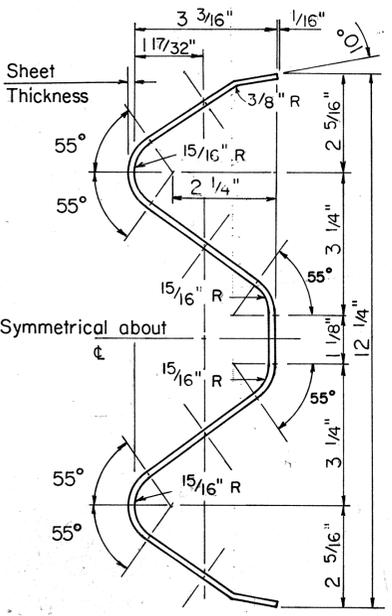


RAIL ELEMENT SECTION
Scale: 6" = 1'-0"

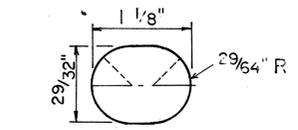


SPLICE BOLT SLOT

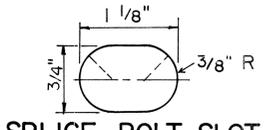


SPLICE BOLT SLOT FOR ALL ENDS

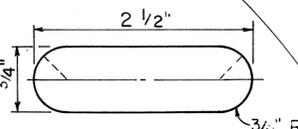


RAIL BOLT SLOT

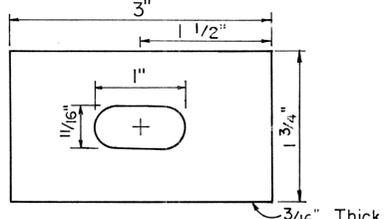


RAIL BOLT WASHER

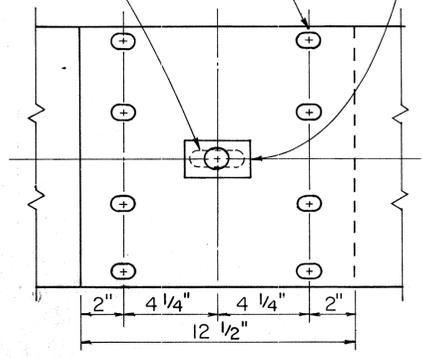

RAIL SPLICE
Scale: 3" = 1'-0"

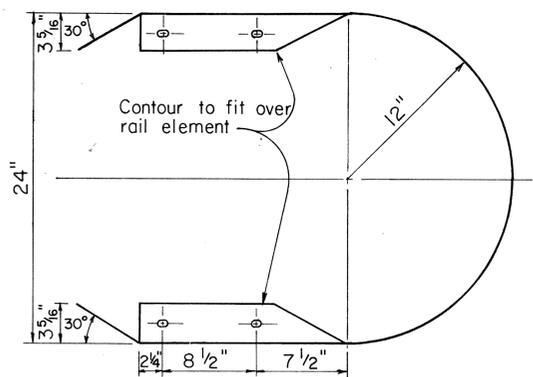

W BEAM END SECTION (BUFFER)
Scale: 1 1/2" = 1'-0"

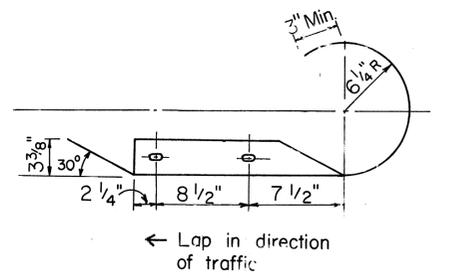

W BEAM END SECTION (ROUNDED)
Scale: 1 1/2" = 1'-0"

DATE	_____
SURVEY PLOTTED BY	_____
DRAWN BY	_____
DESIGNED BY	_____
NOTE BOOK	_____
QUANTITIES BY	_____
CHECKED BY	_____
No.	_____

APPROVAL RECOMMENDED:
Euchi Tanaka 9/20/82
TRAFFIC ENGINEER DATE

APPROVED:
Shiroshi 9/22/82
ASSISTANT CHIEF, ENGINEERING DATE

NO.	REVISION	APPROVED BY	DATE
1	Supersedes sht. DT 501 approved 12/30/69	H.F.	9/22/82







STATE OF HAWAII
DEPARTMENT OF TRANSPORTATION
HIGHWAYS DIVISION

STANDARD DETAILS
METAL GUARDRAIL

Scale: As Noted July, 1982
SHEET No. OF SHEETS DT 501

FED. ROAD DIST. NO.	STATE	FED. AID PROJ. NO.	FISCAL YEAR	SHEET NO.	TOTAL SHEETS
HAWAII	HAW.	HES-0100(28)	1986	48	67

NOTE:
 1. Metal guard rail connection to structures requires End Post Connection. See structure plans.
 2. For detail of Breakaway Cable Terminal (BCT) See Sheet No. DT 519

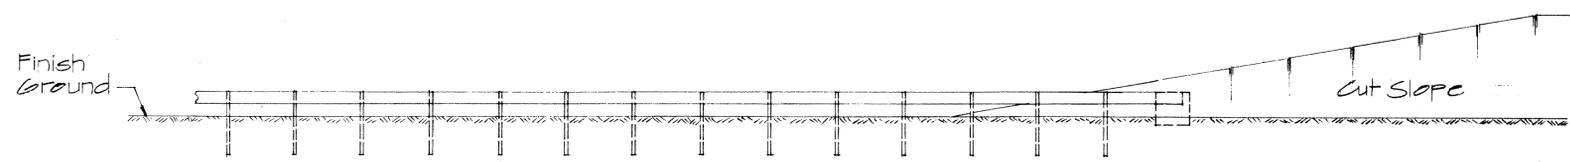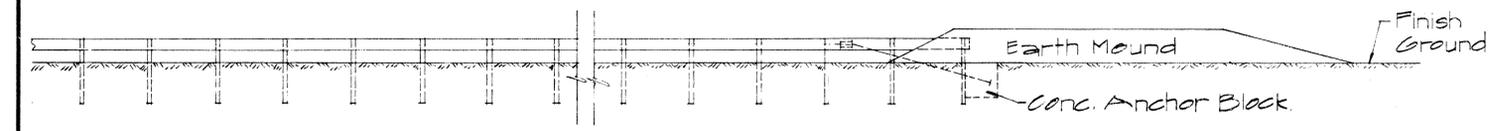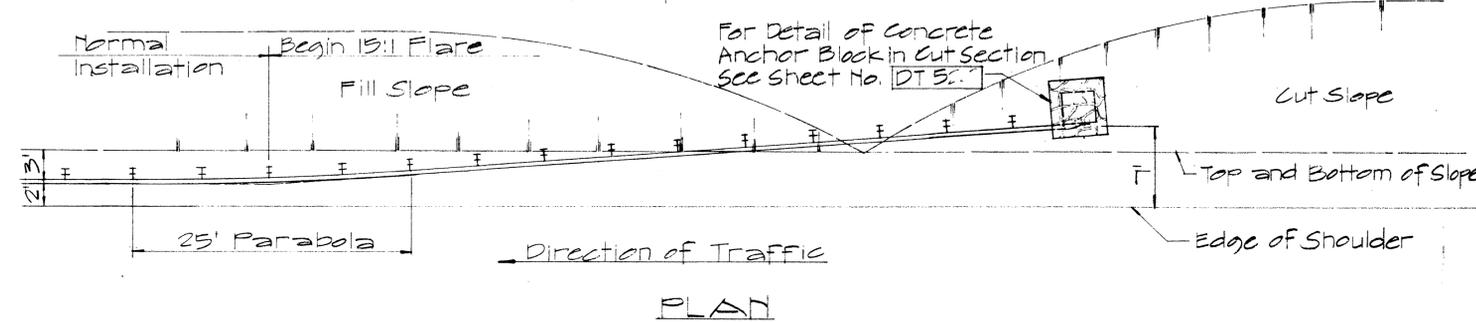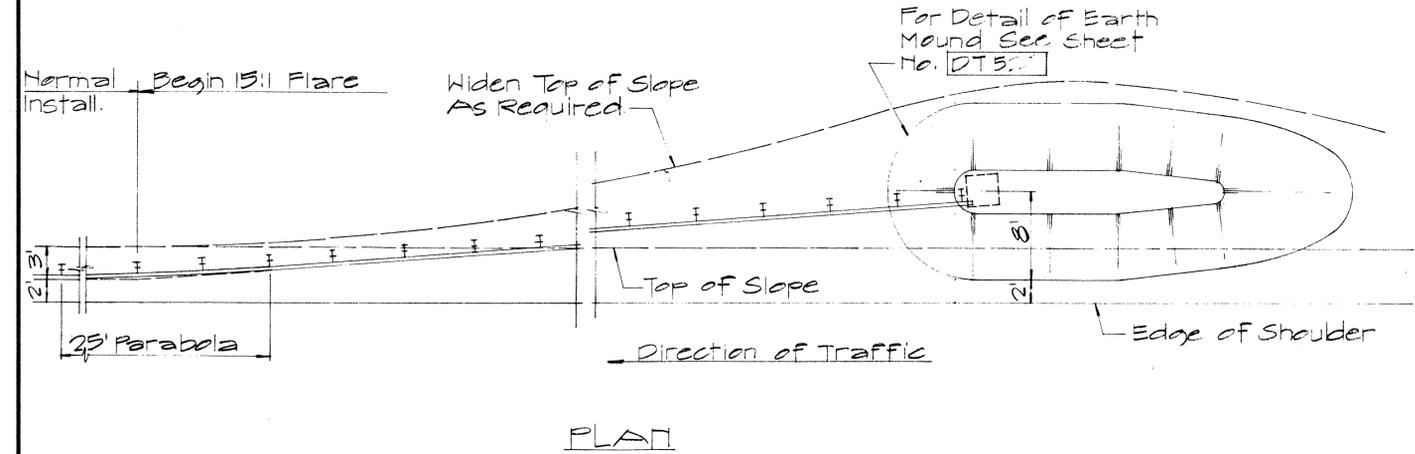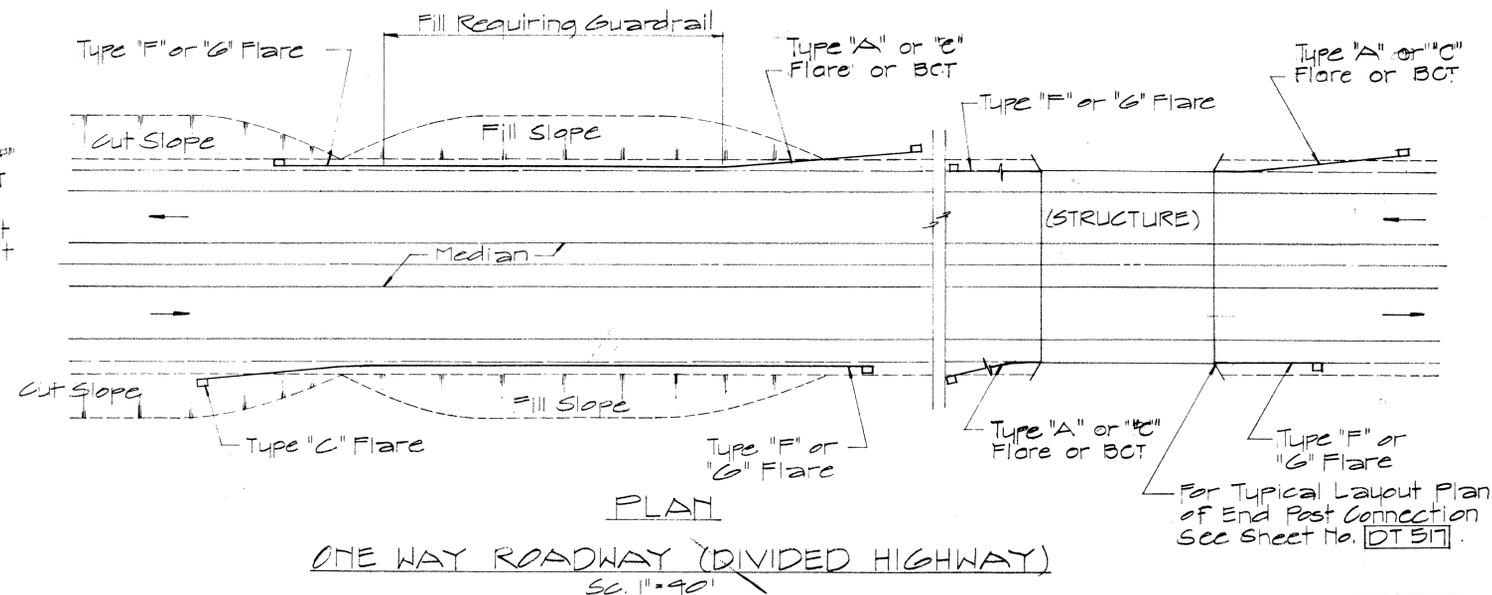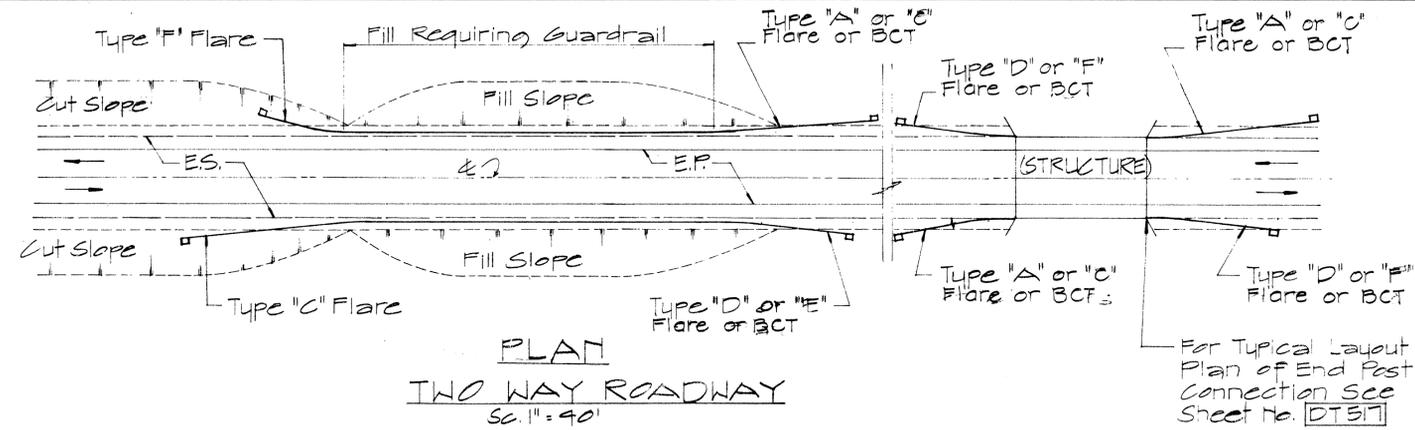

APPROVAL RECOMMENDED:
Etsuki Tanaka 12/29/69
 TRAFFIC ENGINEER DATE

APPROVED:
Andrew J. DeLisi 12-30-69
 ASSISTANT CHIEF, ENGINEERING DATE

ELEVATION
 TYPE "C" FLARE
 Sc. 1/8" = 1'-0"

NO.	REVISION	APPROVED BY	DATE
1	Delete Type "B" Flare and Type "E" Flare	H.S.	6/15/78







STATE OF HAWAII
 DEPARTMENT OF TRANSPORTATION
 HIGHWAYS DIVISION

**STANDARD DETAILS
 OF APPROACH END
 FLARE - ONE & TWO
 WAY ROADWAY**


Sc. As Noted April 1969
 SHEET No. OF SHEETS DT 516

DATE
SURVEY PLOTTED BY
DRAWN BY
FRACED BY
QUANTITIES BY
CHECKED BY
ORIGINAL PLAN
NOTE BOOK
No.

FED. ROAD DIST. NO.	STATE	FED. AID PROJ. NO.	FISCAL YEAR	SHEET NO.	TOTAL SHEETS
HAWAII	HAW.	415-0100(28)	1986	49	67

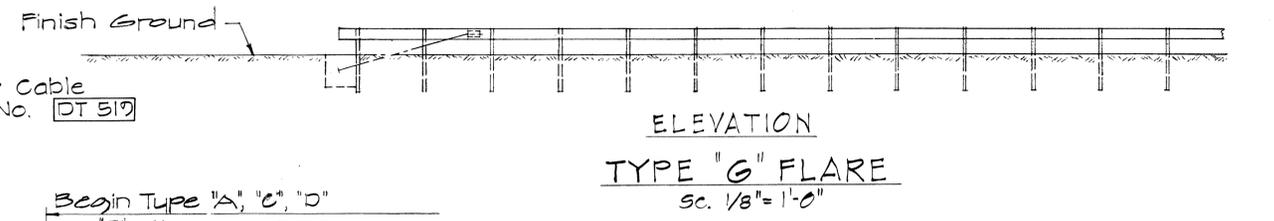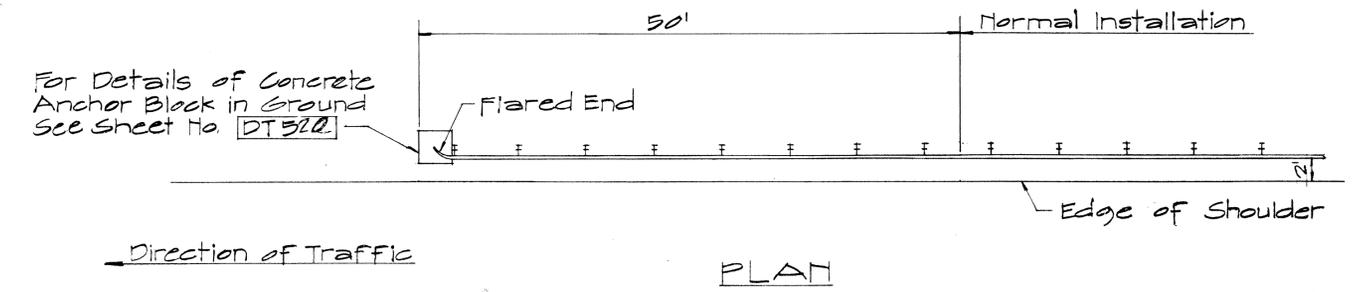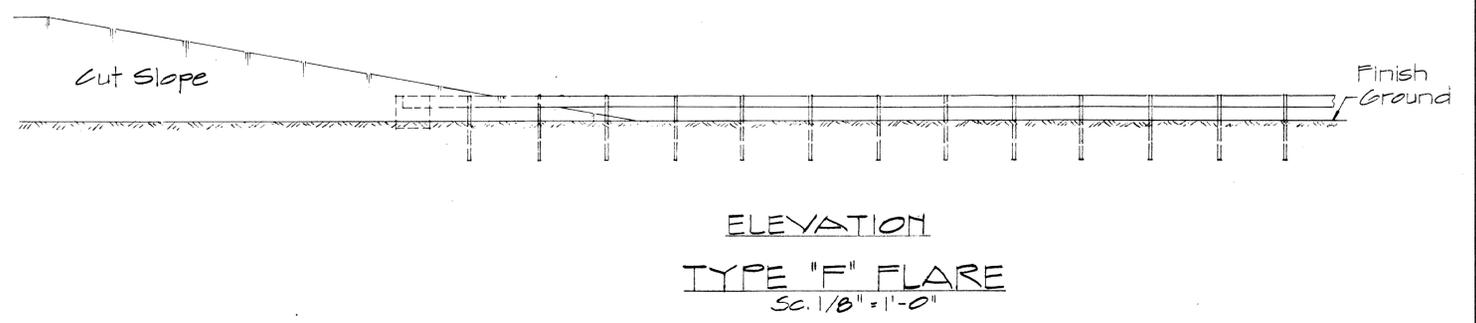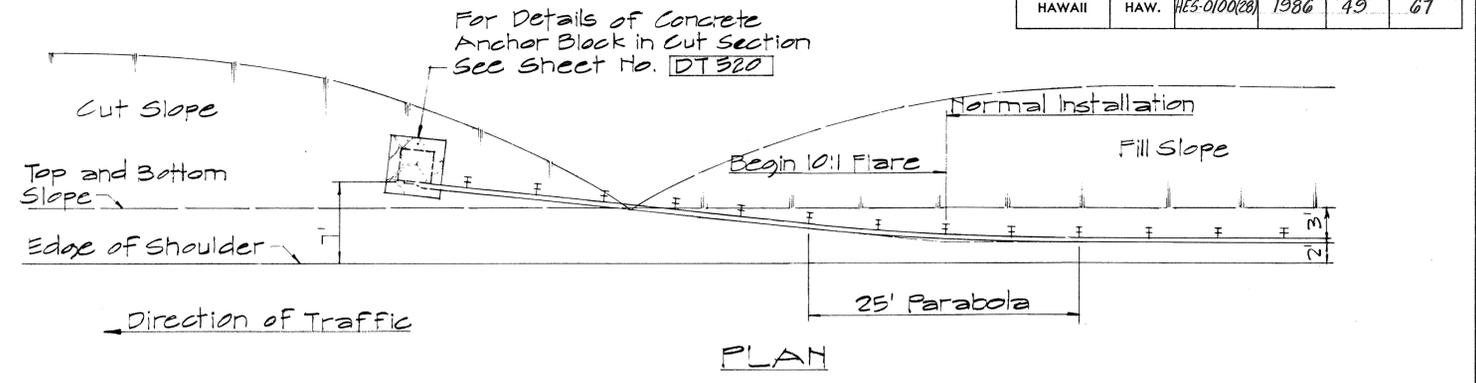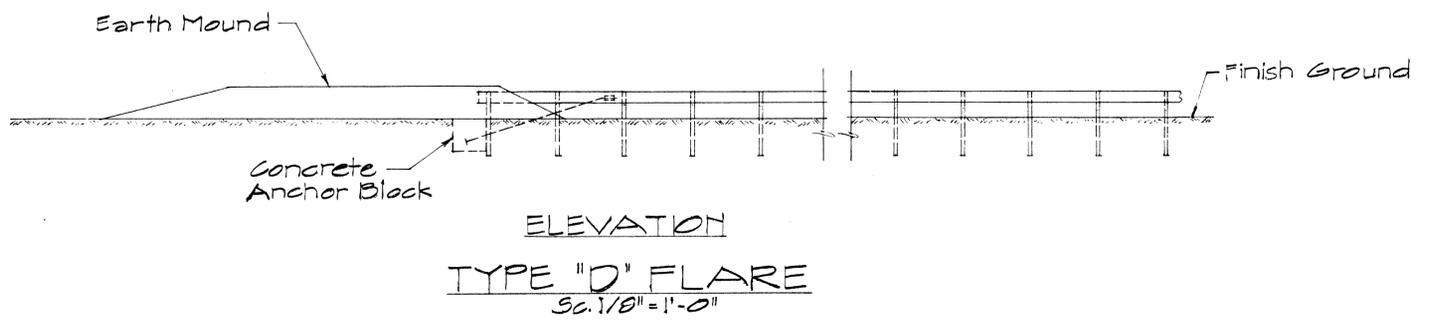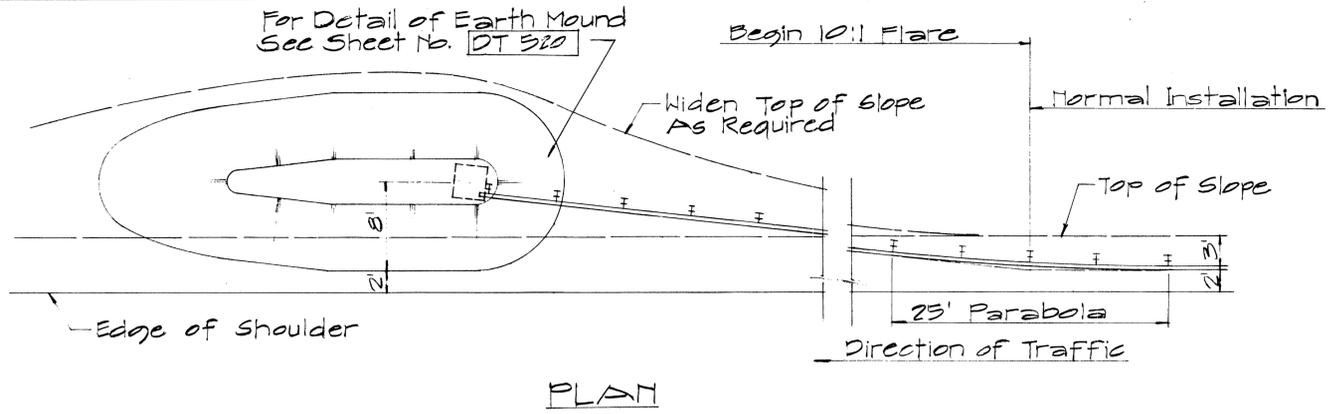

NOTE:
For detail of Breakaway Cable Terminal (BCT) See Sheet No. DT 510

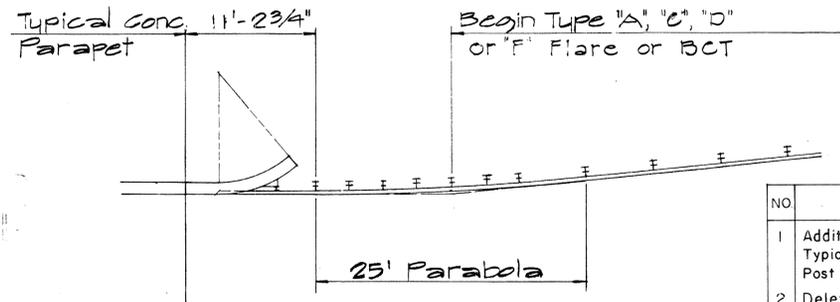

TYPICAL LAYOUT PLAN OF END POST CONNECTION

Sc. 1/8" = 1'-0"

NO	REVISION	APPROVED BY	DATE
1	Additional Posts Added to Typical Layout Plan Of End Post Connection	H.C.	4-12-72
2	Delete Type "B" Flare and Type "E" Flare	H.C.	6-15-78

APPROVAL RECOMMENDED:
Euschi Tanaka 12/29/69
TRAFFIC ENGINEER DATE

APPROVED:
John J. Seal 12-30-69
ASSISTANT CHIEF, ENGINEERING DATE

STATE OF HAWAII
DEPARTMENT OF TRANSPORTATION
HIGHWAYS DIVISION






STANDARD DETAILS
TRAILING END
FLARE - ONE & TWO
WAY ROADWAY

Scale: As Noted April 1969

DATE
DESIGNED BY
DRAWN BY
CHECKED BY
ORIGINAL PLAN
NOTE BOOK
No.


PRINTED ON NO. 1000H CLEARPRINT

FED. ROAD DIST. NO.	STATE	FED. AID PROJ. NO.	FISCAL YEAR	SHEET NO.	TOTAL SHEETS
HAWAII	HAW.	HES-0100(26)	1986	50	67

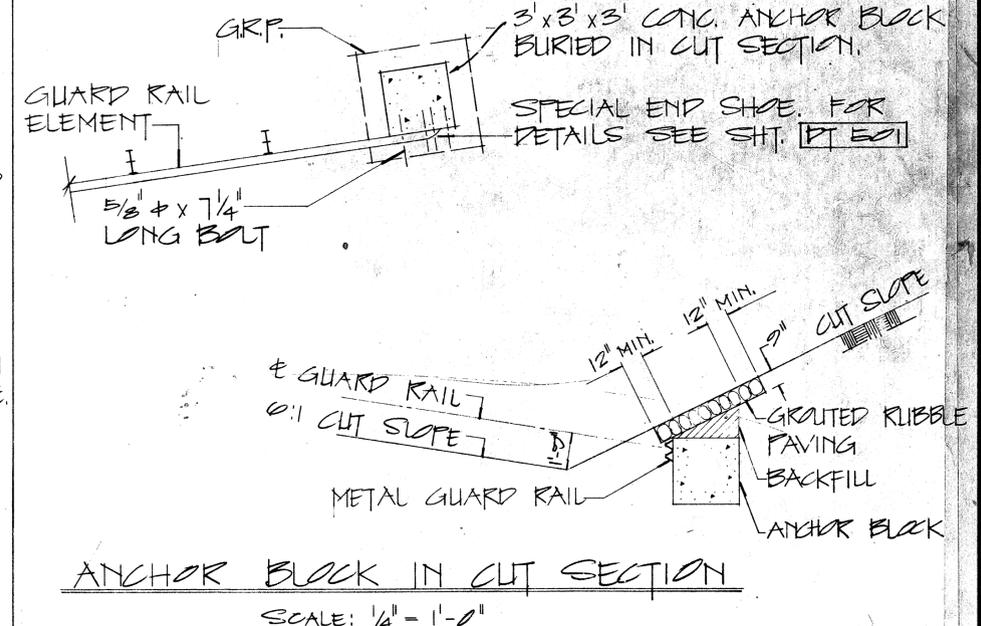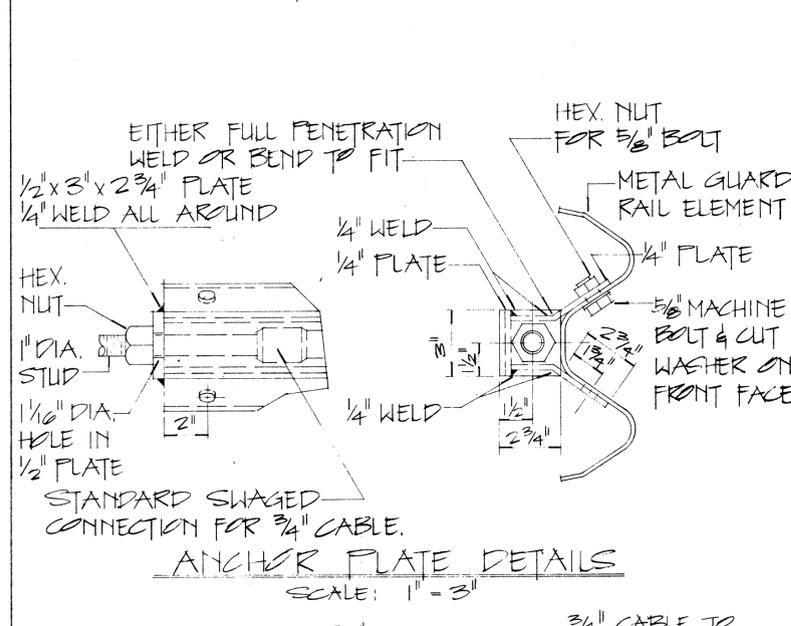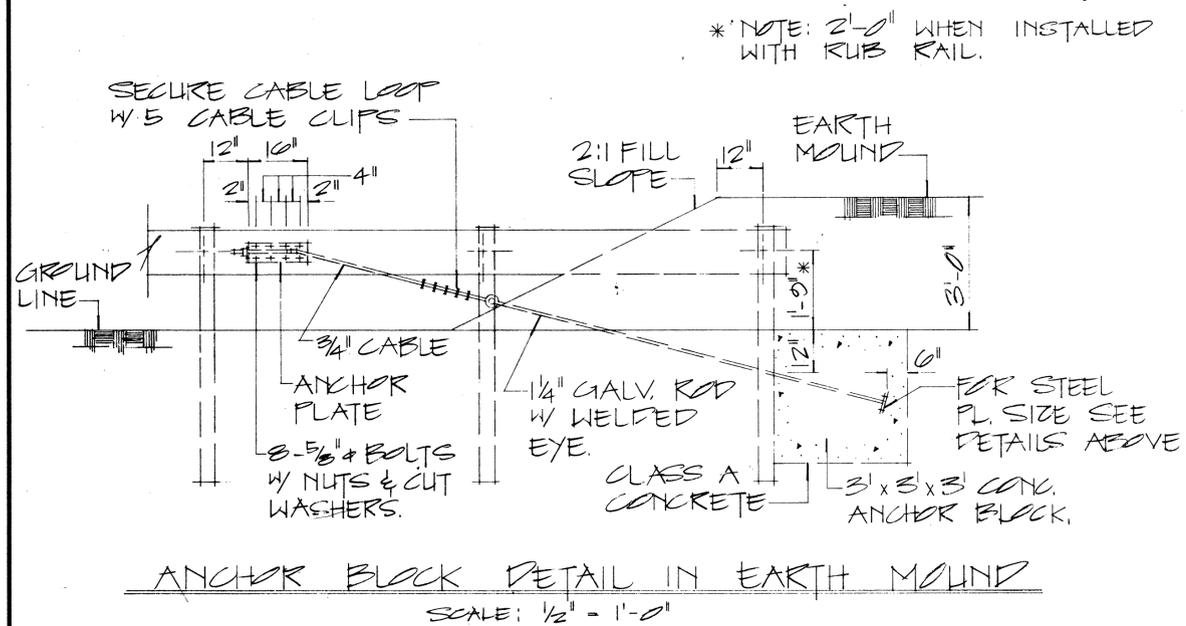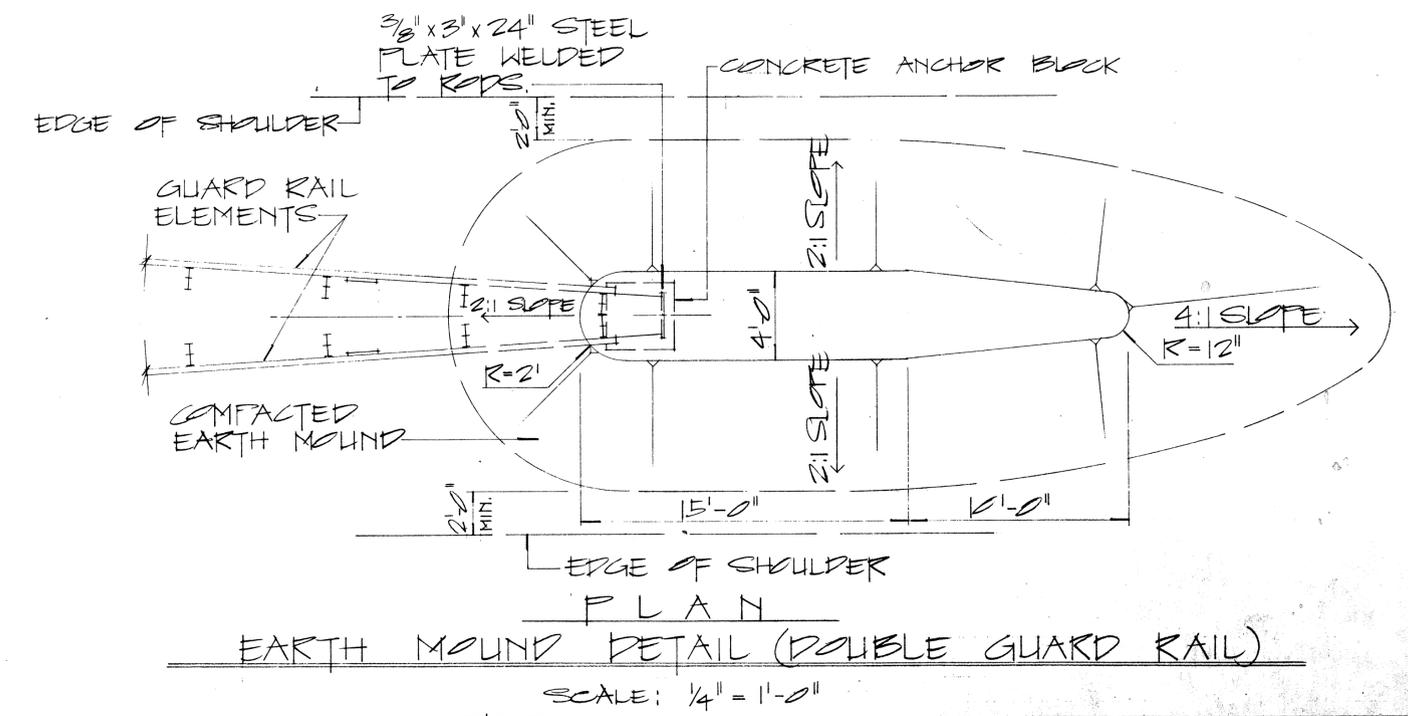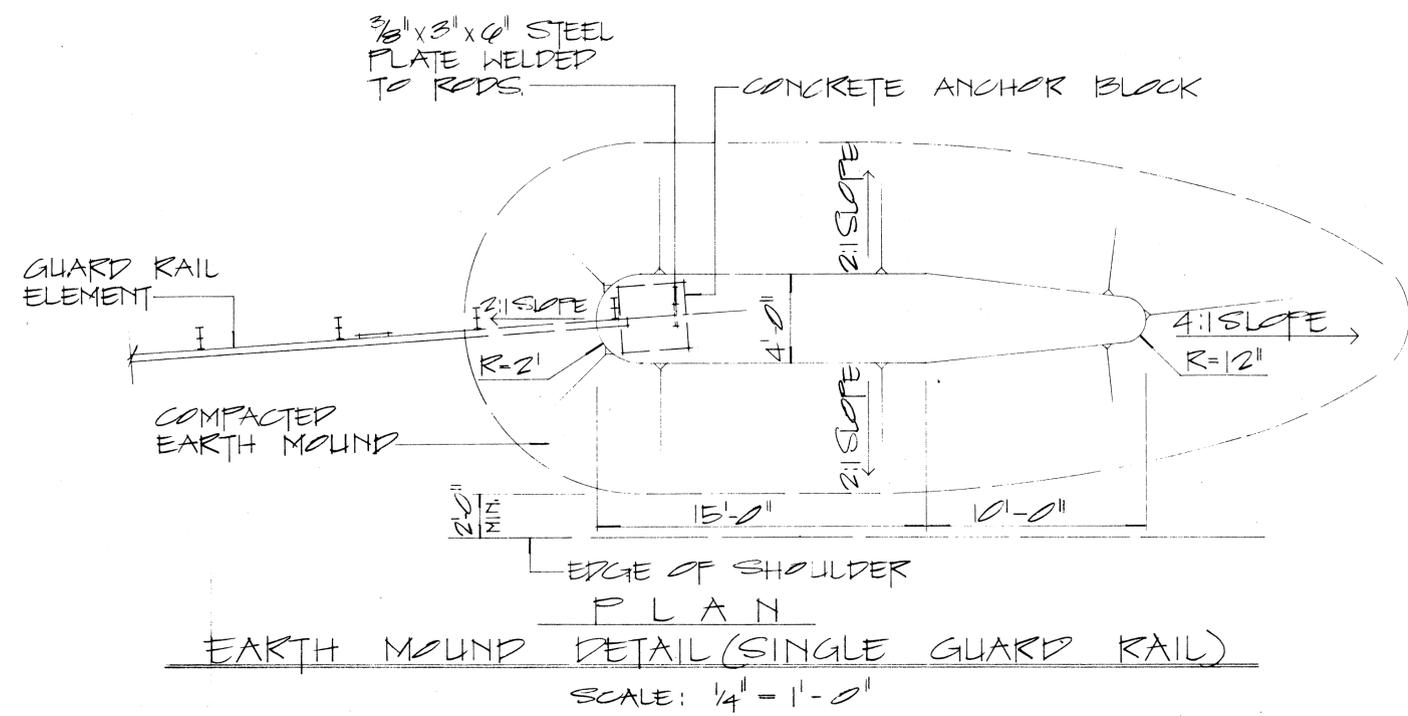

NOTE:

1. GALVANIZED ANCHOR ROD, METAL GUARD RAIL AND FAST BURIED IN GROUND SHALL BE COVERED WITH A MIN. 20-MIL THICKNESS OF COAL TAR ENAMEL CONFORMING TO AWWA STANDARD: C 203
2. CONCRETE, GRP, EXCAVATION, EARTH MOUND, ANCHOR RODS AND MISCELLANEOUS APPURTENANCES NECESSARY TO ANCHOR THE GUARD RAIL ENDS SHALL BE INCIDENTAL TO THE METAL GUARD RAIL.

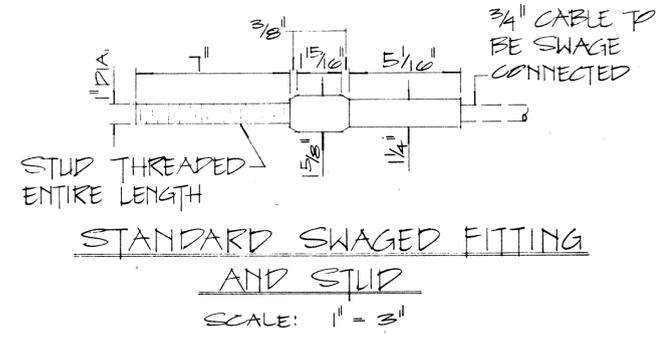

APPROVAL RECOMMENDED:
Eishi Tanaka 12/29/69
TRAFFIC ENGINEER DATE

APPROVED:
[Signature] 12-30-69
ASSISTANT CHIEF, ENGINEERING DATE

NO.	REVISION	APPROVED BY	DATE


STATE OF HAWAII
DEPARTMENT OF TRANSPORTATION
HIGHWAYS DIVISION

STANDARD DETAILS
EARTH MOUND AND ANCHOR BLOCK DETAILS


SCALE: AS SHOWN OCT 1969
SHEET No. OF SHEETS 50 OF 67

DATE
SURVEY PLOTTED BY
DRAWN BY
DESIGNED BY
NOTE BOOK
QUANTITIES BY
CHECKED BY


FED. ROAD DIST. NO.	STATE	FED. AID PROJ. NO.	FISCAL YEAR	SHEET NO.	TOTAL SHEETS
HAWAII	HAW.	HES-0100(28)	1986	51	61

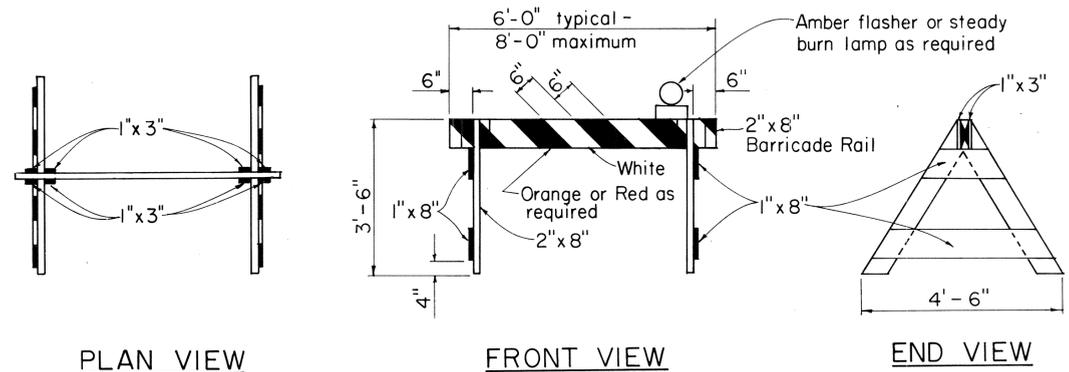

TYPE I BARRICADE
Scale: 1/2" = 1'-0"

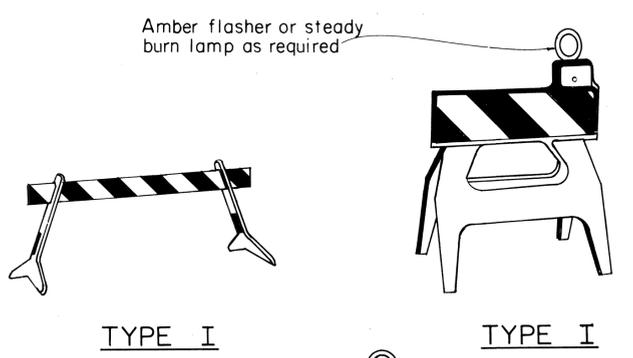


TYPE I TYPE I

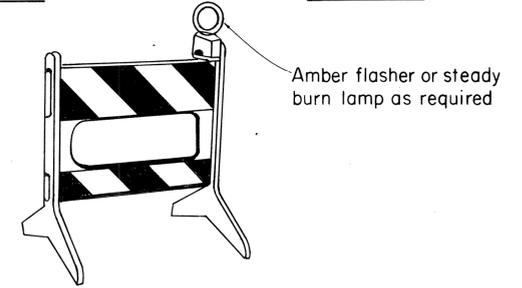


TYPE II

PLASTIC MOLDED BARRICADE OPTIONS*

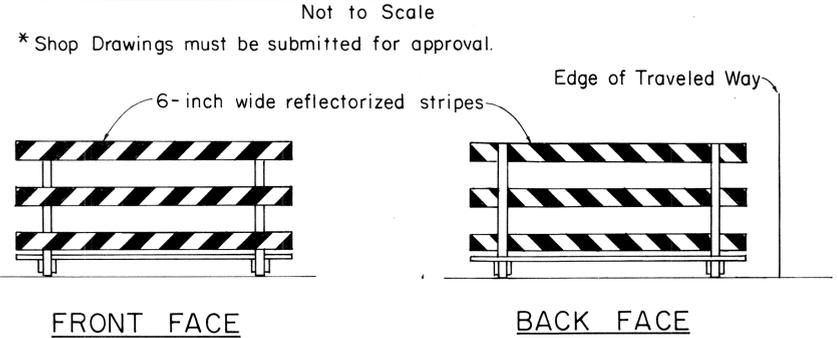


FRONT FACE BACK FACE


TYPICAL BARRICADE STRIPING DETAILS**

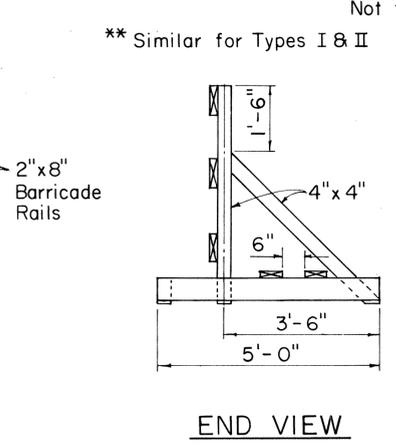


END VIEW

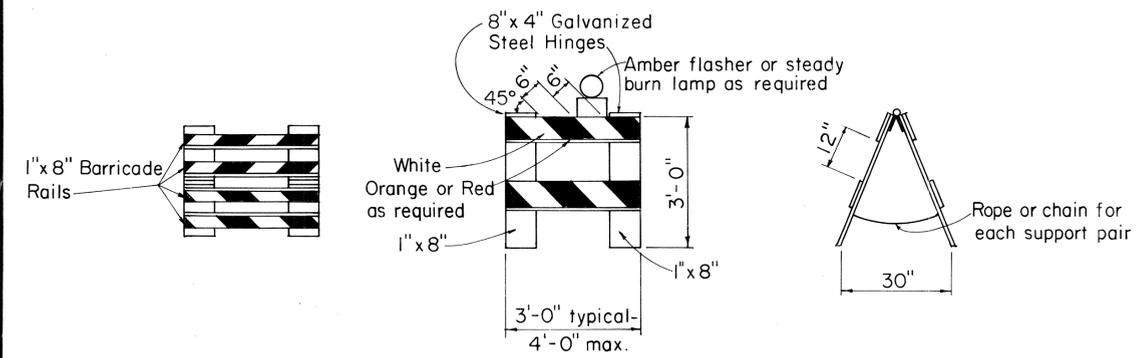

TYPE II BARRICADE
Scale: 1/2" = 1'-0"

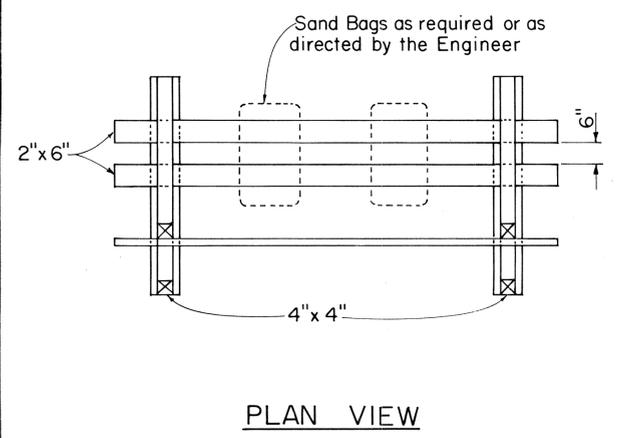

PLAN VIEW

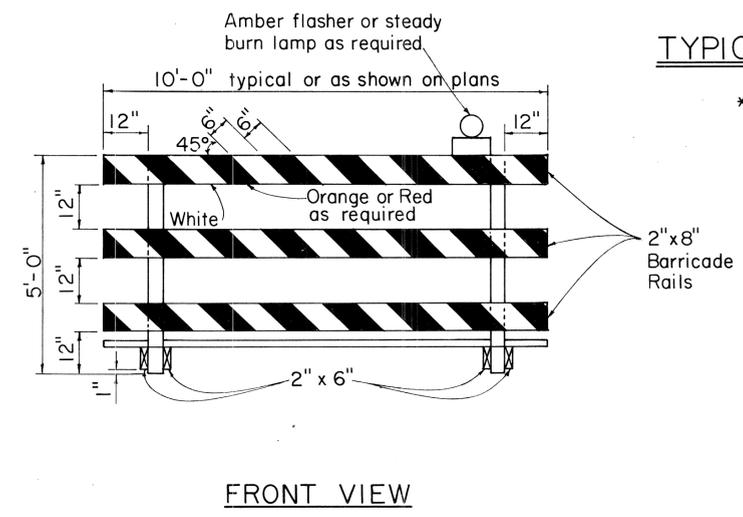

FRONT VIEW

TYPE III BARRICADE
Scale: 1/2" = 1'-0"

GENERAL NOTES

1. The front and back faces of each barricade rail shall be reflectorized with stripes sloping downward toward the same side (traveled way) of each barricade.
2. Contractor may submit alternate barricade designs for approval.
3. Sandbags or other approved weights shall not be placed on top of any striped rail.
4. The Contractor is directed to Section 626.

SURVEY PLOTTED BY	DATE
DRAWN BY	
DESIGNED BY	
NOTE BOOK	
QUANTITIES BY	
CHECKED BY	
No.	

APPROVAL RECOMMENDED:
Eiichi Tanaka 10/21/81
TRAFFIC ENGINEER DATE

APPROVED:
Shuhei S. Sato 10/23/81
ASSISTANT CHIEF, ENGINEERING DATE

NO.	REVISION	APPROVED BY	DATE
1	Supercedes DT 800 Approved 12/30/69	H.T.	10/23/81

STATE OF HAWAII
DEPARTMENT OF TRANSPORTATION
HIGHWAYS DIVISION

STANDARD DETAILS

BARRICADES

SCALE: As Shown

SHEET NO. OF SHEETS DT 800