#### STRUCTURAL GENERAL NOTES

- The existence and location of underground utilities, manholes, monuments and structures as shown on the plans are from the latest available data but the accuracy is not guaranteed. The encountering of other obstacles during the course of work is possible. The Contractor shall be held liable for any damages incurred to the existing facilities and/or improvements as a result of his operations.
- 2. All welding -- whether shop or field -- shall be done by certified welders only.
- 3. Discrepancies contractor shall verify all dimensions and conditions and shall report any discrepancies in writing to the contracting officer before commencing work or ordering materials.
- Details shown on drawings shall be typical for all similar conditions. modify details for special conditions as directed by the Engineer.

#### FOUNDATION AND EARTHWORK NOTES

- 1. These foundation and earthwork notes are based on recommendations contained in a report titled "Geotechnical Engineering Services Queen Kaahumanu Highway Widening Kealakehe Parkway to Keahole Airport Road, Phase 2" by Geolabs, Inc. dated May 13, 2011. These documents shall be considered a part of the construction documents and it's recommendations implemented unless otherwise directed by the geotechnical engineer.
  - a. Static lateral earth pressures (all limit states unless noted otherwise):

3 - Soil Unit Weight of Compacted Fill = 140 Pcf

- Soil Unit Weight Used for Resisting Another Force = 120 Pcf
- Active earth pressure (Level Backfill) = 30 Pcf
- At rest earth pressure = 50 Pcf
- Active earth pressure (Max. 2H:1V Sloping Backfill) = 36 Pcf
- At rest earth pressure (Max. 2H:1V Sloping Backfill) = 54 Pcf
- Passive earth pressure = Strength Event = 320 Pcf
- Passive earth pressure = Extreme Event = 640 Pcf

 $\frac{\sqrt{3}}{b}$ 

Dynamic (Seismic) lateral earth pressures:

- Retaining Wall A Seismic earth load for H8 Wall = 3,050 lb/ft

H12 Wall = 4,950 lb/ft

H16 Wall = 5,800 lb/ft

H20 Wall = 6,550 lb/ft

- Retaining Wall A1 (Culvert B) Seismic earth load for H4 Wall = 2,750 lb/ft

H6 Wall = 3,450 lb/ft

H8 Wall = 4,000 lb/ft

H10 Wall = 4,550 lb/ft

H12 Wall = 5,300 lb/ft

H14 Wall = 5,300 lb/ft

H16 Wall = 5,100 lb/ft

H18 Wall = 4,550 lb/ft

#### FOUNDATION AND EARTHWORK NOTES CONTINUED

- Retaining Wall E Seismic earth load for H8 Wall = 1,150 lb/ft H12 Wall = 3,150 lb/ft H16 Wall = 4,950 lb/ft

H20 Wall = 10,900 lb/ft

- Retaining Wall F Seismic earth load for

H4 Wall = 620 lb/ft H6 Wall = 1,200 lb/ft H8 Wall = 1,050 lb/ft

H10 Wall = 1,650 lb/ft

- Retaining Wall G Seismic earth load for H6 Wall = 2,200 lb/ft

H10 Wall = 2,970 lb/ft

- Culvert L Seismic earth load for

All Walls = 1,500 lb/ft

- c. Bearing Capacity
  - a. 4,000 Psf (Service Load Case)
  - b. 6,000 Psf (Strength Load Case)
  - c. 13,000 Psf (Extreme Event Load Case)
- Coefficient of Friction  $\frac{\sqrt{3}}{3}$
- a. Strength Limit State = 0.53
- b. Extreme Event Limit State = 0.67
- e. Backfill should consist of granular backfill with a maximum particle size less than 3", extending a minimum of 3 feet laterally behind retaining walls, placed in lifts not exceeding 12" and moisture conditioned and compacted to 95% relative maximum dry density. The top 12" of fill behind retaining walls shall be relatively impervious material.

#### CONCRETE NOTES

- 1. Portland cement shall conform to ASTM C150, Type I Or Type II
- 2. All concrete shall develop the following minimum compressive strengths, with corresponding maximum size of aggregates and water cement ratios as follows (unless shown elsewhere in schedules):

	Element	Strength	Maximum Size (Inch) Aggregate	Water/Cement Ratio
a.	Headwall / Conc. Collar / Apron / Cutoff Wall	4000	3/4	<b>.</b> 45

- 3. Admixtures: use of admixture at contractor's option, but subject to contracting officer approval.
- 1. The use of any calcium chloride in any concrete is prohibited.
- 5. Minimum concrete clear cover unless specified otherwise in drawings
  - a. Concrete Cast Directly 3 Against Earth
  - b. All Other Concrete

2"

FED. ROAD DIST. NO.	STATE	FED. AID PROJ. NO.	FISCAL YEAR	SHEET NO.	TOTAL SHEETS
HAWAII	HAW.	NH-019-1(38)R	2016	494	528 522

#### REINFORCING STEEL NOTES

- Reinforcing bars shall conform to ASTM A615 for Deformed Steel Bars and ASTM A1060 for Welded Wire Reinforcement. Strength: unless otherwise noted, all reinforcing bar shall be;
  - a. Deformed bar . . . . . 60 ksi
  - b. Welded wire fabric . . . . 70 ksi
- Reinforcing bar hooks and bends shall be in accordance with ACI318-05

#### <u>ABBREVIATIONS</u>

CAP Corrugated Aluminum Pipe E.W. Each Way

C.I.P. Cast In Place Galv. Galvanized

CMP Corrugated Metal Pipe Thk. Thick

Conc. Concrete Typ.. Typical

CRM Concrete Rubble Masonry Vert. Vertical

Dia. Diameter V.I.F. Verify In Field

#### LEGEND FOR AS-BUILT POSTINGS

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Roadway Text for as-built posting

12/16/16

Added Updated Seismic Lateral Soil
Loads for Retainging Walls A, AI, E, F,
G and Culvert L. Modified Soil Unit
Weights and Friction Coefficients.

1/22/16

Added a note on reinforcement hooks
and bends

PEVISION

state of hawaii DEPARTMENT OF TRANSPORTATION highways division

GENERAL NOTES

QUEEN KAAHUMANU HIGHWAY WIDENING Kealakehe Pkwy. To Keahole Airport Rd. (Ph. 2) Federal Aid Project No. NH-019-1(38)R

Scale: AS NOTED Date: AUGUST 2016

SHEET No. S-1.1 OF 18 SHEETS

"AS-BUILT"

**SIGNATURE** 

∖NO. 10304-S/

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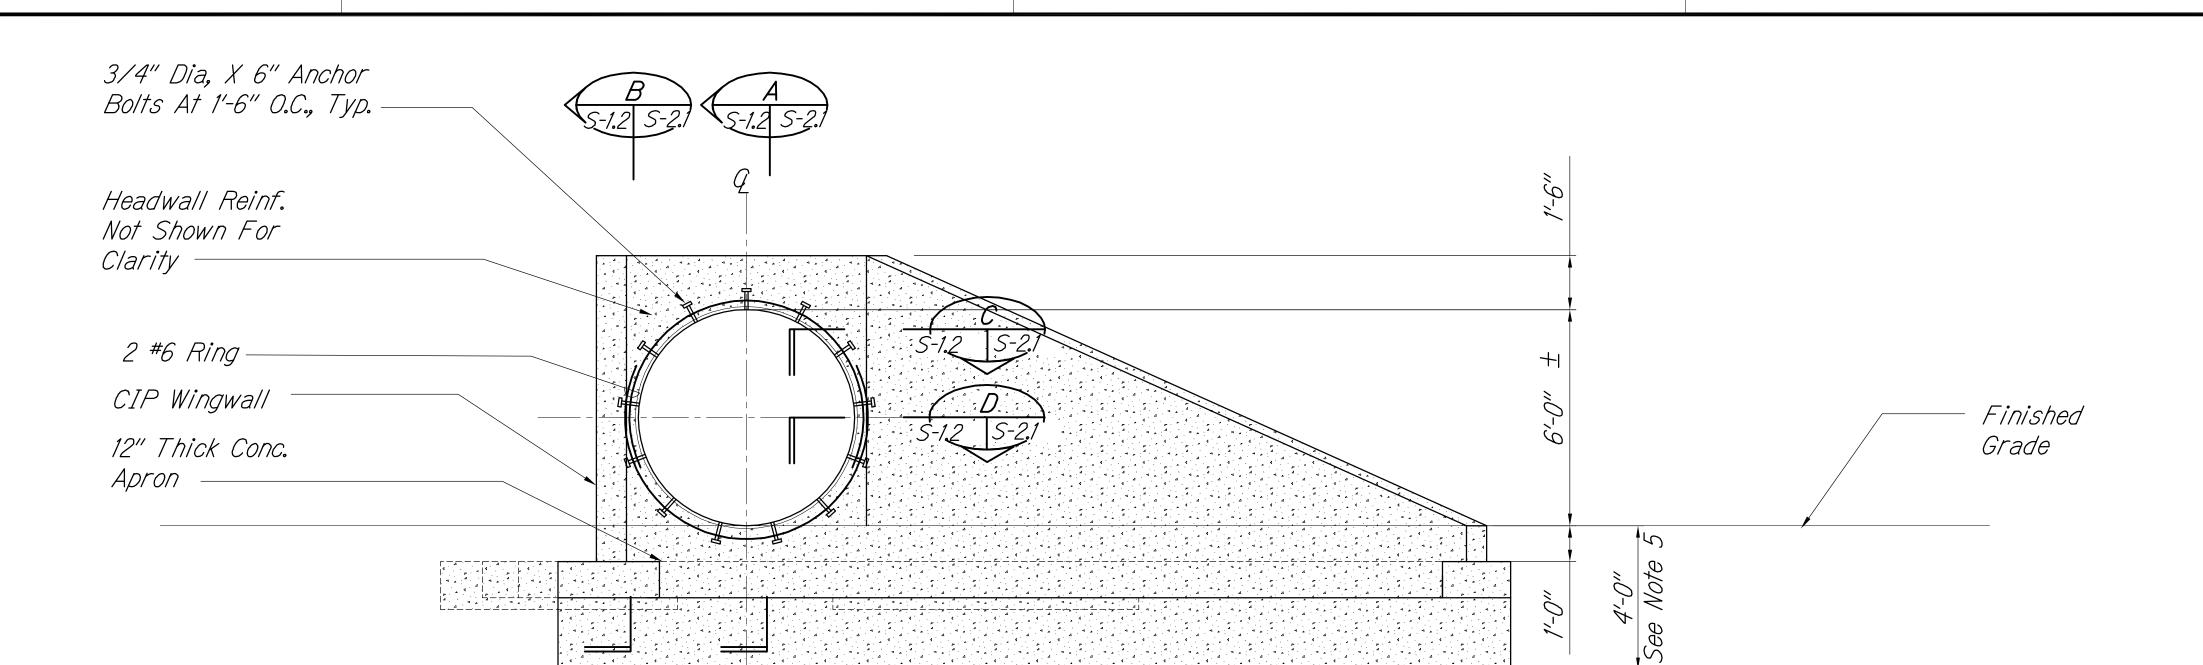
APRIL 30, 2018

EXPIRATION DATE

OF THE LICENSE

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494



ELEVATION - NEW HEADWALL FOR 72" DIA. CAP CULVERT Scale: 3/8" = 1'-0"

See CIP Conc. Retaining 72" Dia. CAP Wall Section A/S-2.3 10" thk. CIP Wingwall See CIP Conc. Retaining Wall Section A/S-2.3 5-3′-8″ HB 138. 10" X, 2, Toe of Slope

PLAN - NEW HEADWALL FOR 72" DIA. CAP CULVERT

10" thk. CIP Wingwall

2. Contractor Shall Coordinate Minimum Cover Over CAP Culvert Required For

3. Heavy Compacting Equipment Shall Not Be Used Directly Over CAP Culvert.

Manufacturer's Instructions

5. Cutoff Wall Depth Shall be 4' as Shown or to Solid Basalt, Whichever is Less, But Not Less Than 2'.

#### Notes:

1. Stud Bolts Shall Be Stainless Steel (See C/S-2.4). Hot Dip Galvanized Bolts with Neoprene Washers and Sleeves are Acceptable, Provided it Does Not Affect the Manufacturer's Warranty.

FED. ROAD DIST. NO.

- Construction Equipment Used With Culvert Manufacturer.
- 4. Balance Culvert Backfill Per

#### LEGEND FOR AS-BUILT POSTINGS

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as-built deletion

FISCAL SHEET TOTAL YEAR NO. SHEETS

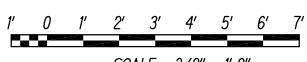
495

FED. AID PROJ. NO.

HAW. *NH-019-1(38)R* 2016

Text for as-built Roadway posting

GRAPHIC SCALES



SCALE: 3/8" = 1'-0"

STATE OF HAWAII
DEPARTMENT OF TRANSPORTATION
HIGHWAYS DIVISION

CULVERT E - 72" CAP PLAN AND ELEVATION

QUEEN KAAHUMANU HIGHWAY WIDENING

<u>Kealakehe Pkwy. To Keahole Airport Rd. (Ph. 2)</u> Federal Aid Project No. NH-019-1(38)R Scale: AS NOTED Date: AUGUST 2016

SHEET No. S-1.2 OF 18 SHEETS

12" Thk. Conc. Apron and Cutoff Wall

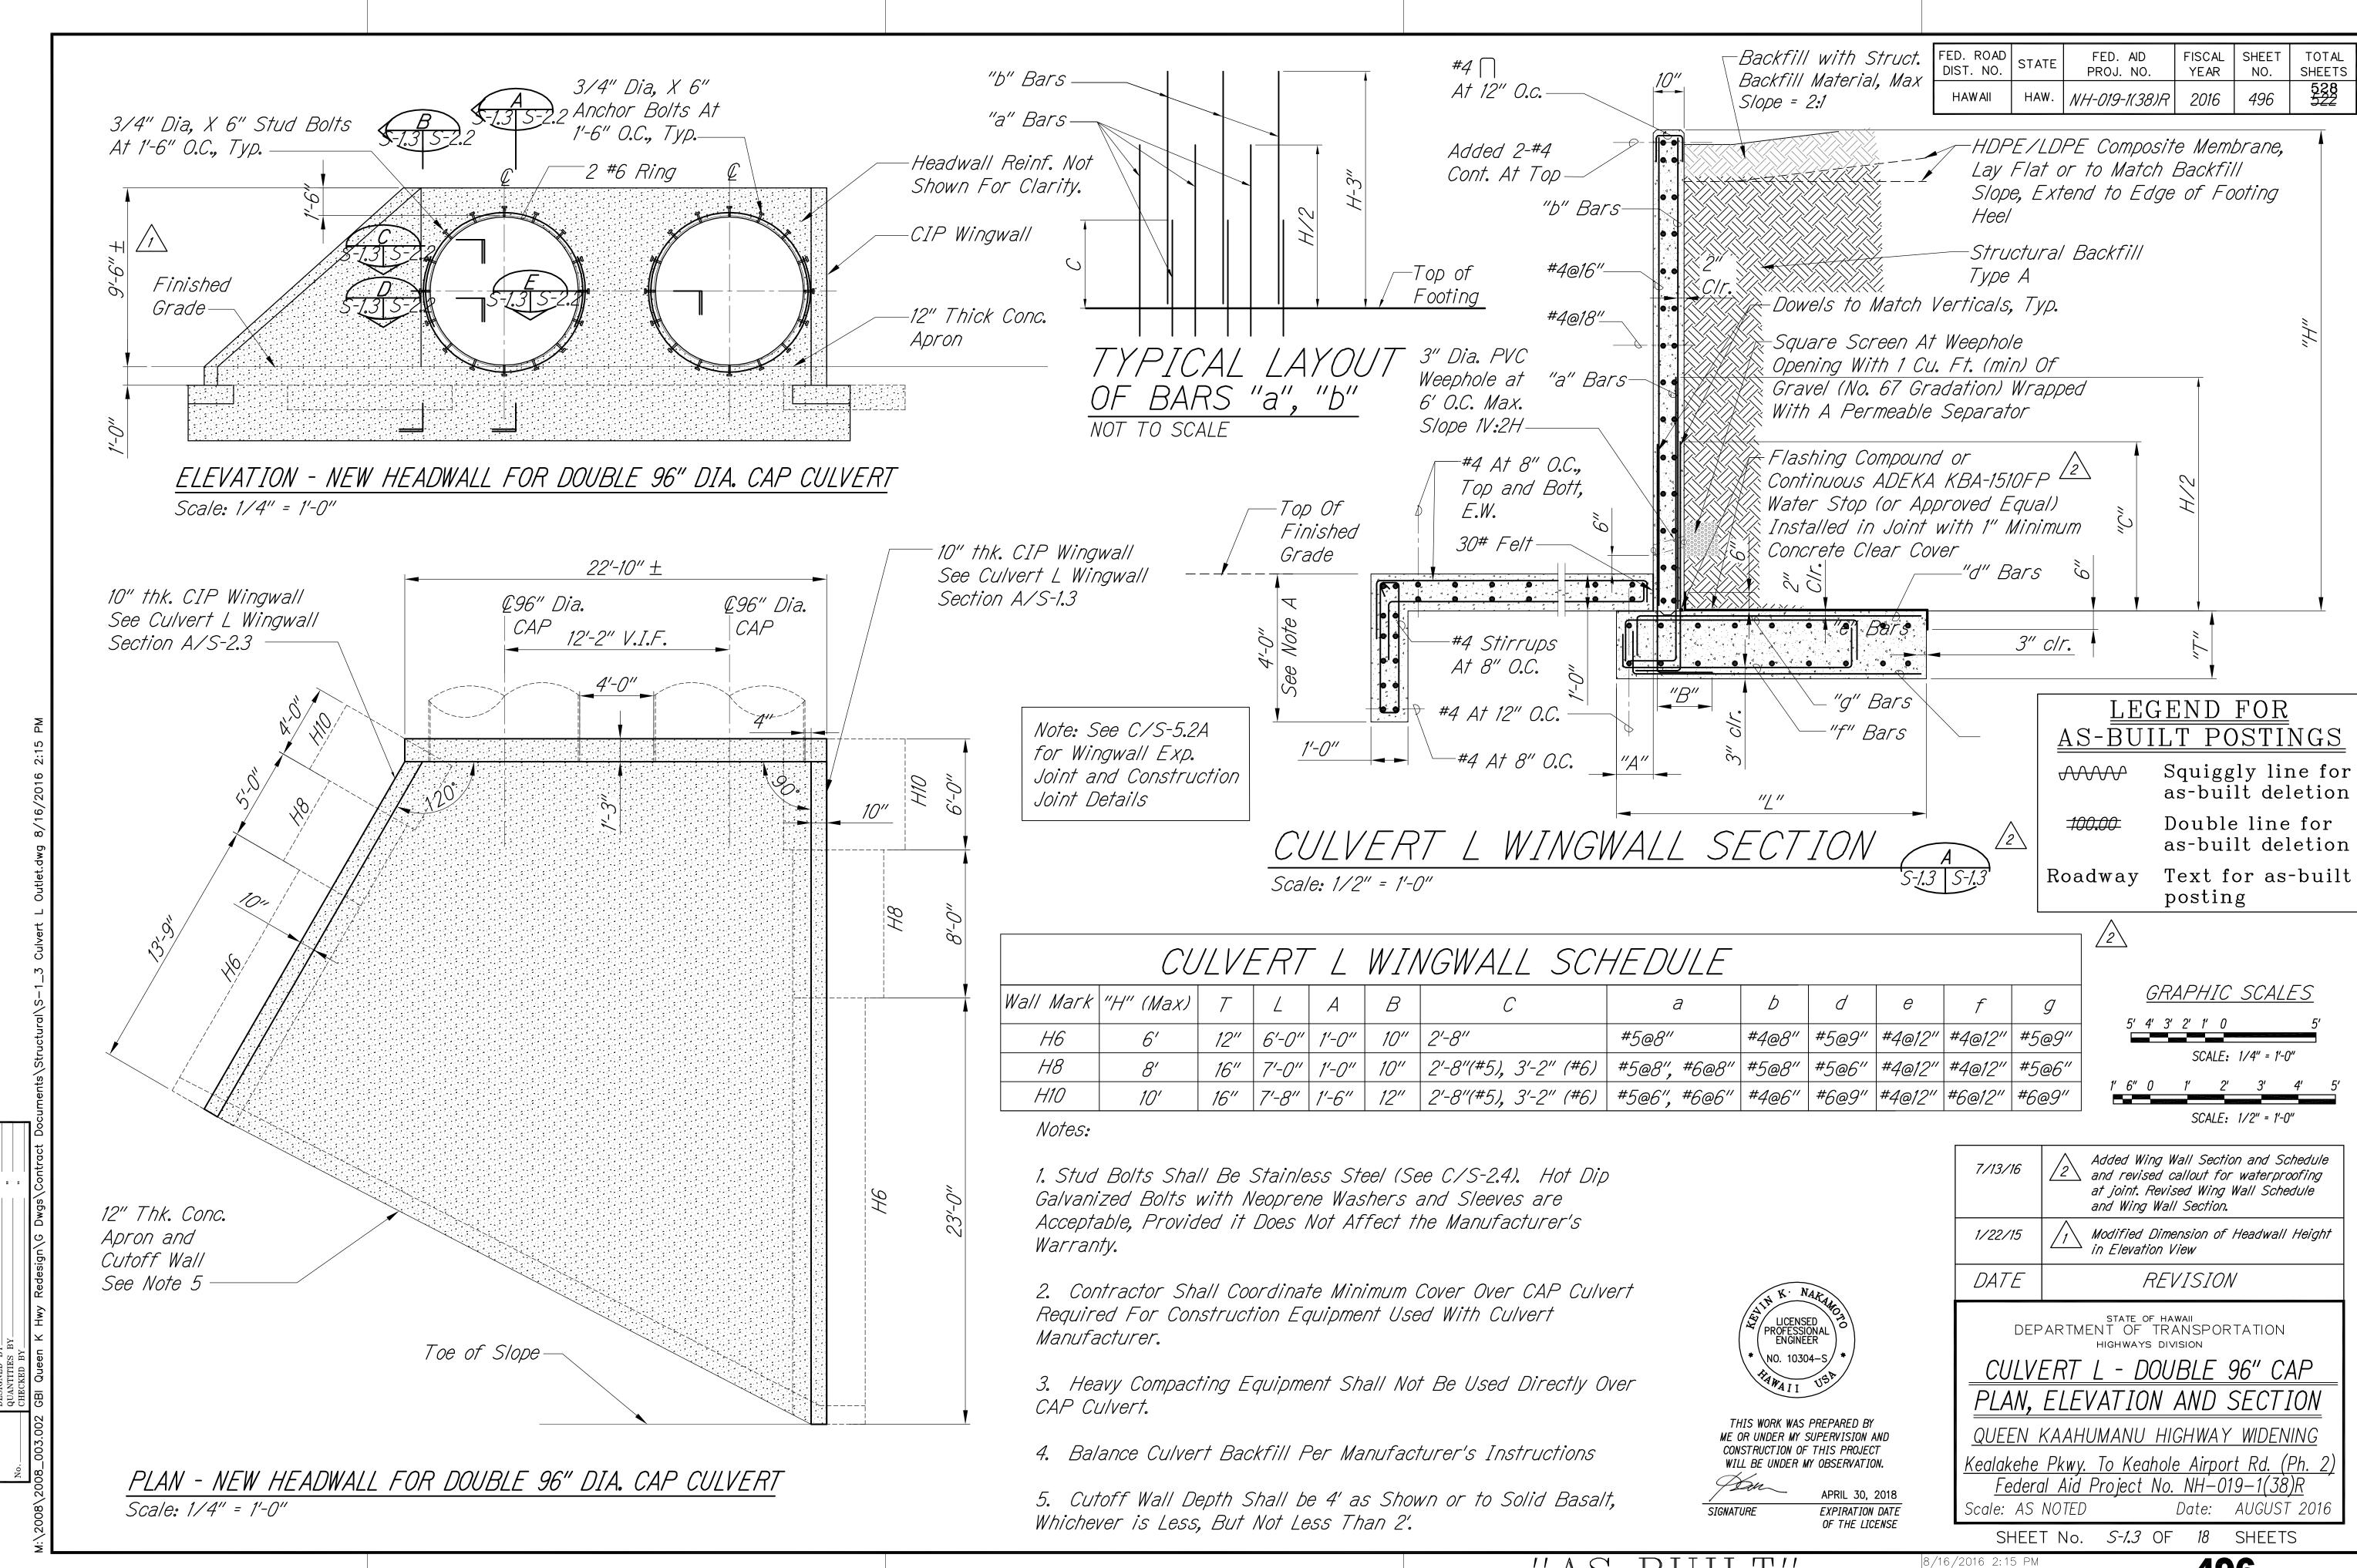
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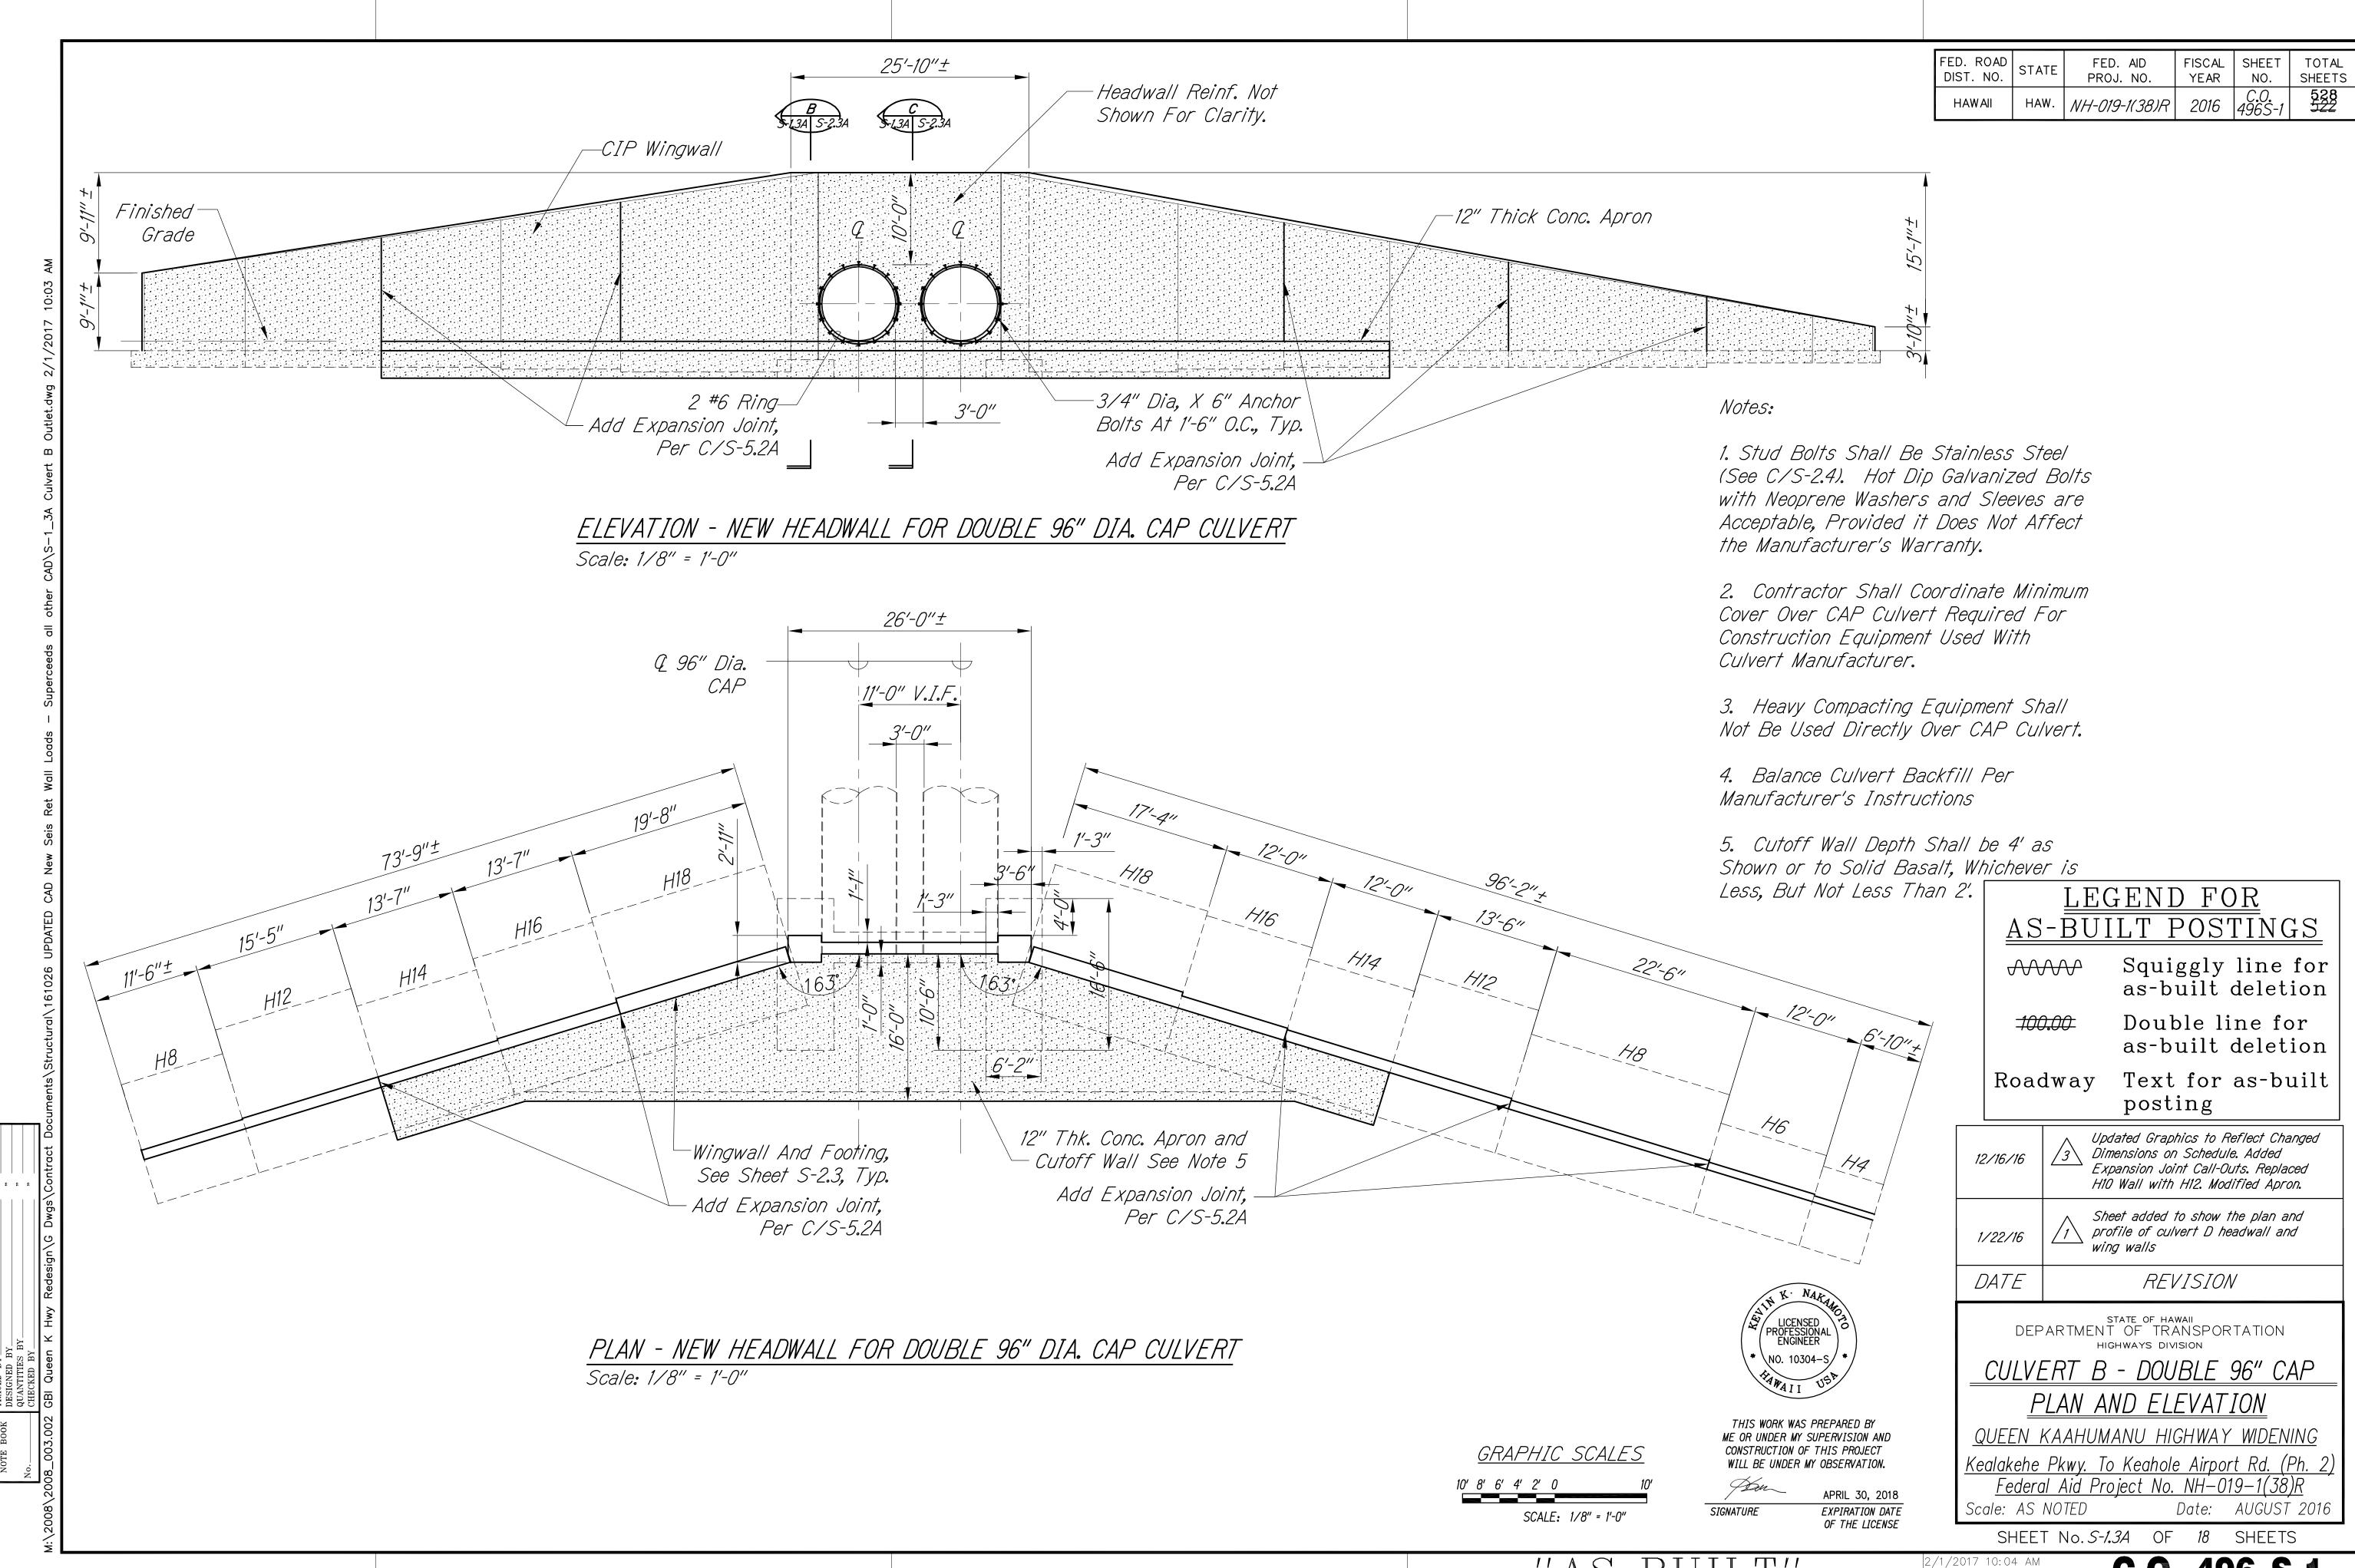
SIGNATURE

APRIL 30, 2018 EXPIRATION DATE OF THE LICENSE

Scale: 3/8" = 1'-0"

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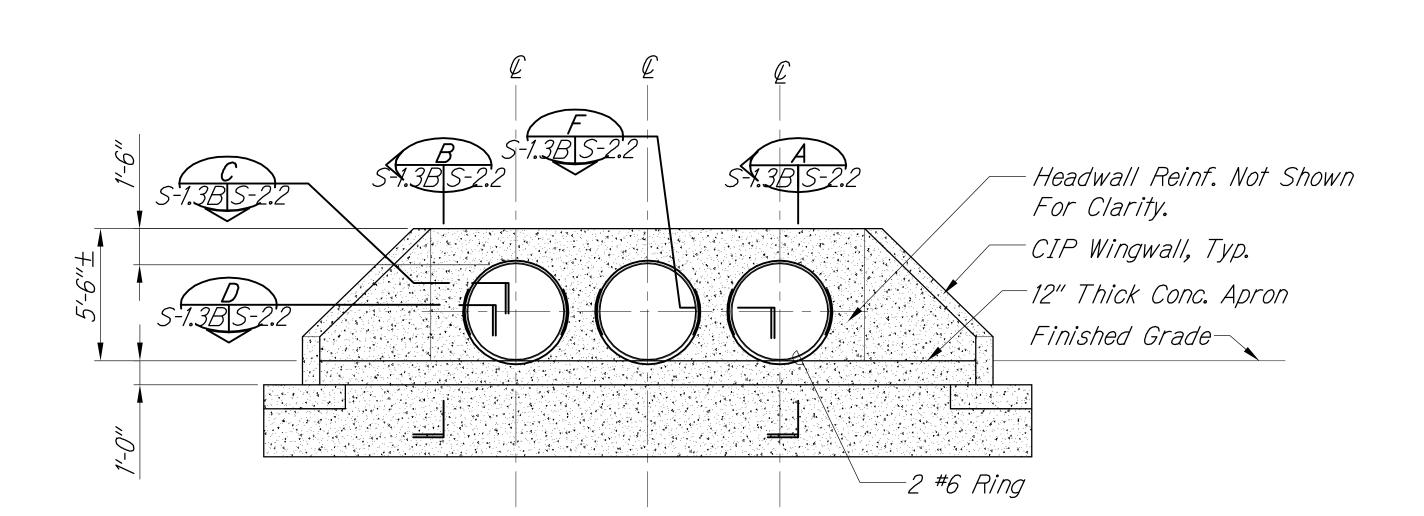


C.O. 496 S-1


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ט.		PROJ. NO.	ILAR	NO.	SUFFIS
HAWAII	HAW.	NH-019-1(38)R	2016	C.O. 496S-2	528 522



- 1. Contractor Shall Coordinate Minimum Cover Over HDPE Culvert Required For Construction Equipment Used With Culvert Manufacturer.
- 2. Heavy Compacting Equipment Shall Not Be Used Directly Over HDPE Culvert.
- 3. Balance Culvert Backfill Per Manufacturer's Instructions
- 4. Cutoff Wall Depth Shall be 4' as Shown or to Solid Basalt, Whichever is Less, But Not Less Than 2'.
- 5. For HDPE Culvert to Headwall Connection, Refer to Similar Details on Sheet S-2.2. Stud Bolts Not Required for HDPE



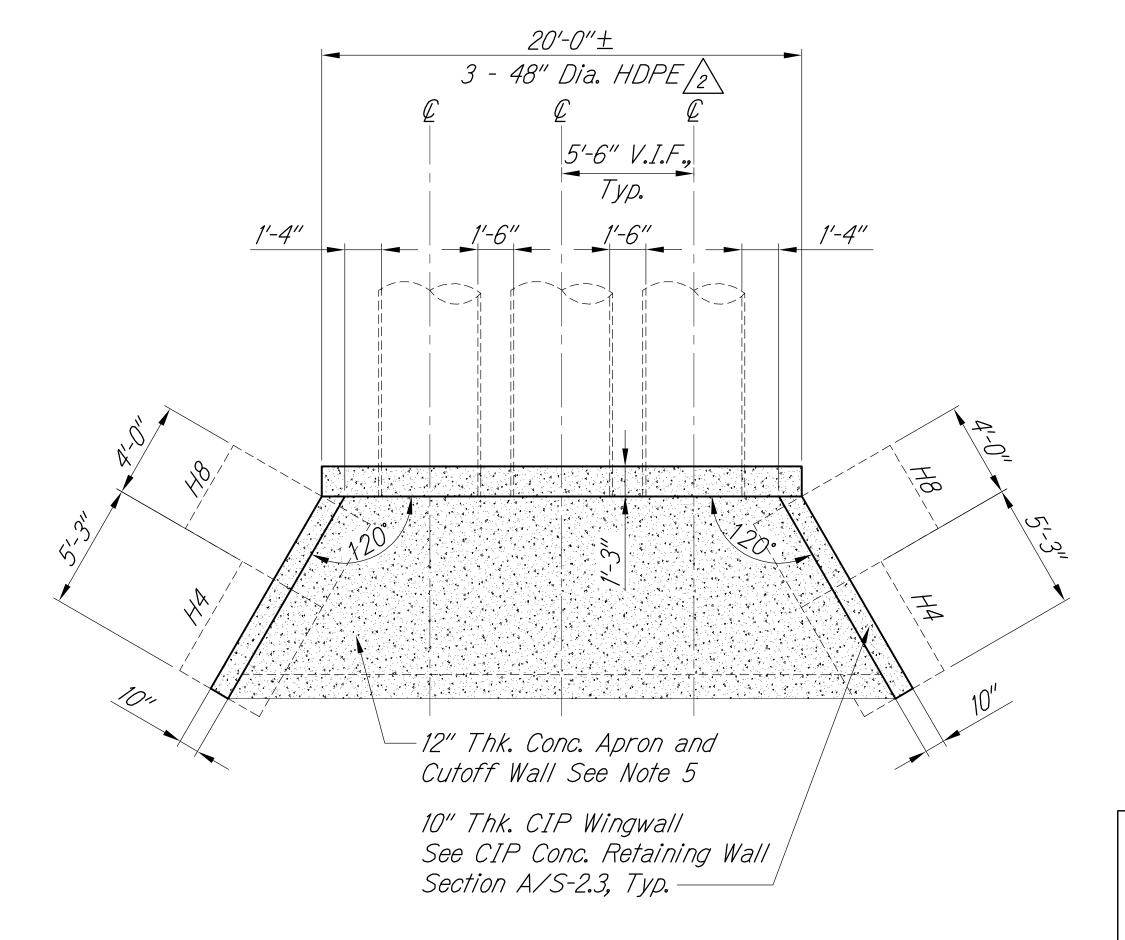ELEVATION - NEW HEADWALL FOR TRIPLE 48" DIA. HDPE CULVERT Scale: 1/4" = 1'-0"



PLAN - NEW HEADWALL FOR TRIPLE 48" DIA. HDPE CULVERT Scale: 1/4" = 1'-0"



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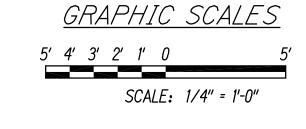
Roadway Text for as-built posting



CONSTRUCTION OF THIS PROJECT WILL BE UNDER MY OBSERVATION. Hun\_ APRIL 30, 2018 SIGNATURE EXPIRATION DATE

OF THE LICENSE

3/19/2016 10:06 AM



Changed CAP pipe to HDPE pipe and removed stud bolts 2/23/16 Sheet added to show the plan and profile of Culvert D headwall and 1/22/16 wingwalls REVISION DATE

> STATE OF HAWAII
> DEPARTMENT OF TRANSPORTATION HIGHWAYS DIVISION

#### CULVERT D - TRIPLE 48" HDPE PLAN AND ELEVATION

QUEEN KAAHUMANU HIGHWAY WIDENING

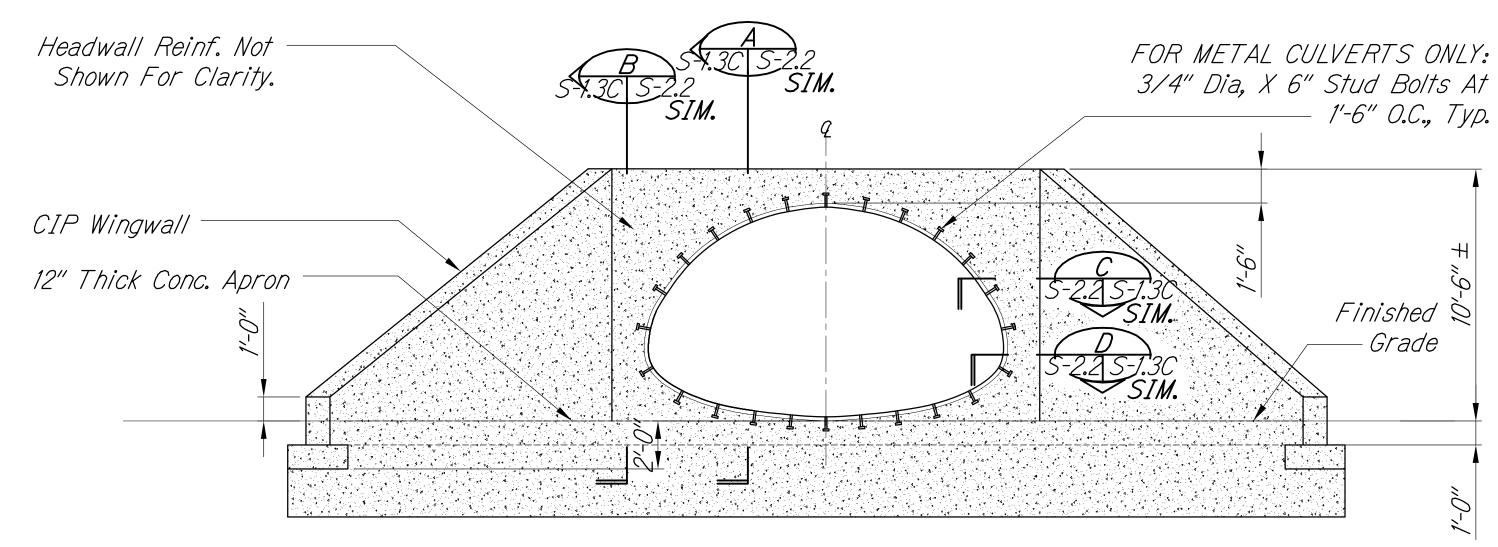
Kealakehe Pkwy. To Keahole Airport Rd. (Ph. 2) Federal Aid Project No. NH-019-1(38)R Scale: AS NOTED Date: AUGUST 2016

SHEET No. S-1.3B OF 18 SHEETS

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C.O. 496 S-2

FED. ROAD DIST. NO. FISCAL SHEET TOTAL YEAR NO. SHEETS FED. AID PROJ. NO. HAW. NH-019-1(38)R 2016 C.O. 528




#### ELEVATION - NEW HEADWALL FOR 15'X9' ARCH CULVERT Scale: 1/4" = 1'-0"

19'-10"± 10" thk. CIP Wingwall See CIP Conc. Retaining Wall € 15'X9' Arch Section A/S-2.3 Drainline H2. Toe of Slope 12" Thk. Conc. Apron and Cutoff Wall PLAN - NEW HEADWALL FOR 15'X9' ARCH CULVERT See Note 5 Scale: 1/4" = 1'-0"

#### Notes:

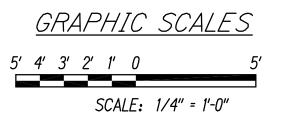- 1. Stud Bolts Shall Be Stainless Steel with Neoprene Washers and Sleeves (See C/S-2.4). Hot Dip Galvanized Bolts with Neoprene Washers and Sleeves are Acceptable, Provided it Does Not Affect the Manufacturer's Warranty.
- 2. Contractor Shall Coordinate Minimum Cover Over CAP Culvert Required For Construction Equipment Used With Culvert Manufacturer.
- 3. Heavy Compacting Equipment Shall Not Be Used Directly Over CAP Culvert.
- 4. Balance Culvert Backfill Per Manufacturer's Instructions
- 5. Cutoff Wall Depth Shall be 4' as Shown or to Solid Basalt, Whichever is Less, But Not Less Than 2'.



LEGEND FOR AS-BUILT POSTINGS

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Roadway Text for as-built posting

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APRIL 30, 2018 SIGNATURE EXPIRATION DATE

OF THE LICENSE

Sheet added to show the plan and profile of Culvert G headwall and 1/22/16 wingwalls REVISION DATE

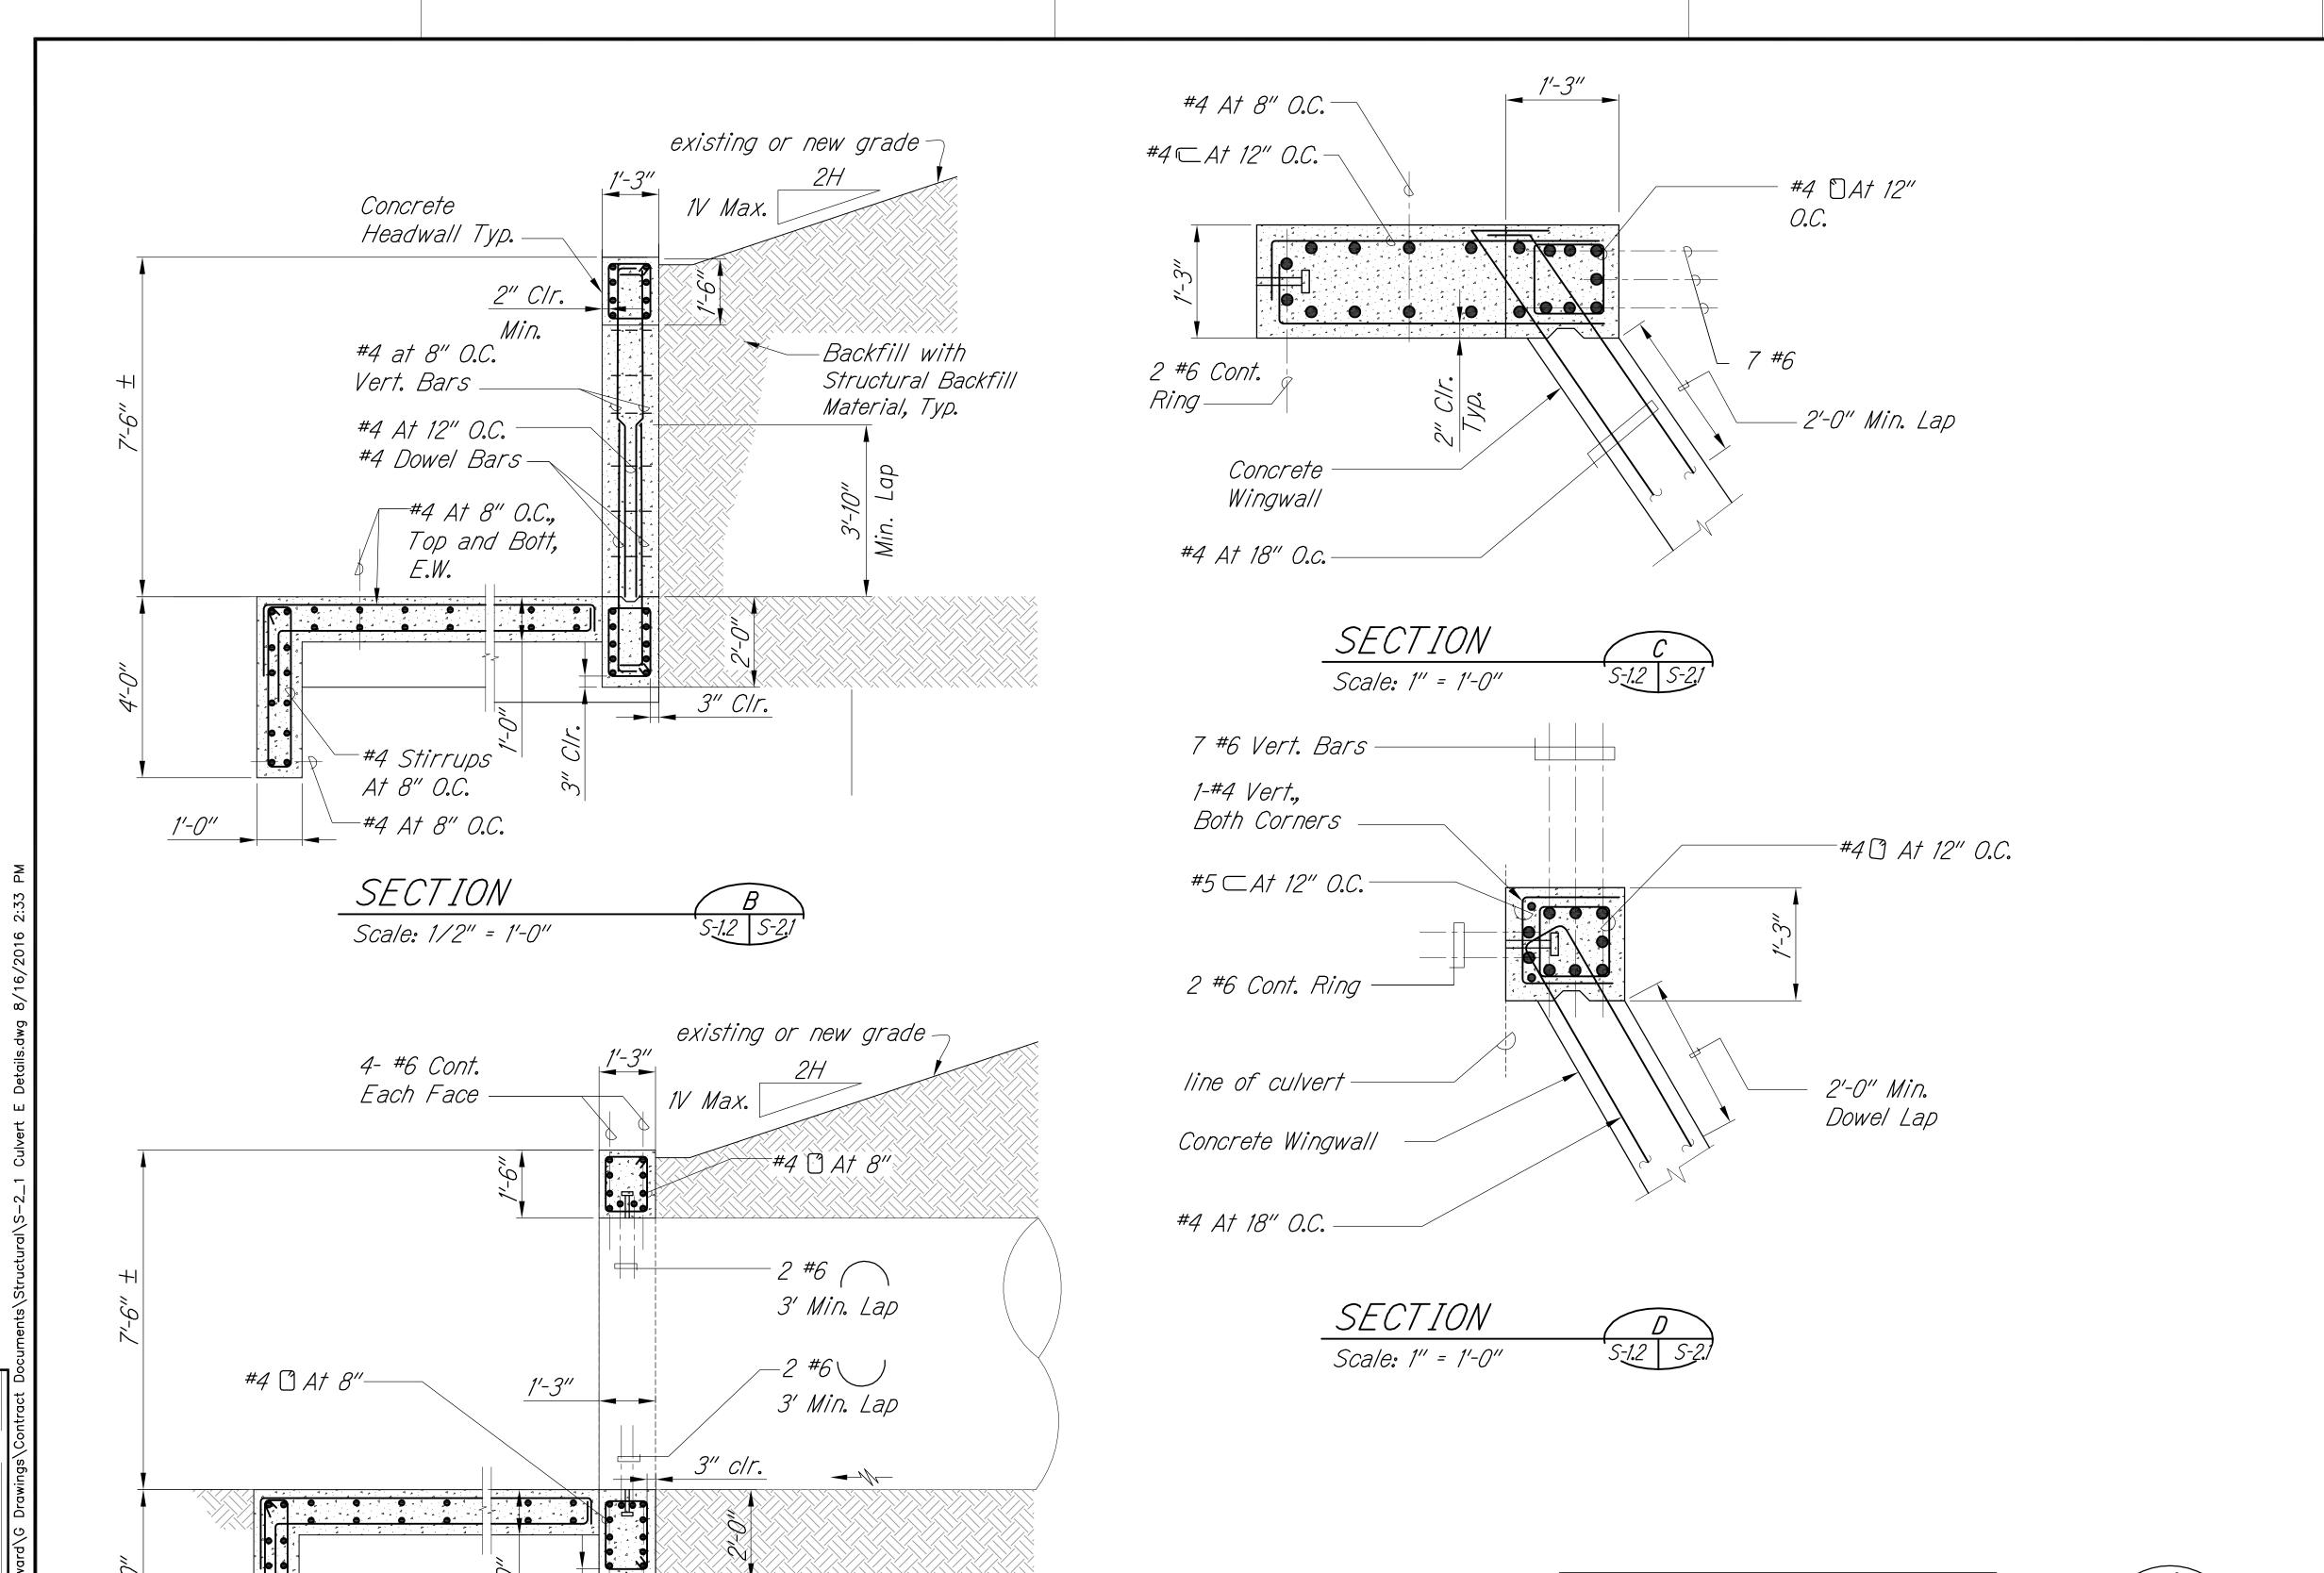
STATE OF HAWAII
DEPARTMENT OF TRANSPORTATION HIGHWAYS DIVISION

CULVERT G - 15'X9' ARCH PLAN AND ELEVATION

QUEEN KAAHUMANU HIGHWAY WIDENING

Kealakehe Pkwy. To Keahole Airport Rd. (Ph. 2) Federal Aid Project No. NH-019-1(38)R Scale: AS NOTED Date: AUGUST 2016

SHEET No. S-1.3C OF 18 SHEETS



-5- #6 Cont.

Each Face

S-1.2 S-2.1

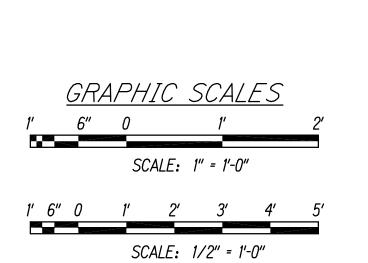
See Section B

for Cutoff Wall

SECTION

Scale: 1/2" = 1'-0"

Reinforcing



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APRIL 30, 2018

STATE OF HAWAII
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HIGHWAYS DIVISION

#### <u>CULVERT E</u> SECTION AND DETAILS

QUEEN KAAHUMANU HIGHWAY WIDENING

Kealakehe Pkwy. To Keahole Airport Rd. (Ph. 2)
Federal Aid Project No. NH-019-1(38)R
Scale: AS NOTED Date: AUGUST 2016

SHEET No. *S-2.1* OF *18* SHEETS

8/16/2016 2:33 PM

FED. ROAD DIST. NO.

HAWAII

FISCAL SHEET YEAR NO.

497

2016

FED. AID PROJ. NO.

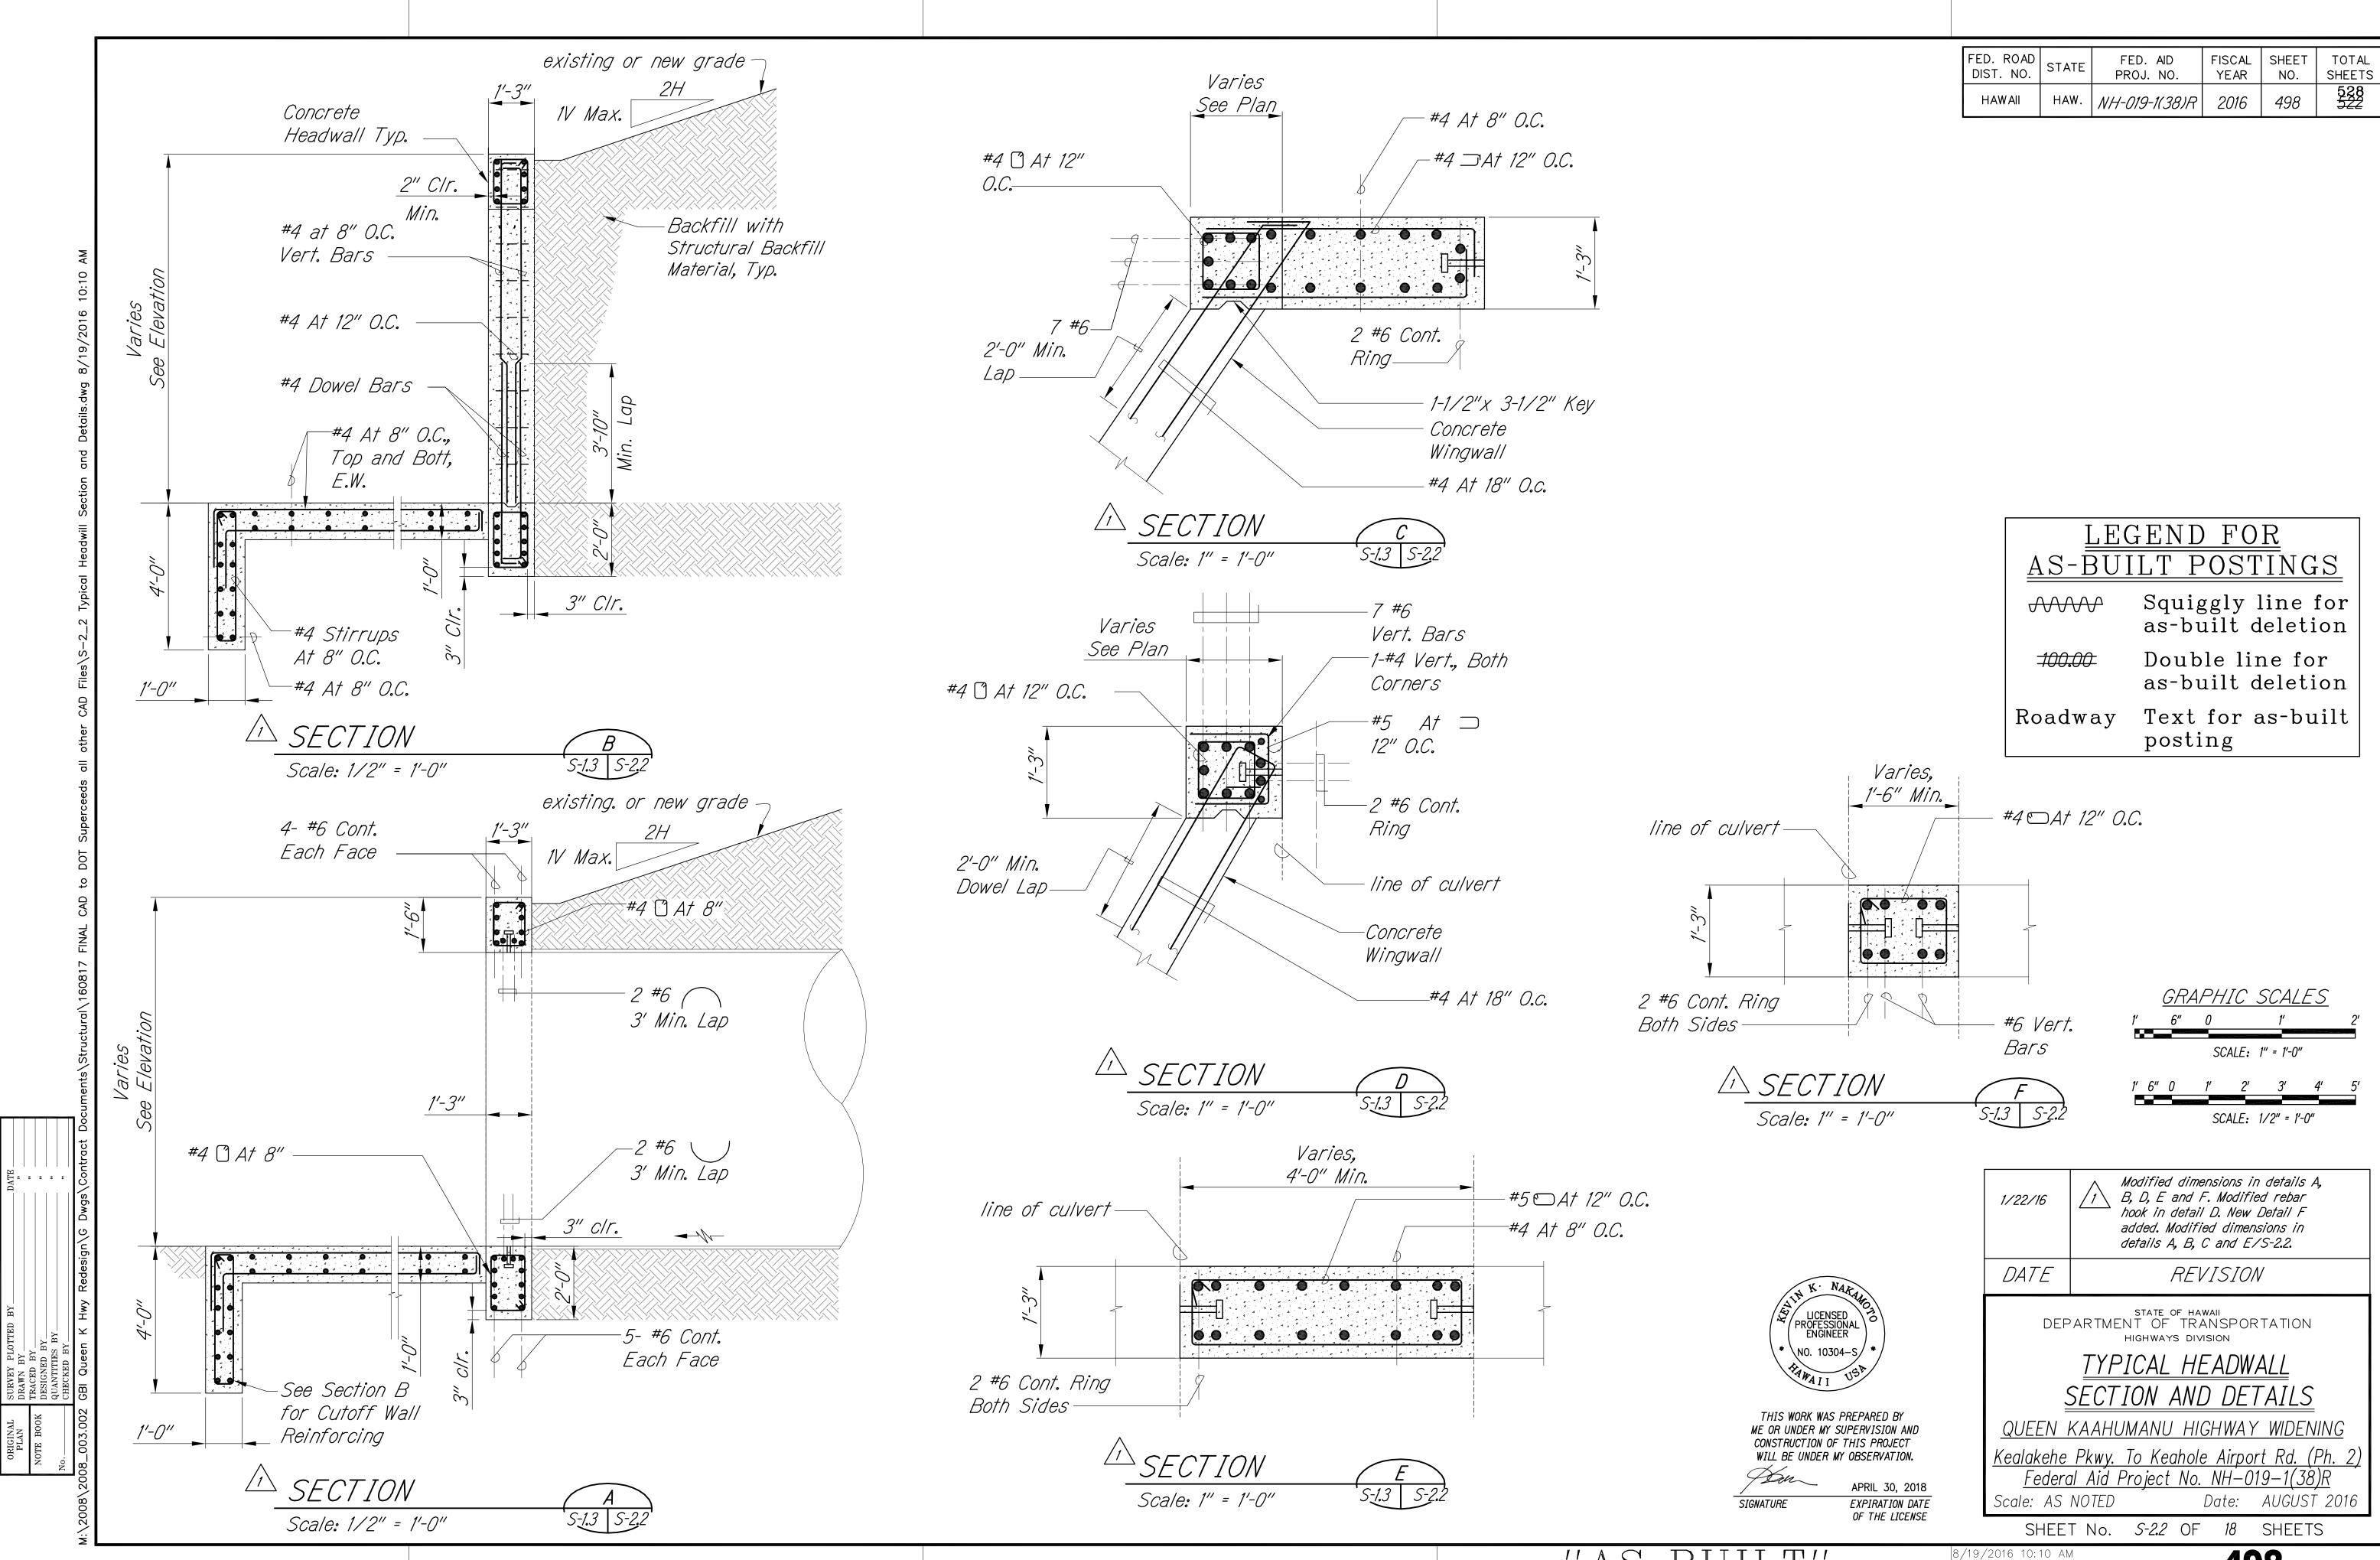
HAW. NH-019-1(38)R

TOTAL SHEETS

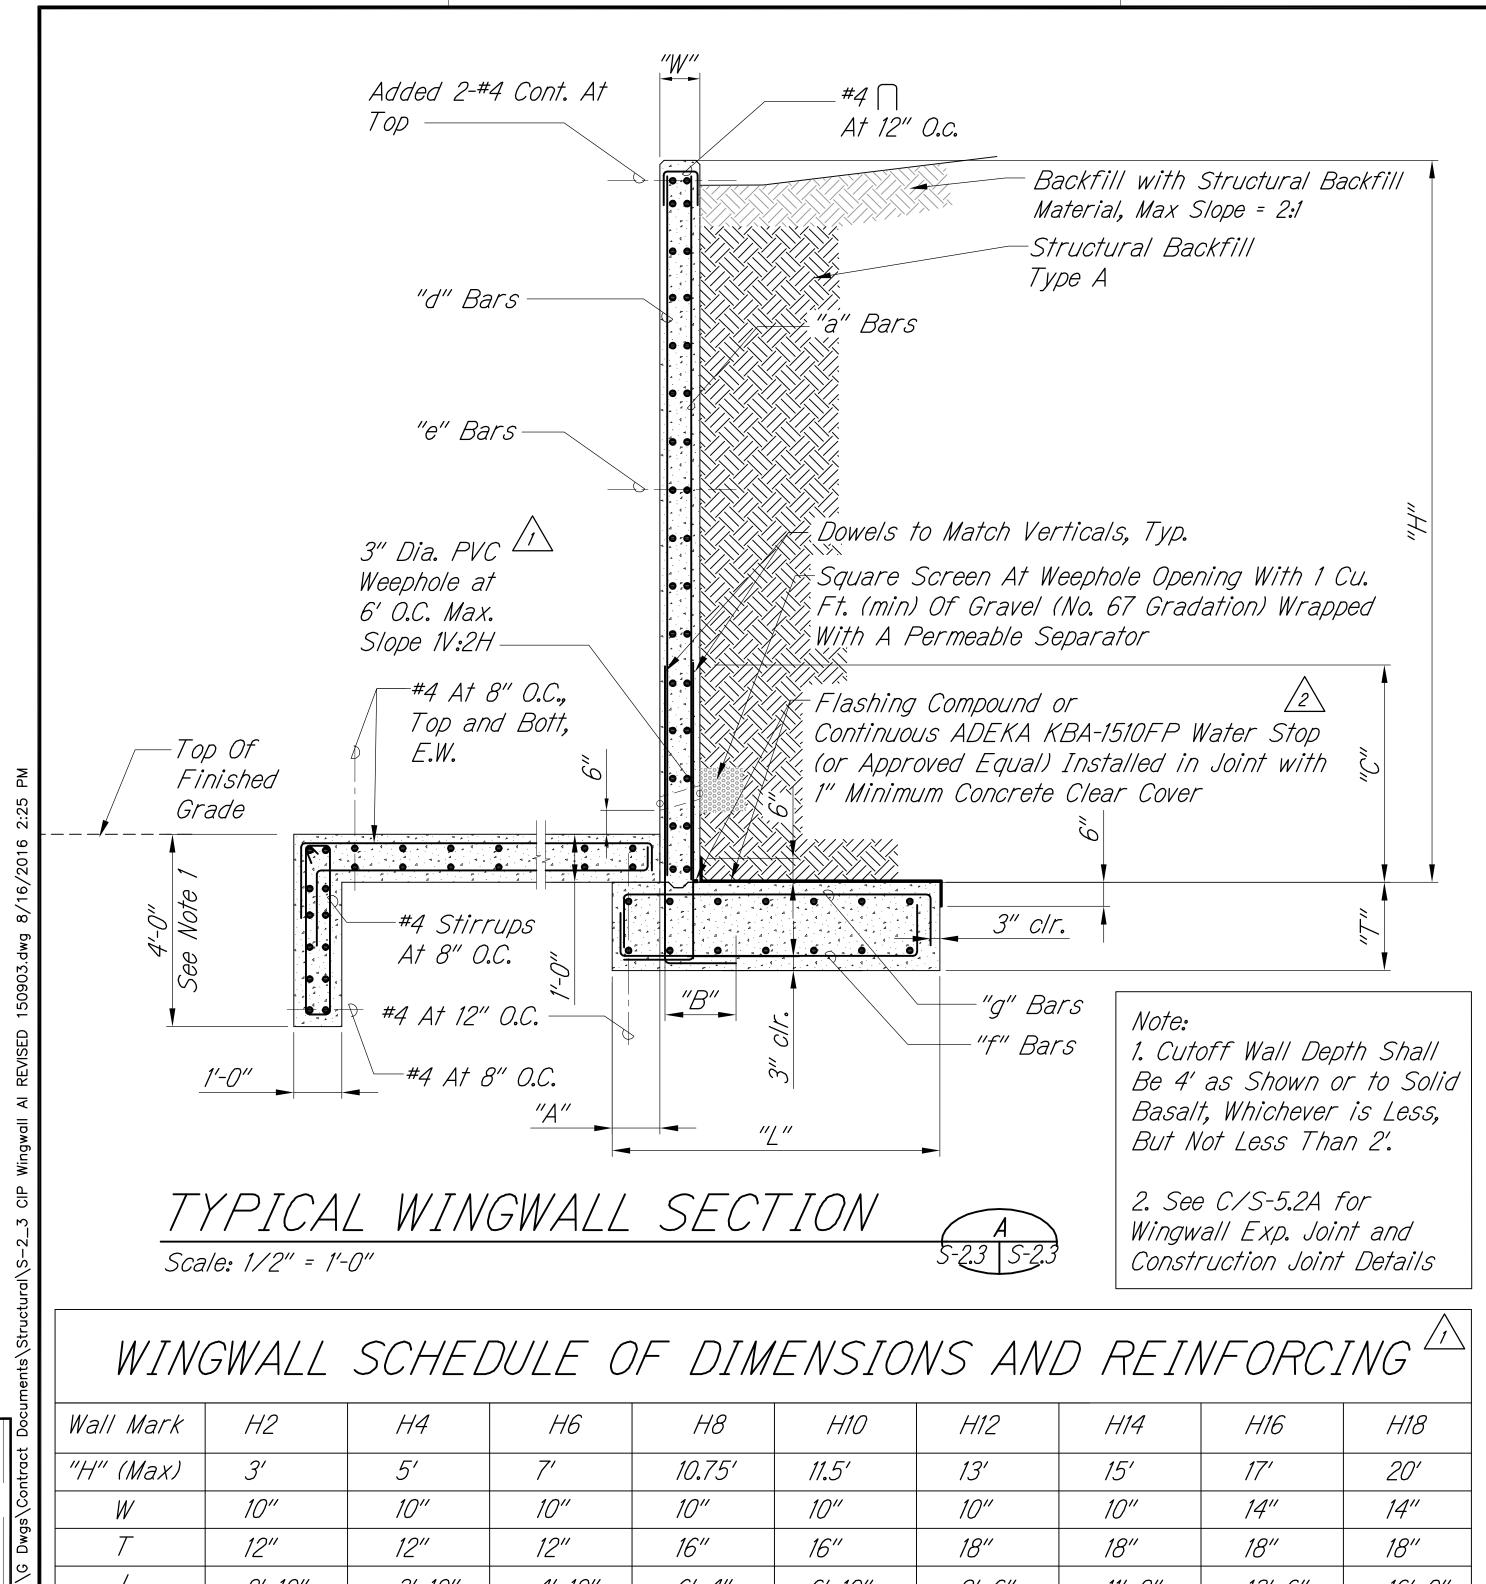
8/16/2016

EXPIRATION DATE OF THE LICENSE

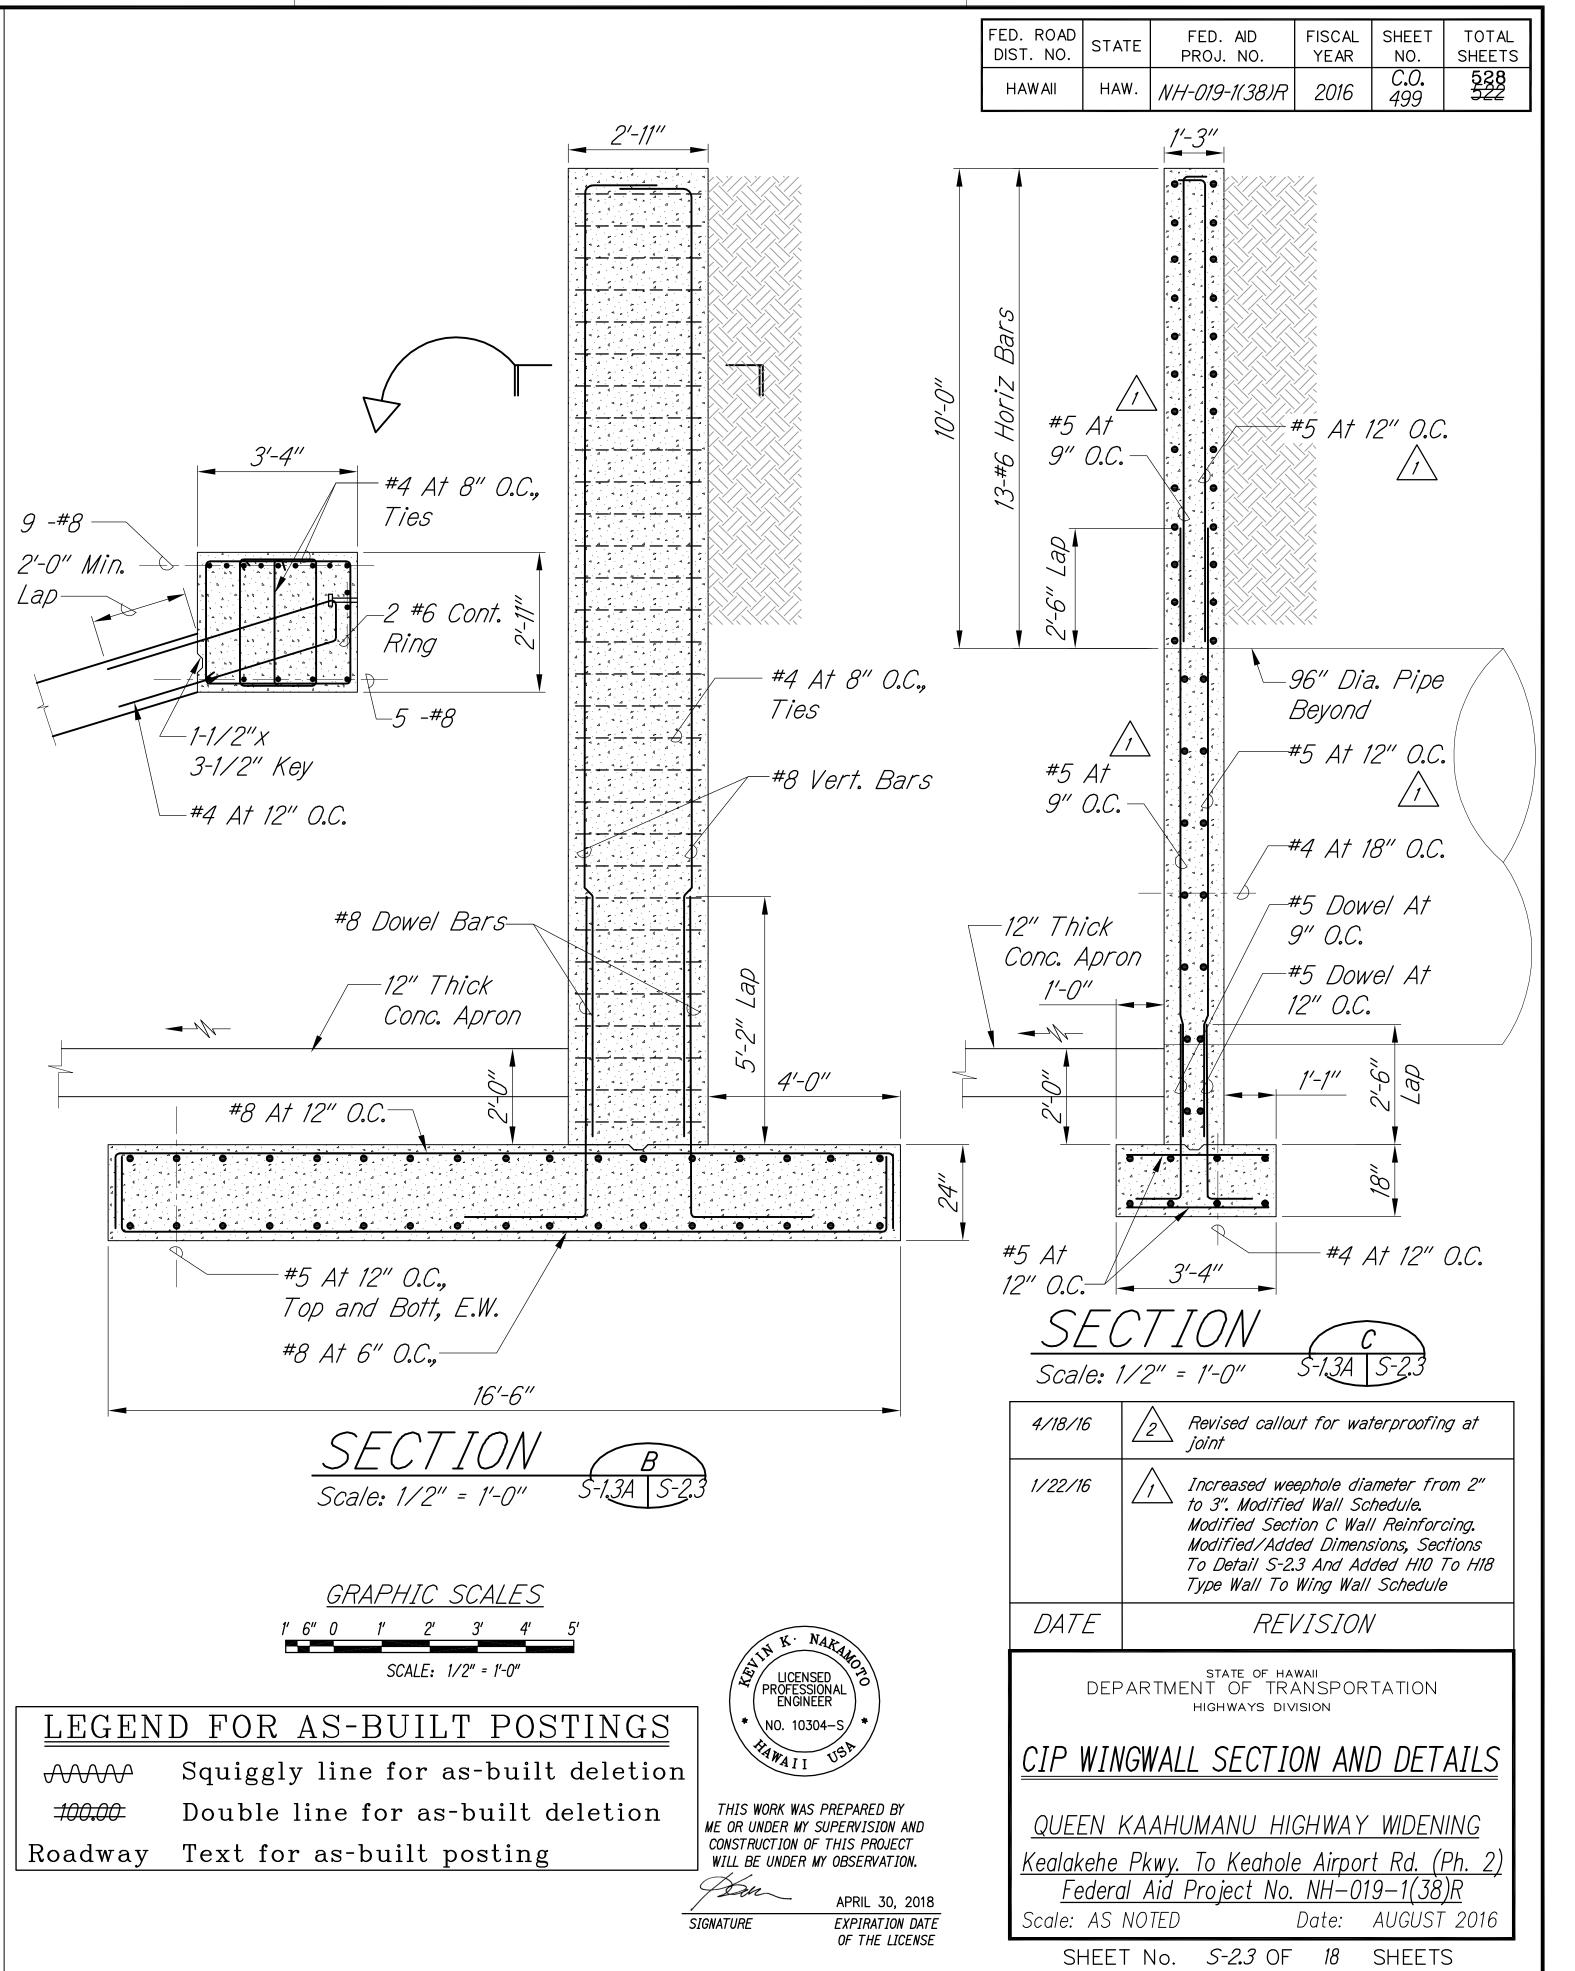
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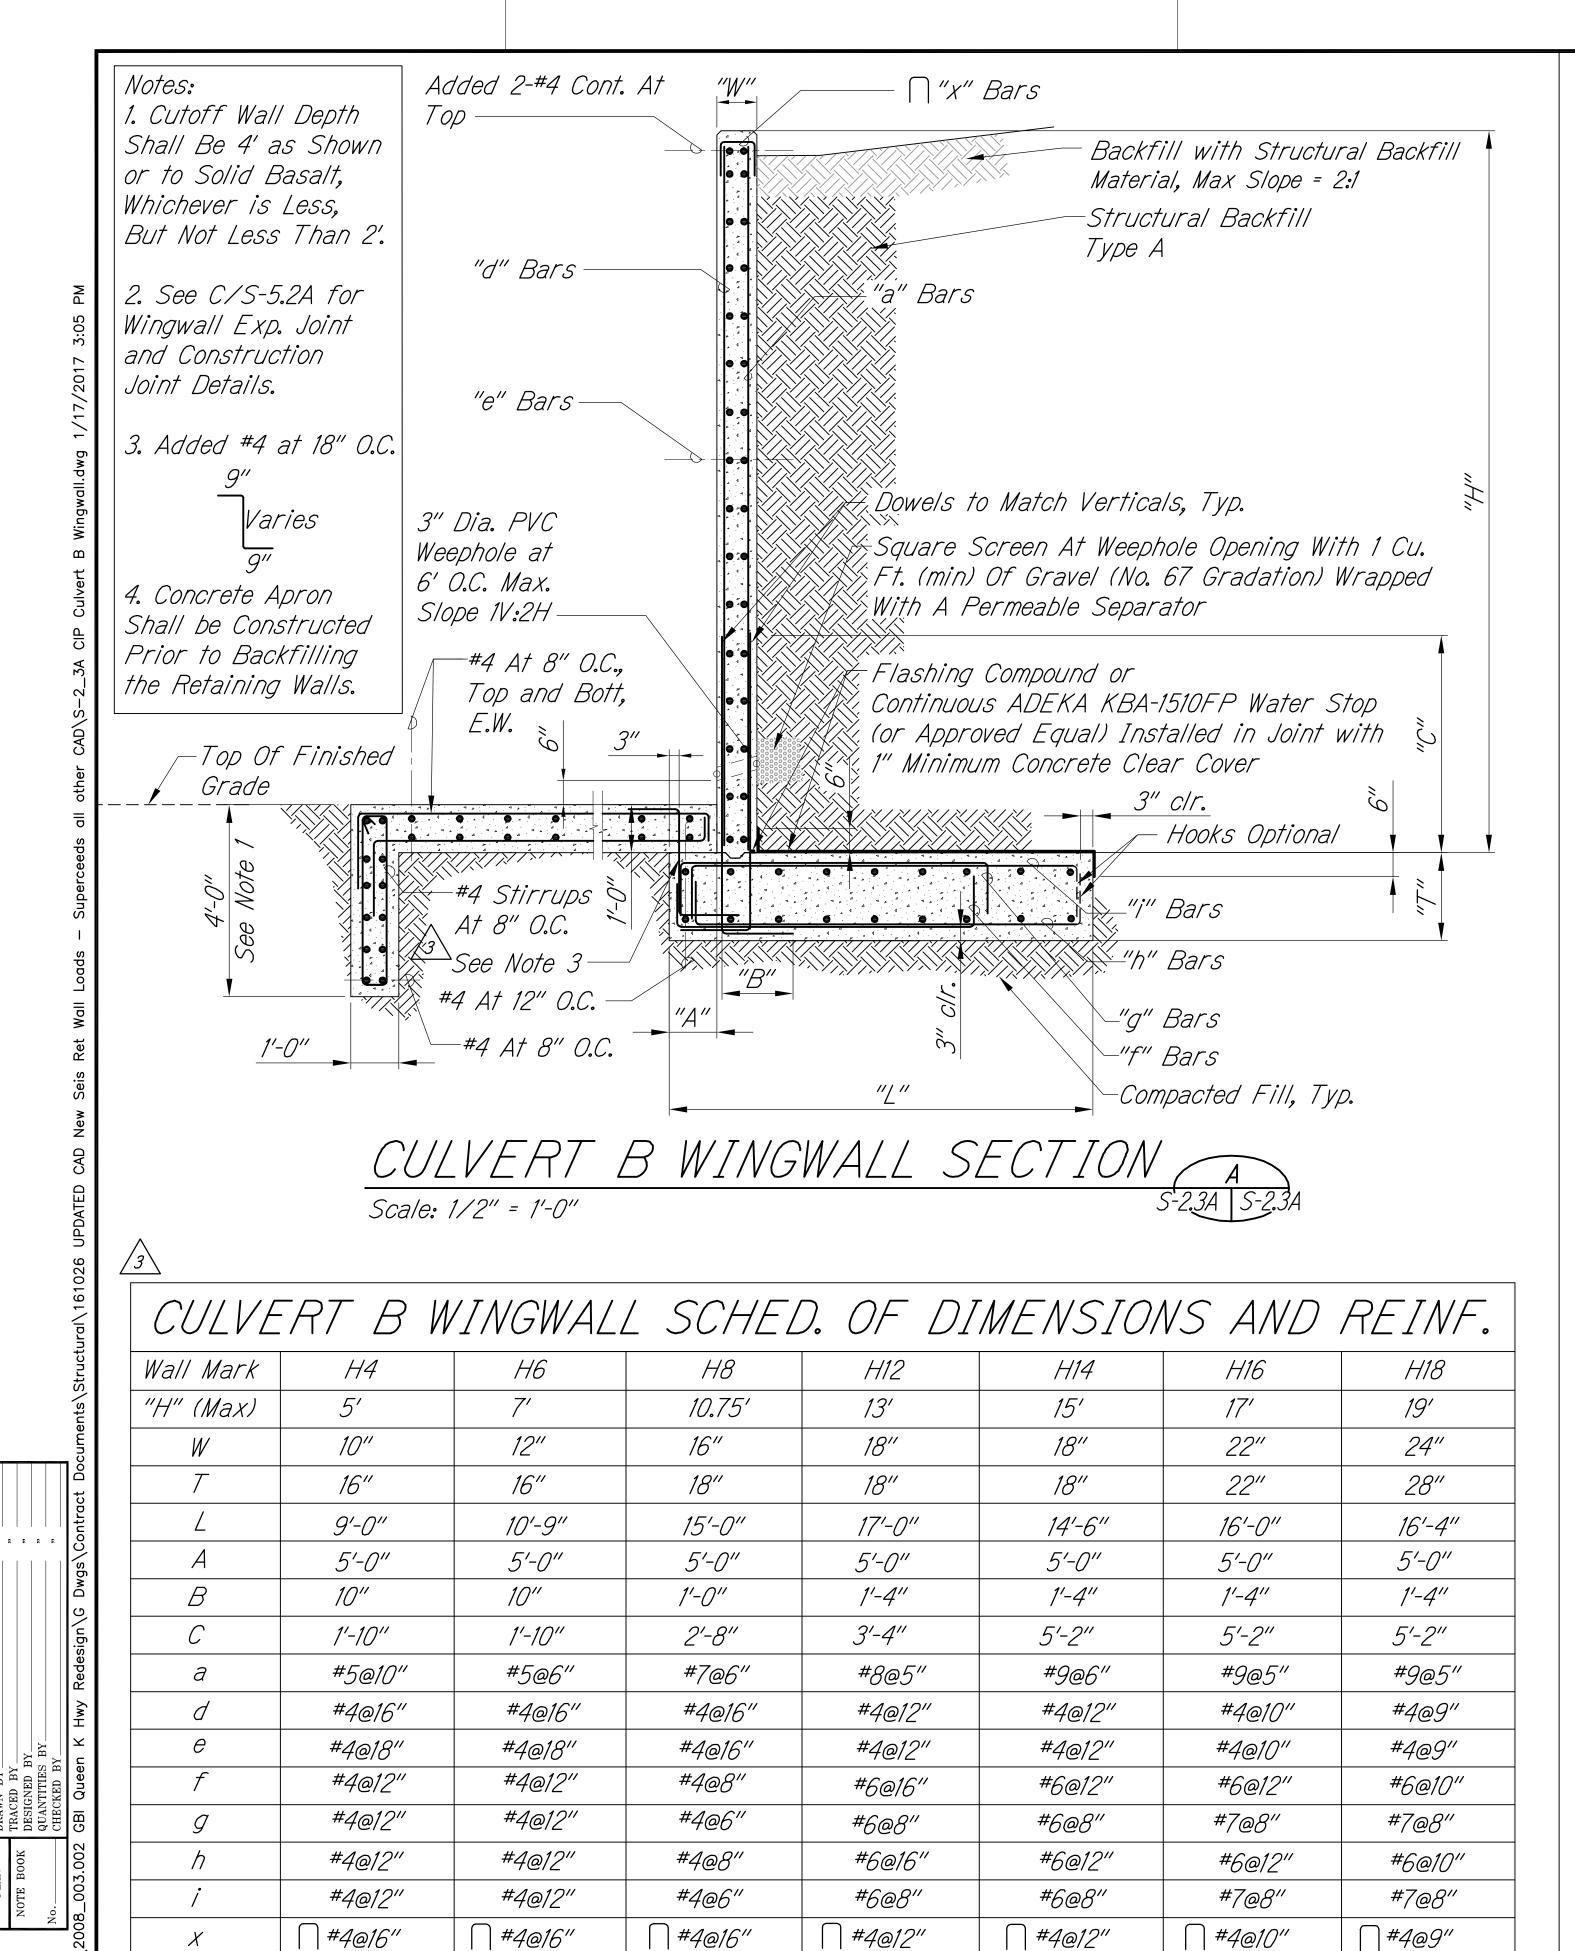
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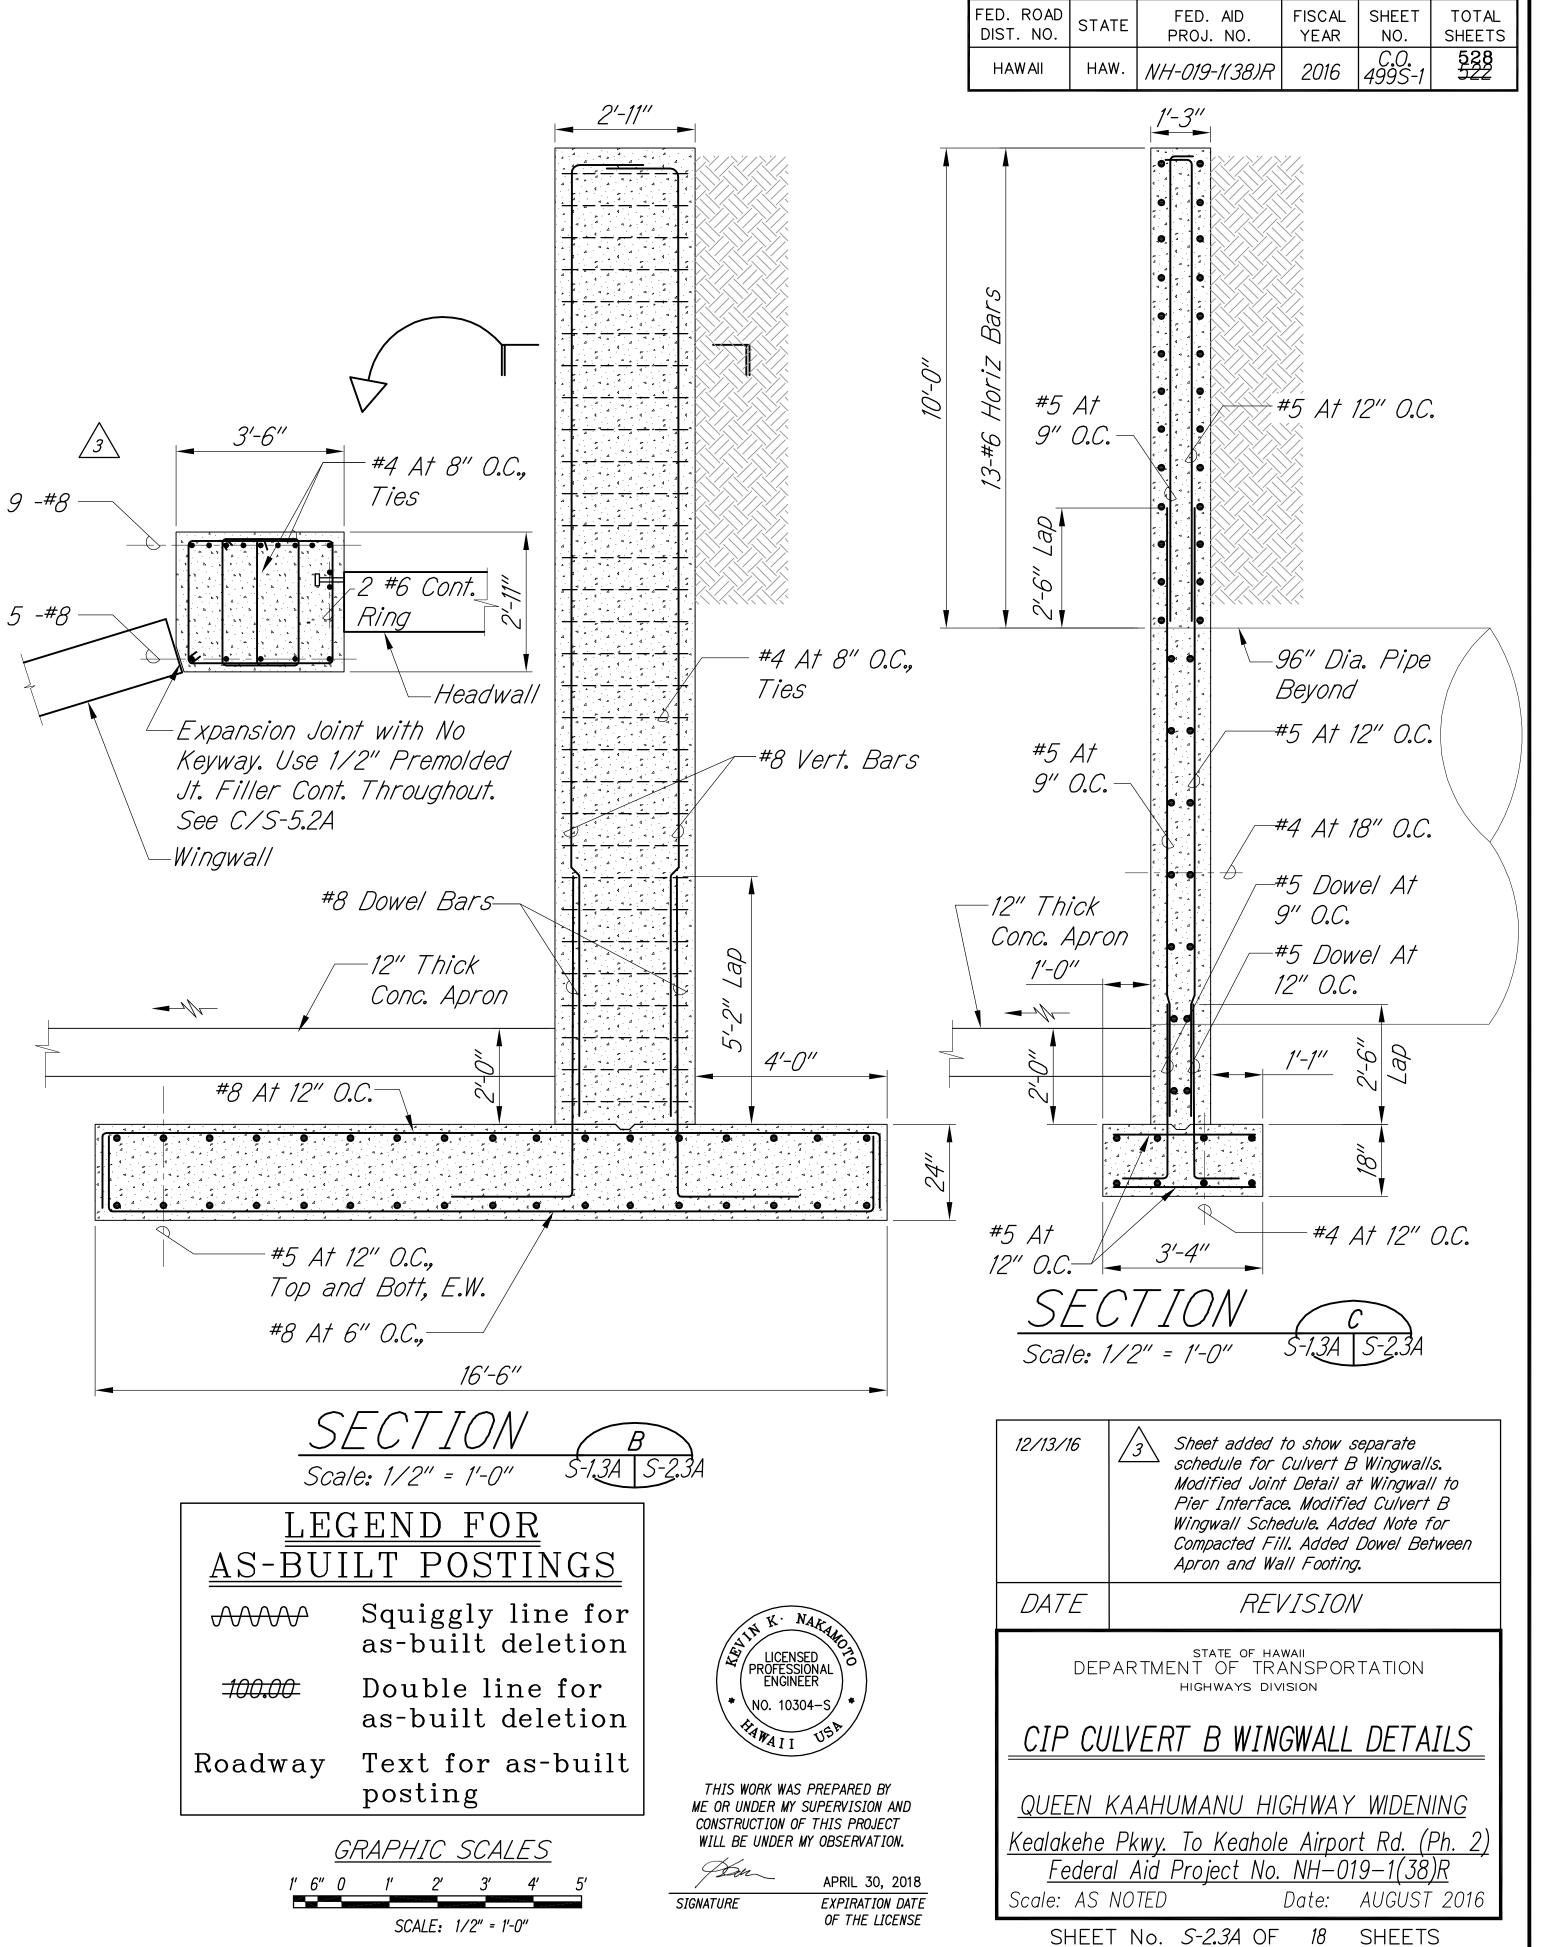


Wall Mark	H2	H4	H6	H8	H10	H12	H14	H16	H18
"H" (Max)	3'	5′	7'	10.75′	11.5′	13'	15′	17'	20'
W	10"	10"	10"	10"	10"	10"	10"	14"	14"
T	12"	12"	12"	16"	16"	18"	18"	18"	18"
L	2' 10"	3' 10"	4' 10"	6' 4"	6' 10"	9' 6"	11' 0"	13' 6"	16' 0"
Α	1' 0"	1' 0"	1' 0"	1' 6"	1' 6"	1' 6"	2' 0"	2' 6"	2' 6"
В	10"	10"	10"	1'-0"	1'-0"	1'-4"	1'-4"	1'-4"	1'-4"
С	2'-8"	2'-8"	2'-8"	3'-2"	3'-2"	5'-2"	5'-2"	5'-2"	5'-2"
а	#5@12"	#5@12"	#5@12"	#6@12"	#6@12"	#8@10"	#8@6"	#8@6"	#8@4"
d	#4@16"	#4@16"	#4@16"	#4@16"	#4@16"	#4@16"	#4@16"	#4@10"	#4@10"
e	#4@18"	#4@18"	#4@18"	#4@18"	#4@18"	#4@18"	#4@18"	#4@12"	#4@12"
f	#4@12"	#4@12"	#4@12"	#4@12"	#4@12"	#6@8"	#6@8"	#6@12"	#6@12"
g	#4@12"	#4@12"	#4@12"	#4@12"	#4@12"	#6@8"	#6@8"	#7@10"	#7@6"



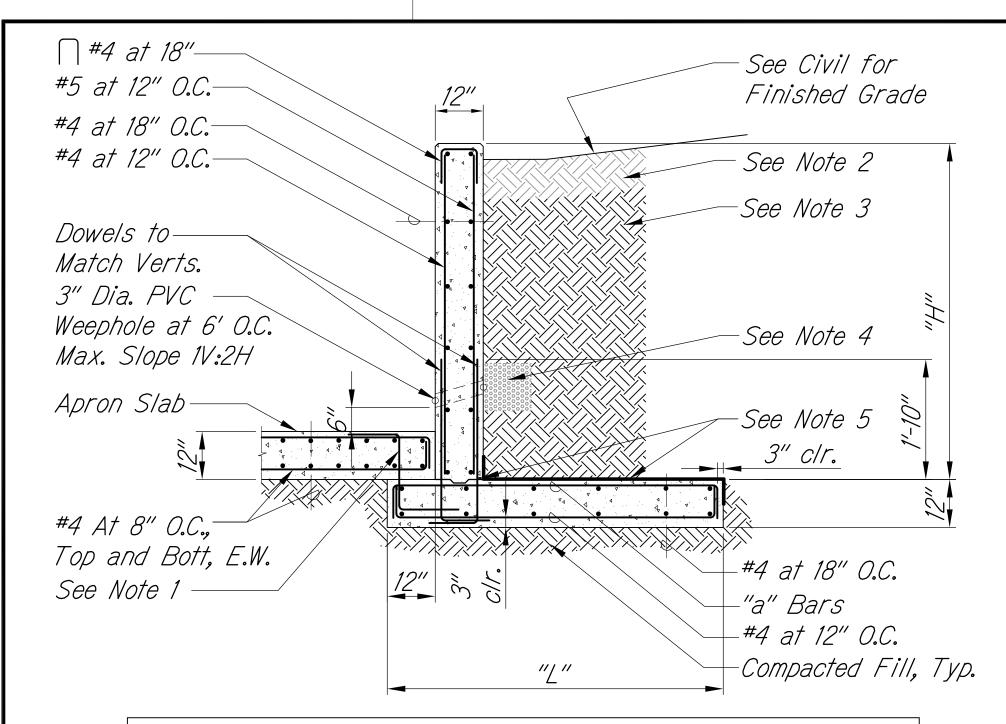
C.O. 499



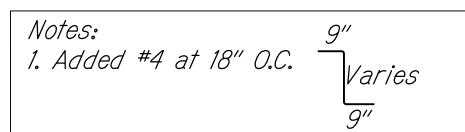


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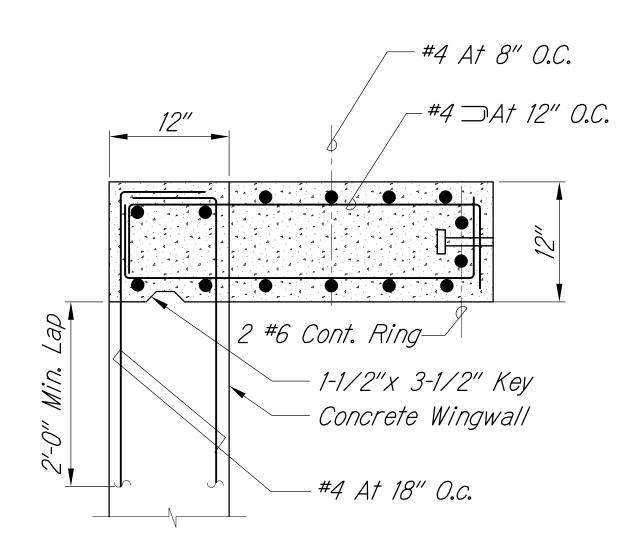


CULV.	C WINGWALL SCHED.				
Wall Mark	W2	W5	W7		
"H" (Max)	2'-0"	5'-0"	7'-0"		
L	4'-3"	5'-6"	7'-0"		
а	#4@12"	#5@12"	#5@9"		




- 2. Backfill with Structural Backfill Material, Max. Slope = 2:1
- 3. Structural Backfill Type A
- 4. Square Screen At Weephole Opening With 1 Cu. Ft. (min) Of gravel (No. 67 Gradation) Wrapped With A Permeable Separator
- 5. Flashing Compound or Continuous ADEKA KBA-1510FP Water Stop (or Approved Equal) Installed in Joint with 1" Minimum Concrete Clear Cover
- 6. Added #4 at 18" O.C.
- 7. Cutoff Wall Depth Shall Be 4' as Shown or to Solid Basalt, Whichever is Less, But Not Less Than 2'.
- 8. Concrete Apron Shall be Constructed Prior to Backfilling the Retaining Walls.

FED. ROAD DIST. NO.	STATE	FED. AID PROJ. NO.	FISCAL YEAR	SHEET NO.	TOTAL SHEETS
HAWAII	HAW.	NH-019-1(38)R	2016	C.O. 4995-2	528 <del>522</del>




WINGWALL TO HEADWALL PLAN

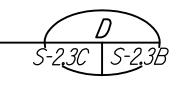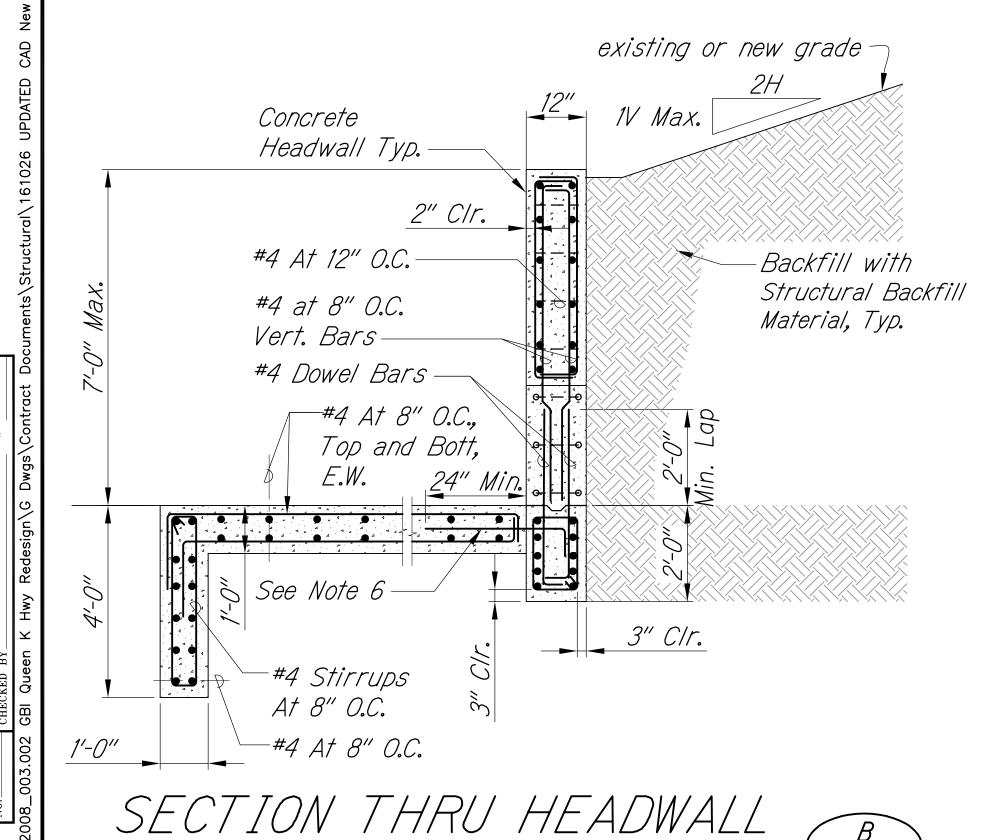
Scale: 1" = 1'-0"







Scale: 1/2" = 1'-0"

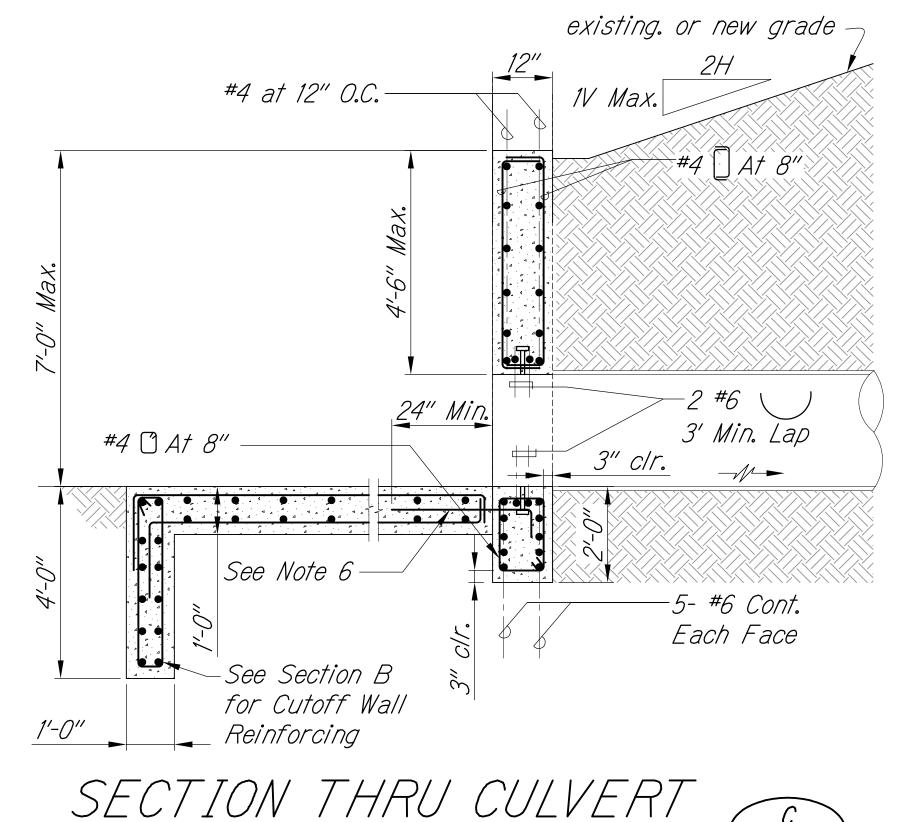


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#### LEGEND FOR AS-BUILT POSTINGS

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Double line for 100.00 as-built deletion

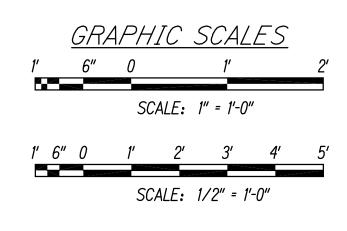Text for as-built Roadway posting





CONSTRUCTION OF THIS PROJECT WILL BE UNDER MY OBSERVATION.

SIGNATURE

APRIL 30, 2018 EXPIRATION DATE

OF THE LICENSE

2/5/18	Sheet added to show Culvert C Inlet Wall
DATE	REVISION
DEF	state of hawaii PARTMENT OF TRANSPORTATION highways division

CIP CULVERT C DETAILS

QUEEN KAAHUMANU HIGHWAY WIDENING Kealakehe Pkwy. To Keahole Airport Rd. (Ph. 2) Federal Aid Project No. NH-019-1(38)R Scale: AS NOTED Date: AUGUST 2016


SHEET No. S-2.3B OF 18 SHEETS

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4/25/2018 8: 42 AM **C.O. 499 S-2** 

FED. ROAD DIST. NO. STATE FED. AID PROJ. NO. FISCAL SHEET NO. SHEETS

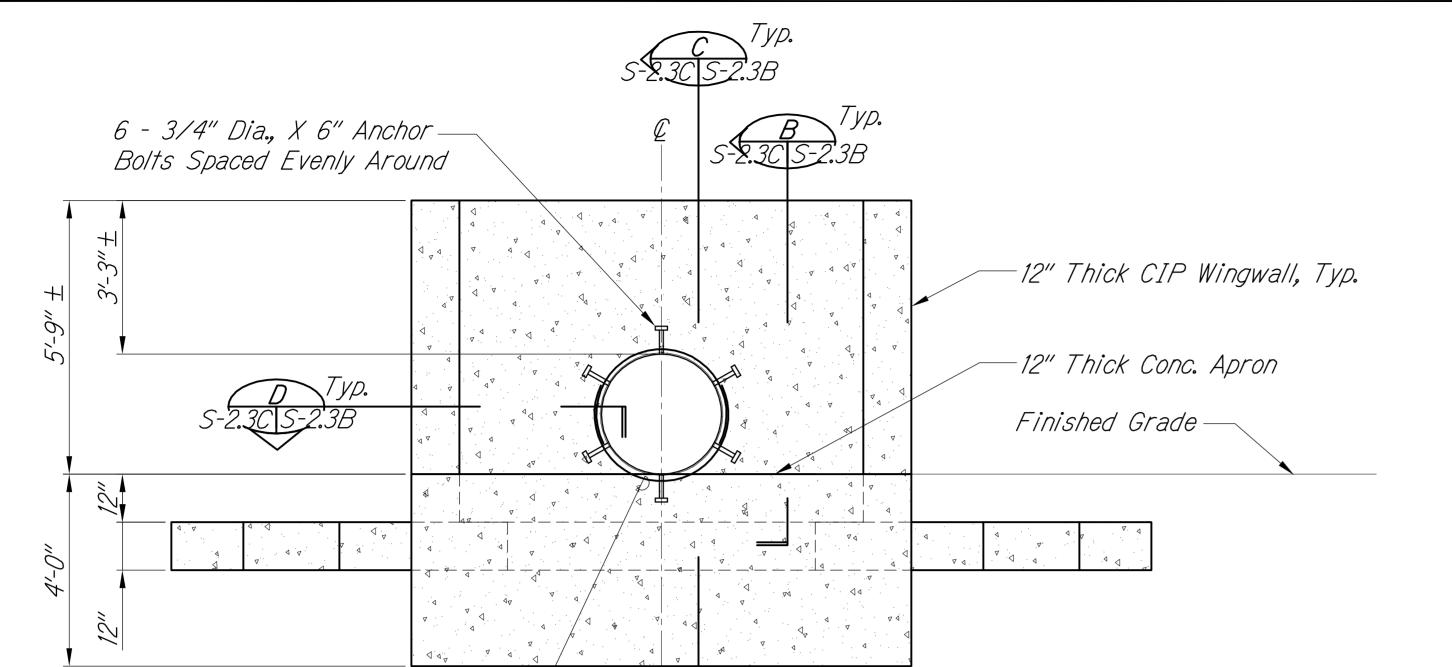HAWAII HAW. NH-019-1(38)P 2016 C.O. 4995-3 528 522




## ELEVATION - NEW HEADWALL FOR 30" DIA. CULVERT Scale: 1/2" = 1'-0"

*10'-6"* ±

30" Dia.

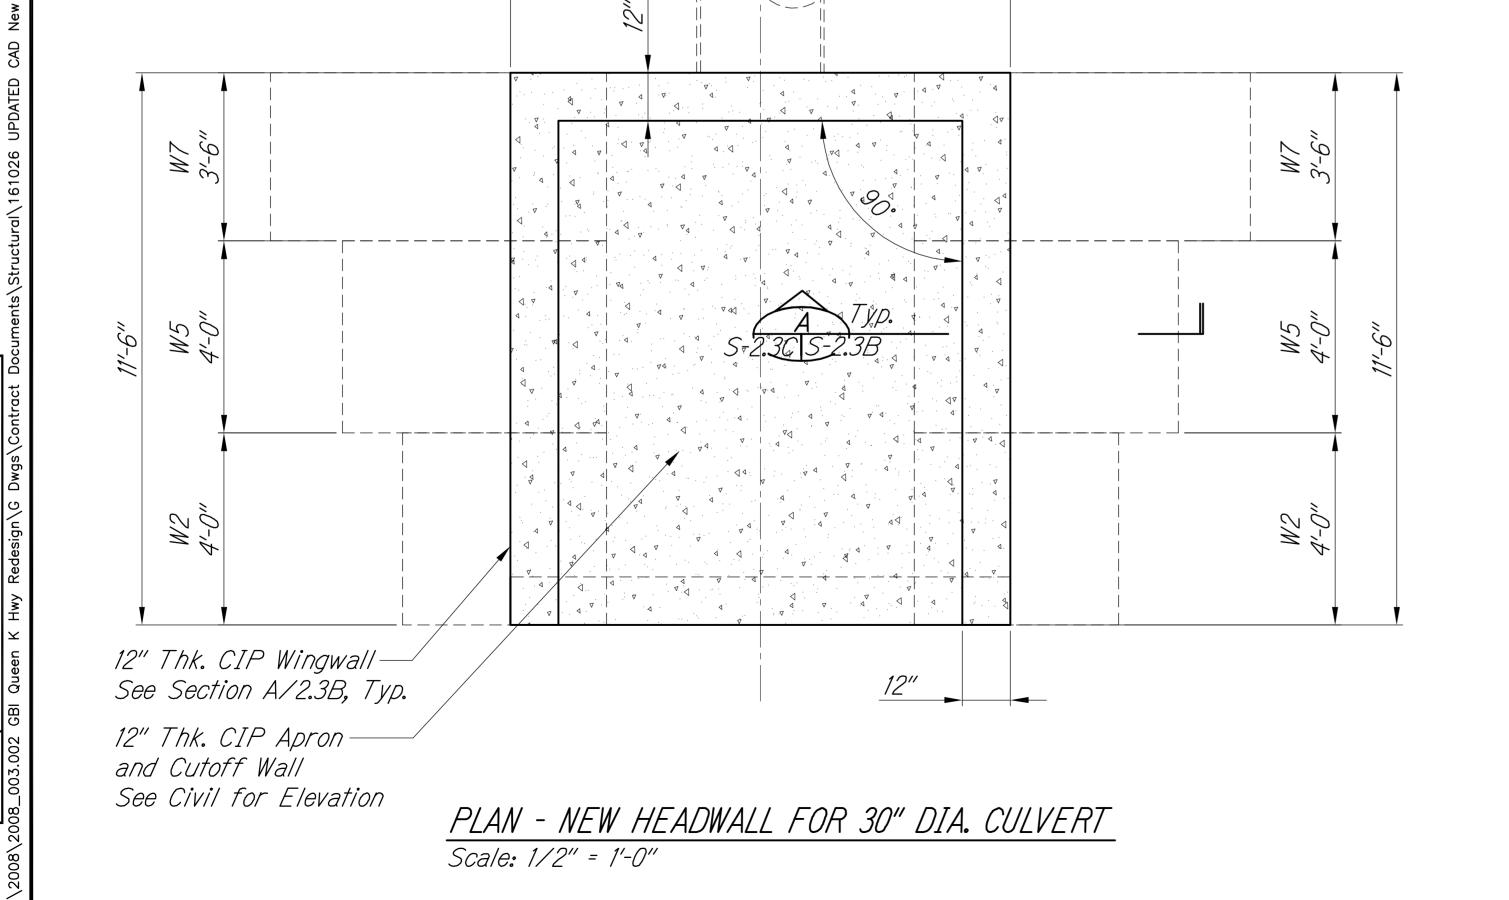2 #6 Ring—



Note:

Stud Bolts Shall Be Stainless Steel (See C/S-2.4). Hot Dip Galvanized Bolts with Neoprene Washers and Sleeves are Acceptable, Provided it Does Not Affect the Manufacturer's Warranty.

#### LEGEND FOR AS-BUILT POSTINGS

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Double line for as-built deletion

Roadway Text for as-built

posting

GRAPHIC SCALES

SCALE: 1/2" = 1'-0"



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SIGNATURE

APRIL 30, 2018

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OF THE LICENSE

3/20/2018 3:22 PM

2/5/18 Sheet added to show Culvert C Inlet

Wall

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DEPARTMENT OF TRANSPORTATION

HIGHWAYS DIVISION

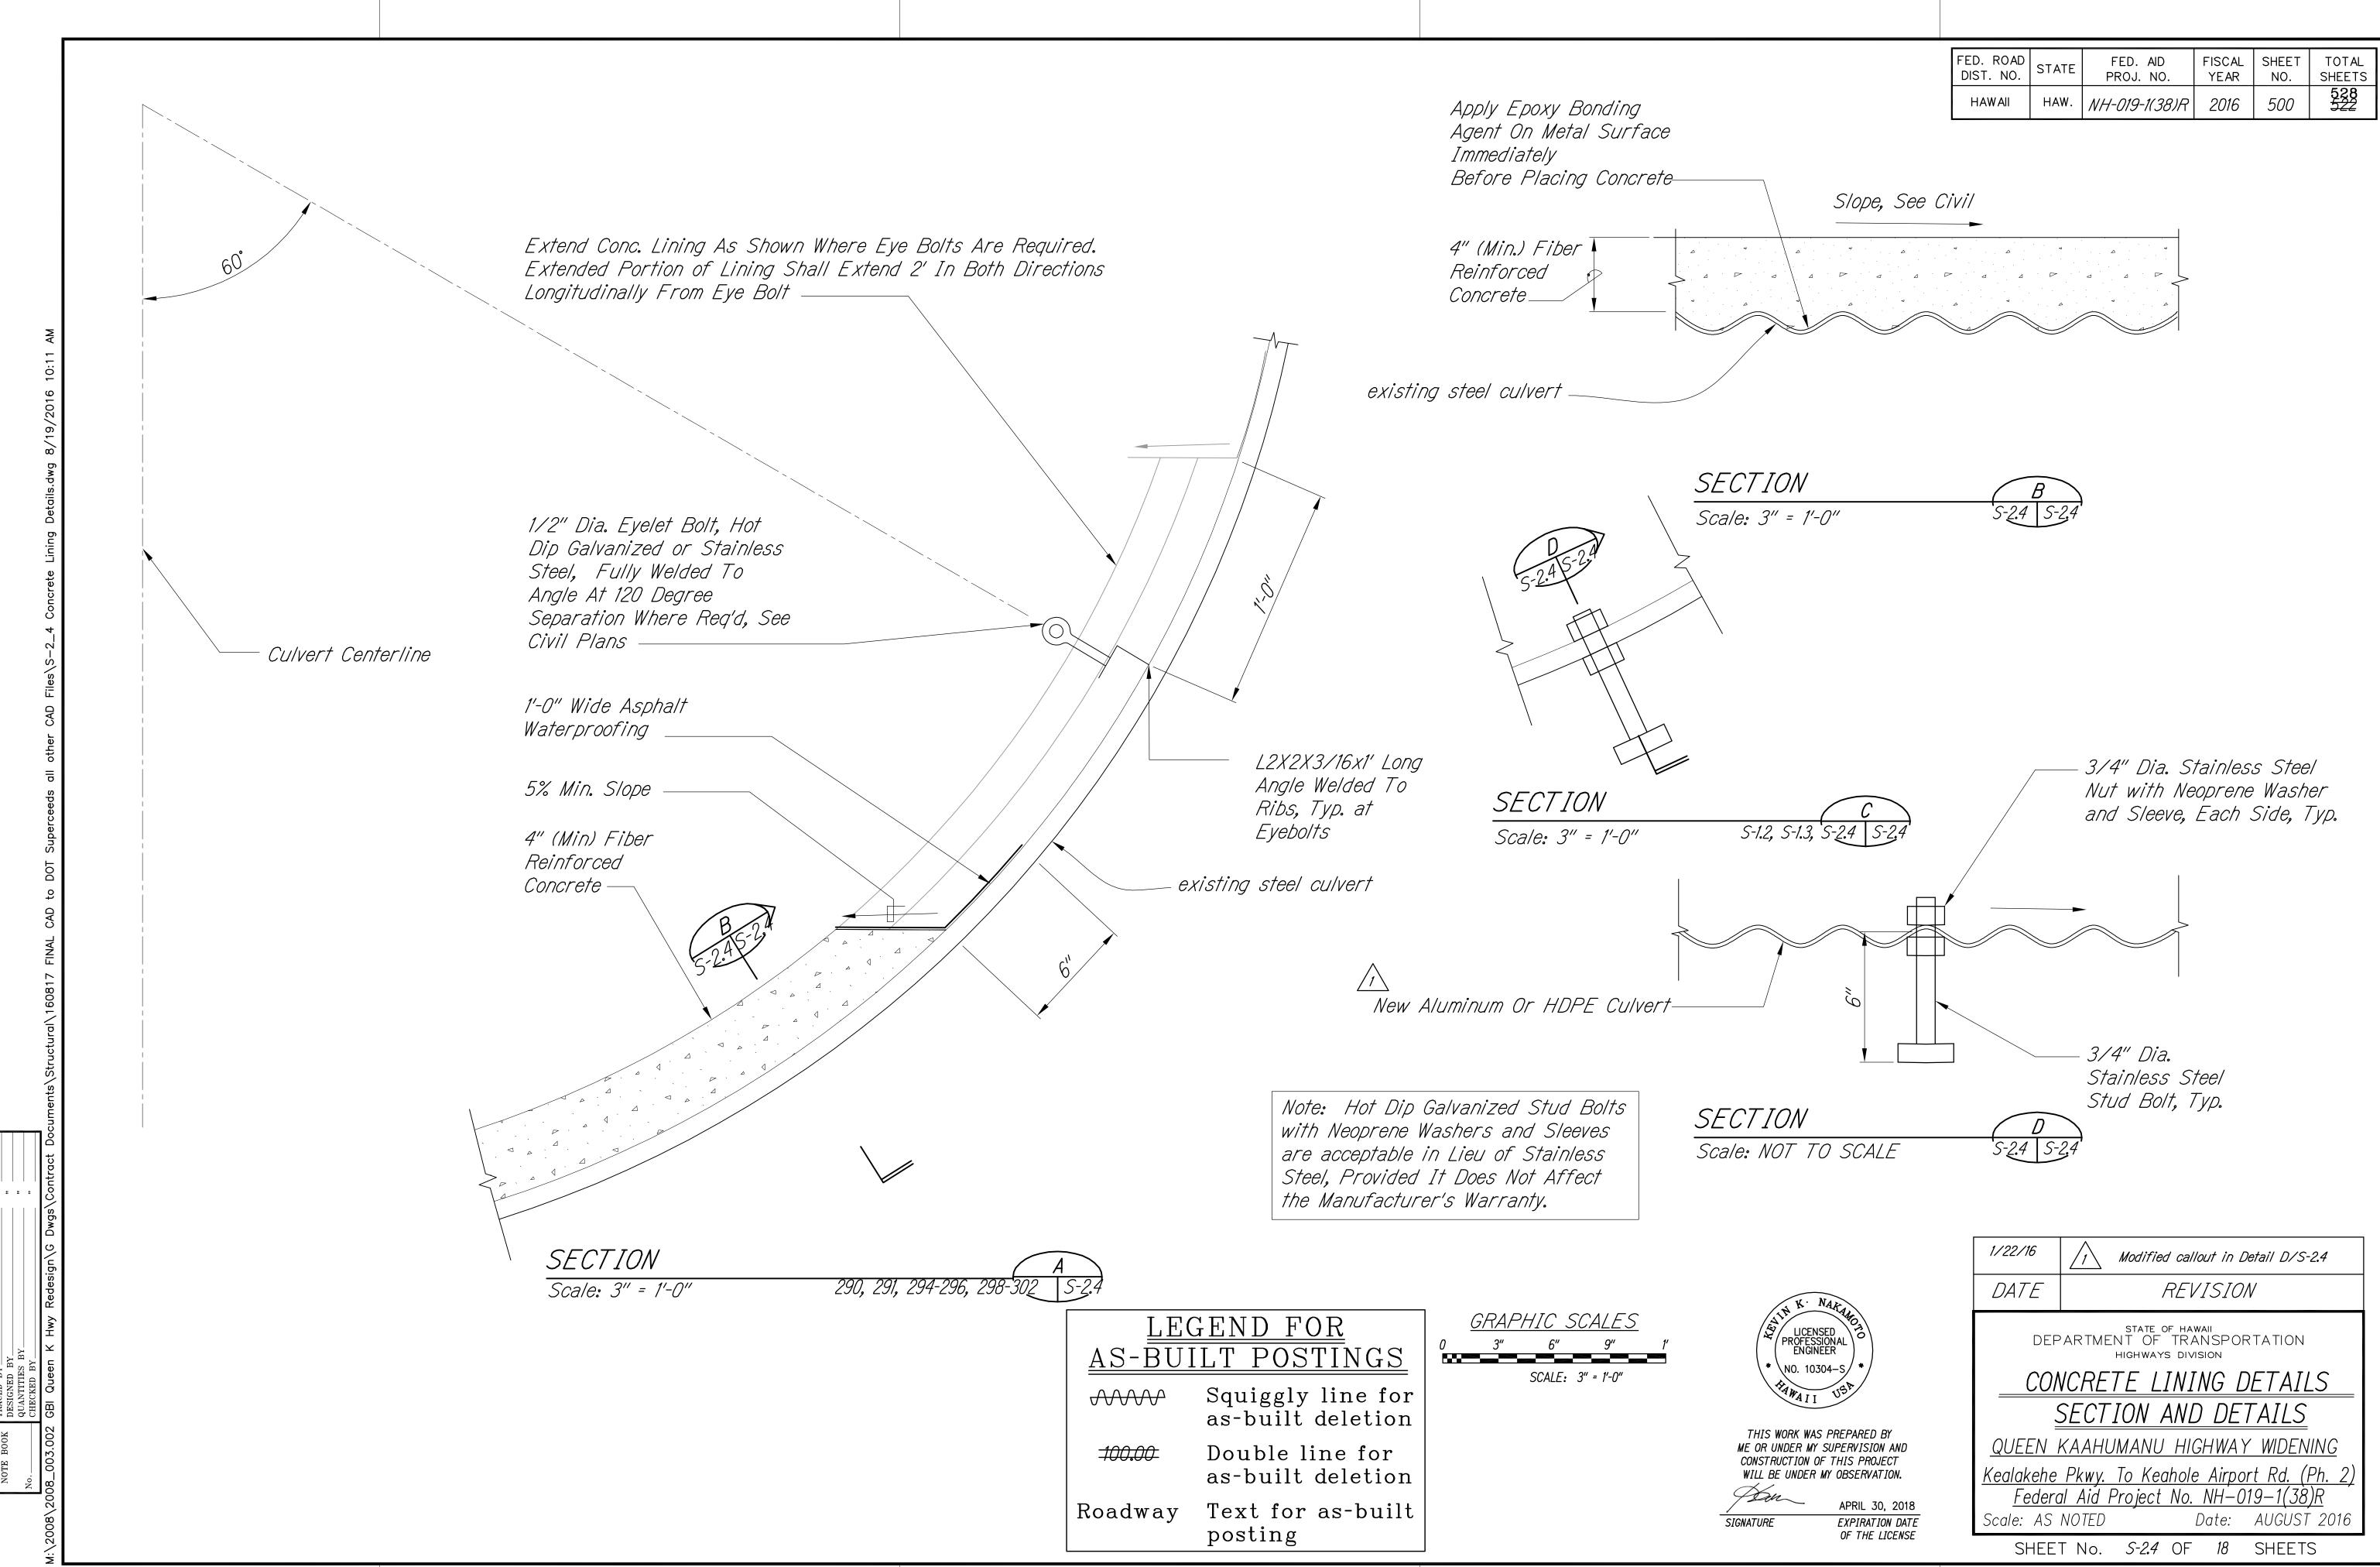
CULVERT C INLET WALL

PLAN AND PROFILE

QUEEN KAAHUMANU HIGHWAY WIDENING


Kealakehe Pkwy. To Keahole Airport Rd. (Ph. 2)
Federal Aid Project No. NH-019-1(38)R
Scale: AS NOTED Date: AUGUST 2016

SHEET No. S-2.3C OF 18 SHEETS




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FED. ROAD	STATE	FED. AID	FISCAL	SHEET	TOTAL
DIST. NO.		PROJ. NO.	YEAR	NO.	SHEETS
HAWAII	HAW.	NH-019-1(38)R	2016	501	528 522

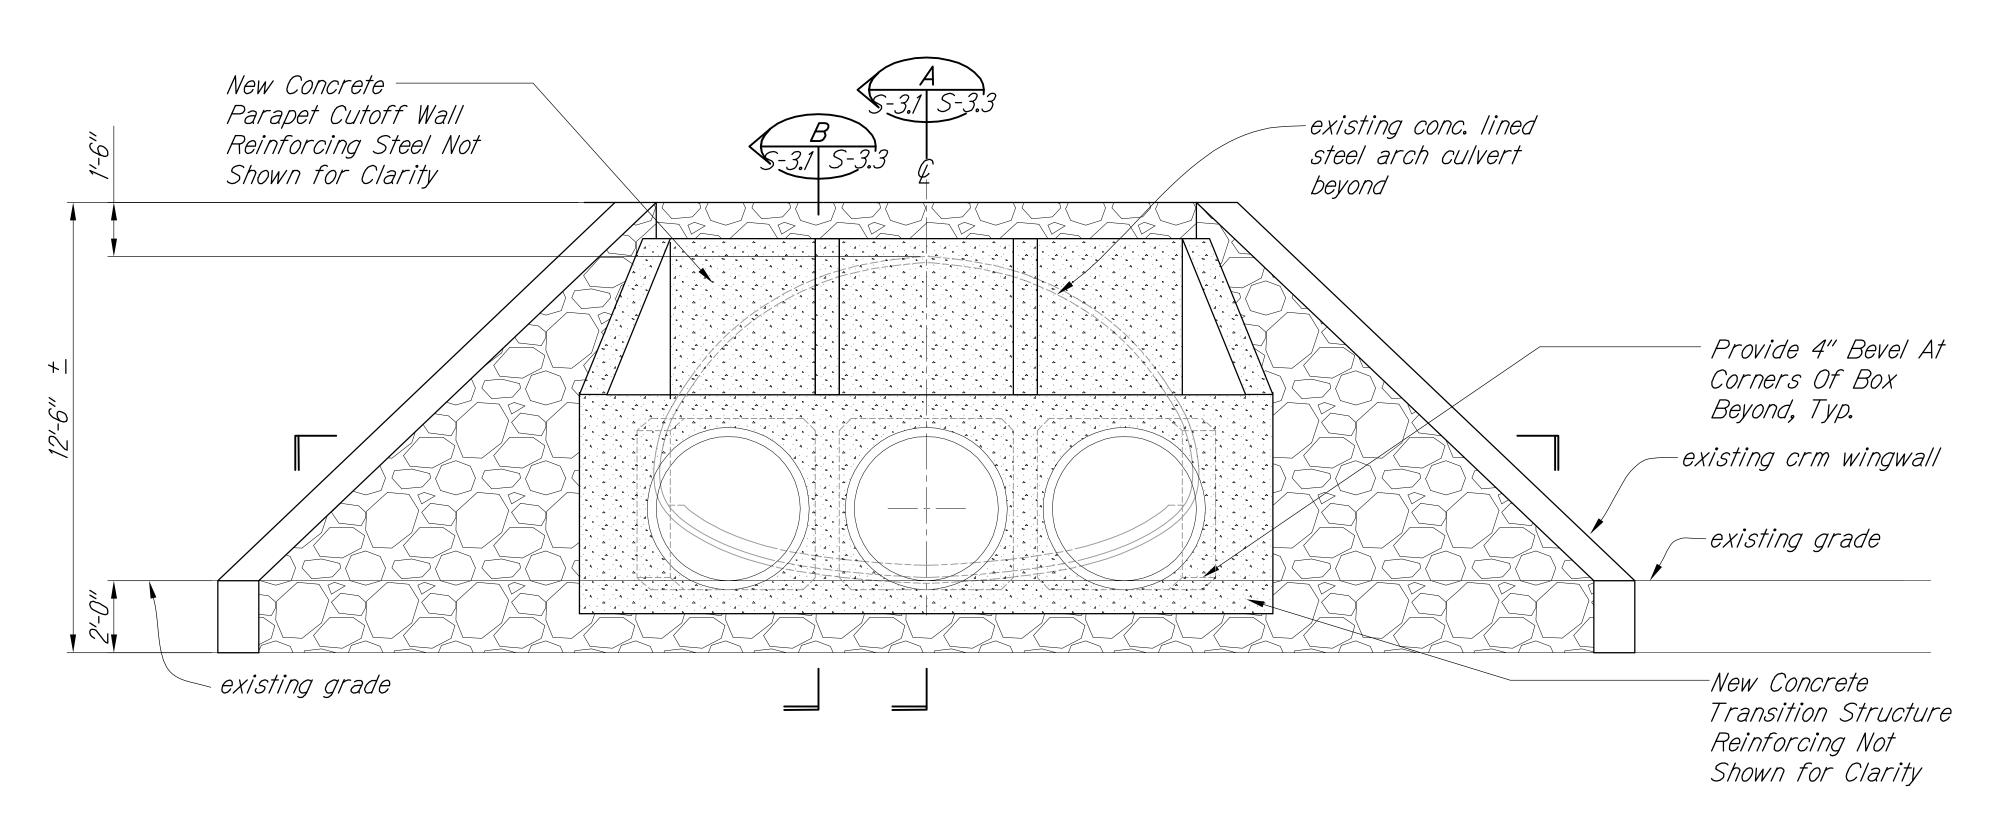

### ELEVATION - NEW ARCH TO TRIPLE CULVERT TRANSITION STRUCTURE

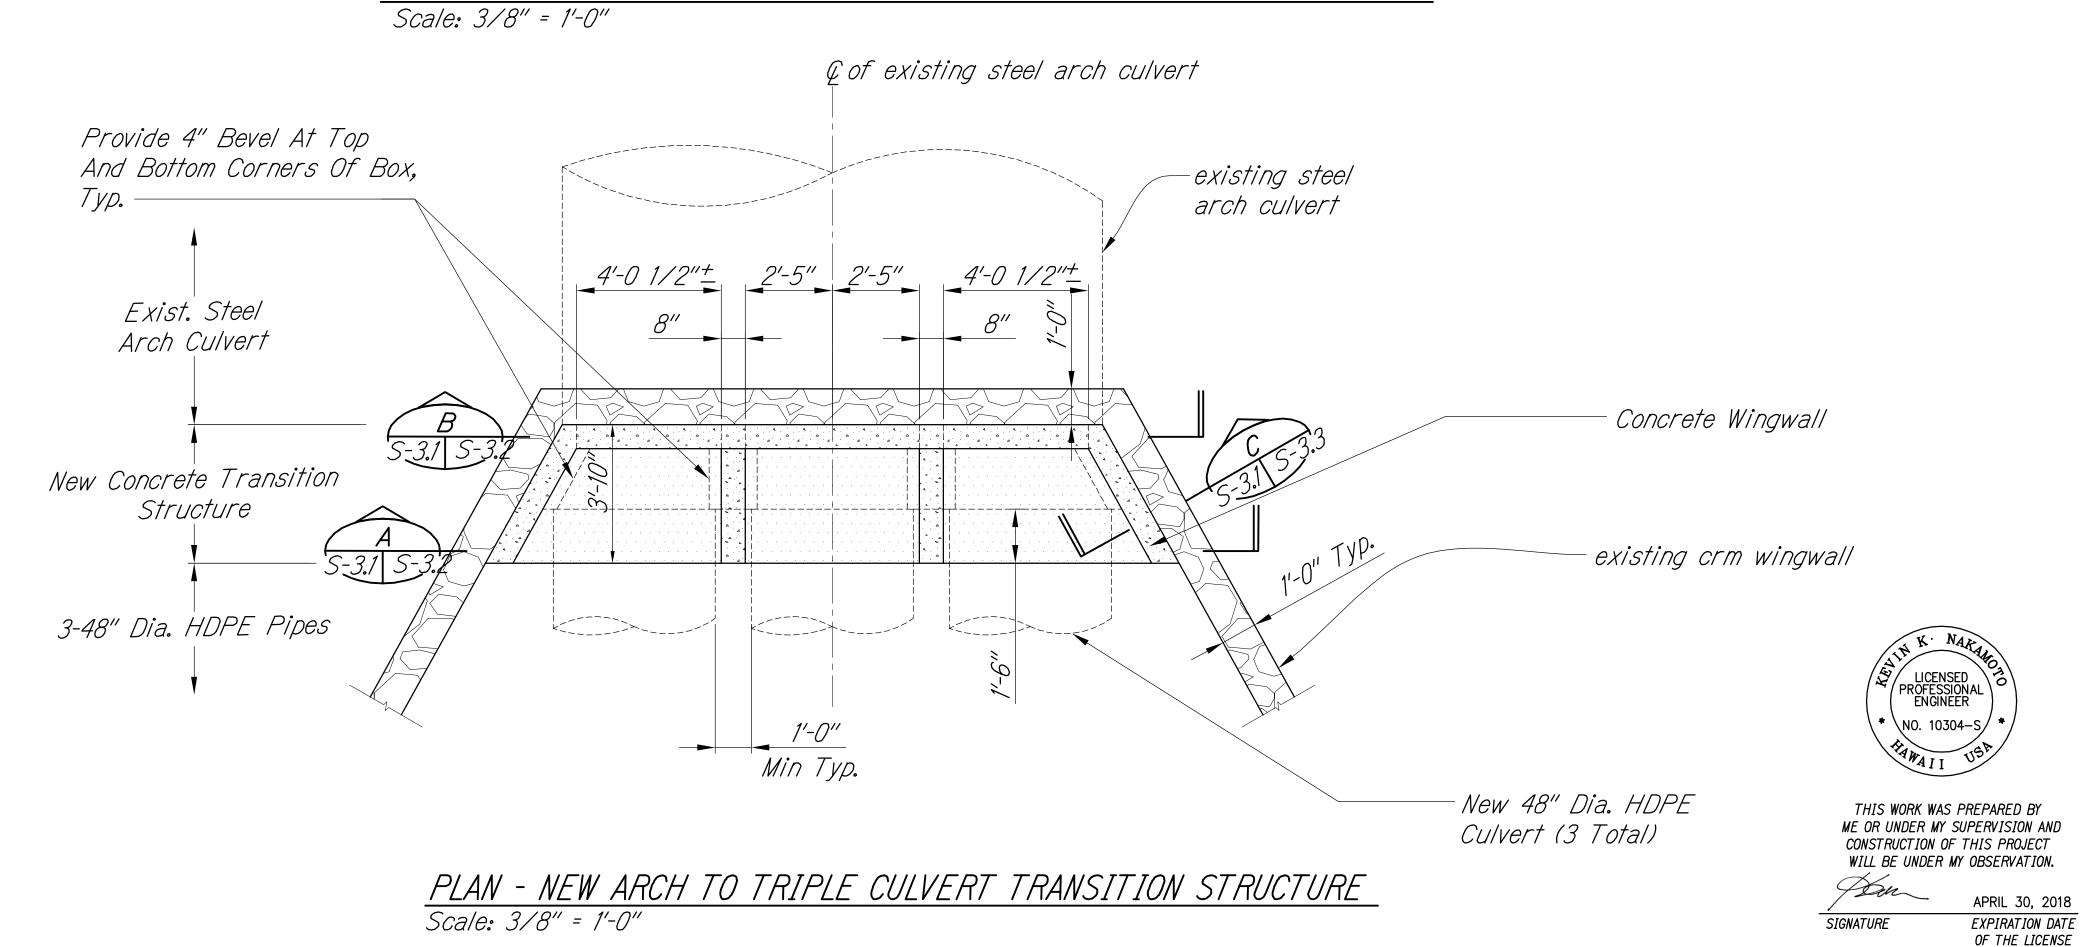

LEGEND FOR AS-BUILT POSTINGS

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Roadway Text for as-built posting

> GRAPHIC SCALES 1' 0 1' 2' 3' 4' 5' 6' 7' SCALE: 3/8" = 1'-0"

STATE OF HAWAII
DEPARTMENT OF TRANSPORTATION
HIGHWAYS DIVISION


#### STRUCTURAL ARCH TO TRIPLE TRANSITION STRUCTURE PLAN AND ELEVATION

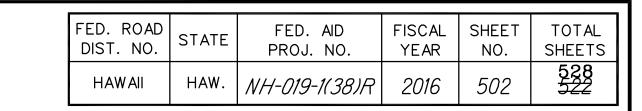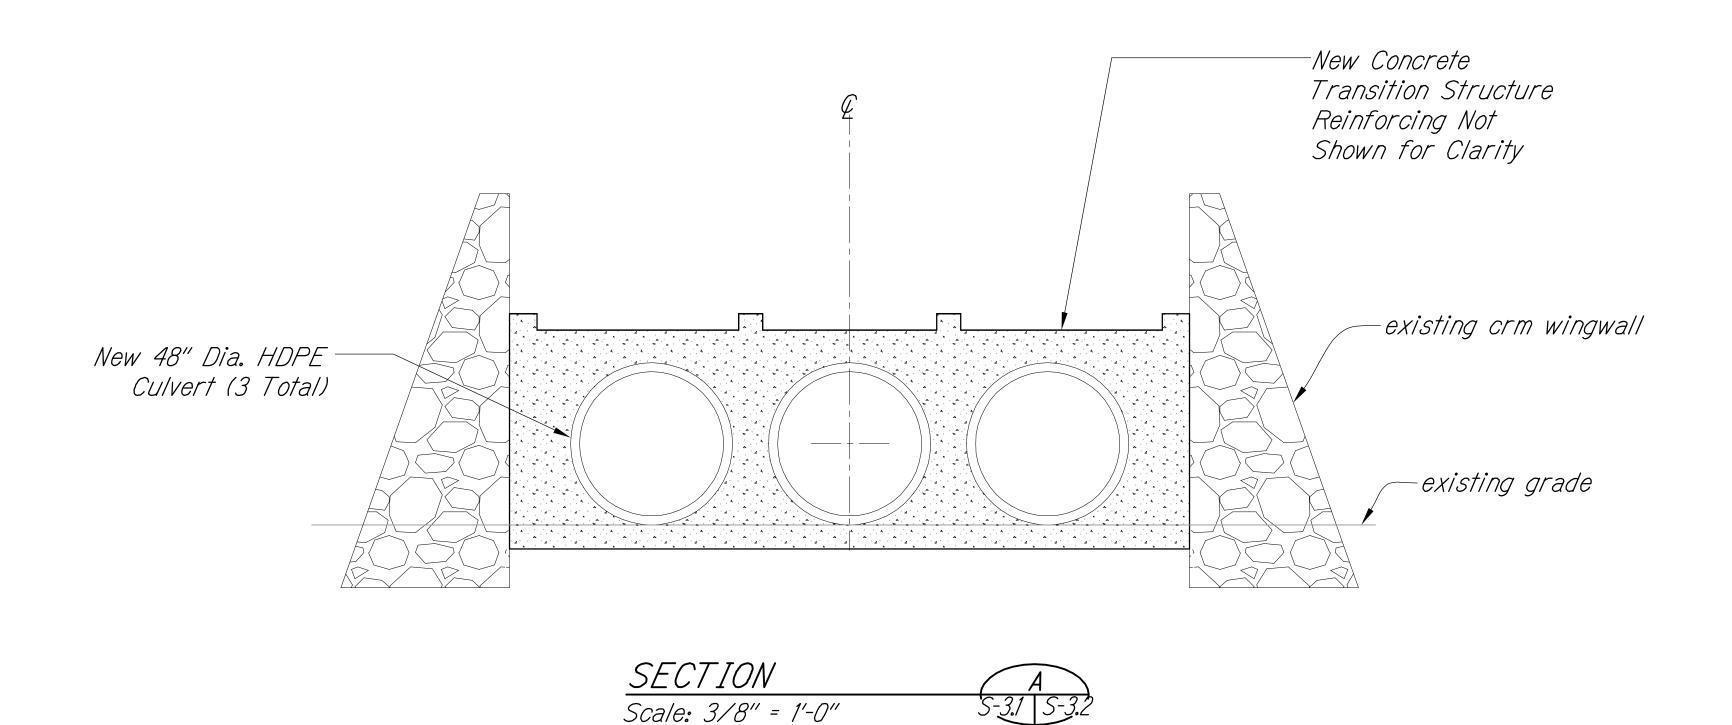
QUEEN KAAHUMANU HIGHWAY WIDENING

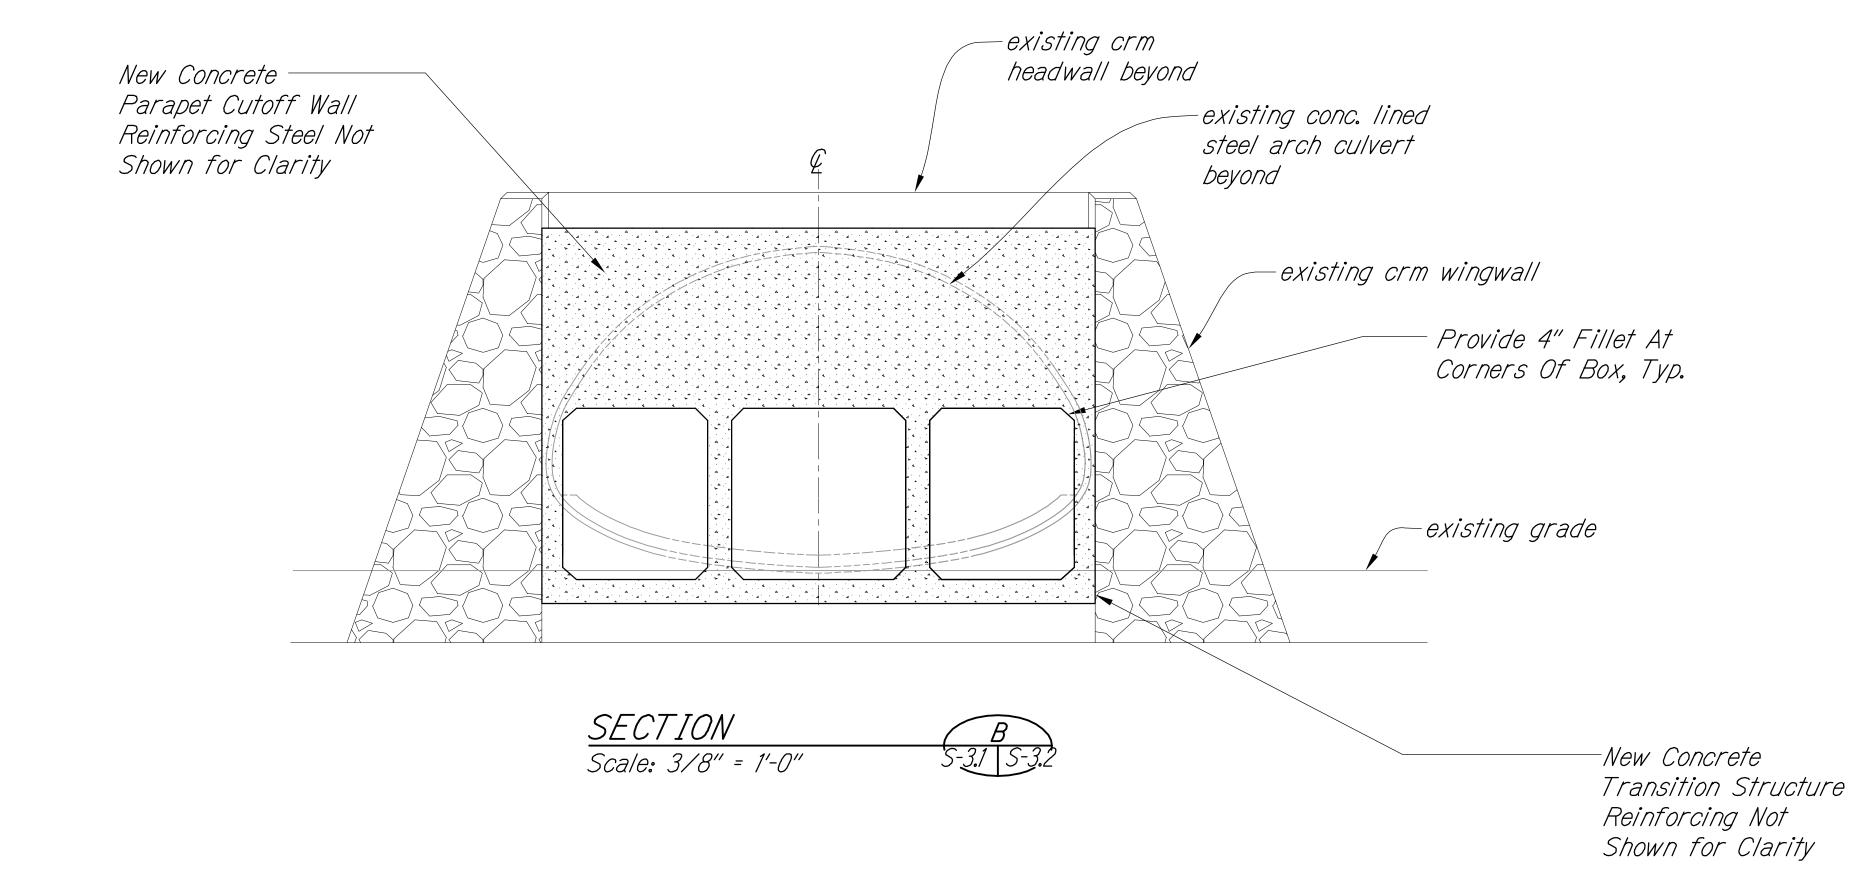
<u>Kealakehe Pkwy. To Keahole Airport Rd. (Ph. 2)</u> Federal Aid Project No. NH-019-1(38)R

Scale: AS NOTED Date: AUGUST 2016 SHEET No. S-3.1 OF 18 SHEETS

8/16/2016 2:36 PM








#### LEGEND FOR AS-BUILT POSTINGS

Squiggly line for as-built deletion

Double line for as-built deletion

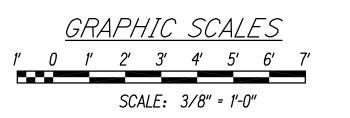Roadway Text for as-built posting



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APRIL 30, 2018

EXPIRATION DATE
OF THE LICENSE

8/16/2016 2:36 PM

STATE OF HAWAII

DEPARTMENT OF TRANSPORTATION

HIGHWAYS DIVISION

FDIINTIIDAI ADNU TO TDIDIE TDANCITION CTDIN


# STRUCTURAL ARCH TO TRIPLE TRANSITION STRUCTURE SECTIONS

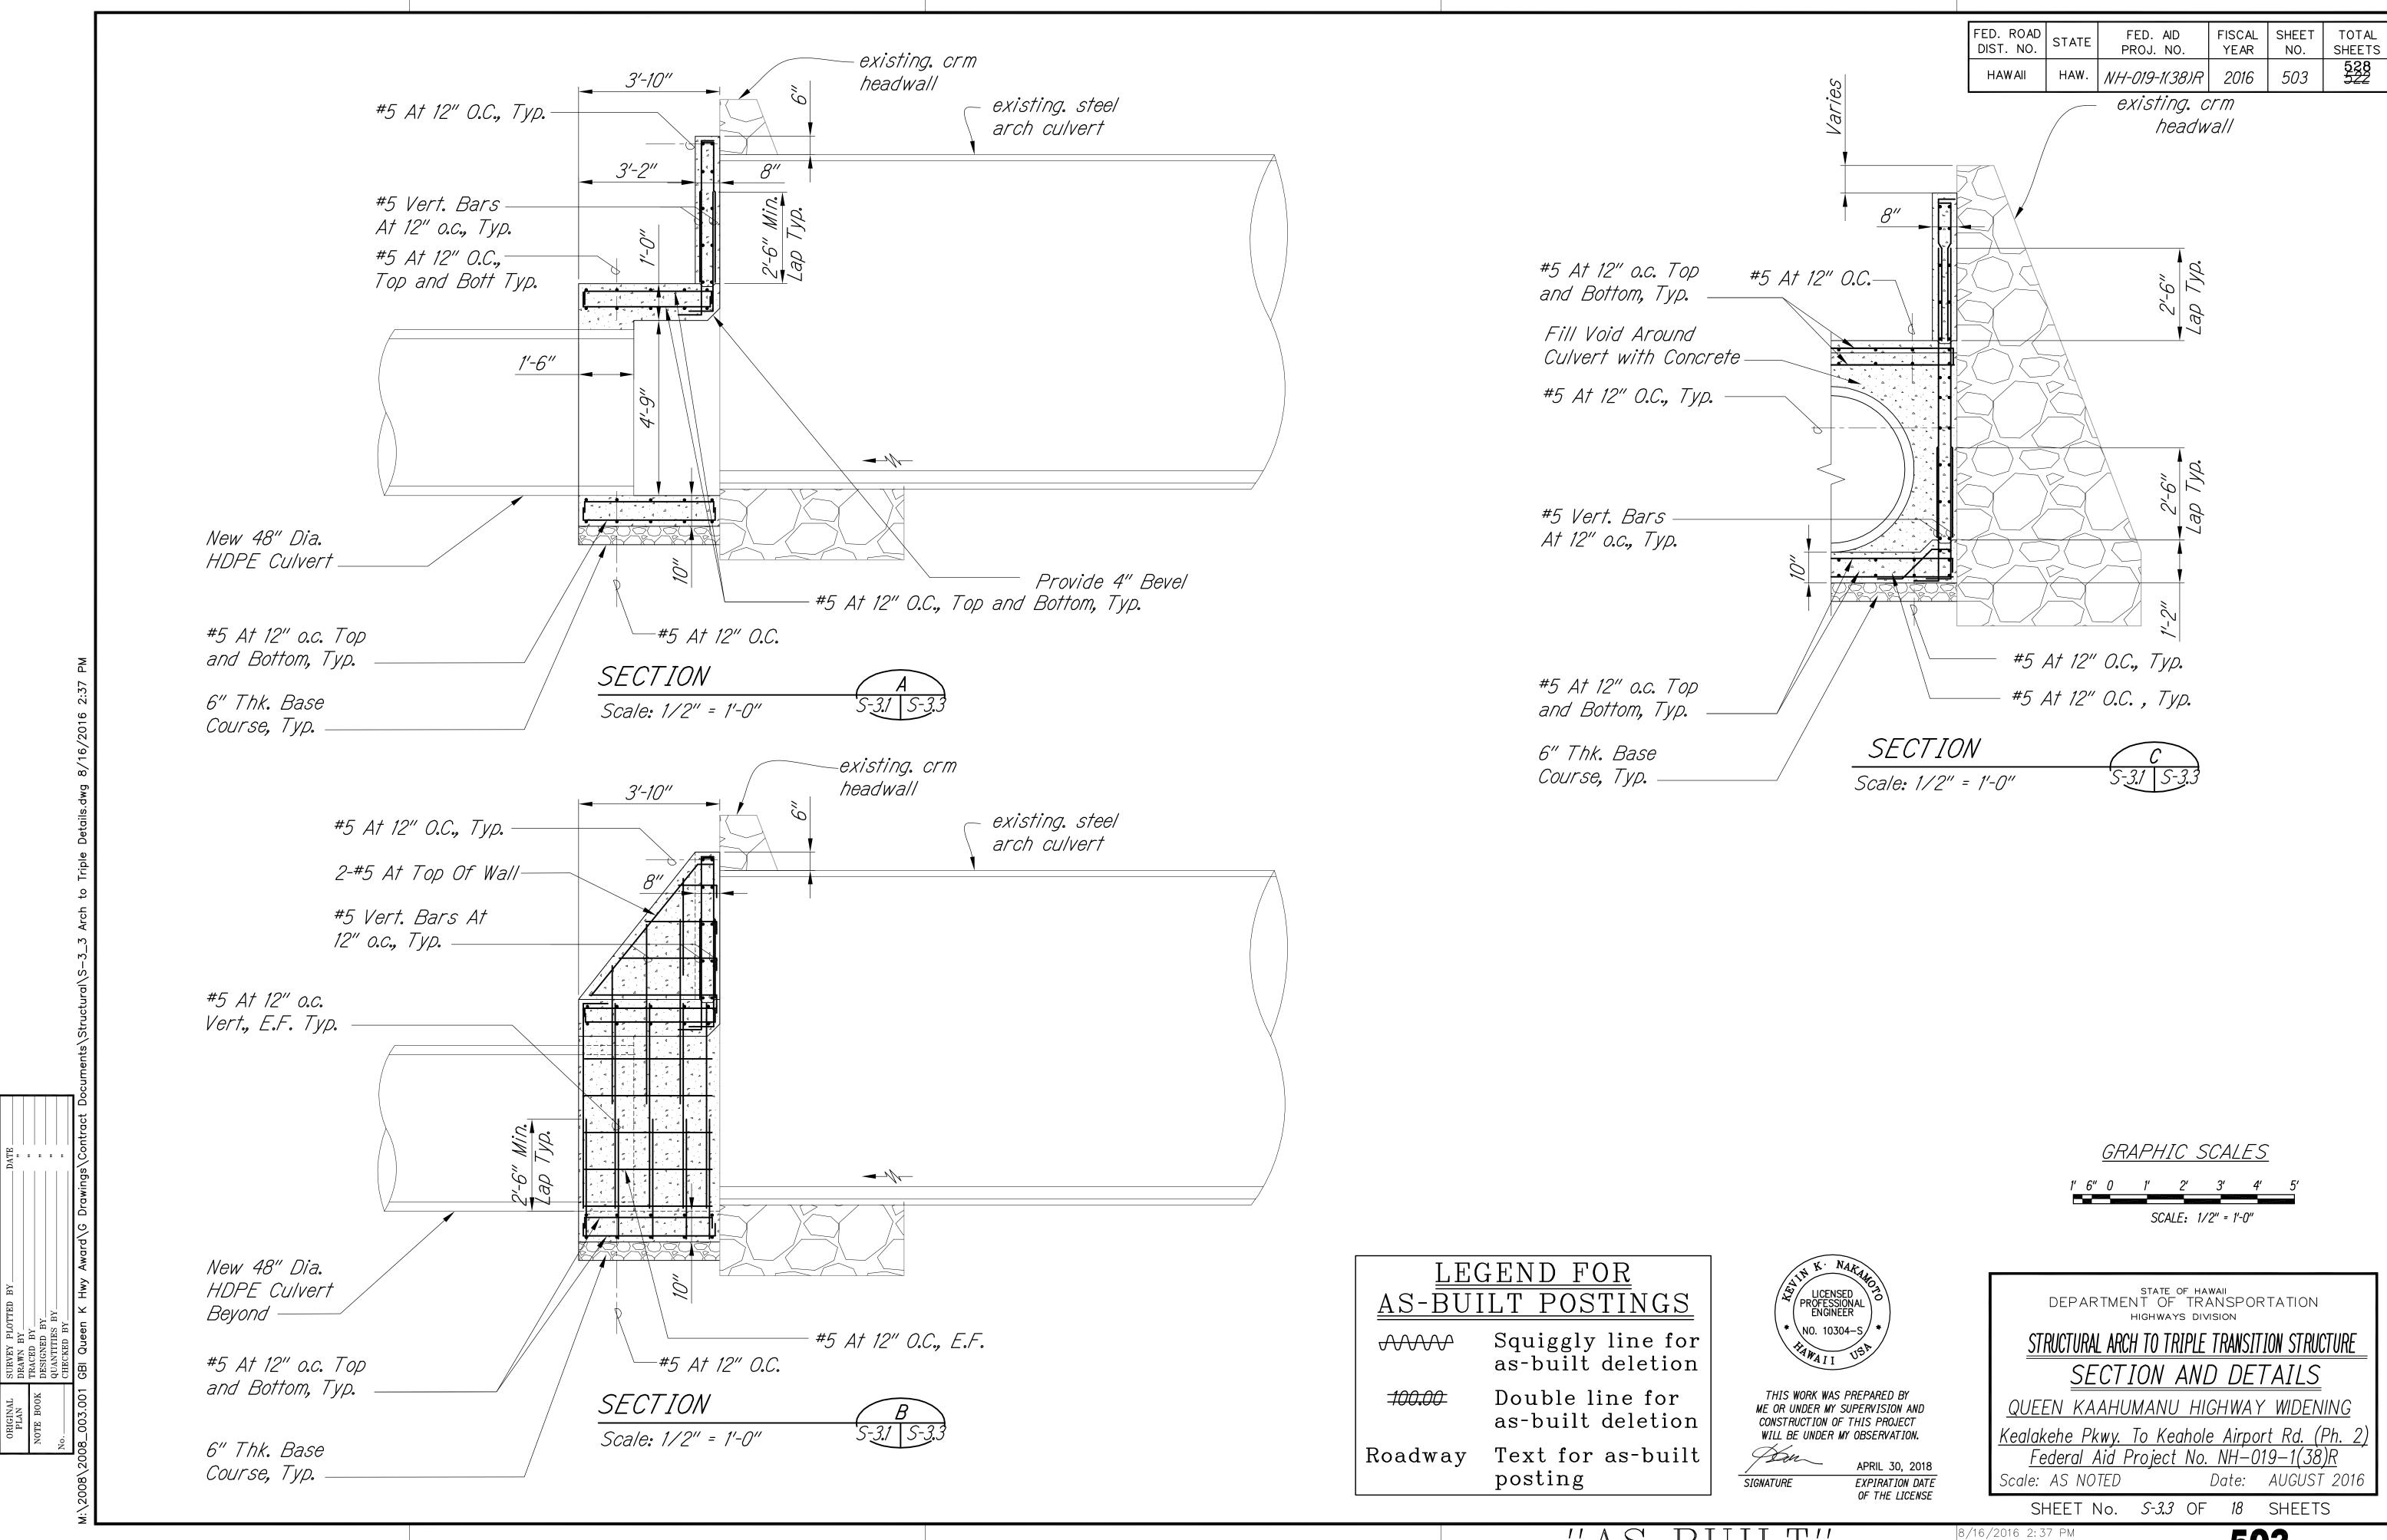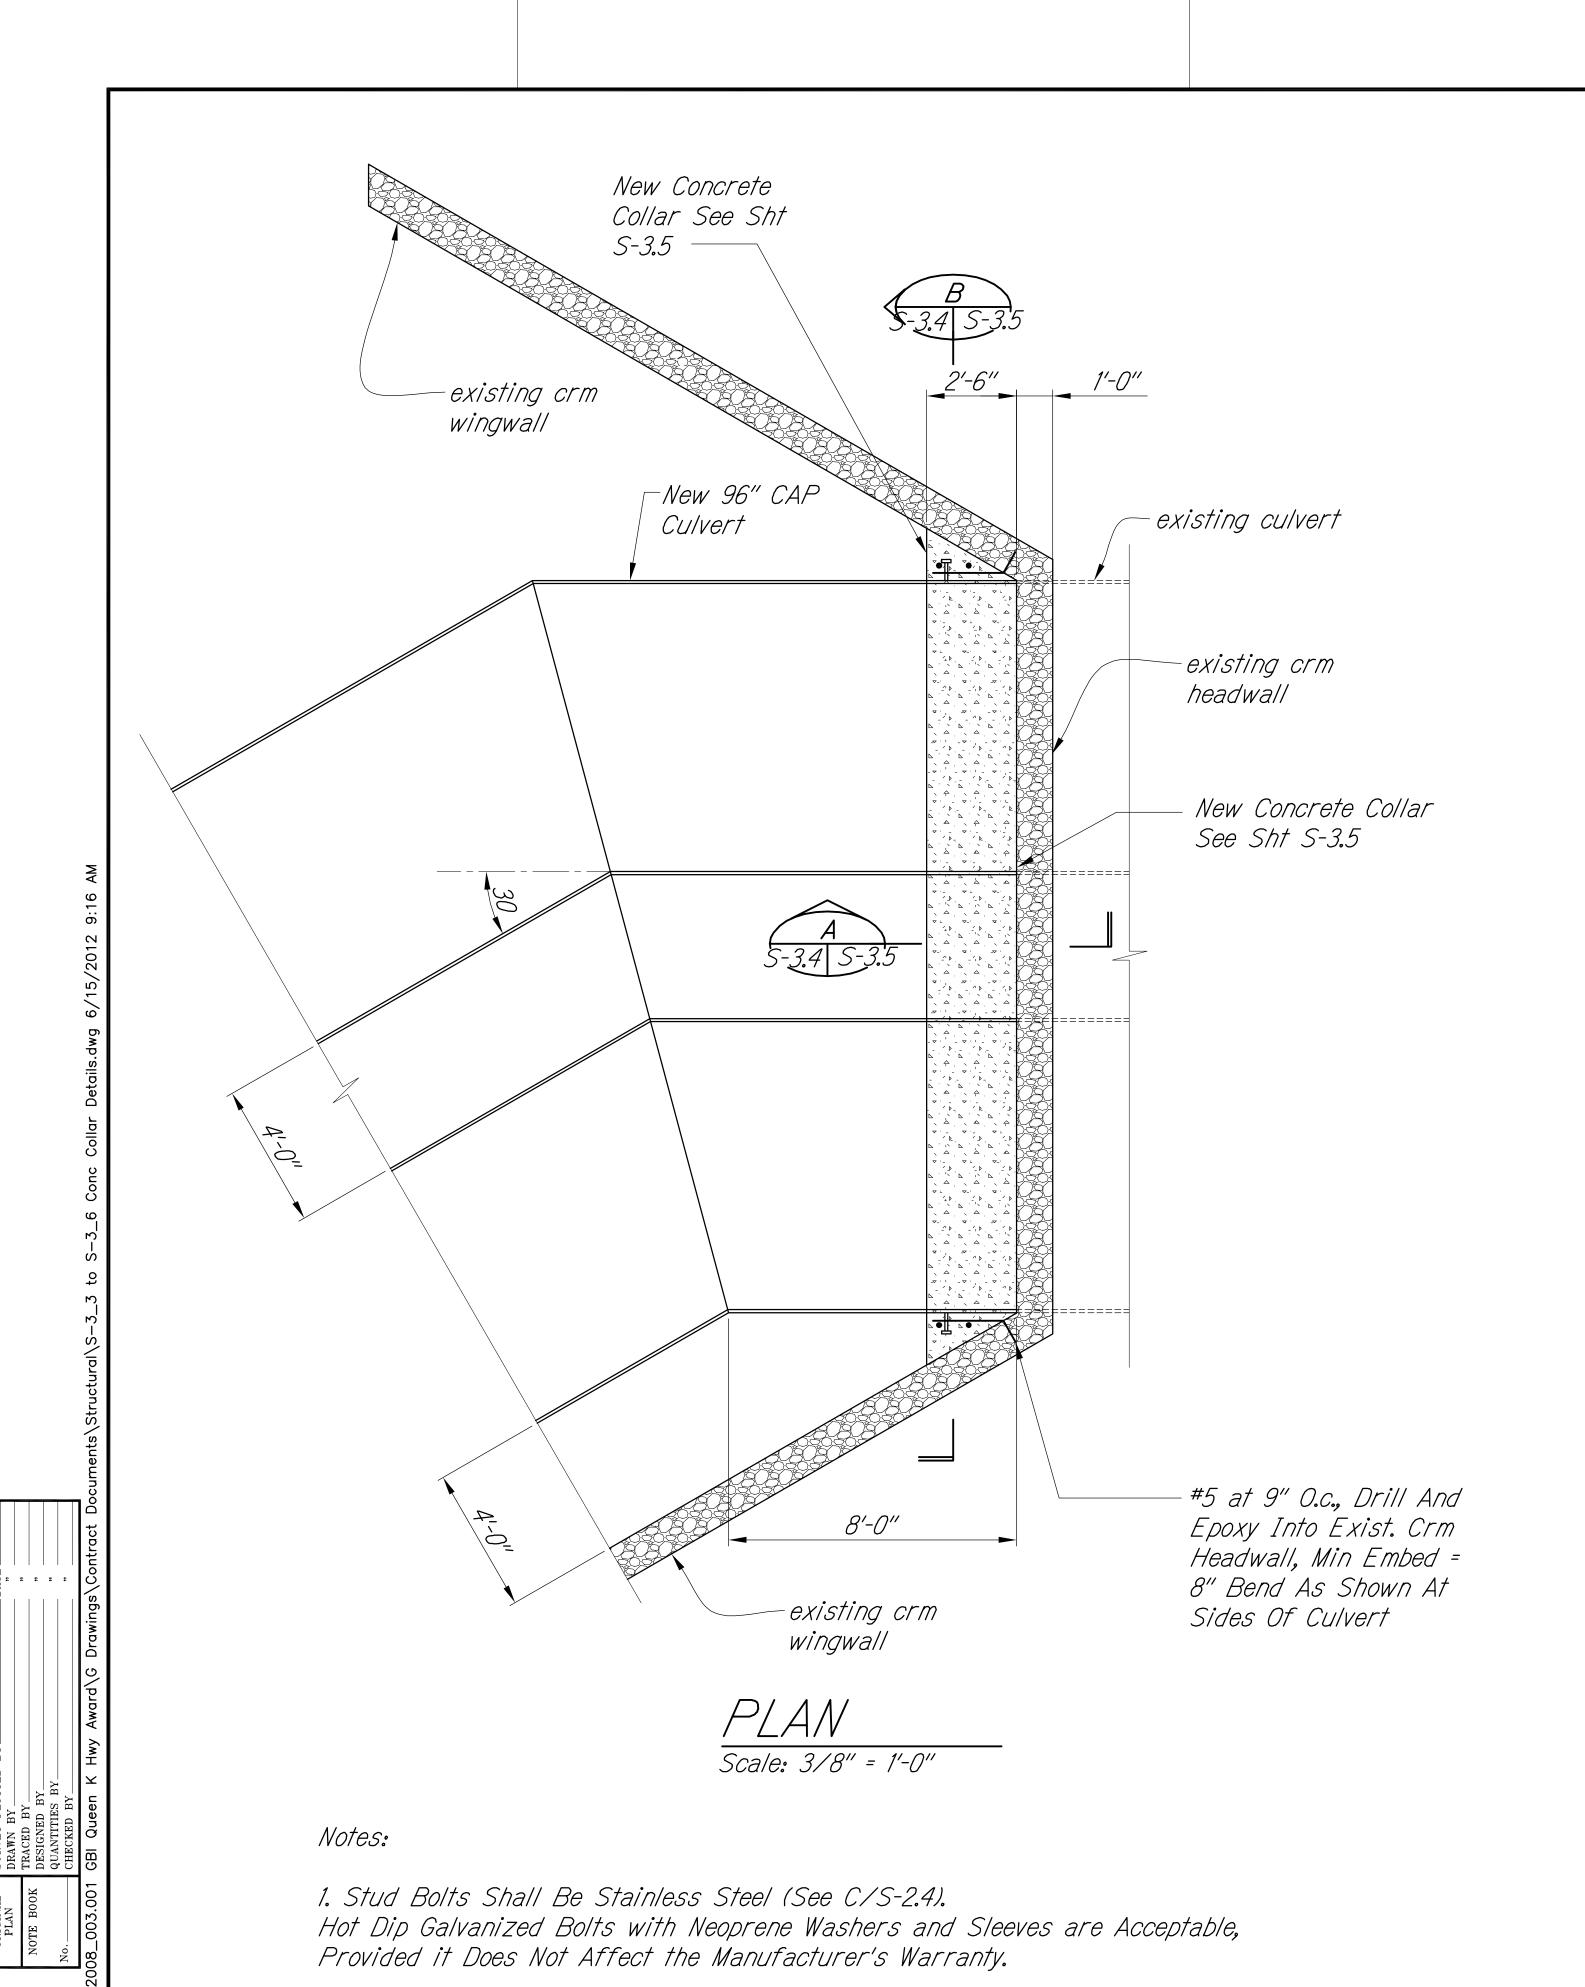
QUEEN KAAHUMANU HIGHWAY WIDENING

Kealakehe Pkwy. To Keahole Airport Rd. (Ph. 2)
Federal Aid Project No. NH-019-1(38)R
Scale: AS NOTED Date: AUGUST 2016


SHEET No. *S-3,2* OF *18* SHEETS

3 3.2 01 10





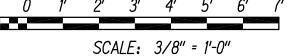FED. ROAD DIST. NO. FISCAL SHEET YEAR NO. FED. AID PROJ. NO. HAW. NH-019-1(38)R 504 2016



GRAPHIC SCALES

AS-BUILT POSTINGS


LEGEND FOR

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Double line for

as-built deletion

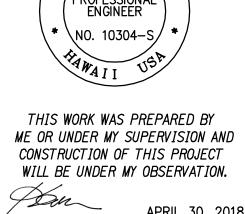Text for as-built Roadway posting



APRIL 30, 2018

EXPIRATION DATE OF THE LICENSE

STATE OF HAWAII
DEPARTMENT OF TRANSPORTATION
HIGHWAYS DIVISION

CULVERT L CONCRETE COLLAR PLAN

QUEEN KAAHUMANU HIGHWAY WIDENING

<u>Kealakehe Pkwy. To Keahole Airport Rd. (Ph. 2)</u> <u>Federal Aid Project No. NH-019-1(38)R</u> Scale: AS NOTED Date: AUGUST 2016


SHEET No. *S-3.4* OF *18* SHEETS

8/16/2016 2:38 PM

**504** 

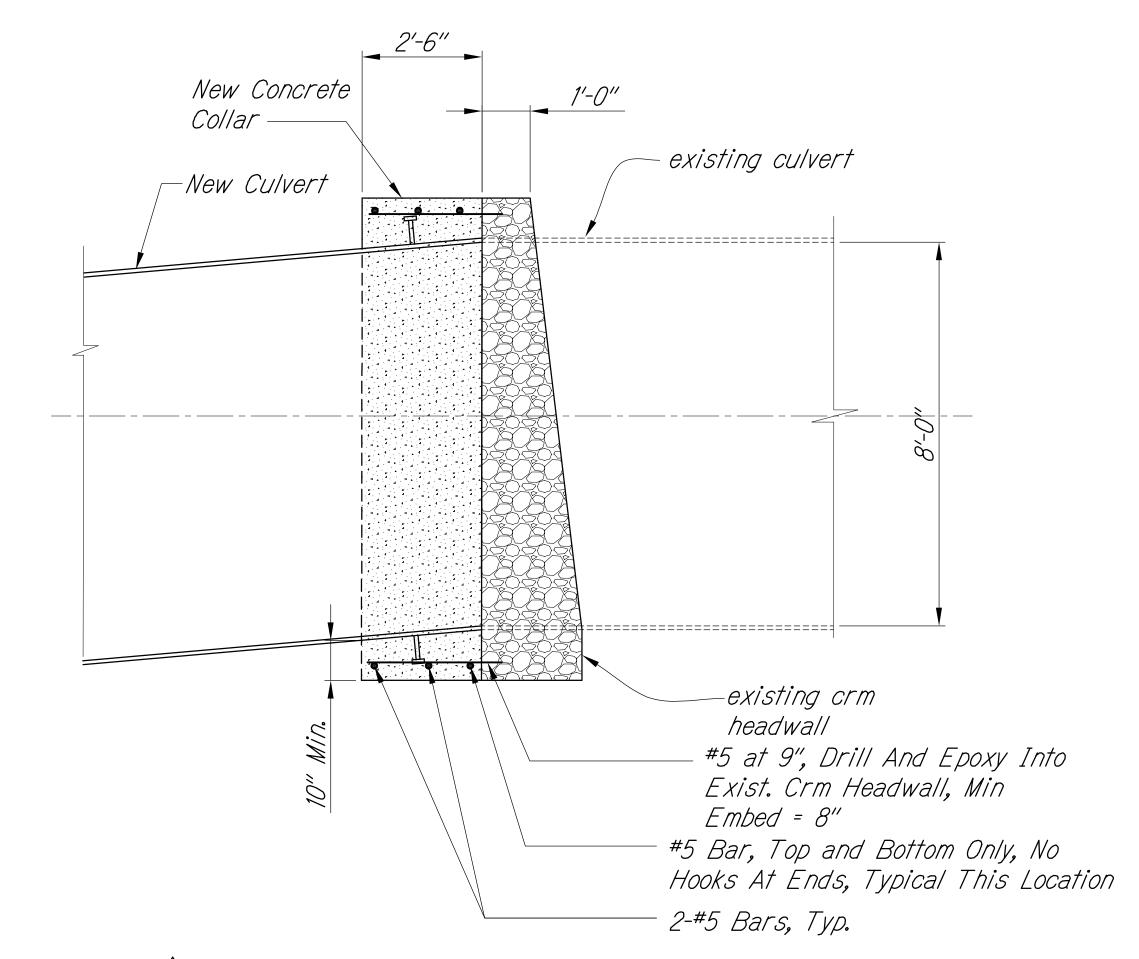SIGNATURE


FED. ROAD	STATE	FED. AID	FISCAL	SHEET	TOTAL
DIST. NO.		PROJ. NO.	YEAR	NO.	SHEETS
HAWAII	HAW.	NH-019-1(38)R	2016	505	528 <del>522</del>



SECTION WITH EXISTING HEADWALL O Scale: 1/2" = 1'-0"

Note:

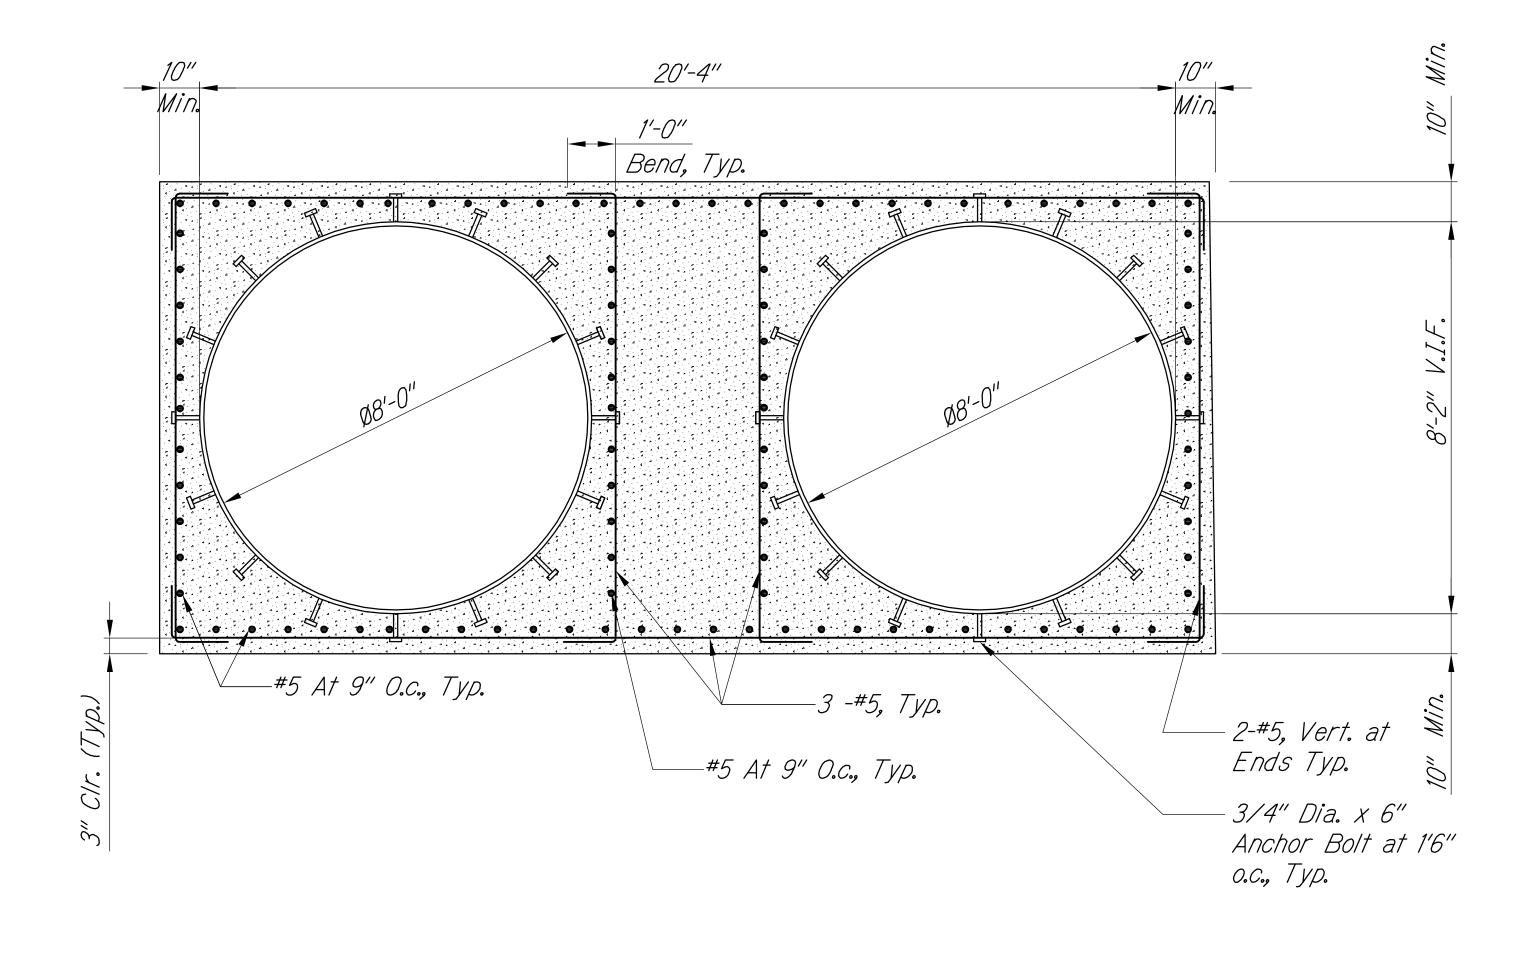1. Stud Bolts Shall Be Stainless Steel (See C/S-2.4). Hot Dip Galvanized Bolts with Neoprene Washers and Sleeves are Acceptable, Provided it Does Not Affect the Manufacturer's Warranty.




<u>SECTION</u> Scale: 1/2" = 1'-0"

#### LEGEND FOR AS-BUILT POSTINGS
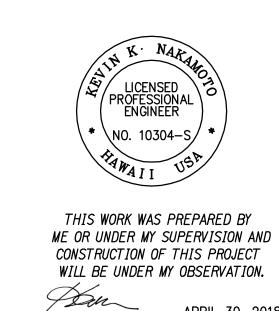
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*100.00* Double line for as-built deletion

Text for as-built Roadway posting



SIGNATURE

DATE

02/18/16

STATE OF HAWAII
DEPARTMENT OF TRANSPORTATION
HIGHWAYS DIVISION REINFORCED CONCRETE COLLAR AT DUAL 96" CULVERT

SECTIONS AND DETAILS

GRAPHIC SCALES

1' 6" 0 1' 2' 3' 4' 5'

REVISION

Modified title for Section A

SCALE: 1/2" = 1'-0"

QUEEN KAAHUMANU HIGHWAY WIDENING <u>Kealakehe Pkwy. To Keahole Airport Rd. (Ph. 2)</u> <u>Federal Aid Project No. NH-019-1(38)R</u>

Scale: AS NOTED Date: AUGUST 2016 SHEET No. S-3.5 OF 18 SHEETS

APRIL 30, 2018


EXPIRATION DATE

OF THE LICENSE

8/19/2016 10:29 AM

**505** 

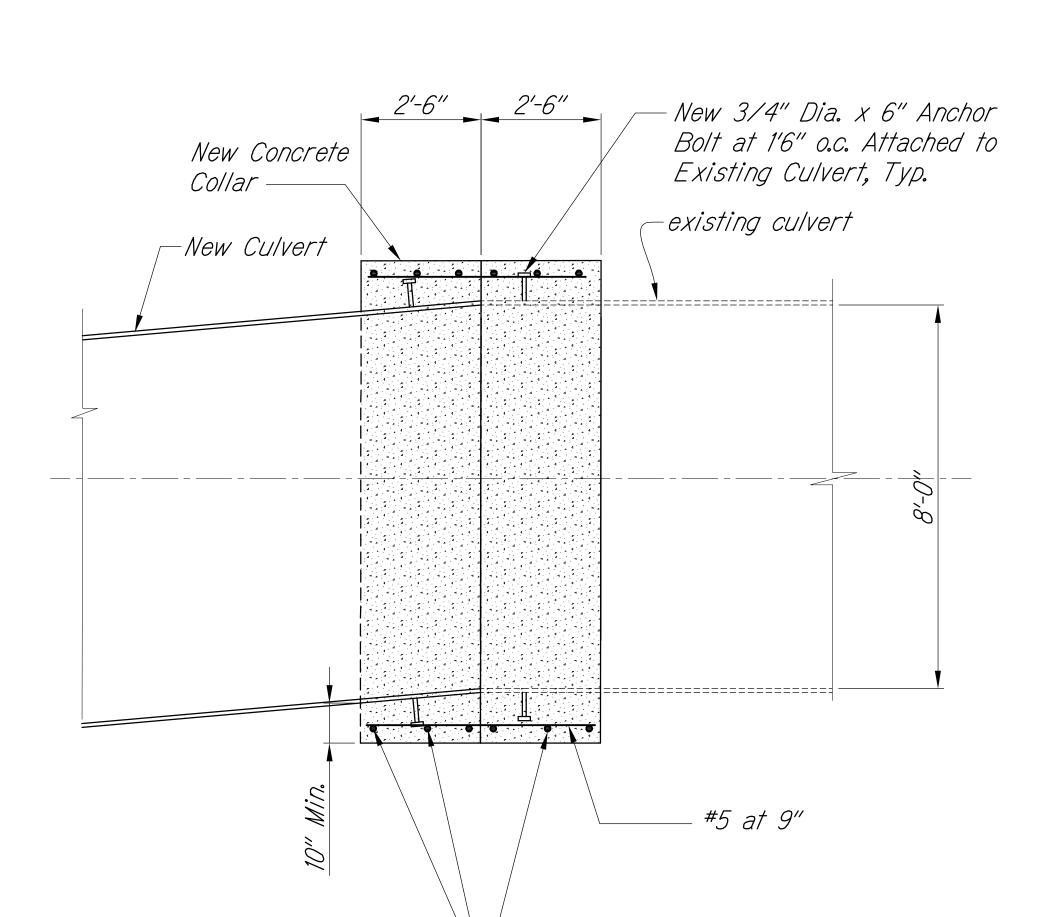"AS-BUILT"







#5 Bars, Typ.

Note:

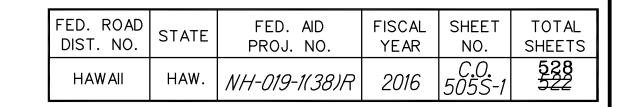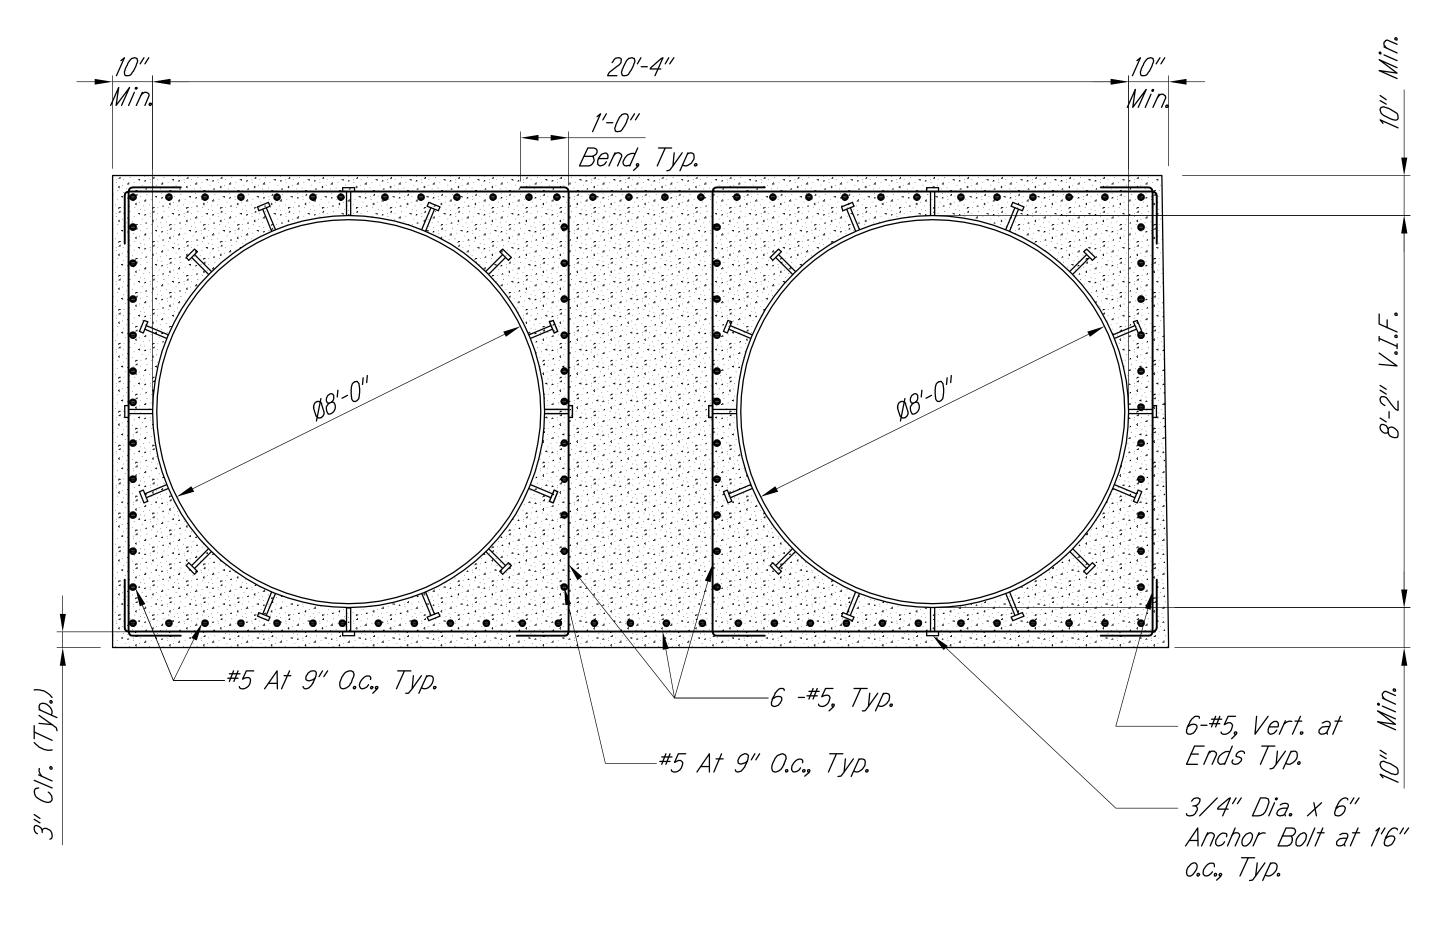1. Stud Bolts Shall Be Stainless Steel (See C/S-2.4). Hot Dip Galvanized Bolts with Neoprene Washers and Sleeves are Acceptable, Provided it Does Not Affect the Manufacturer's Warranty.





SECTION Scale: 1/2" = 1'-0" 5-3.4 S-3.5A

#### GRAPHIC SCALES



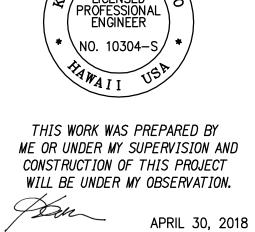
SCALE: 1/2" = 1'-0"

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Double line for

as-built deletion Text for as-built Roadway posting



EXPIRATION DATE OF THE LICENSE

Sheet added to show the concrete collar detail for Culvert B 02/18/16 REVISION

STATE OF HAWAII
DEPARTMENT OF TRANSPORTATION
HIGHWAYS DIVISION

#### REINFORCED CONCRETE COLLAR AT DUAL 96" CULVERT SECTIONS AND DETAILS

QUEEN KAAHUMANU HIGHWAY WIDENING

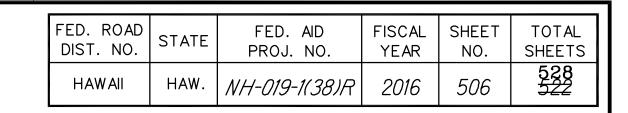
<u>Kealakehe Pkwy. To Keahole Airport Rd. (Ph. 2)</u> <u>Federal Aid Project No. NH-019-1(38)R</u> Scale: AS NOTED Date: AUGUST 2016

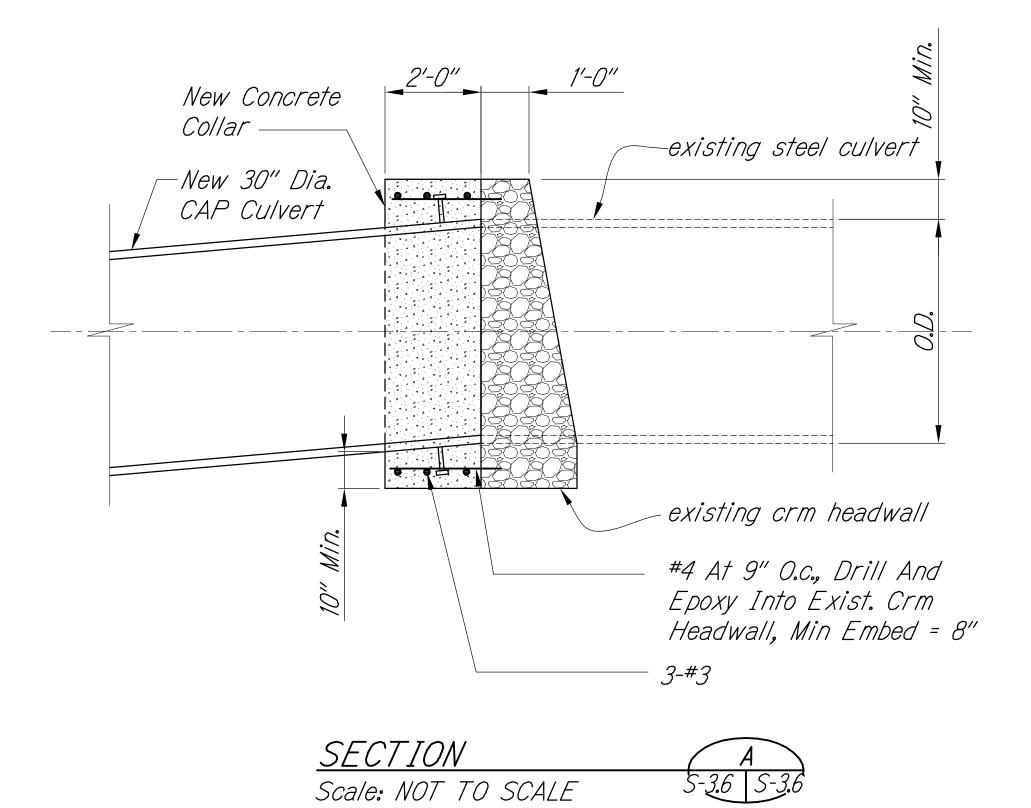
SHEET No. S-3.5A OF 18 SHEETS

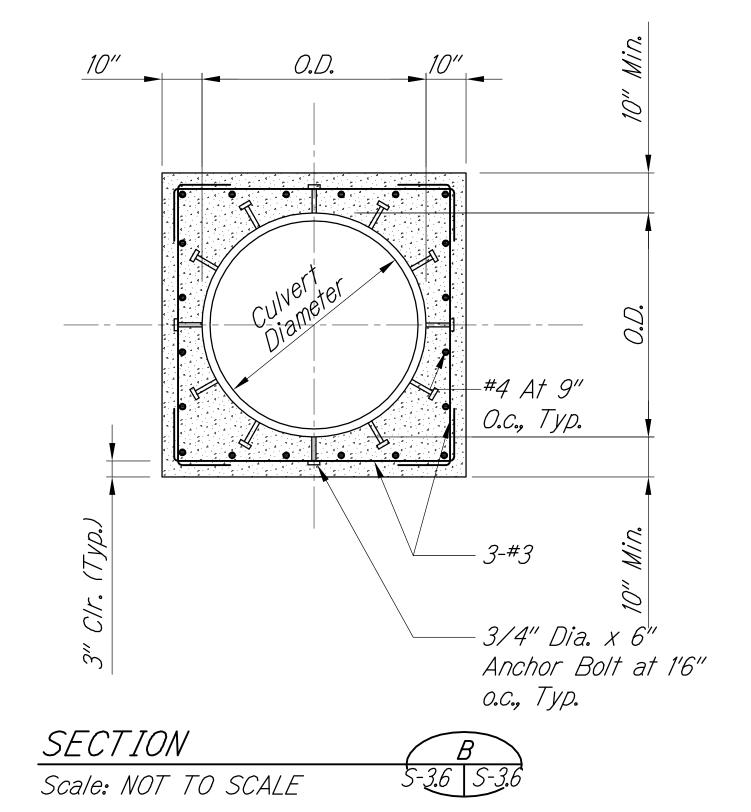
"AS-BUILT"

SIGNATURE


C.O. 505 S-1







B-3.6 S-3.6

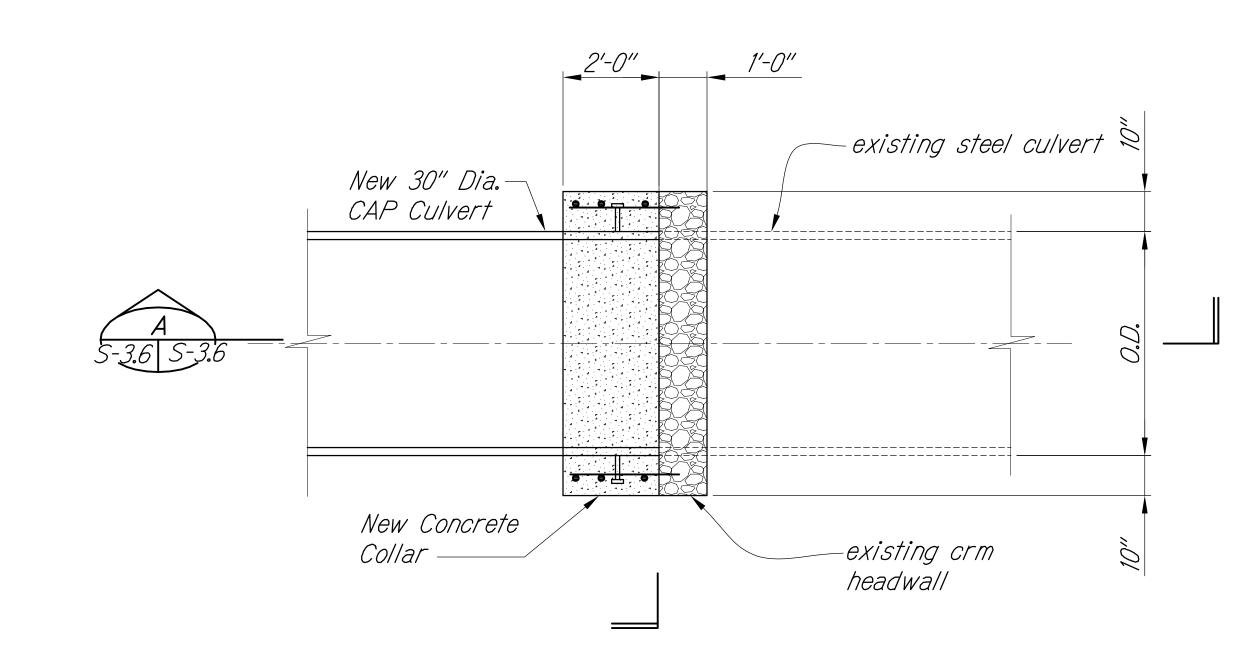

PLAN

Scale: NOT TO SCALE

Note:

1. Stud Bolts Shall Be Stainless Steel (See C/S-2.4). Hot Dip Galvanized Bolts with Neoprene Washers and Sleeves are Acceptable, Provided it Does Not Affect the Manufacturer's Warranty.

#### LEGEND FOR AS-BUILT POSTINGS

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Roadway Text for as-built posting

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APRIL 30, 2018

EXPIRATION DATE OF THE LICENSE STATE OF HAWAII
DEPARTMENT OF TRANSPORTATION
HIGHWAYS DIVISION

## REINFORCED CONCRETE COLLAR (NO WINGWALLS) PLAN AND SECTION

PLAN AND SECTION

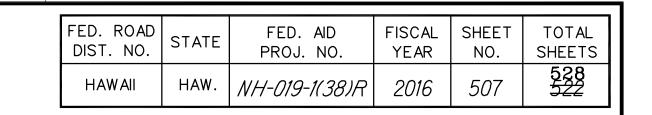
QUEEN KAAHUMANU HIGHWAY WIDENING

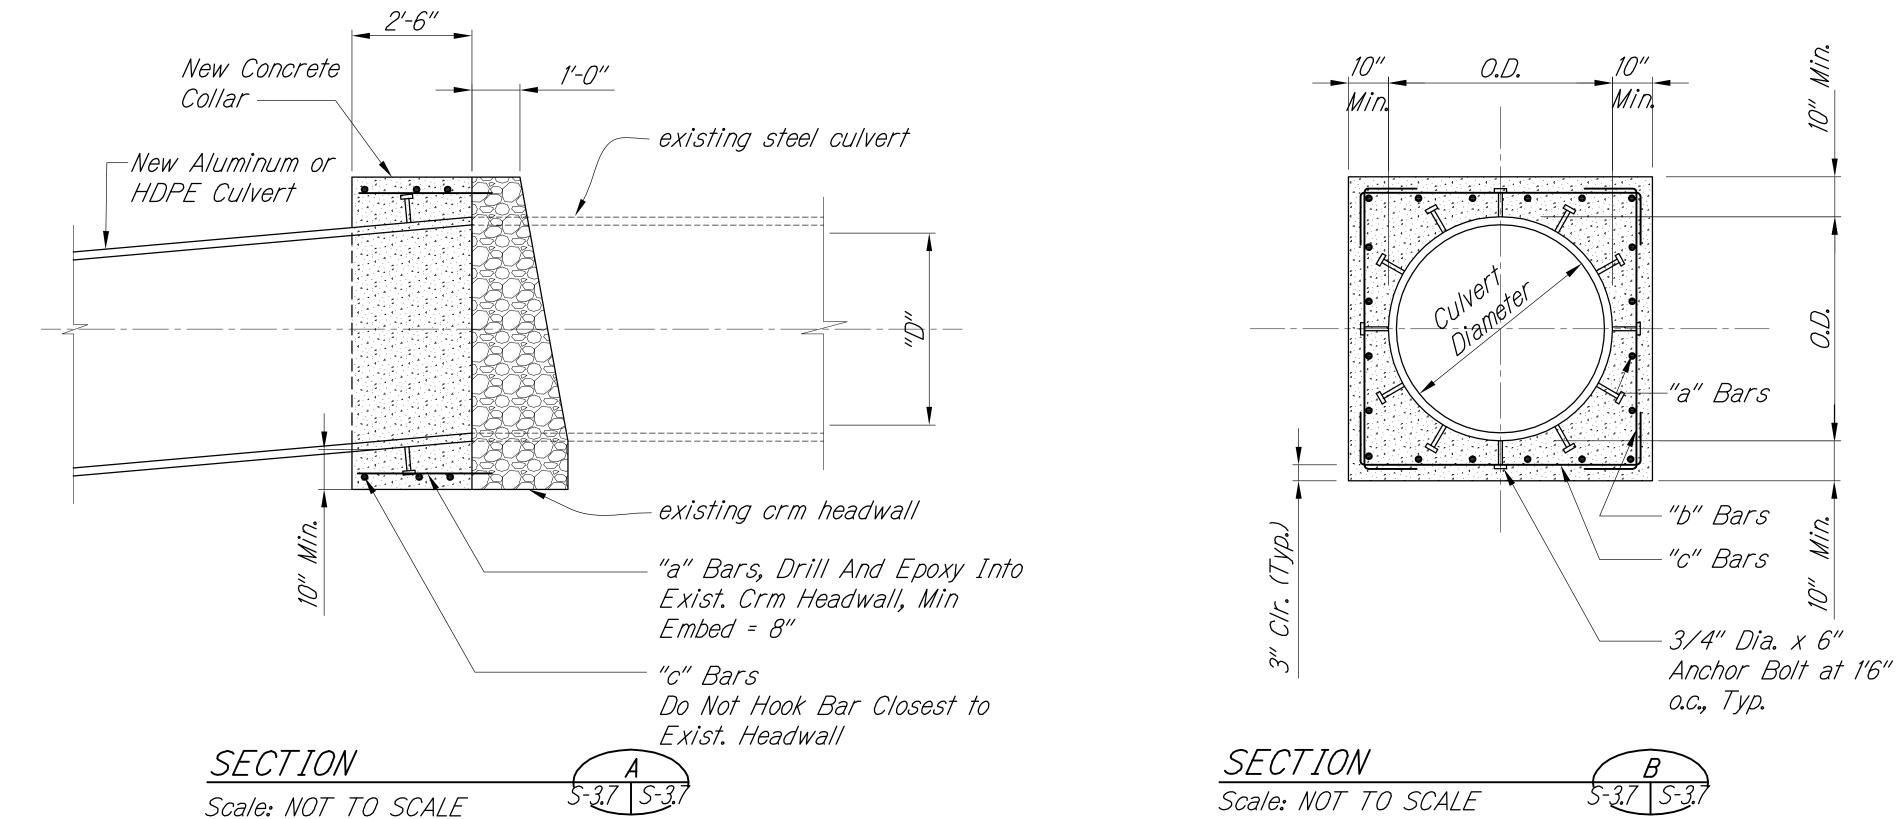
<u>Kealakehe Pkwy. To Keahole Airport Rd. (Ph. 2)</u> <u>Federal Aid Project No. NH-019-1(38)R</u>

Scale: AS NOTED Date: AUGUST 2016

SHEET No. S-3.6 OF 18 SHEETS

SIGNATURE





"b" Bars

\_\_\_\_\_

existing crm

Sides Of Culvert

"a" Bars, Drill And Epoxy Into

Embed = 8" Bend As Shown At

Exist. Crm Headwall, Min

headwall

existing steel culvert

New Concrete

-existing crm

wingwall

PLAN

Scale: NOT TO SCALE

Collar —

New Aluminum or

HDPE Culvert

Note:

1. Stud Bolts Shall Be Stainless Steel (See C/S-2.4). Hot Dip Galvanized Bolts with Neoprene Washers and Sleeves are Acceptable, Provided it Does Not Affect the Manufacturer's Warranty.

Culvert Diameter "D"	"a" Bars	"b" Bars	"c" Bars
18" to 30"	#4 at 9"	2 - #3	3 - #3
60" and Larger	#5 at 9"	2 - #5	3 - #5

#### LEGEND FOR AS-BUILT POSTINGS

Squiggly line for as-built deletion

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as-built deletion Roadway Text for as-built

Text for as-built posting

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APRIL 30, 2018

EXPIRATION DATE

OF THE LICENSE

STATE OF HAWAII
DEPARTMENT OF TRANSPORTATION
HIGHWAYS DIVISION

# REINFORCED CONCRETE COLLAR AT EXIST WINGWALLS PLAN AND SECTION

QUEEN KAAHUMANU HIGHWAY WIDENING

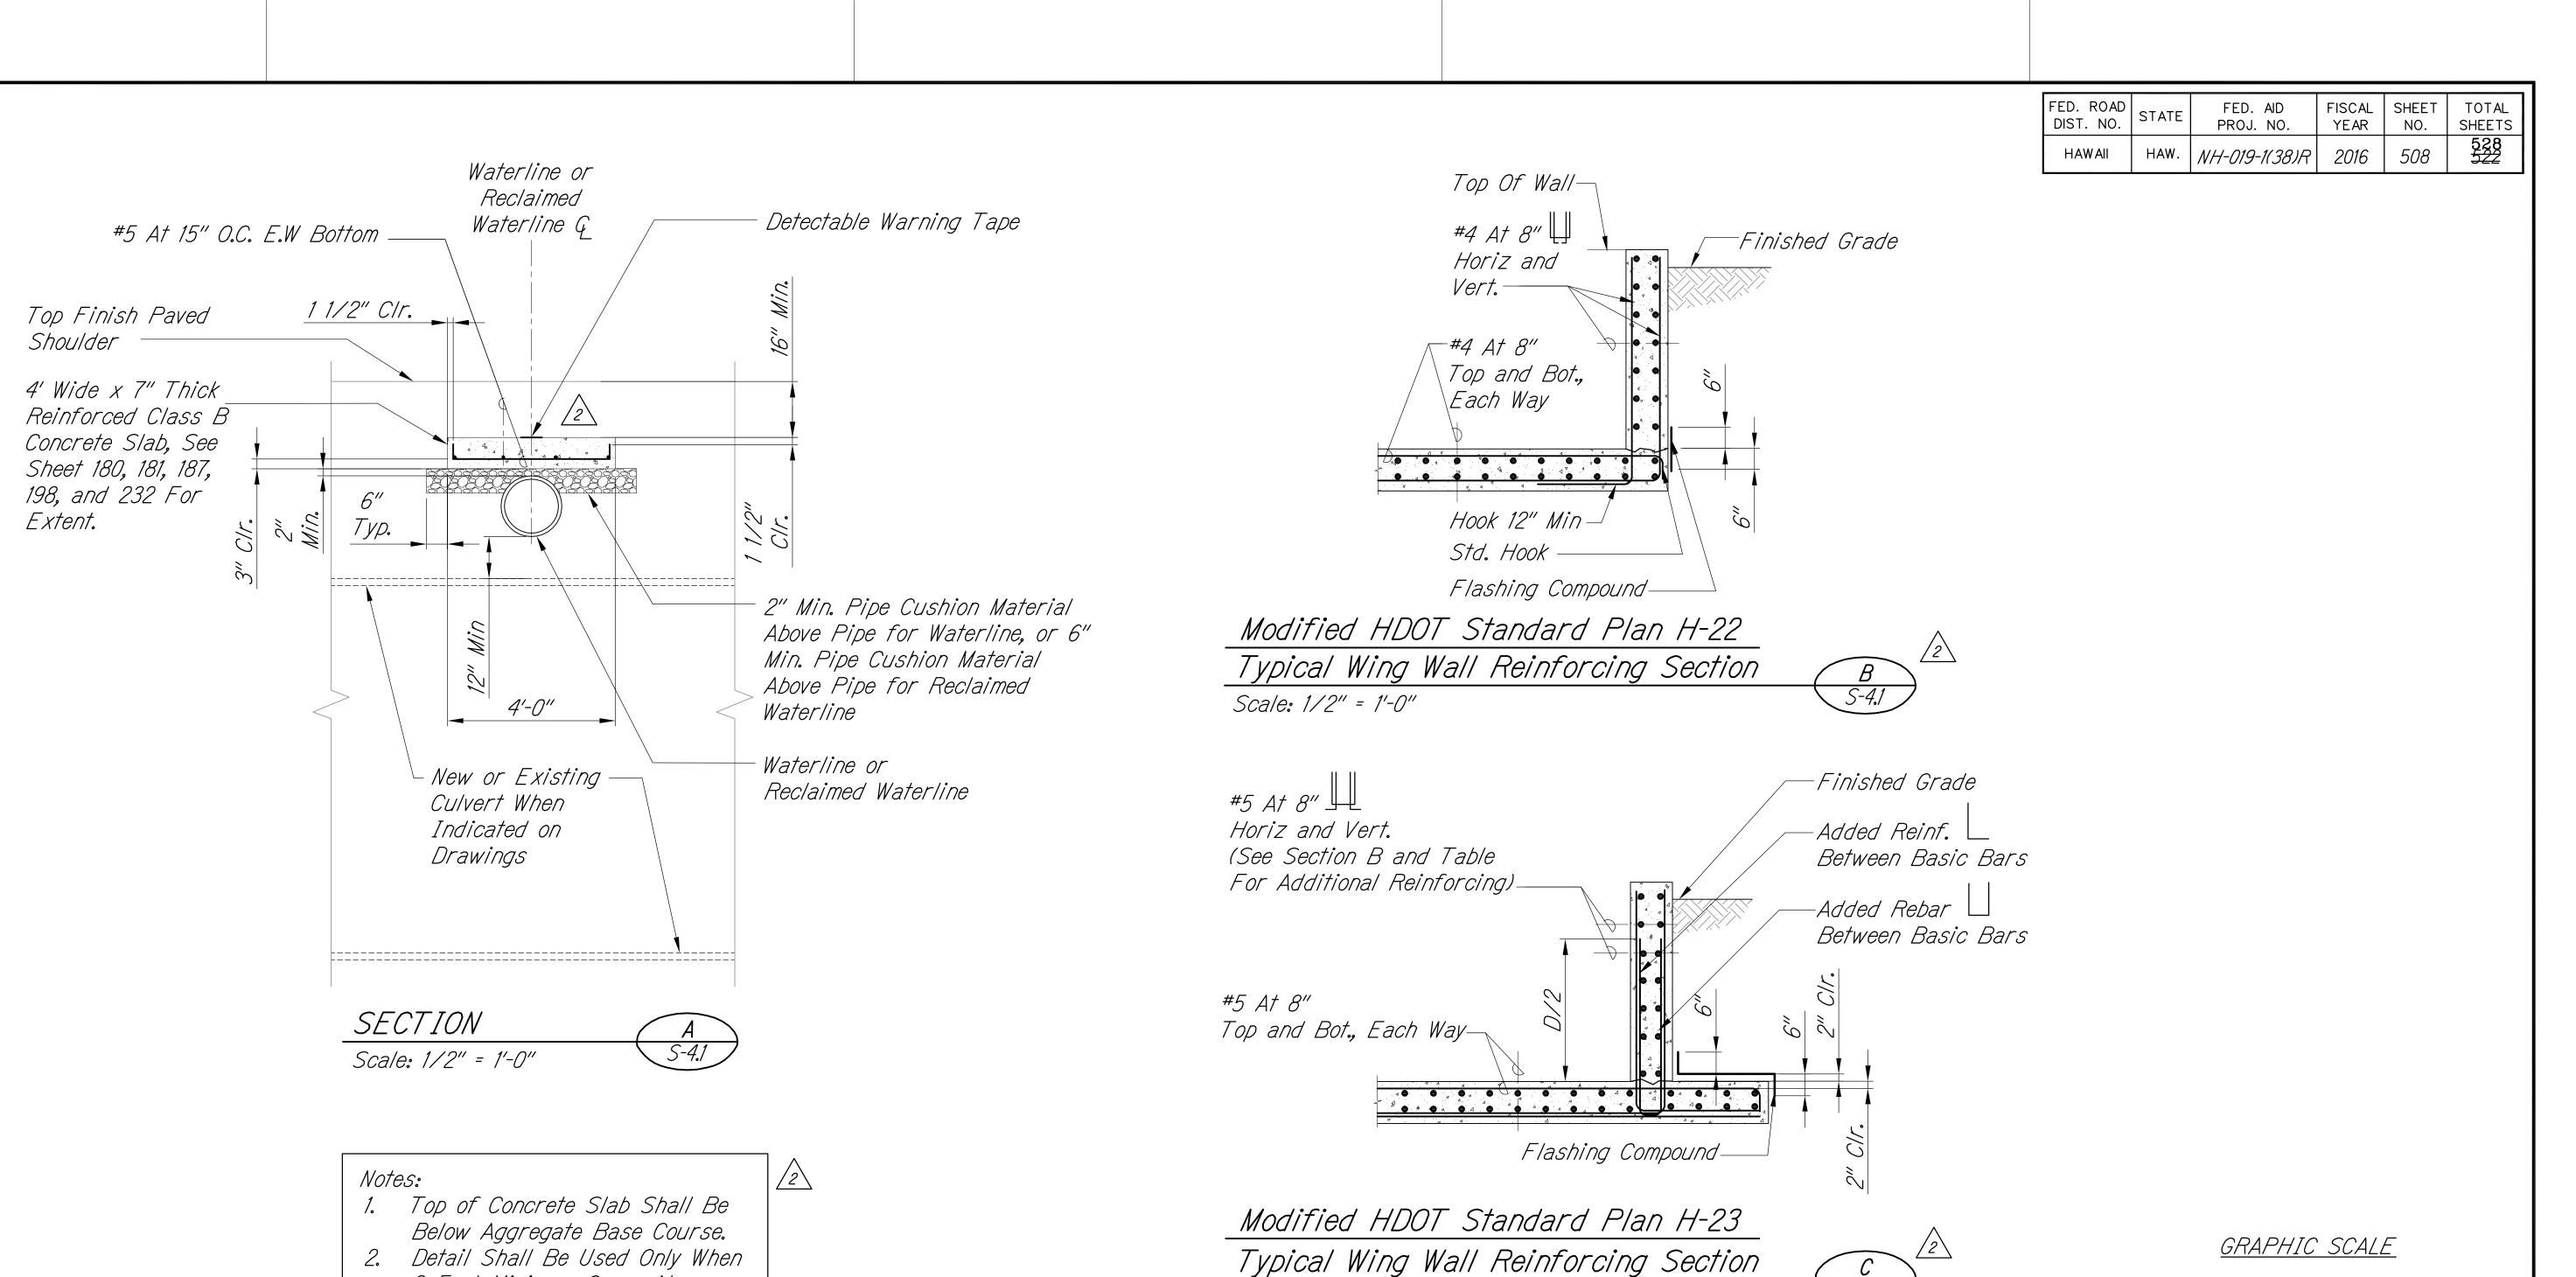
Kealakehe Pkwy. To Keahole Airport Rd. (Ph. 2)
Federal Aid Project No. NH-019-1(38)R
Scale: AS NOTED Date: AUGUST 2016

SHEET No. S-3.7 OF 18 SHEETS

8/16/2016 2:39 PM

"AS-BUILT"

**507** 



Scale: 1/2" = 1'-0"



3 Foot Minimum Cover Above

Cannot Be Met.

Waterline or Reclaimed Waterline

#### LEGEND FOR AS-BUILT POSTINGS

Squiggly line for **₩** 

as-built deletion Double line for

as-built deletion Roadway Text for as-built

posting



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SCALE: 1/2" = 1'-0" Added HDOT Wingwall Reinforcing Details. Added Modified HDOT Wingwall Details and Waterproofing Detail for Construction Joints. Modified Section A Drawing and Callouts and Added Notes

STATE OF HAWAII
DEPARTMENT OF TRANSPORTATION
HIGHWAYS DIVISION

### MISCELLANEOUS STRUCTURAL DETAILS

REVISION

QUEEN KAAHUMANU HIGHWAY WIDENING

<u>Kealakehe Pkwy. To Keahole Airport Rd. (Ph. 2)</u> Federal Aid Project No. NH-019-1(38)R Scale: AS NOTED Date: AUGUST 2016

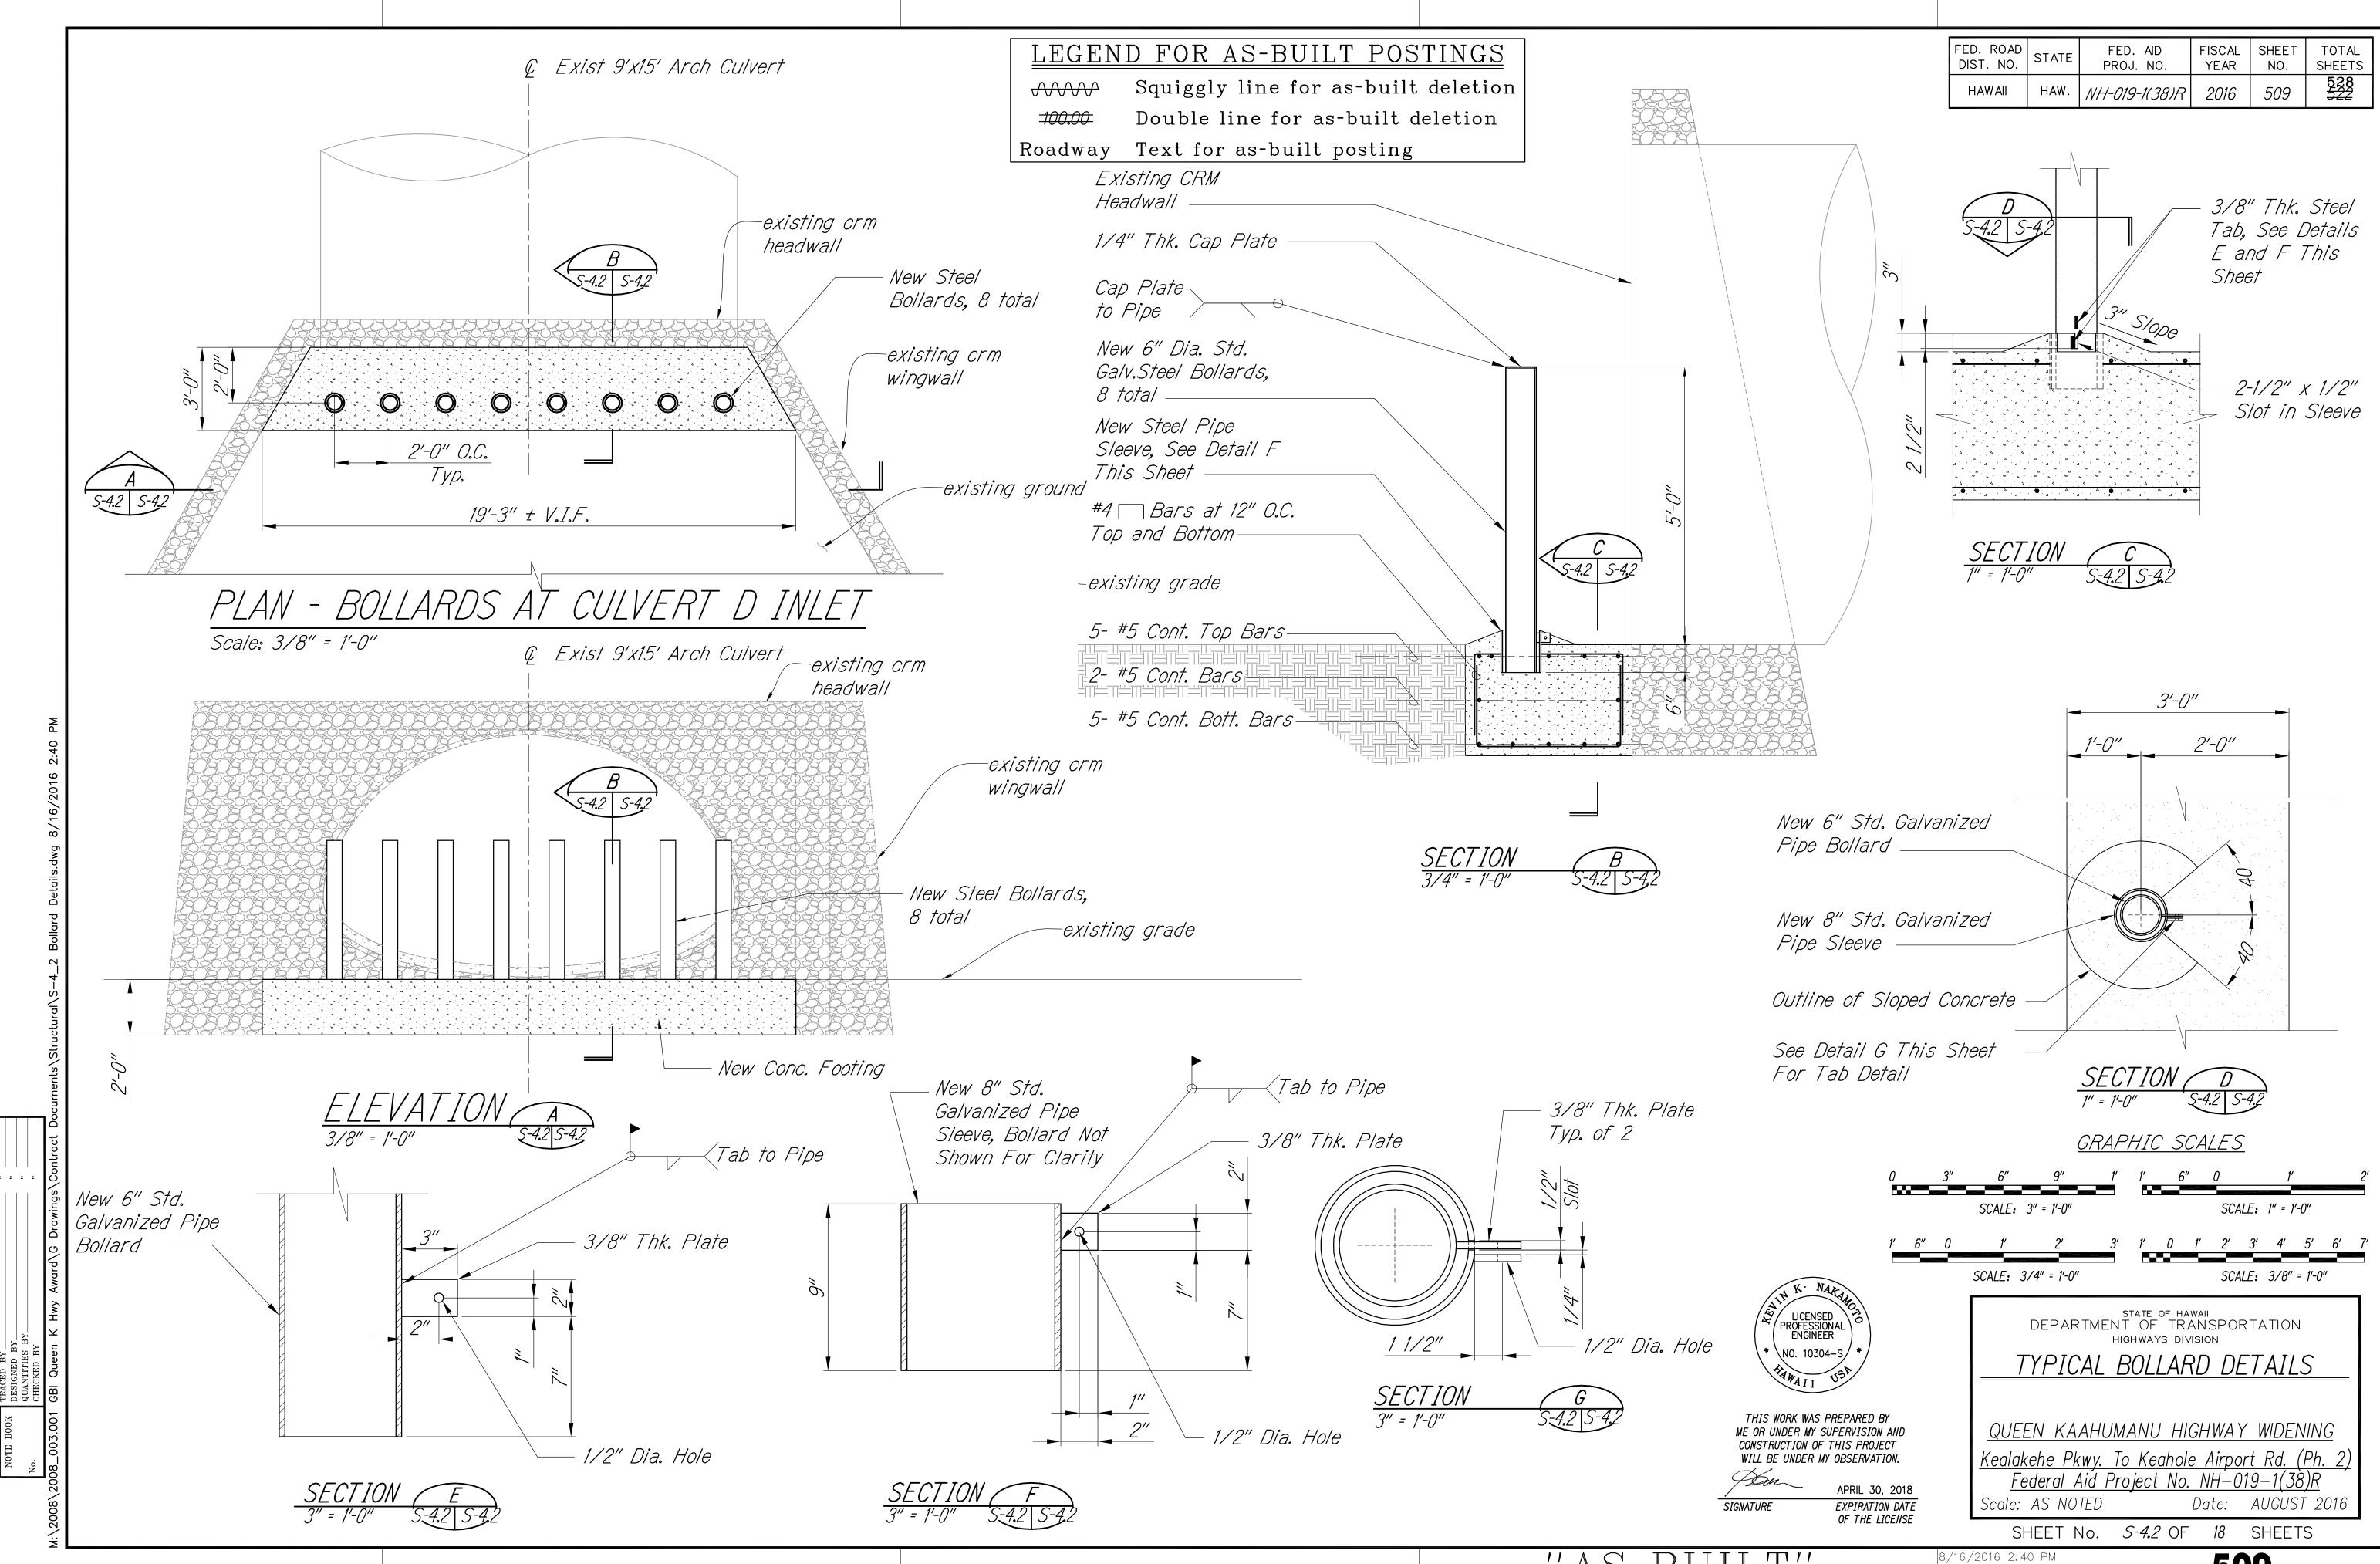
SHEET No. *S-4.1* OF 18 SHEETS

8/16/2016 2:07 PM


DATE

**508** 

OF THE LICENSE




509

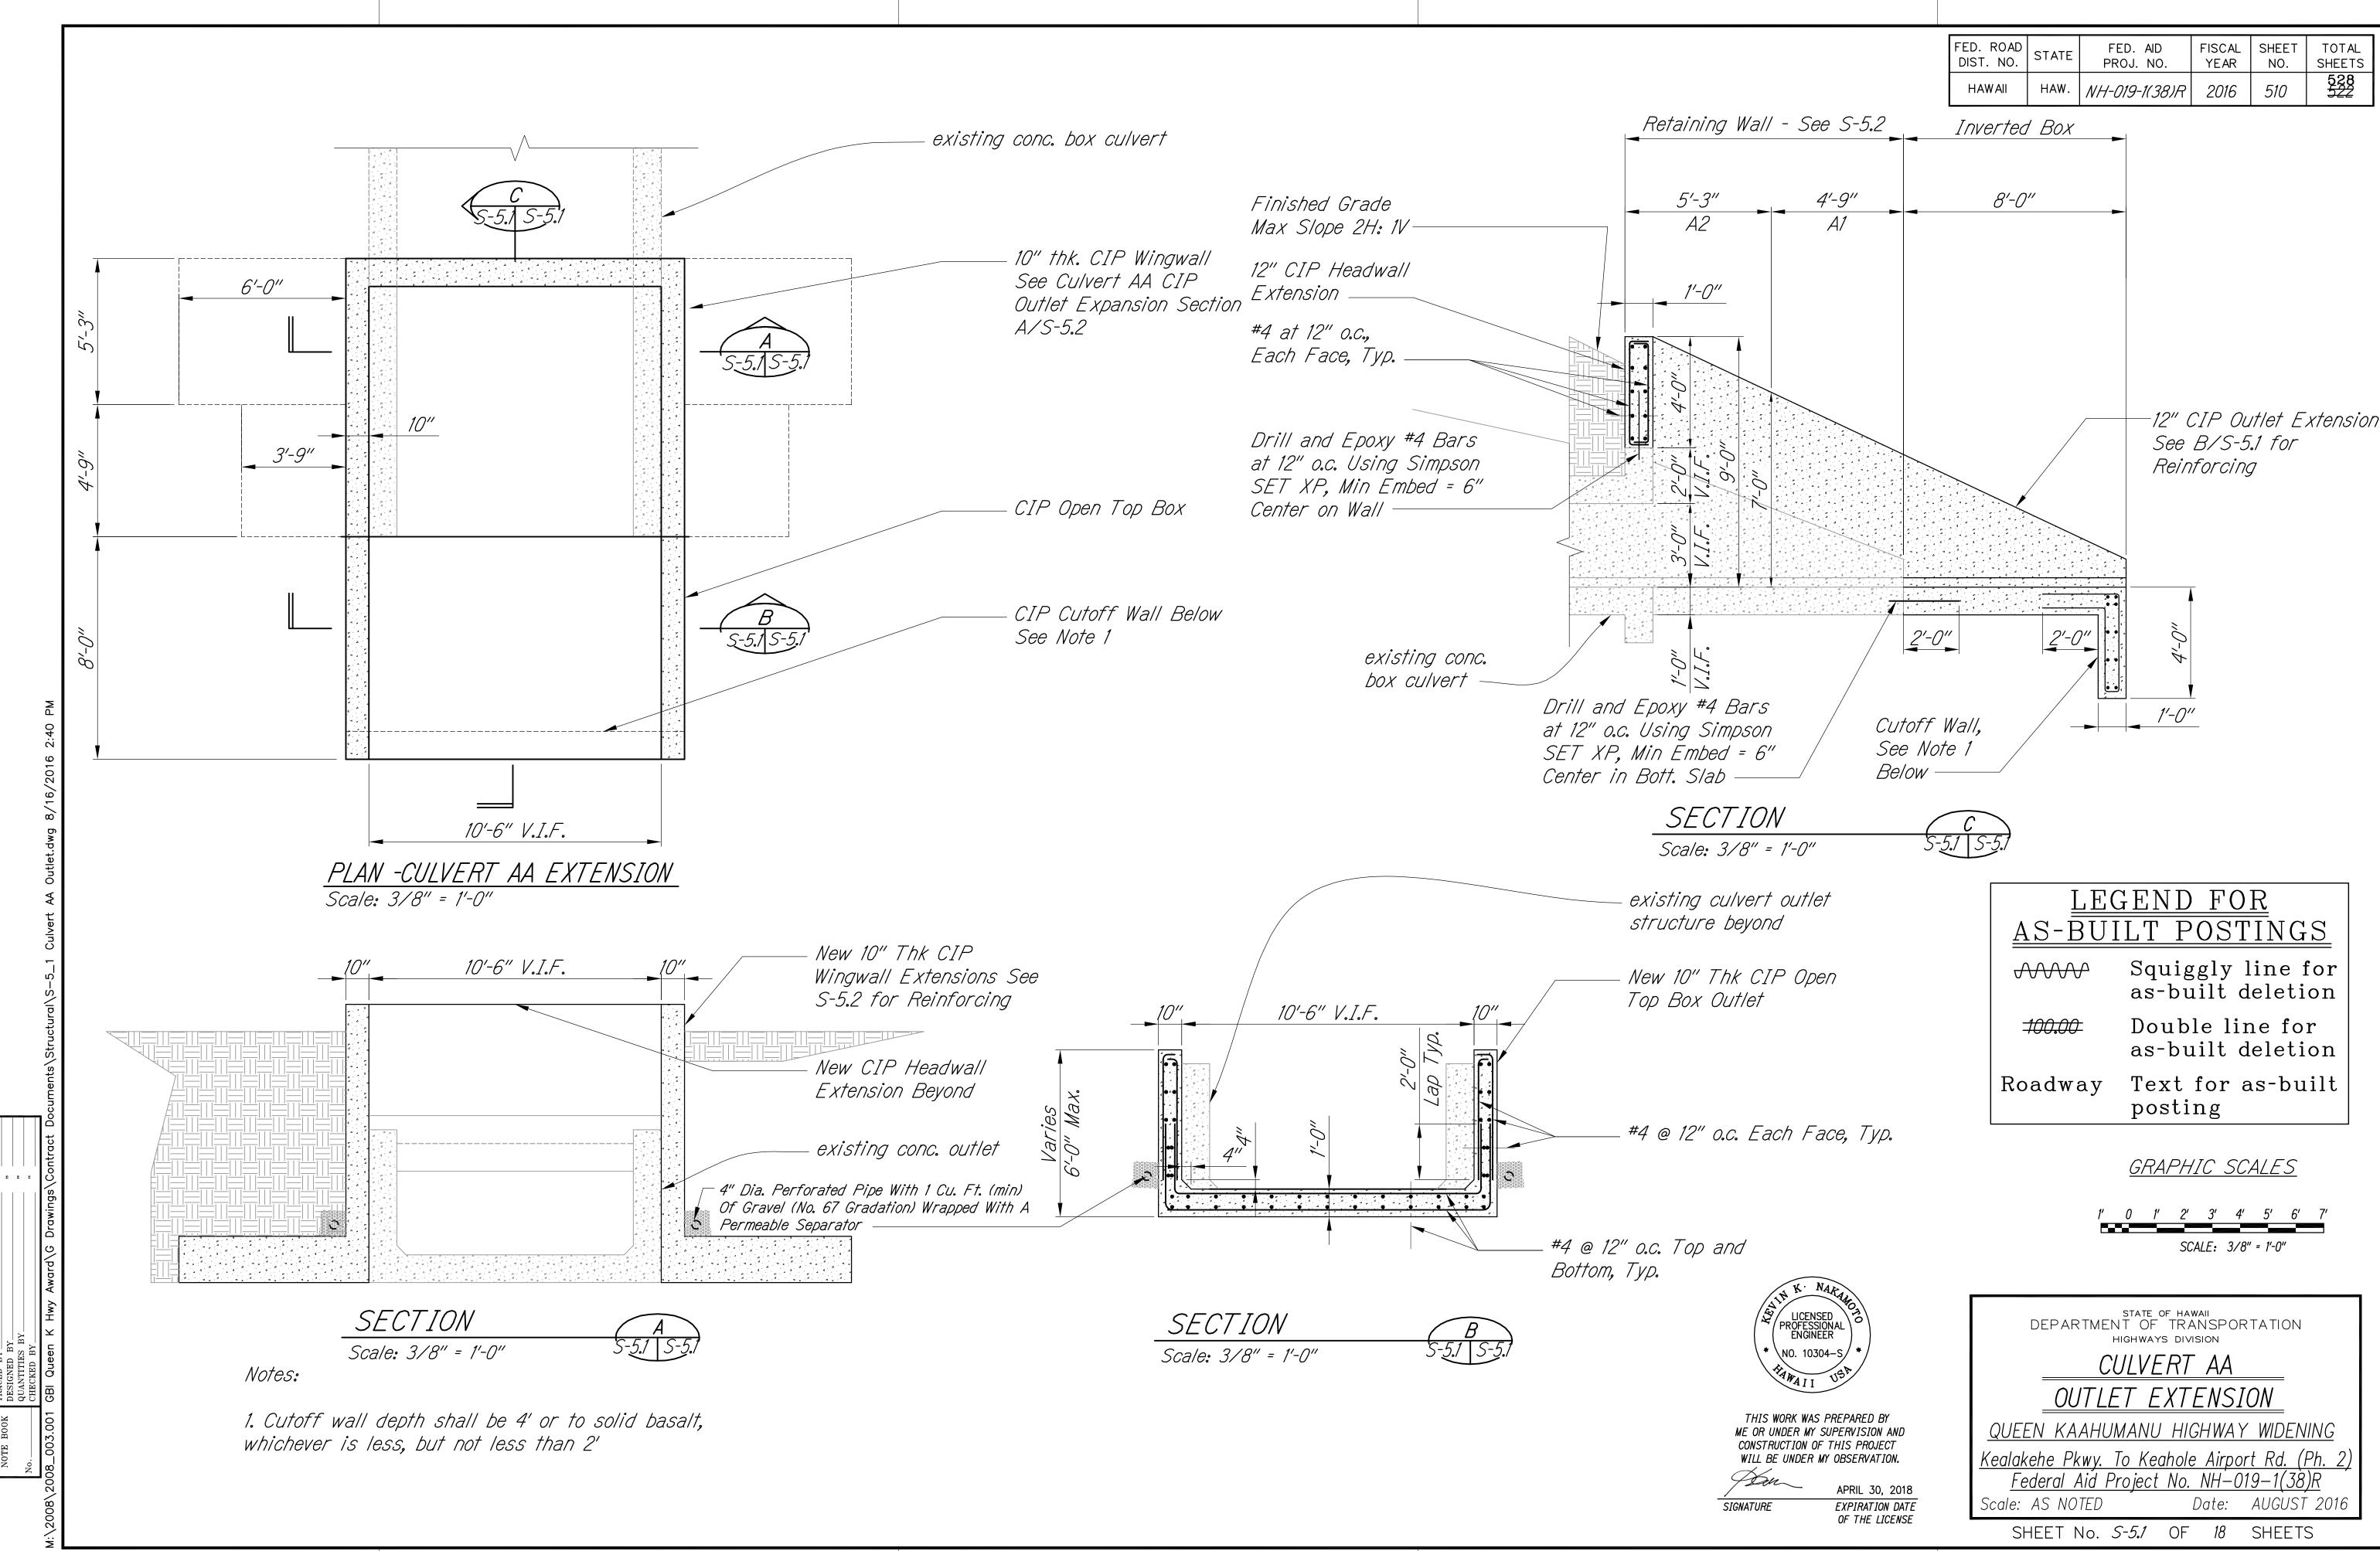

8/16/2016 2:41 PM

FED. ROAD DIST. NO.	STATE	FED. AID PROJ. NO.	FISCAL YEAR	SHEET NO.	TOTAL SHEETS
HAWAII	HAW.	NH-019-1(38)R	2016	C.O. 511	528 <del>522</del>

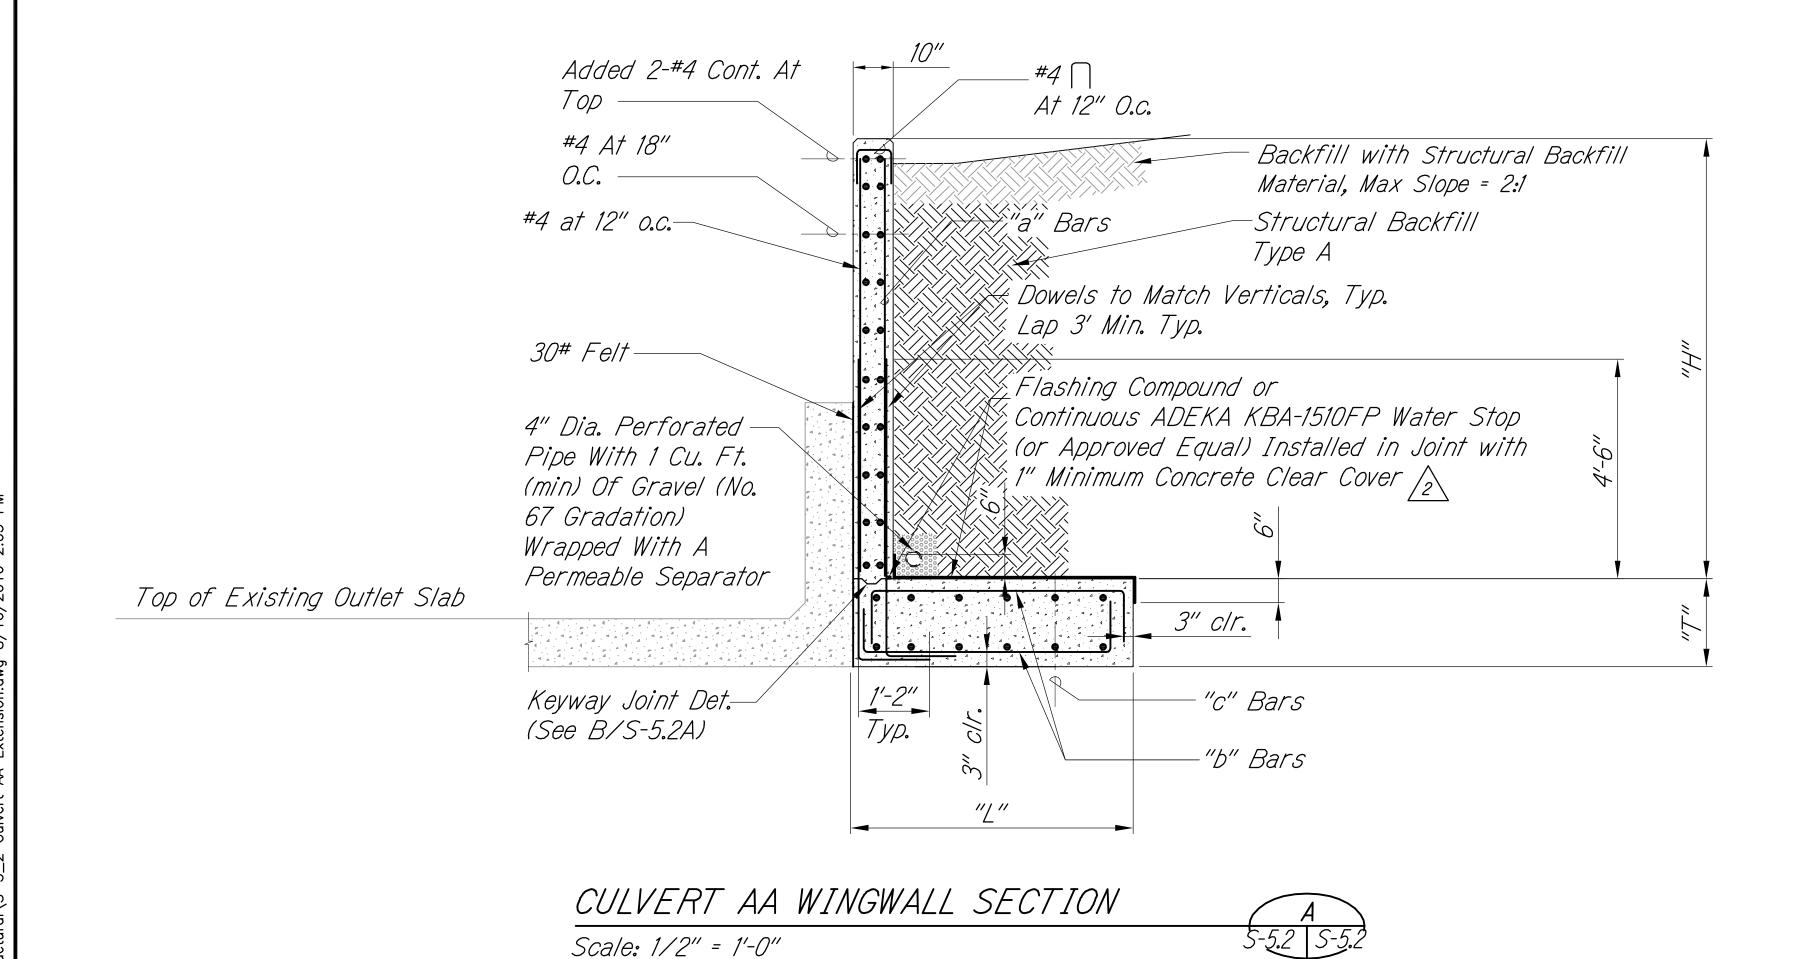


WINGWALL SCHEDULE OF DIMENSIONS AND REINFORCING						
Wall Mark	A1	A2				
"H" (Max)	8'	10'				
T	12"	20"				
L	4' 7"	6' 10"				
а	#4@12"	#6@12"				
b	#5@9"	#6@6"				
С	#5@12"	#6@12"				



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Roadway Text for as-built posting



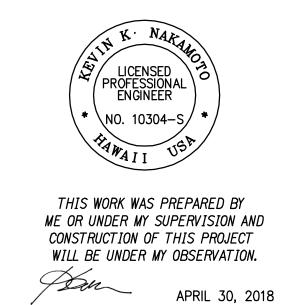EXPIRATION DATE OF THE LICENSE

8/16/2016 2:05 PM



Revised callout for waterproofing at joint 4/18/16 REVISION DATE

GRAPHIC SCALES

SCALE: 1/2" = 1'-0"

state of hawaii DEPARTMENT OF TRANSPORTATION HIGHWAYS DIVISION


#### CULVERT AA OUTLET EXTENSION

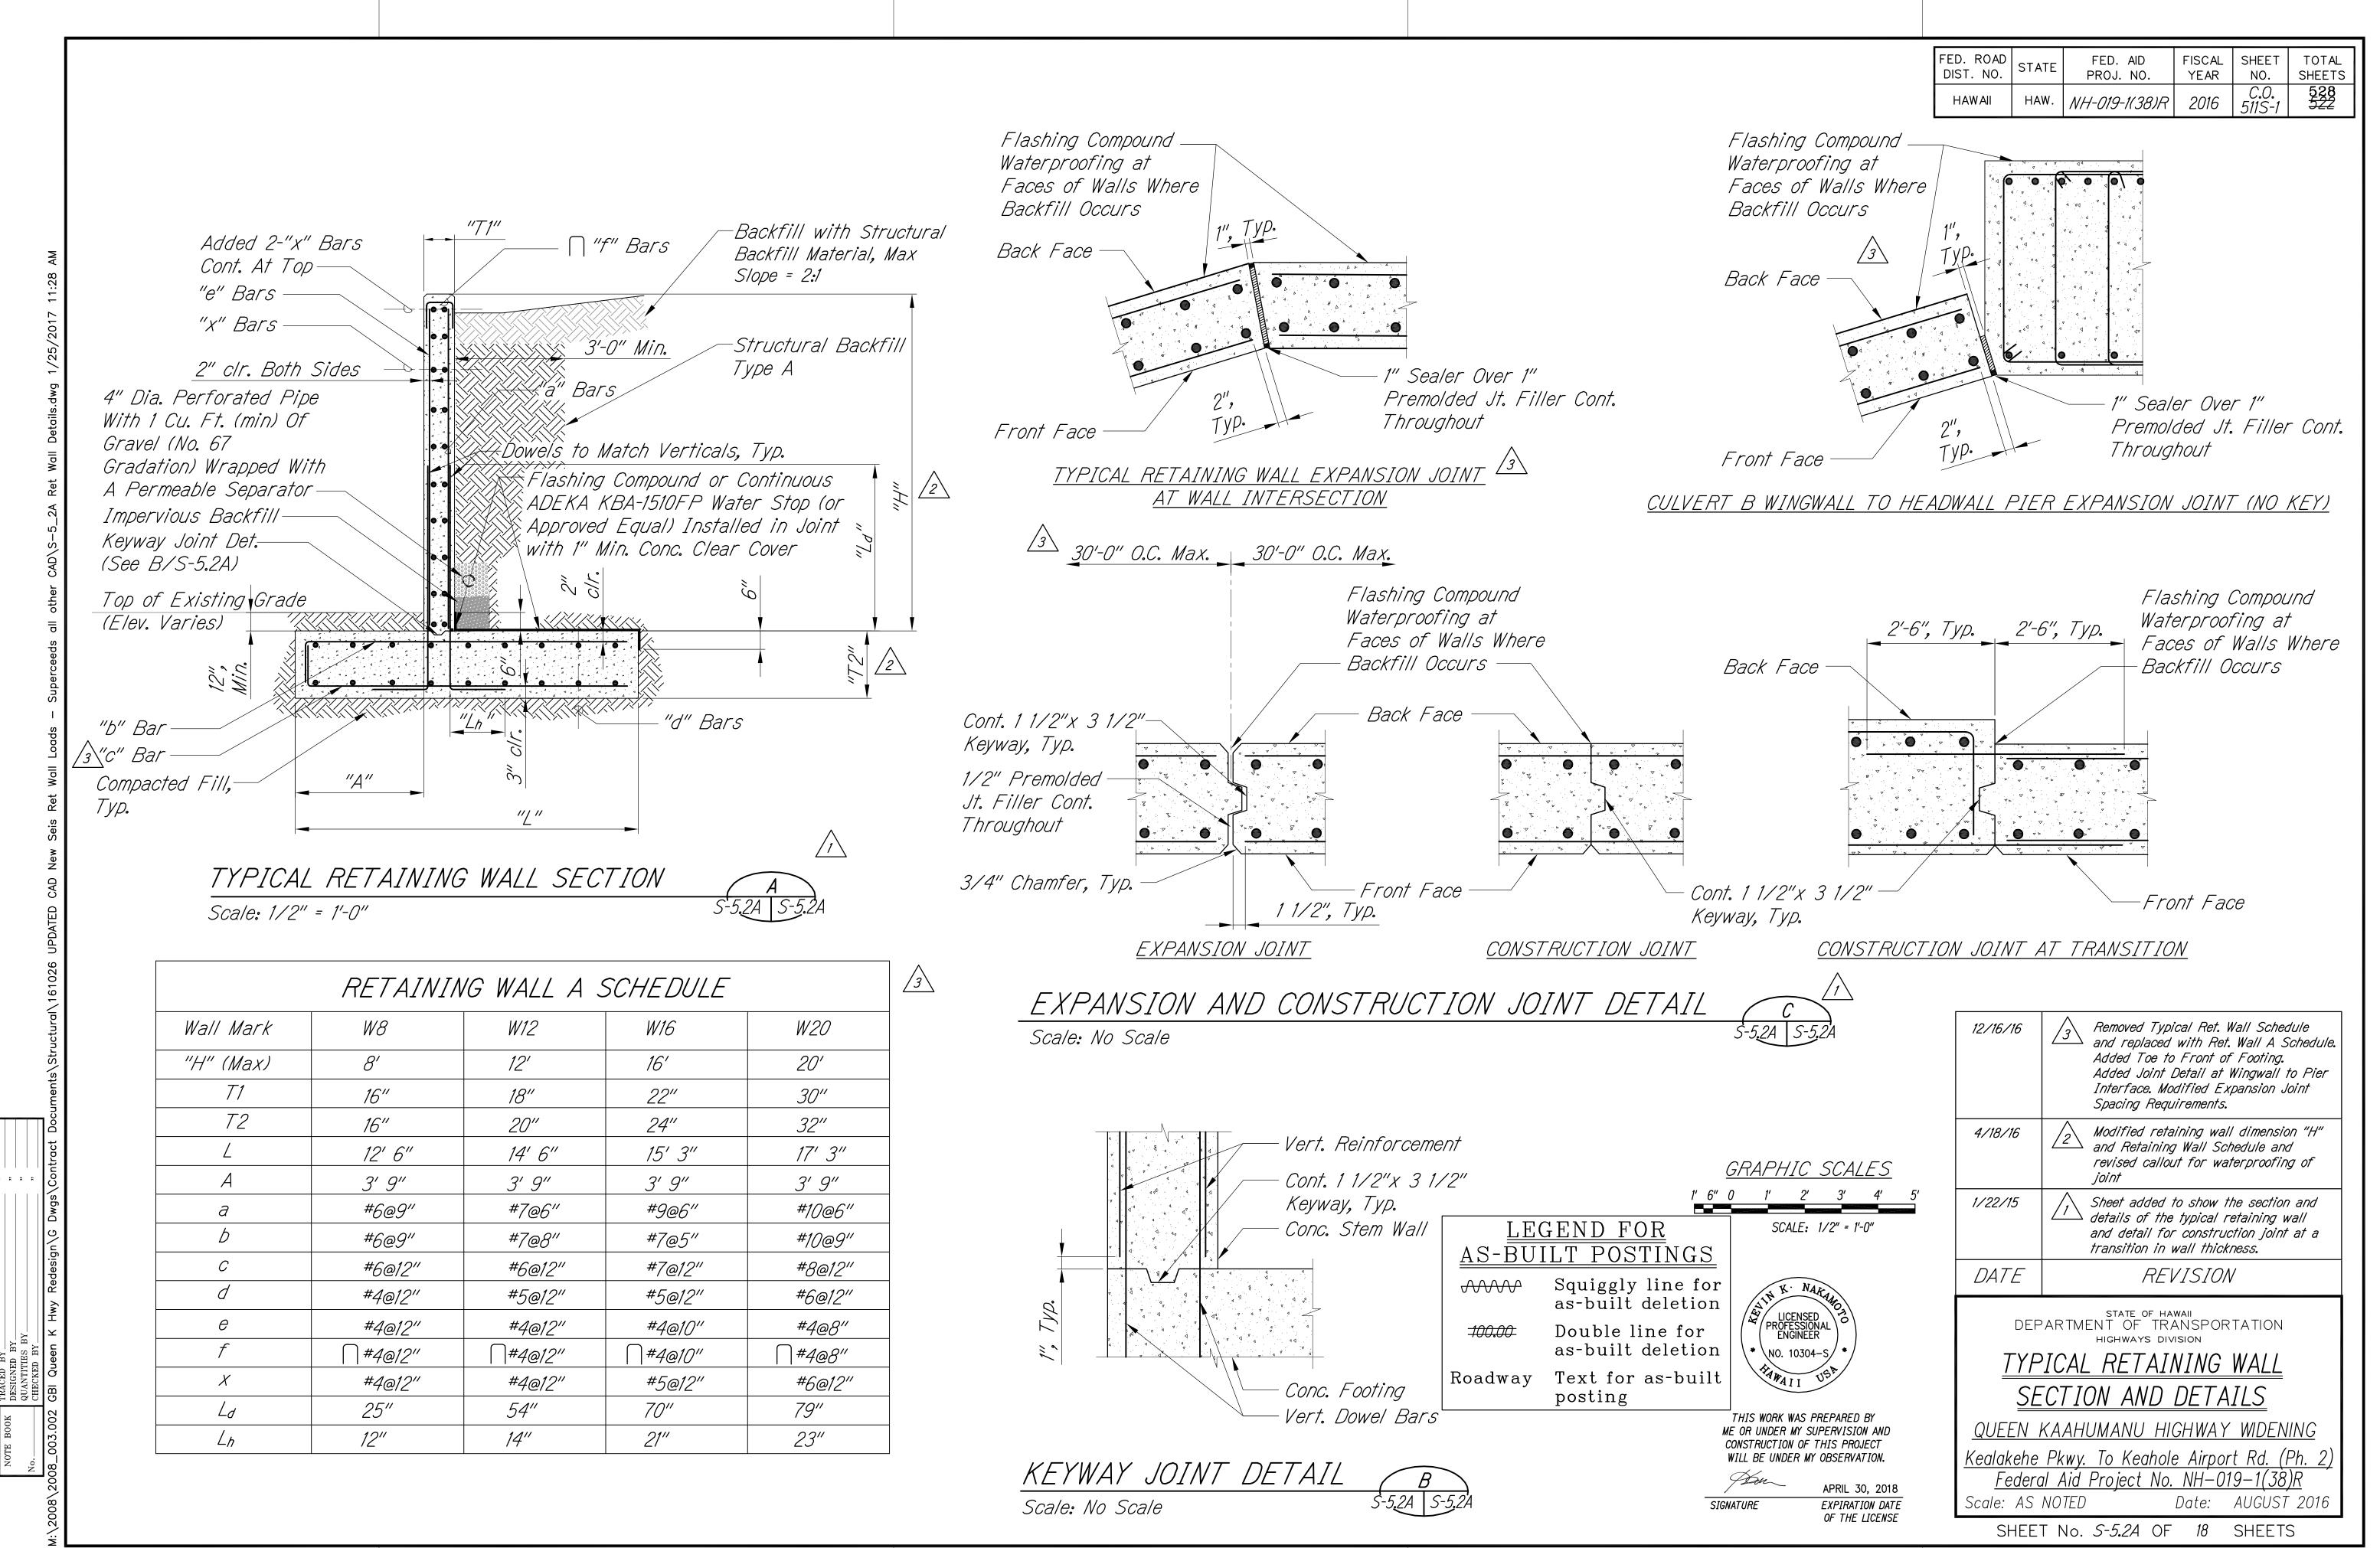QUEEN KAAHUMANU HIGHWAY WIDENING

<u>Kealakehe Pkwy. To Keahole Airport Rd. (Ph. 2)</u> <u>Federal Aid Project No. NH-019-1(38)R</u> Scale: AS NOTED Date: AUGUST 2016

SHEET No. S-5.2 OF 18 SHEETS

SIGNATURE




C-O-511S-1

/25/2017 11:28 AM


	RETAININ	IG WALL E S	SCHEDULE	
Wall Mark	W8	W12	W16	W20
"H" (Max)	8'	12'	16'	20'
<i>T1</i>	16"	20"	24"	34"
T2	16"	20"	24"	36"
L	10' 9"	12' 9"	14' 9"	20' 6"
А	4' 0"	4' 0"	4' 0"	4' 6"
а	#6@11"	#8@11"	#9@8"	#9@5"
Ь	#6@12"	#8@12"	#9@11"	#9@6"
С	#6@12"	#6@12"	#7@12"	#8@12"
d	#4@12"	#4@12"	#5@12"	#6@12"
е	#4@12"	#4@12"	#4@10"	#4@6"
f	\\\\\\\\\\\\\\\\\\\\\\\\\\\\\\\\\\\\\\	\[\#4\@12''\]	\ \ \#4@10''	□ #4@6"
Х	#4@12"	#5@12"	#5@12"	#6@12"
Ld	31"	60"	70"	70"
Ln	12"	16"	20"	20"

FED. ROAD DIST. NO.	STATE	FED. AID PROJ. NO.	FISCAL YEAR	SHEET NO.	TOTAL SHEETS
HAWAII	HAW.	NH-019-1(38)R	2016	C.O. 511S-2	528 <del>522</del>

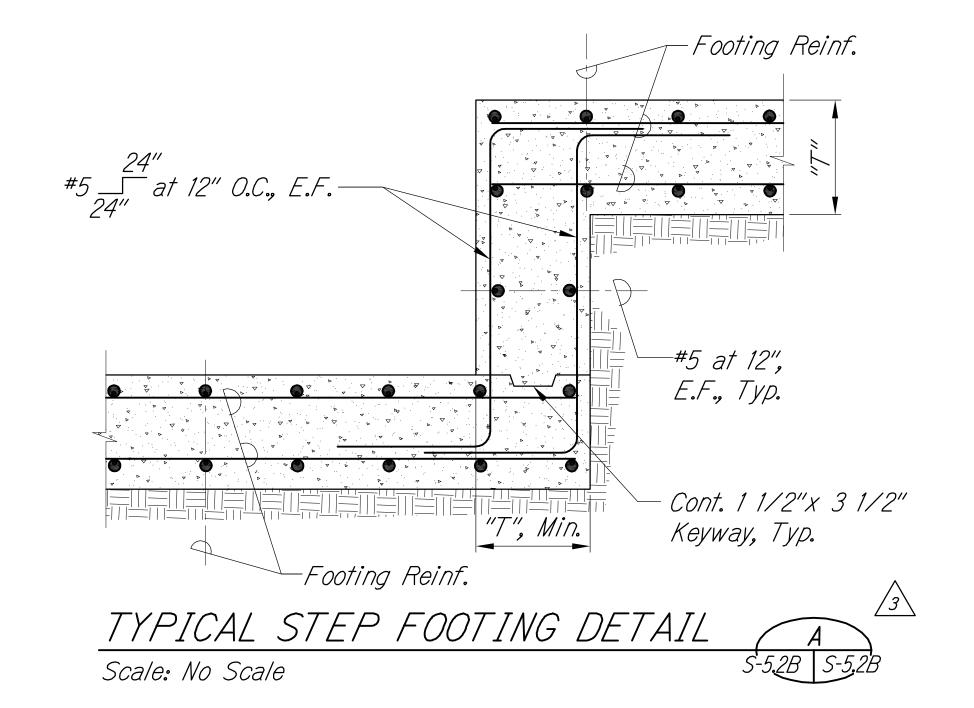

			$\sqrt{3}$
RETAINI	NG WALL G	SCHEDULE	
Wall Mark	W6	W10	
"H" (Max)	6'	10'	
<i>T1</i>	14"	14"	
<i>T2</i>	20"	20"	
Z	10' 0''	12' 4"	
А	3′ 6″	3′ 6″	
а	#5@10"	#5@4"	
b	#5@8"	#5@5"	
С	#4@12"	#6@12"	
d	#4@12"	#4@12"	
е	#4@12"	#4@12"	
f	∏ #4@12''	□ #4@12"	
X	#4@12"	#4@12"	
Ld	25"	25"	
$\angle_h$	10"	10"	

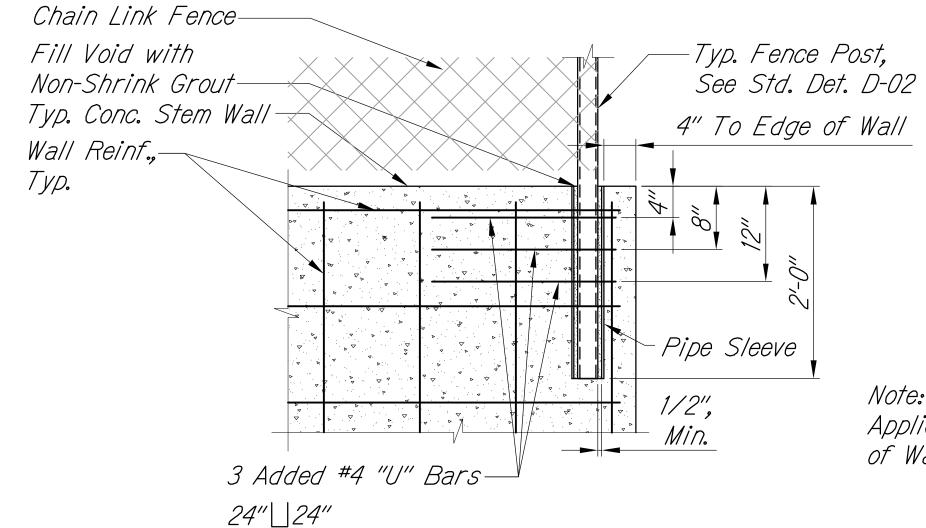Note: Refer to Sheet S-5.2A for Typical Retaining Wall Section



ADDED REINFORCEMENT FOR FENCE POST DETAIL

Scale: No Scale

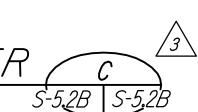
Typ. Fence Post, See Std. Det. D-02 Chain Link Fence-1" Sealer Over 1" Premolded Jt. Filler Cont. Throughout Fill Void with Non-Shrink Grout—

Note: Added "U" Bar Detail Applies to Conditions at the End of Walls and at Expansion Joints

Typ. Conc. Stem Wall

FENCE POST DETAIL AT CORNER Scale: No Scale

2/27/2017 2:54 PM



4" To Edge of Wall, Typ.

#### LEGEND FOR AS-BUILT POSTINGS

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Double line for as-built deletion

Text for as-built Roadway posting

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APRIL 30, 2018

10/26/16 Sheet added to show separate schedules for each retaining wall.

Details added for stepped footings and added reinforcement for fence posts at wall ends. DATE REVISION STATE OF HAWAII
DEPARTMENT OF TRANSPORTATION

10 1/2" +/-

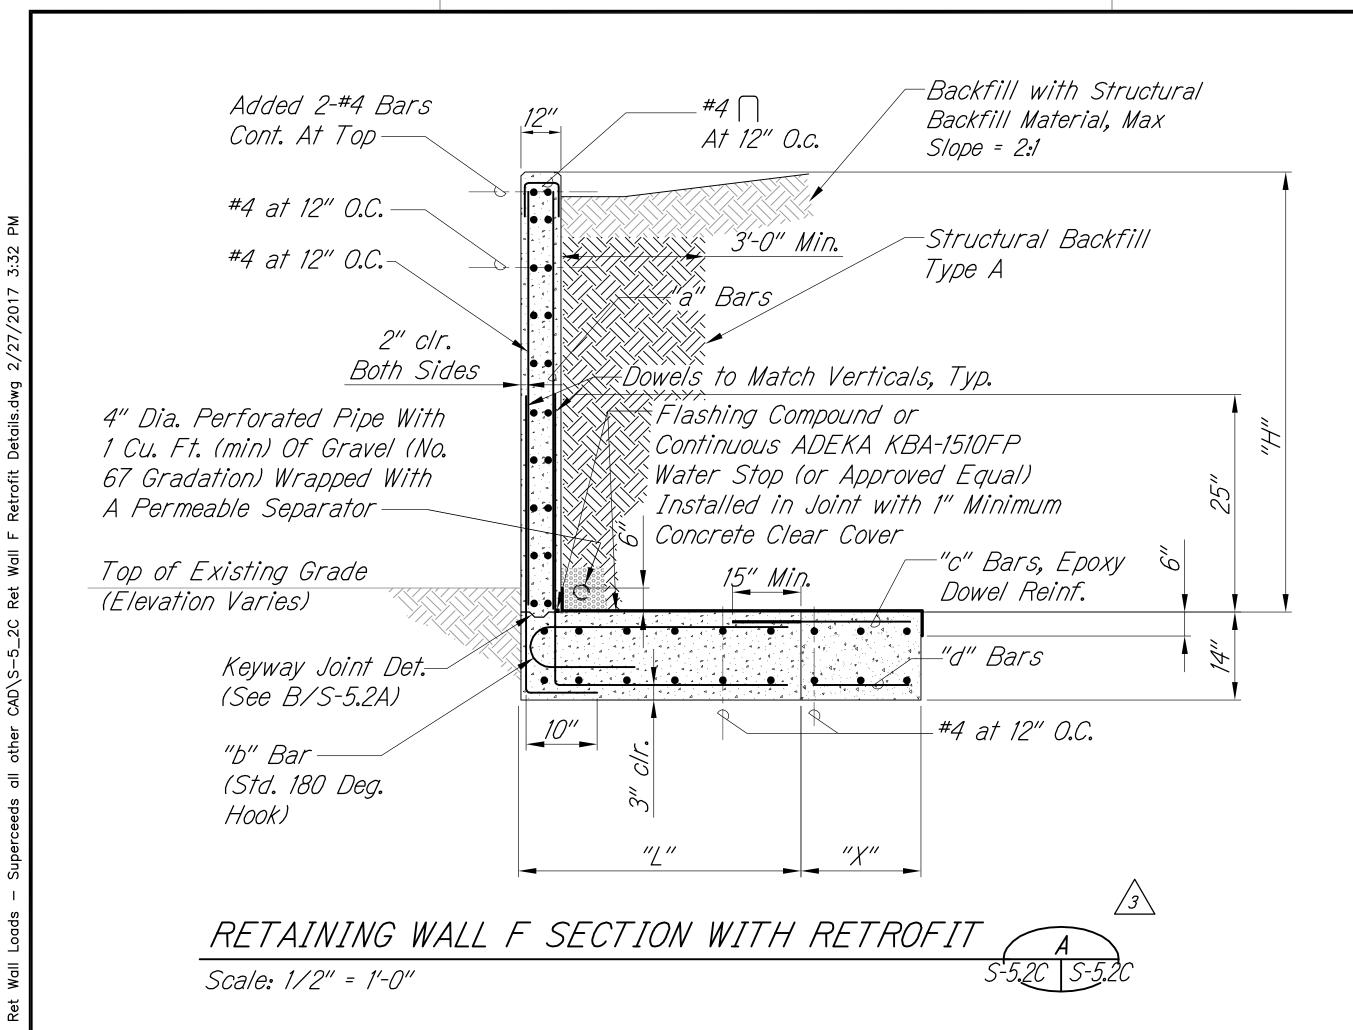
HIGHWAYS DIVISION

RETAINING WALL <u>SCHEDULES</u>


QUEEN KAAHUMANU HIGHWAY WIDENING


<u>Kealakehe Pkwy. To Keahole Airport Rd. (Ph. 2)</u> <u>Federal Aid Project No. NH-019-1(38)R</u> Scale: AS NOTED Date: AUGUST 2016

SHEET No. S-5.2B OF 18 SHEETS



RETAINING WALL F SCHEDULE		
Wall Mark	W6	W10
"H" (Max)	6'	10'
L	3' 9"	6' 3"
X	2' 5"	2' 6"
а	#5@12"	#5@6"
Ь	#5@12"	#5@5"
С	#6@10"	#6@16"
d	#5@12"	#5@18"

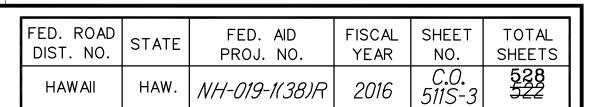

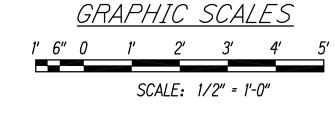

#### LEGEND FOR AS-BUILT POSTINGS

**₩** 

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Text for as-built Roadway posting

CONSTRUCTION OF THIS PROJECT WILL BE UNDER MY OBSERVATION.

NAKAL
LICENSED 3
PROFESSIONAL ENGINEER
* NO. 10304-S/*/
HAWAII USP

THIS WORK WAS PREPARED BY ME OR UNDER MY SUPERVISION AND

APRIL 30, 2018 EXPIRATION DATE OF THE LICENSE SIGNATURE

2/27/17	Sheet added to show the retrofit of Retaining Wall F after it was constructed.
DATE	REVISION

STATE OF HAWAII
DEPARTMENT OF TRANSPORTATION HIGHWAYS DIVISION

#### RETAINING WALL F RETROFIT SECTION AND DETAILS

QUEEN KAAHUMANU HIGHWAY WIDENING

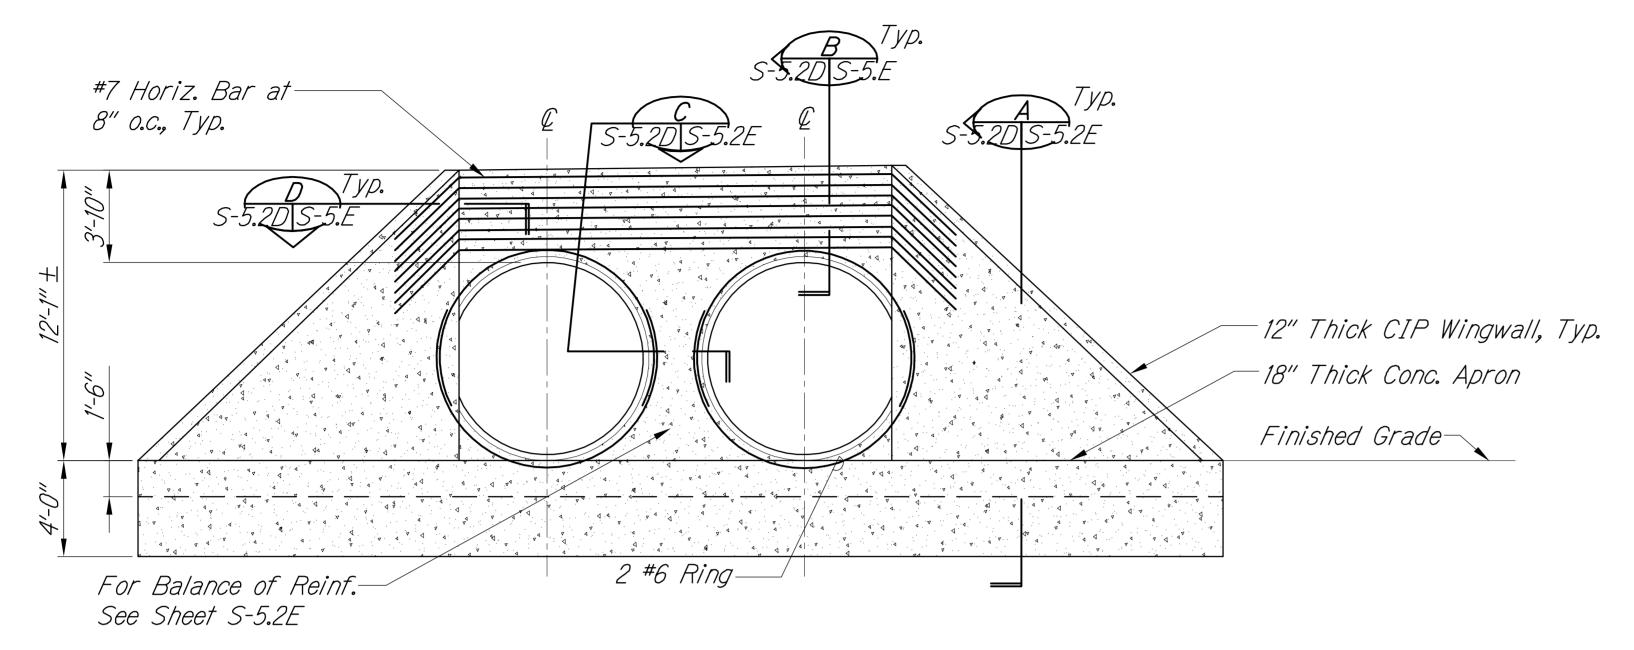
Kealakehe Pkwy. To Keahole Airport Rd. (Ph. 2) <u>Federal Aid Project No. NH-019-1(38)R</u> Scale: AS NOTED Date: AUGUST 2016

SHEET No. S-5.2C OF 18 SHEETS

2/27/2017 3:32 PM

"AS-BUILT


C.O. 511S-3



# ELEVATION - NEW HEADWALL FOR DOUBLE 96" DIA. CULVERT Scale: 1/4" = 1'-0"

*19'-2"*±

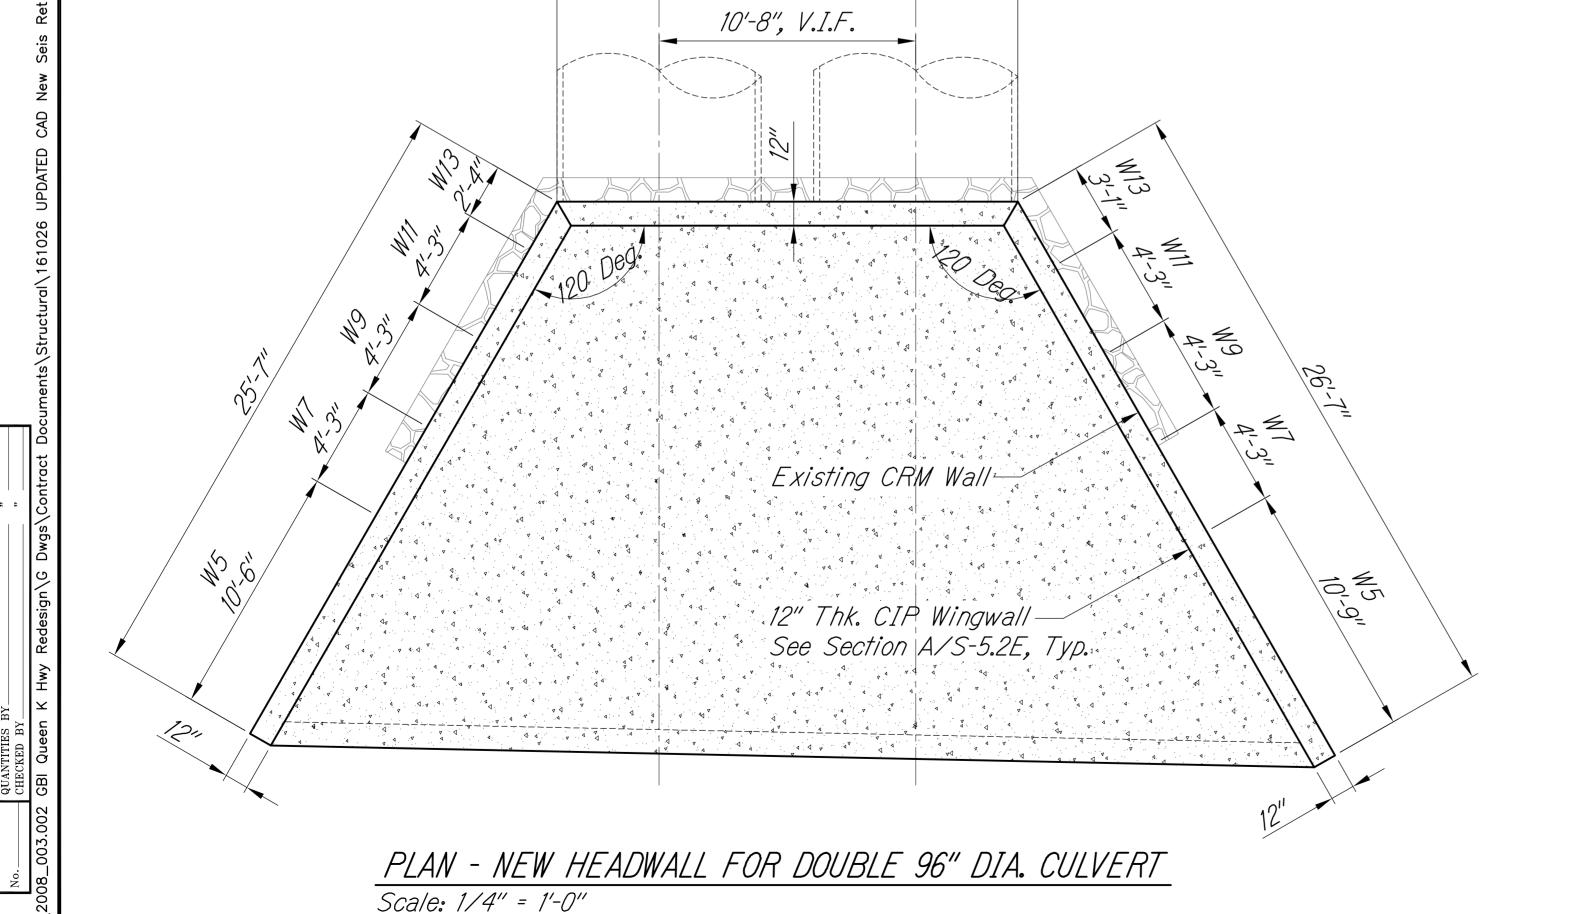2 - 96" Dia.



Note:

Stud Bolts Shall Be Stainless Steel (See C/S-2.4). Hot Dip Galvanized Bolts with Neoprene Washers and Sleeves are Acceptable, Provided it Does Not Affect the Manufacturer's Warranty.



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Double line for as-built deletion

Roadway '

y Text for as-built posting

3/12/18 Sheet added to show Culvert B Inlet Wall

DATE

REVISION

STATE OF HAWAII
DEPARTMENT OF TRANSPORTATION
HIGHWAYS DIVISION

CULVERT B INLET WALL
SECTION AND DETAILS

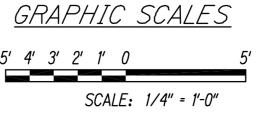
QUEEN KAAHUMANU HIGHWAY WIDENING

Kealakehe Pkwy. To Keahole Airport Rd. (Ph. 2)

Federal Aid Project No. NH-019-1(38)R

Scale: AS NOTED Date: AUGUST 2016

SHEET No. S-5.2D OF 18 SHEETS




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APRIL 30, 2018

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OF THE LICENSE



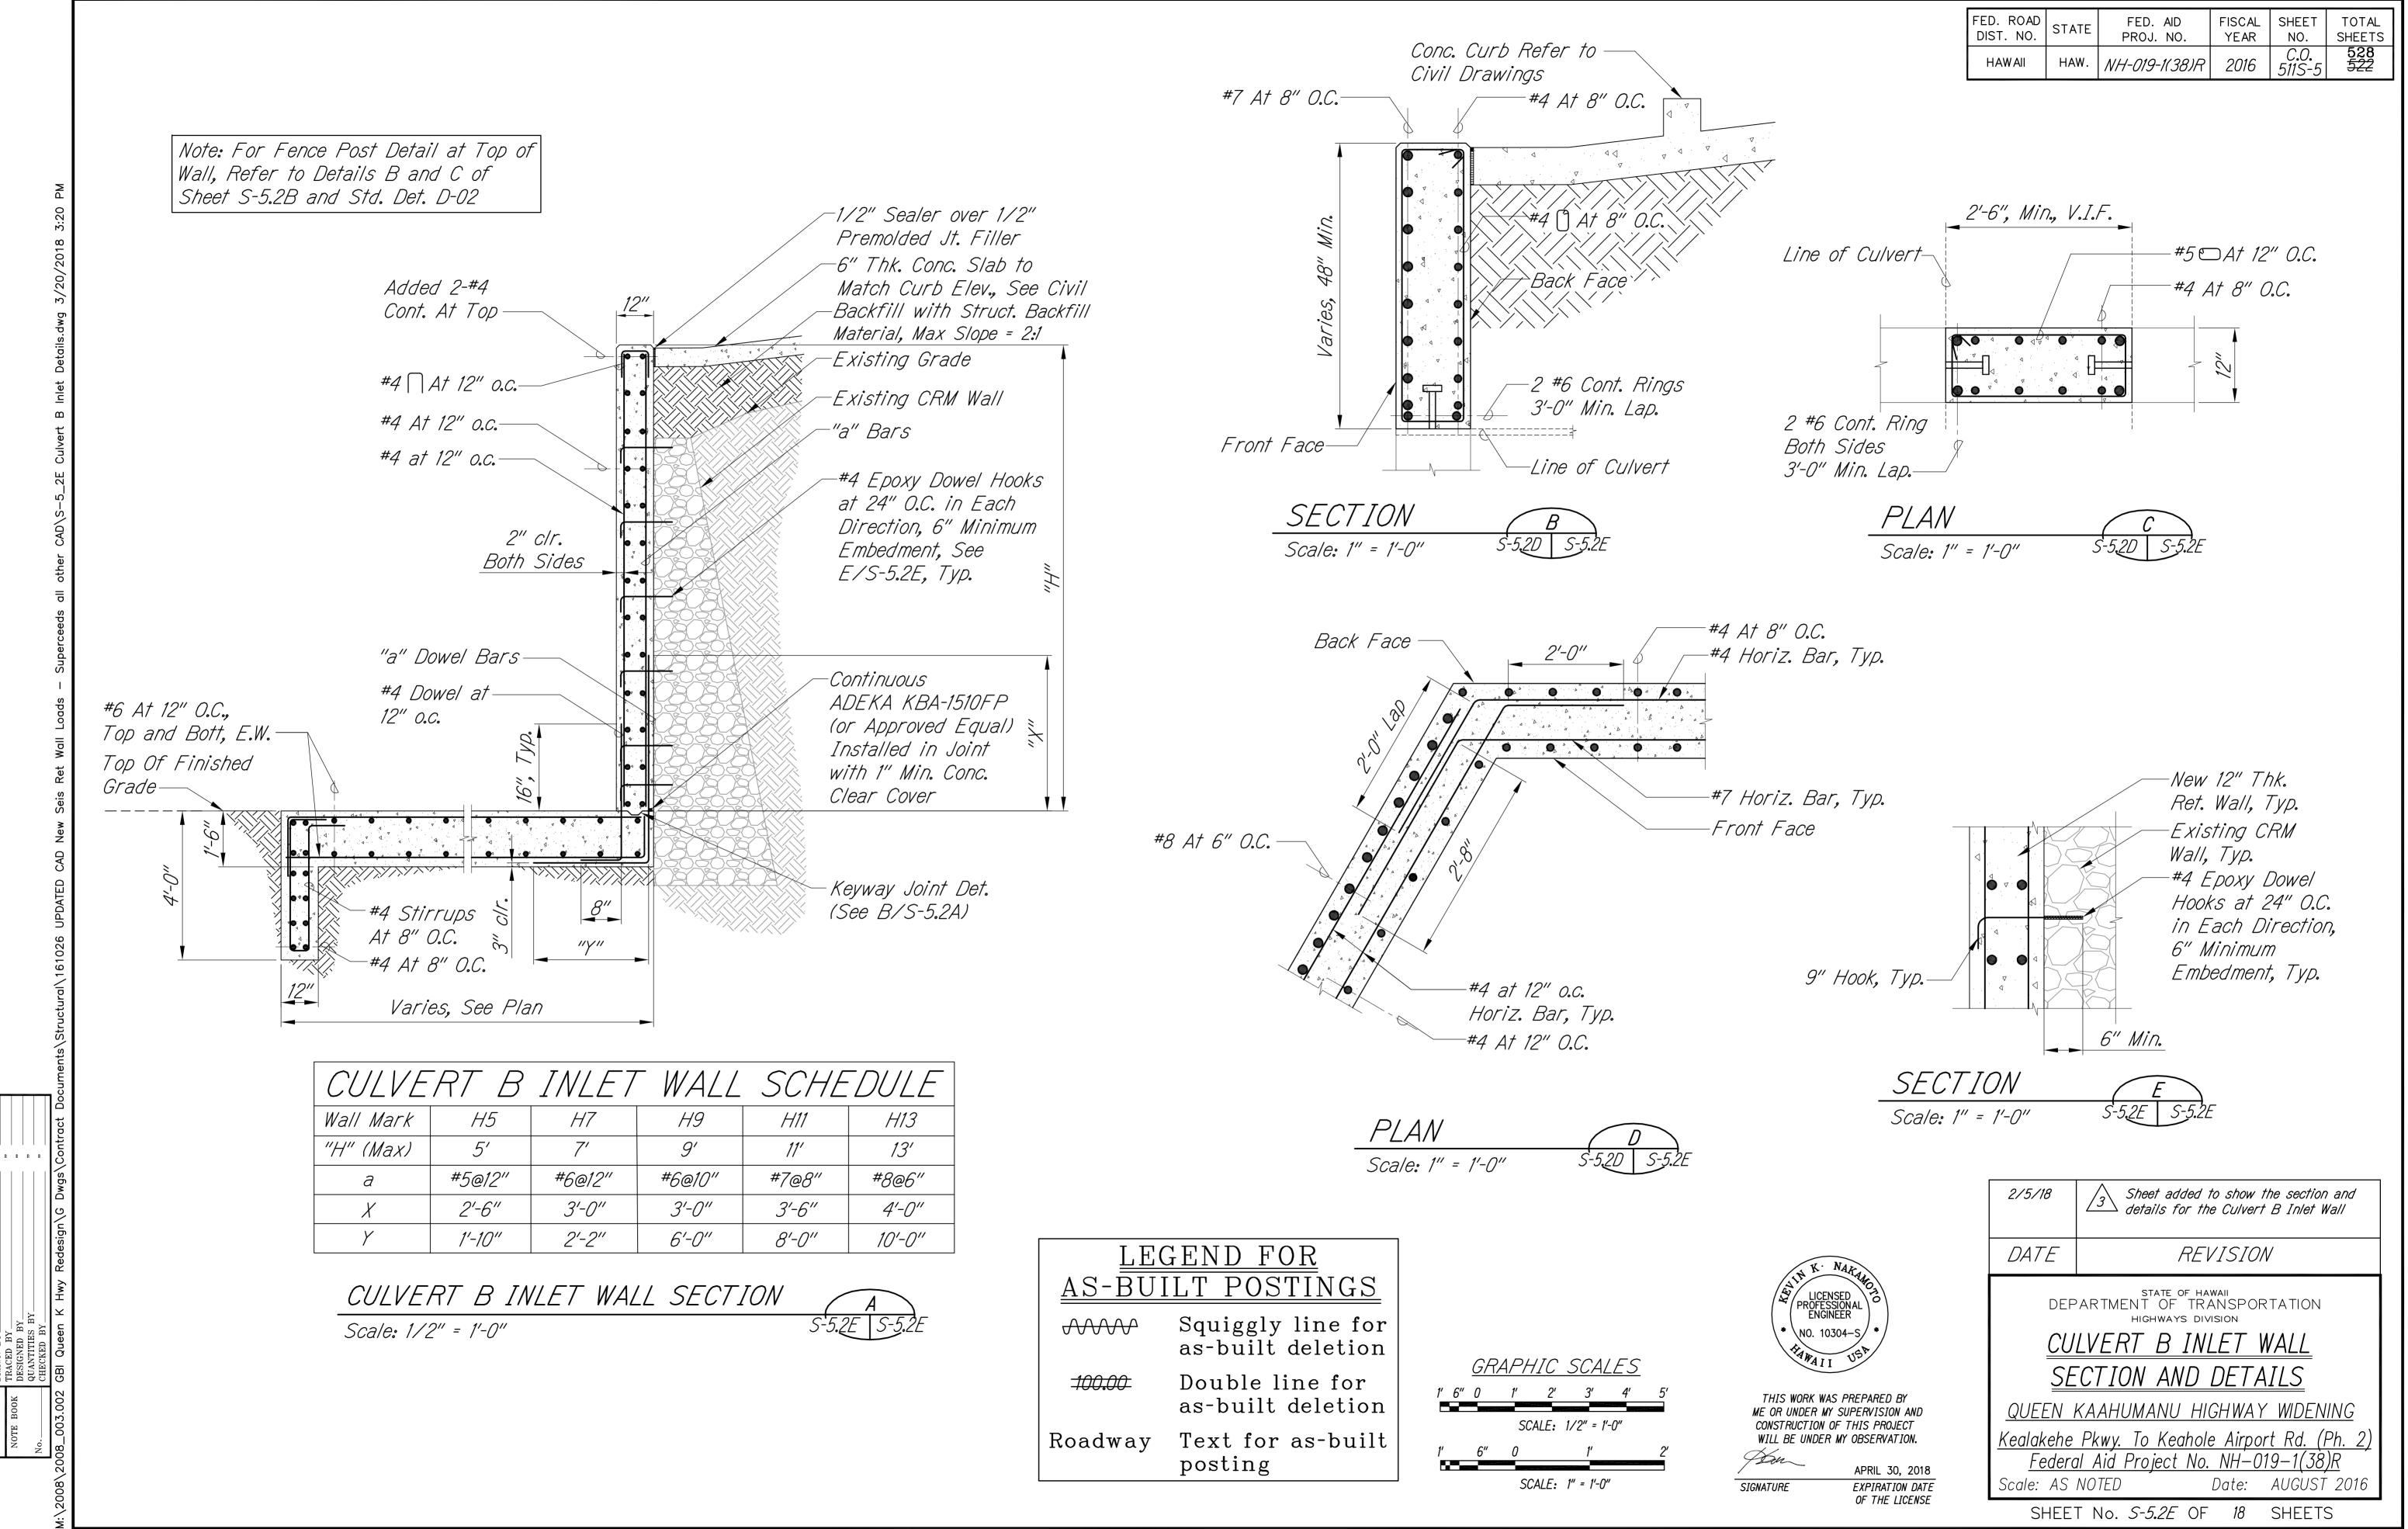"AS-BUILT" 3/20/2018 3: 21 PM C.O. 511S-5