#### EROSION CONTROL NOTES AND BEST MANAGEMENT PRACTICES (BMP):

- 1. The site-specific BMP measures (such as silt fencing) may be placed in phases as work progresses. The BMP measures required to protect each work area shall be in place before clear and grub or mass grading work may proceed in that work area. These measures shall be properly constructed and maintained throughout the construction period.
- 2. Construction shall be sequenced to minimize the exposure time of cleared surface area.
- 3. All control measures shall be checked and repaired as necessary.
- 4. Construct facilities to retain on-site concrete wash water and waste concrete per "concrete washdown area detail" on sheet 12.
- 5. Maintain sediment traps at discharge points during site work and until permanent erosion controls are in place.
- 6. Pre-construction vegetative ground cover shall not be destroyed, removed or disturbed more than twenty (20) calendar days prior to site disturbance.
- 7. Temporary slope stabilization will be applied where applicable in erodible material. Mulching and/or matting will only be applied where exposed finish slopes consists of significantly erodible material.
- 8. The Contractor, at his own expense, shall keep the project area and surrounding area free from dust nuisance. the work shall be done in conformance with the air pollution control standards of the local agency.
- 9. All grading work shall be done in accordance with local agency standards and the geotechnical soils report.

Swale ⊈—

Sedimentation basin with

Sediment Control Logs at outfall

(Gravel filled bags can be used,

as alternate in rocky areas. —

2.00% (Typ.)


Cut slope-

10. The Contractor shall maintain all temporary BMP measures until the entire area is completely stabilized. All BMP measures shall be removed immediately after the area is completely stabilized.

-Road

SEDIMENTATION BASIN DETAIL

~ ~ ~

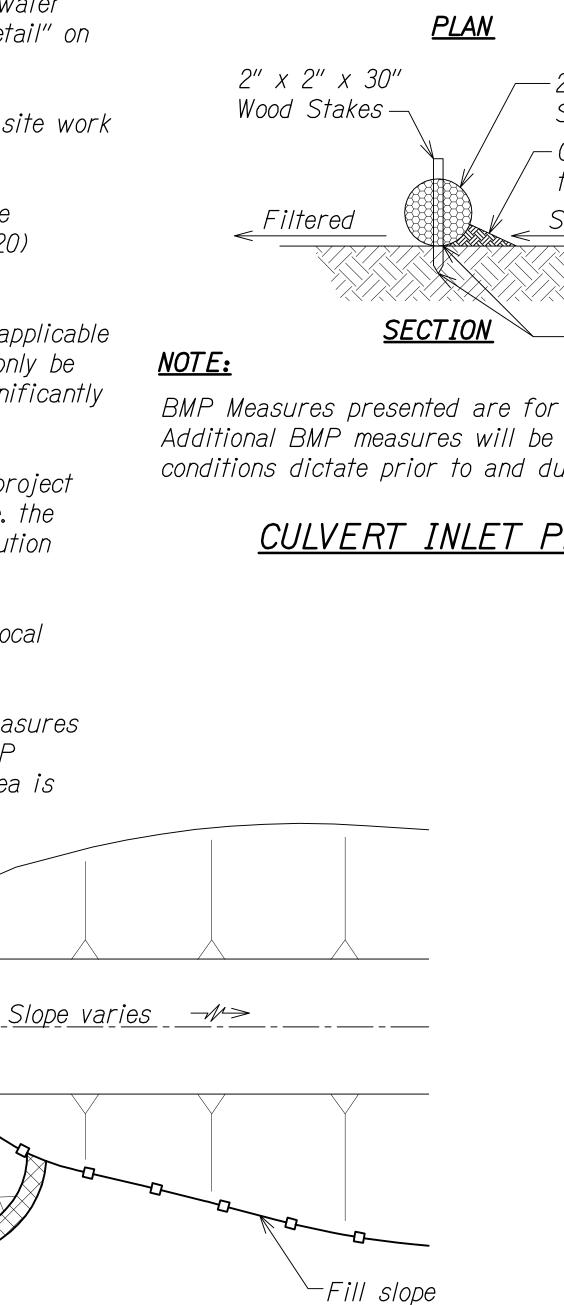


with silt and

sedimentation

control


12" on Center exist. roadway -exist. drainage — Install 20″ø x 10′ flow pattern, typ. Sediment Control Logs Around Culvert Inlets/Outlets as -exist. Shown on Erosion culvert Control Plans  $\leftarrow\sim$ ~~**, K** structure/ **~**~~

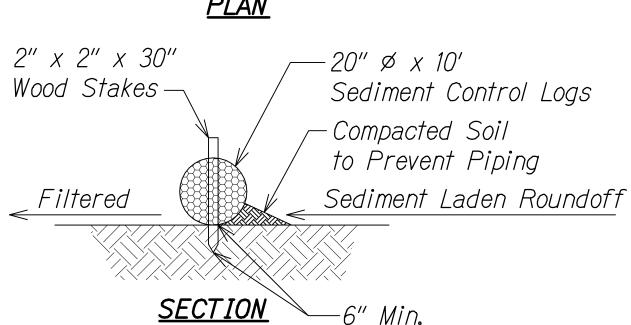

BMP Measures presented are for known conditions. Additional BMP measures will be incorporated as conditions dictate prior to and during construction.

## CULVERT INLET PROTECTION DETAIL

Slope stabilization to be exist. applied as applicable ground -Finish Grade-CONDITION AT CUT SECTION

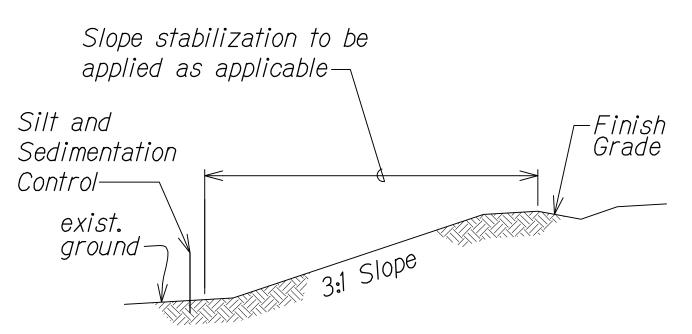


CONDITION AT FILL SECTION TEMPORARY SLOPE PROTECTION DETAIL

#### **NOTES:**

Space Wood Stakes

FED. ROAD DIST. NO.	STATE	FED. AID PROJ. NO.	FISCAL YEAR	SHEET NO.	TOTAL SHEETS
HAWAII	HAW.	NH-019-1(38)R	2016	11	528 522

- 1. Stake sediment logs in place with 2"x2"x30" wood stakes space no less than 24" apart unless otherwise noted. Drive stakes into ground a minimum of 6".
- 2. Install sediment control logs directly on ground making sure bottom of log is in full contact with ground. Tamp soil backfill against upstream side of log to assure storm water is forced flow through log rather than under it.
- 3. Gravel filled bags can be used as alternate to sediment logs in rock areas.

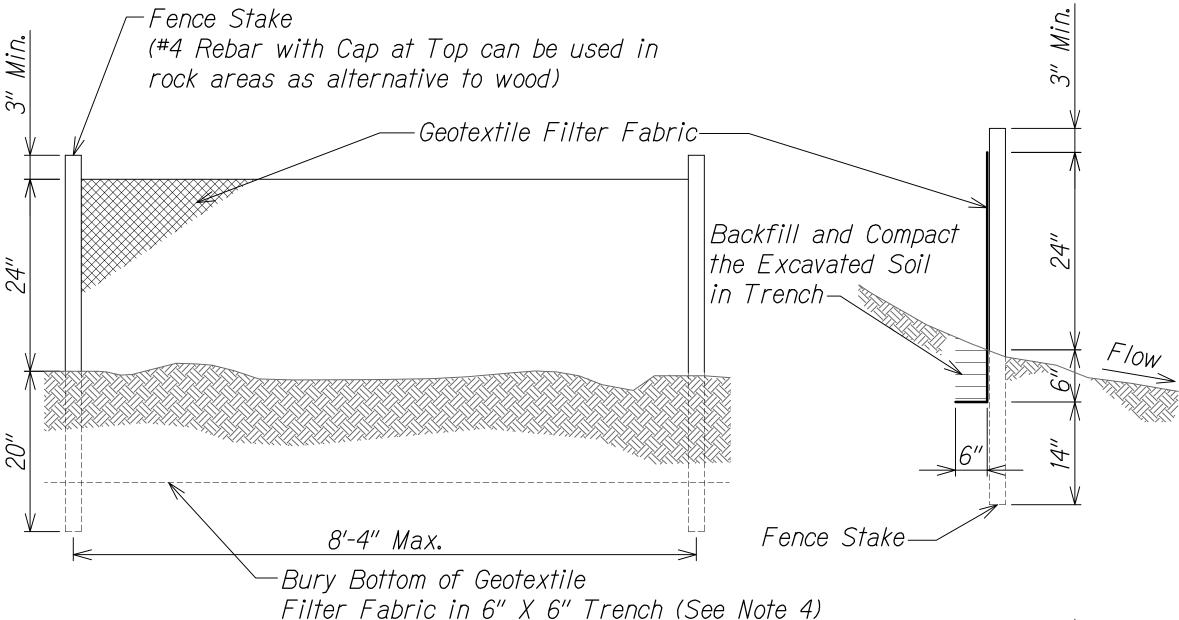


SILT FENCE DETAIL

#### **NOTES:**

''AS-BU

- 1. The filter fabric shall be a minimum of 36 inches wide.
- 2. If silt fence is obtained from manufacturer as a package (i.e. fabric attached to post) the manufacturer's installation instruction shall be adhered to.
- 3. Fence stakes may be wood or metal, must be capable of supporting anticipated loads.
- 4. In rock areas, as alternative to burying bottom of geotextile fabric in 6" X 6" trench, a 12" long flap can be place on top of the rock with #67 backfill placed on top to secure it.

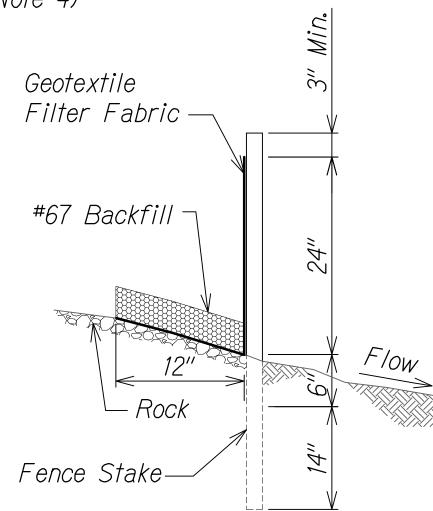

LICENSED PROFESSIONAL ENGINEER NO. 13059-C

THIS WORK WAS PREPARED BY ME OR UNDER MY SUPERVISION AND CONSTRUCTION OF THIS PROJECT WILL BE UNDER MY OBSERVATION.

luten W. Drake APRIL 30, 2018

EXPIRATION DATE

OF THE LICENSE

STATE OF HAWAII DEPARTMENT OF TRANSPORTATION HIGHWAYS DIVISION EROSION CONTROL NOTES AND DETAILS

QUEEN KAAHUMANU HIGHWAY WIDENING Kealakehe Pkwy. To Keahole Airport Rd.(Ph. 2)

Federal Aid Project No. NH-019-1(38)R Scale: AS NOTED Date: MAY 2012

5/22/2012 3:49 PM

SHEET No.

OF 2 SHEETS

					4
FED. ROAD DIST. NO.	STATE	FED. AID PROJ. NO.	FISCAL YEAR	SHEET NO.	TOTAL SHEETS
HAWAII	HAW.	NH-019-1(38)R	2016	C.O. 12	528 522


A'A Berm-\_Varies \_ Top of Berm

1. Temporary erosion control berm to consist of local a'a lava material.

2. The temporary erosion control berm is an alternate that can be used in lieu of the silt fence detail.


3. In areas where local a'a material is not readily available, berm material can be substituted with local rock and be treated as a diversion berm which routes water to a rock check dam.

### A'A BERM

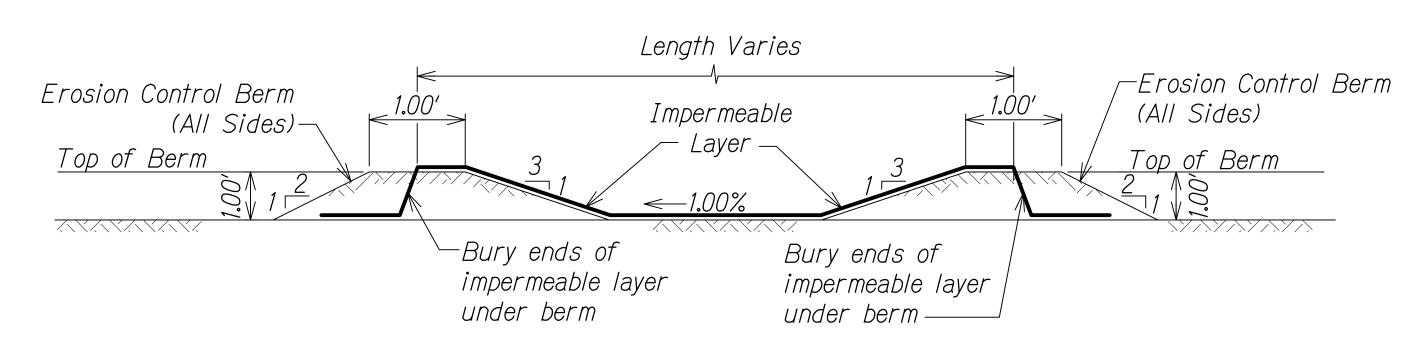

Temporary wash down areas will be installed at locations convenient to the work in the area and will be removed when filled to capacity or when no longer needed.

### CONCRETE WASH DOWN AREA DETAIL

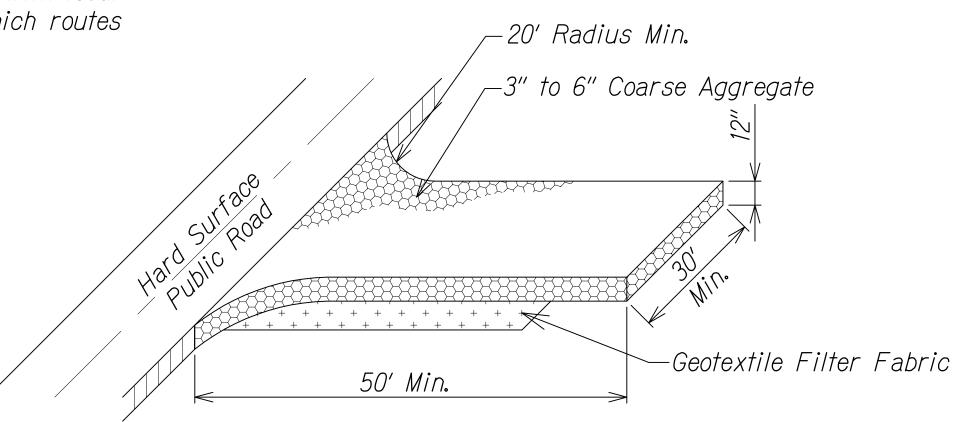

### *Notes:*


1. All points of egress and ingress to the site shall be protected with a stabilized construction entrance.

A manufactured rumple strip covering the full width of the construction entrance may be used in place of course aggregate. A manufactured rumble strip shall be built on a stable base over geotextile fabric and will be of adequate length to encompass one full tire rotation of all vehicles entering and exiting the site. Rumble strips shall be maintained on at least a weekly basis and remain free of compacted rock.

## STABILIZED CONSTRUCTION ENTRANCE DETAIL

# LEGEND FOR AS-BUILT POSTINGS

Squiggly line for as-built deletion **√√√√** *100.00* Double line for as-built deletion Text for as-built posting Roadway

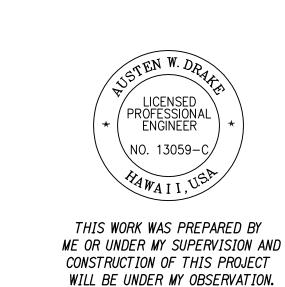

(1) Drake APRIL 30, 2018

EXPIRATION DATE OF THE LICENSE

DATE REVISION STATE OF HAWAII DEPARTMENT OF TRANSPORTATION EROSION CONTROL NOTES AND DETAILS

QUEEN KAAHUMANU HIGHWAY WIDENING Kealakehe Pkwy. To Keahole Airport Rd.(Ph. 2) Federal Aid Project No. NH-019-1(38)R

Added note #3 for berm, temp.

1 \check dam detail and note #2 for

construction entrance

Scale: AS NOTED Date: AUGUST 2016 SHEET No. 2 OF 2 SHEETS

C.O. 12 1/12/2016 9:37 AM

