


 FED. ROAD DIST. NO.
 STATE
 FED. AID PROJ. NO.
 FISCAL YEAR
 SHEET NO.
 TOTAL SHEETS

 HAWAII
 HAW.
 NH-019-1(20)
 2005
 73
 315

#### <u>Notes:</u>

- 1. Concrete shall develop a minimum 28—Day Compressive Strength of 4,000 psi.
- 2. All reinforcing bars shall be ASTM A615 Grade 60.
- 3. Concrete of invert slab shall contain a minimum of 7.5 lbs./cy of synthetic structural fiber and conform to ASTM C1116 and ACI 544.
- 4. A shrinkage reducing admixture (SRA), Tetraguard AS20 by Master Builders or Eclipse Eclipse by W.R. Grace & Co., shall be added added to the concrete mix for all concrete.

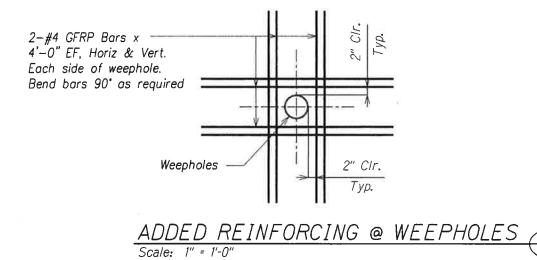

THIS WORK WAS PREPARED BY ME OR UNDER MY SUPERVISION ENP. 94-30-10

STATE OF HAWAI'I
DEPARTMENT OF TRANSPORTATION
HIGHWAYS DIVISION


ELEVATION @ PIPE OPENING
3-84" CMP EXTENSION

QUEEN KAAHUMANU HIGHWAY WIDENING HENRY ST. to KEALAKEHE PKWY - PHASE I

Federal Aid Project No. NH-019-1(20)
Scale: As Noted Date: November 2009


SHEET No. 2 OF 5 SHEETS

FED. R JAD	STATE	FED, AID	FISCAL	SHEET	TOTAL
DIST. NO.		PROJ. NO.	YEAR	NO.	SHEETS
HAWAII	HAW.	NH-019-1(20)	2005	74	315

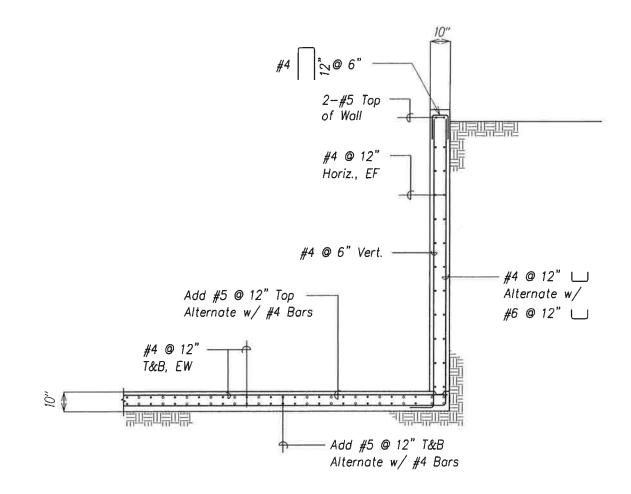

WING WALL SECTION (6'  $\leq$  H < 12')


Scale:  $\frac{1}{2}$ " = 1'-0"

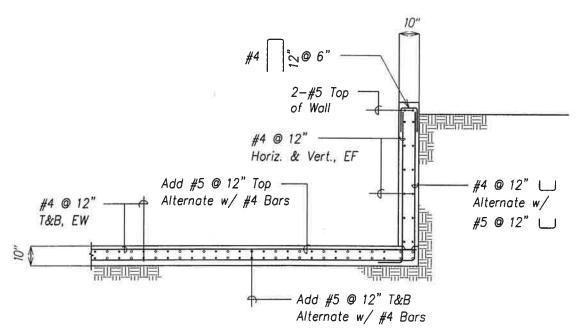

WING WALL SECTION (H < 6')

Scale: 1/2" = 1'-0"

8

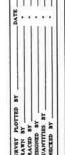



STATE OF HAWAI'I DEPARTMENT OF TRANSPORTATION HIGHWAYS DIVISION


<u>HEAD WALL SECTION</u> 3-84" CMP EXTENSION


QUEEN KAAHUMANU HIGHWAY WIDENING HENRY ST. to KEALAKEHE PKWY - PHASE I Federal Aid Project No. NH-019-1(20)


Scale: As Noted

Date: November 2009

SHEET No. 3 OF 5 SHEETS

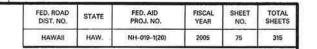

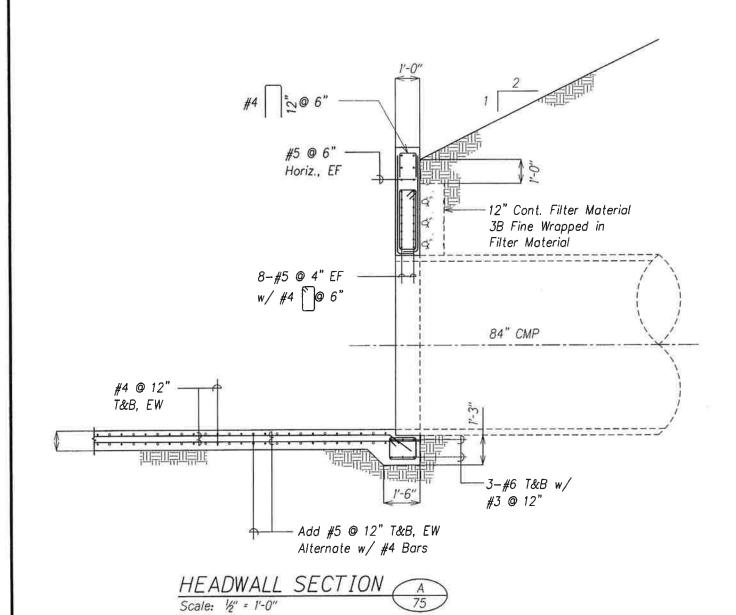

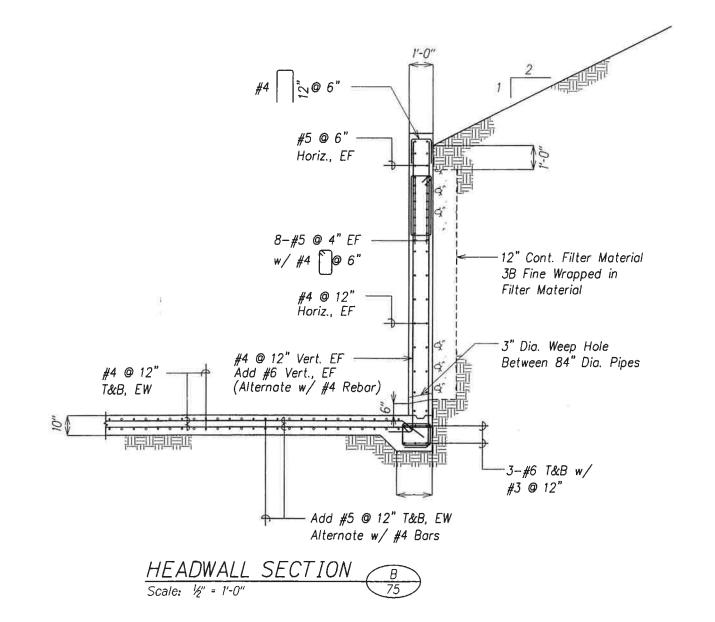



THIS WORK WAS PREPARED BY ME OR UNDER MY SUPERVISION EXP. 04-30-10 STATE OF HAWAI'I
DEPARTMENT OF TRANSPORTATION
HIGHWAYS DIVISION

<u>HEAD WALL SECTION</u> 3-84" CMP EXTENSION

QUEEN KAAHUMANU HIGHWAY WIDENING HENRY ST. to KEALAKEHE PKWY - PHASE I


Federal Aid Project No. NH-019-1(20)
Scale: As Noted Date: November 2009

SHEET No. 4 OF 5 SHEETS

AS-BUILT

75


FED. ROAD	STATE	FED. AID	FISCAL	SHEET	TOTAL
DIST. NO.		PROJ. NO.	YEAR	NO.	SHEETS
HAWAII	HAW.	NH-019-1(20)	2005	76	315

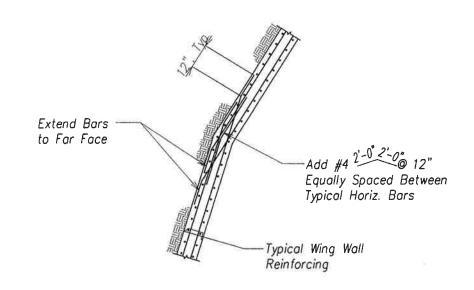

PLAN AT KINK IN WING WALL

Scale: 1/2" = 1'-0"

A
76

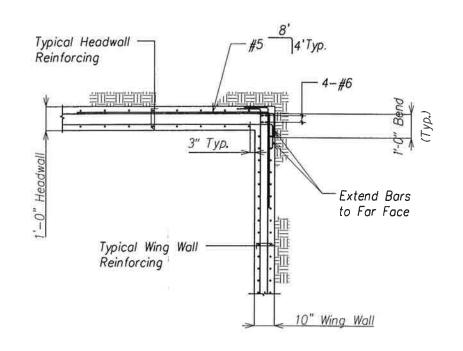

PLAN AT HEADWALL AND WING WALL CORNER

Scale: 1/2" = 1'-0"

B

76



THIS WORK WAS PREPARED BY ME OR UNDER MY SUPERVISION EXP. 04-30-10

STATE OF HAWAYI
DEPARTMENT OF TRANSPORTATION

# HEADWALL PLAN & SECTION 3-84" CMP EXTENSION


QUEEN KAAHUMANU HIGHWAY WIDENING
HENRY ST. to KEALAKEHE PKWY - PHASE I
Federal Aid Project No. NW-019-1/201

Federal Aid Project No. NH-019-1(20)
Scale: As Noted Date: November 2009

SHEET No. 5 OF 5 SHEETS

70

AS-BUILT

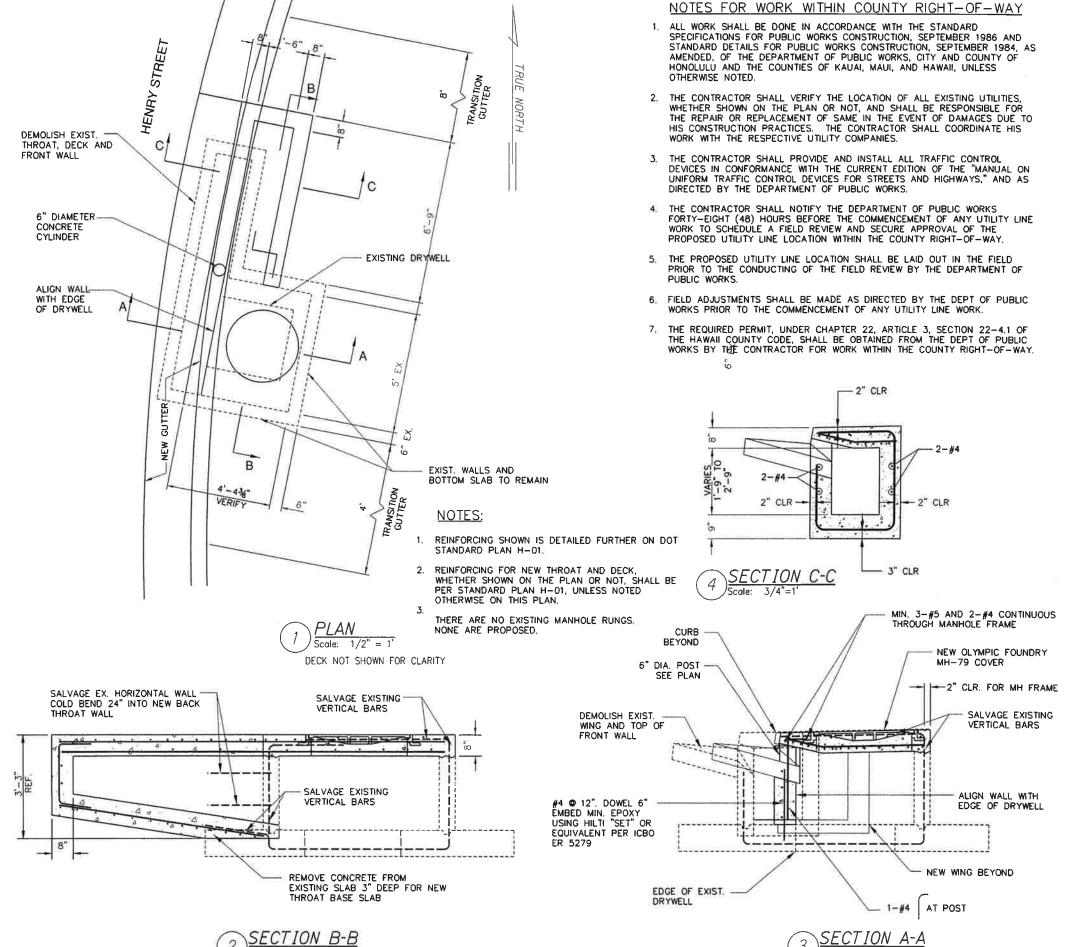

.....

DRAWN TRACED DESIGNED OUANTED CHECKED 
 FED. ROAD DIST. NO.
 STATE
 FED. AID PROJ. NO.
 FISCAL YEAR
 SHEET NO.
 TOTAL SHEETS

 HAWAII
 HAW.
 NH-019-1(20)
 2005
 77
 315

### NOTES FOR WORK WITHIN COUNTY RIGHT-OF-WAY(CONT)

- B. THE EXISTING PAVEMENT SHALL BE SAW-CUT BEFORE COMMENCING OF TRENCHING WORK. PAYMENT FOR SAW-CUTTING SHALL BE CONSIDERED INCIDENTAL TO THE OTHER CONTRACT ITEMS.
- ANY PAVEMENT OUTSIDE THE CONTRACT ZONE LIMITS DAMAGED AS A RESULT OF CONSTRUCTION OPERATIONS SHALL BE RESTORED TO ITS ORIGINAL CONDITION, OR BETTER, AS DIRECTED BY THE DPW.
- O. A TEMPORARY COLD MIX PATCH SHALL BE APPLIED IMMEDIATELY UPON COMPLETION OF THE BACKFILLING OPERATION AND SHALL BE MAINTAINED BY THE CONTRACTOR UNTIL A PERMANENT PATCH IS AUTHORIZED BY THE DEPARTMENT OF PUBLIC WORKS.
- NO MATERIAL, EXCEPT THE TRENCH EXCAVATED MATERIAL, SHALL BE STOCKPILED CLOSER THAN SIX (6) FEET FROM THE EXISTING EDGE OF PAVEMENT.
- 12. NO CONSTRUCTION EQUIPMENT SHALL BE PARKED WITHIN THE ROAD RIGHT-OF-WAY IN SUCH A MANNER THAT THE EQUIPMENT WILL OBSTRUCT THE NORMAL MOVEMENT AND SIGHT DISTANCE OF THE DRIVING MOTORIST, EXCEPT DURING ACTUAL WORKING HOURS.
- 13. EXCEPT DURING ACTUAL WORKING HOURS, ALL SIGNS THAT DO NOT PERTAIN TO THE CONSTRUCTION ACTIVITY, SUCH AS "MEN WORKING" AND "FLAGMAN AHEAD" SHALL BE COVERED OR LAID DOWN. HOWEVER, ALL SIGNS NECESSARY FOR THE SAFETY OF THE PUBLIC SHALL BE MAINTAINED.
- 14. ANY PAVEMENT MARKINGS, STRUCTURES, AND APPURTENANCES (WITHIN OR OUTSIDE OF THE CONSTRUCTION LIMITS) DAMAGED AND/OR WORN AWAY UNDER THE PERMIT SHALL BE REPAINTED OR RECONSTRUCTED AS DIRECTED BY THE DEPARTMENT OF PUBLIC WORKS.
- NO TRENCHING SHALL BE LEFT OPEN FOR MORE THAN FIVE (5) WORKING DAYS.
- . SHOULD TRENCHING OCCUR THROUGH AN EXISTING SIDEWALK OR SHOULD DAMAGES OCCUR TO THE SIDEWALK AS A RESULT OF ANY CONSTRUCTION WORK, THE FOLLOWING PROCEDURE SHALL BE UTILIZED TO REPAIR THE SIDEWALK:
- ALL PORTLAND CEMENT CONCRETE TO BE REMOVED SHALL FIRST BE CUT WITH A CONCRETE SAW THAT HAS A DIAMOND OR CARBORUNDUM ABRASIVE WHEEL. THOSE CUTS SHALL BE MADE TO A DEPTH EQUAL TO AT LEAST ONE-FOURTH OF THE DEPTH OF THE SLAB, OR ENOUGH AS IS DEEMED NECESSARY BY THE DEPARTMENT OF PUBLIC WORKS, TO PERMIT BREAKING OUT THE BALANCE OF THE CONCRETE WITHOUT SPALLING OFF THE EXPOSED EDGES OF THE SLAB LEFT IN PLACE.
- IF ANY CONCRETE BLOCK IS TOUCHED, THE WHOLE BLOCK SHALL BE REMOVED AND LATER REPLACED, UNLESS A MINOR VARIATION IS AUTHORIZED BY THE DPW OR ITS REPRESENTATIVE.
- C: ANY DAMAGES TO ADJACENT AREAS DUE TO SETTLEMENT OR TO ANY OTHER EFFECTS WHATSOEVER CAUSED BY THE TRENCH CONSTRUCTION SHALL BE PROPERLY REPAIRED AND CORRECTED.
- d. ALL OTHER INCIDENTAL WORK SHALL BE SATISFACTORILY PERFORMED TO EFFECT THE PROPER RESTORATION OF THE SIDEWALK AREA.
- SHOULD DAMAGE TO A SIDEWALK, CURB AND/OR GUTTER OCCUR AT A LOCATION WHERE A CURB RAMP SHOULD EXIST, OR TO A DRIVEWAY THAT DOES NOT MEET WITH THE REQUIREMENTS OF THE AMERICANS WITH DISABILITIES ACT (ADA), REPAIR WORK SHALL INCLUDE THE CONSTRUCTION OF A CURB RAMP, OR RECONSTRUCTION TO THE DRIVEWAY SUCH THAT THE REPAIR WORK COMPLIES WITH THE ADA AND MEETS WITH THE APPROVAL OF THE DPW
- 17. THE PERMITTEE SHALL MAINTAIN, TO THE SATISFACTION OF THE DEPARTMENT OF PUBLIC WORKS, THE AREA WORKED WITHIN THE GOVERNMENT RIGHT-OF-WAY INCLUDING ANY REPAIRS TO PAVEMENT AND SHOULDER DAMAGED AS A RESULT OF THE INSTALLATION WORK, FOR A PERIOD OF ONE (1) YEAR FROM THE DATE OF FINAL INSPECTION. THE PERMITTEE SHALL UNDERTAKE REPAIRS EXPEDITIOUSLY, WHENEVER DIRECTED BY THE DEPARTMENT OF PUBLIC WORKS DURING THE MAINTENANCE PERIOD.




THIS WORK WAS PREPARED BY ME OR UNDER MY SUPERVISION EXP. 04-30-10 STATE OF HAWAI'I
DEPARTMENT OF THANSPORTATION
HIGHWAYS DIVISION

<u>HENRY STREET</u> <u>MAUKA CATCH BASIN</u>


QUEEN KAAHUMANU HIGHWAY WIDENING HENRY ST. to KEALAKEHE PKWY - PHASE I Federal Aid Project No. NH-019-1(20)

Scale: As Noted Date: November 2009

SHEET No. 1 OF 2 SHEETS

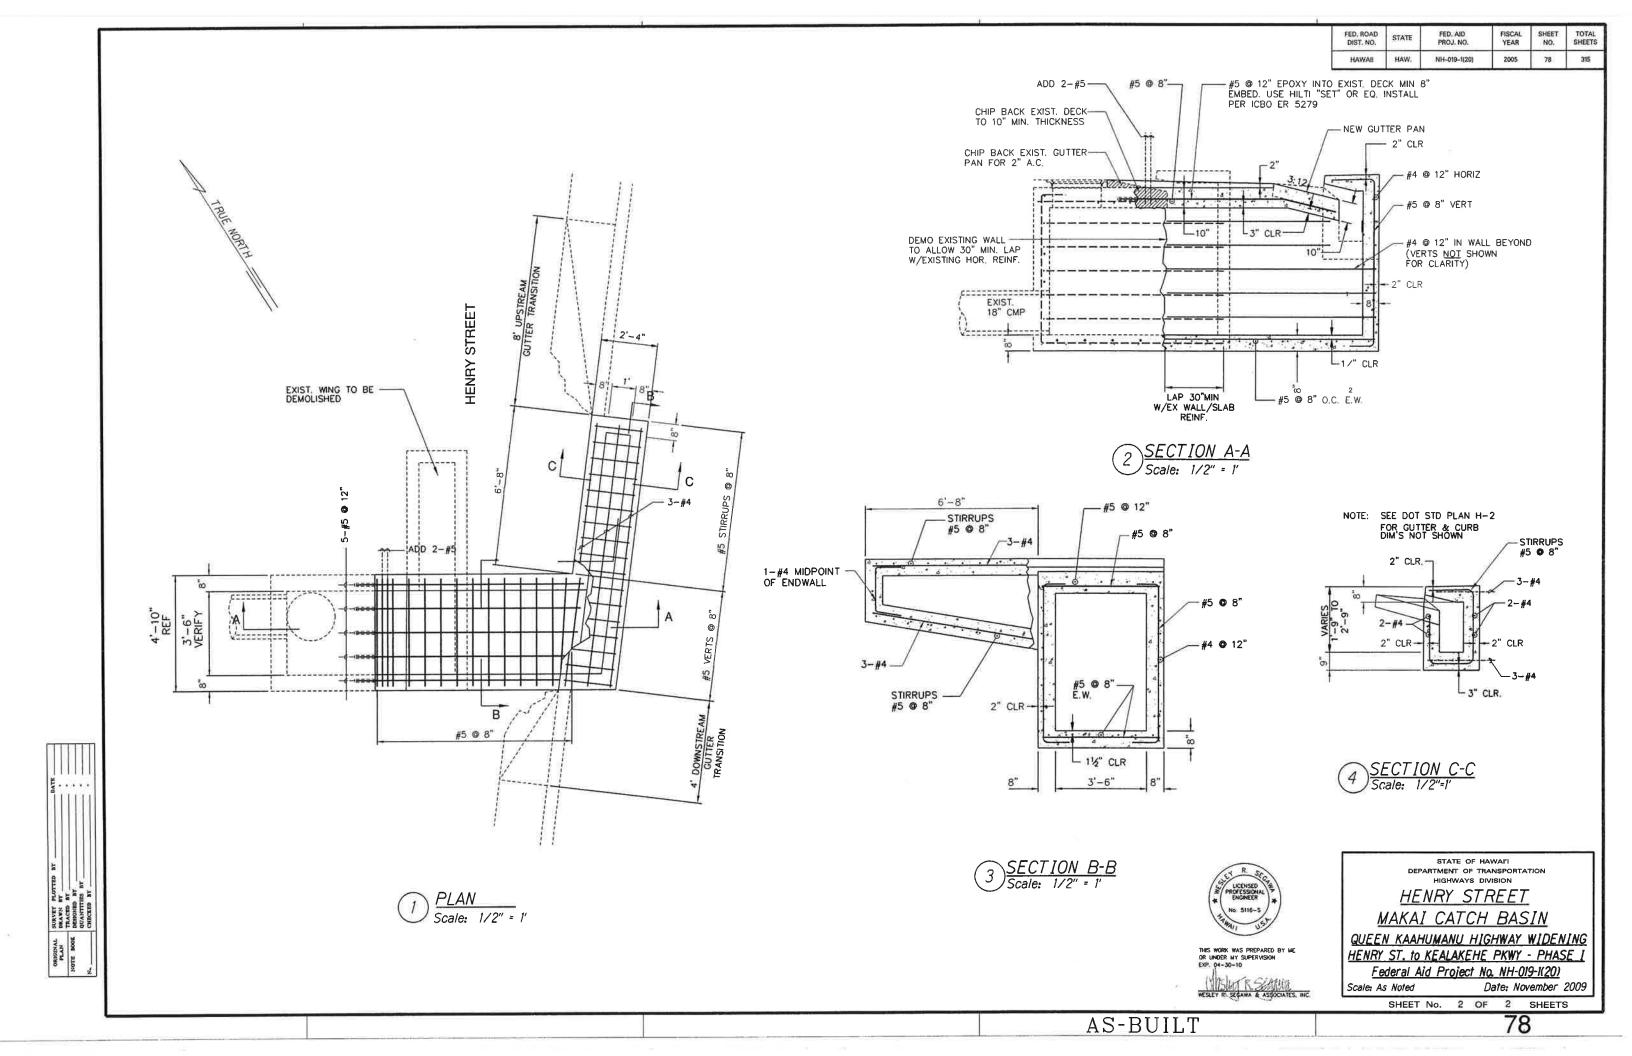


FED. ROAD	STATE	FED. AID	FISCAL	SHEET	TOTAL
DIST. NO.		PROJ. NO.	YEAR	NO.	SHEETS
HAWAII	HAW.	NH-019-1(20)	2005	79	315

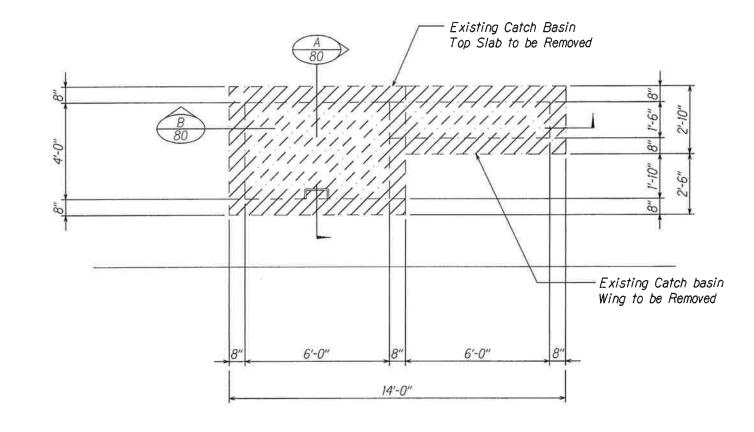

TOP SLAB DEMO PLAN
Scale: 1/2" = 1'-0"

79

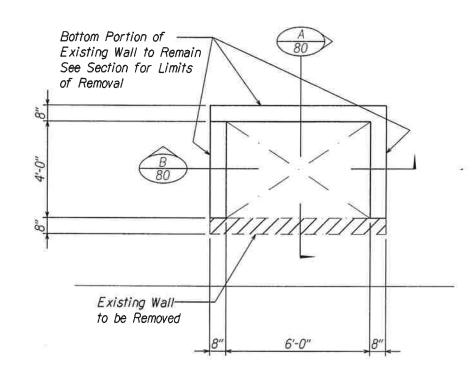

WALL DEMO PLAN Scale: 1/2" = 1'-0"



CATCH BASIN "CB2" TO "CB8" - PLANS

QUEEN KAAHUMANU HIGHWAY WIDENING HENRY ST. to KEALAKEHE PKWY - PHASE I


STATE OF HAWAI'I
DEPARTMENT OF TRANSPORTATION


Federal Aid Project No. NH-019-1(20)
Scale: ½" = 1'-0" Date: November Date: November 2009


SHEET No. 1 OF 3 SHEETS

AS-BUILT

FED. ROAD	STATE	FED. AID	FISCAL	SHEET	TOTAL
DIST. NO.		PROJ. NO.	YEAR	NO.	SHEETS
HAWAII	HAW.	NH-019-1(20)	2005	80	315

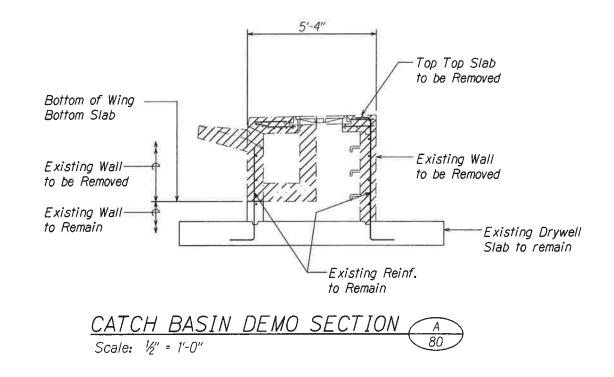

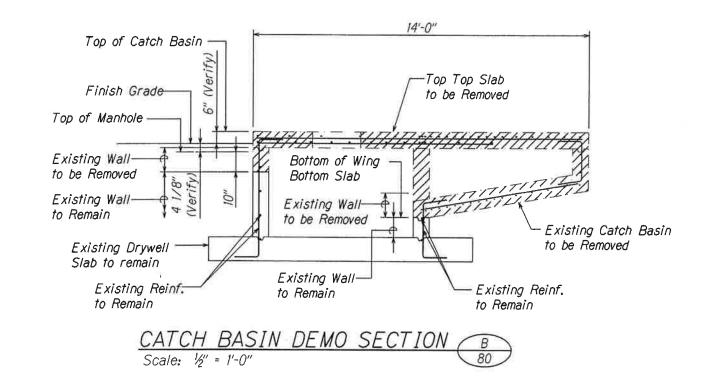

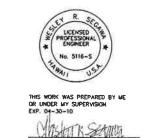

STATE OF HAWAI'I
DEPARTMENT OF TRANSPORTATION
HIGHWAYS DIVISION

CATCH BASIN "CB2" TO "CB8" - PLANS


QUEEN KAAHUMANU HIGHWAY WIDENING HENRY ST. 10 KEALAKEHE PKWY - PHASE I


Federal Aid Project No. NH-019-1(20)
Scale: ½" = 1'-0" Date: November


 ½" = 1'-0"
 Date: November 2009


 SHEET No. 2
 OF 3
 SHEETS


AS-BUILT

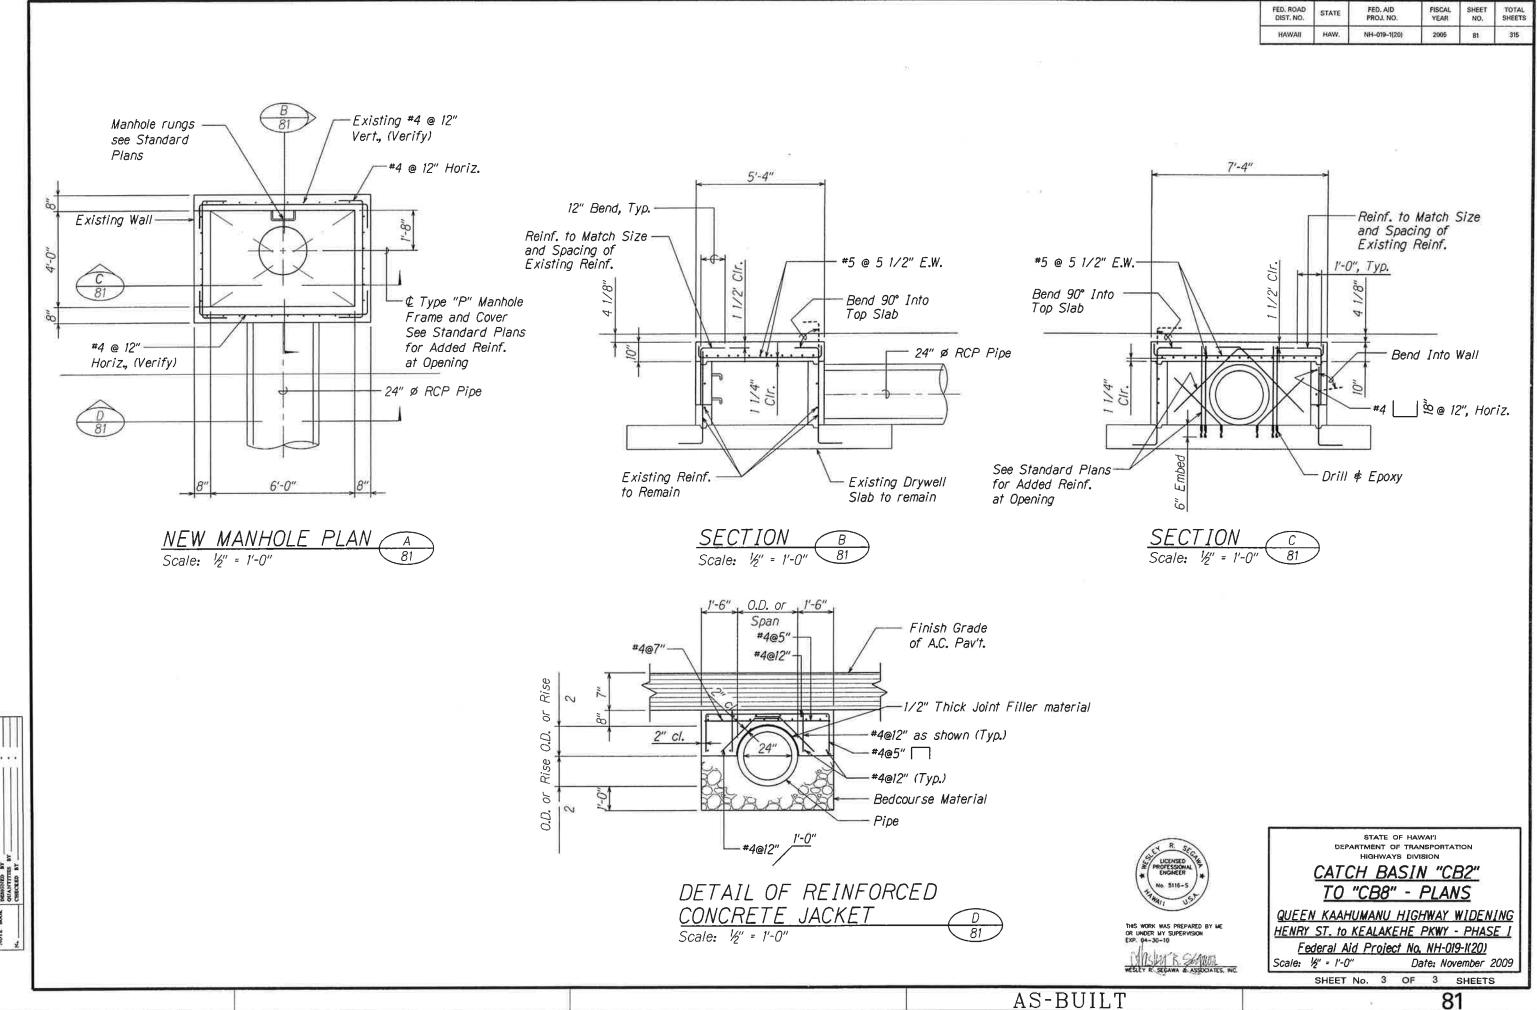


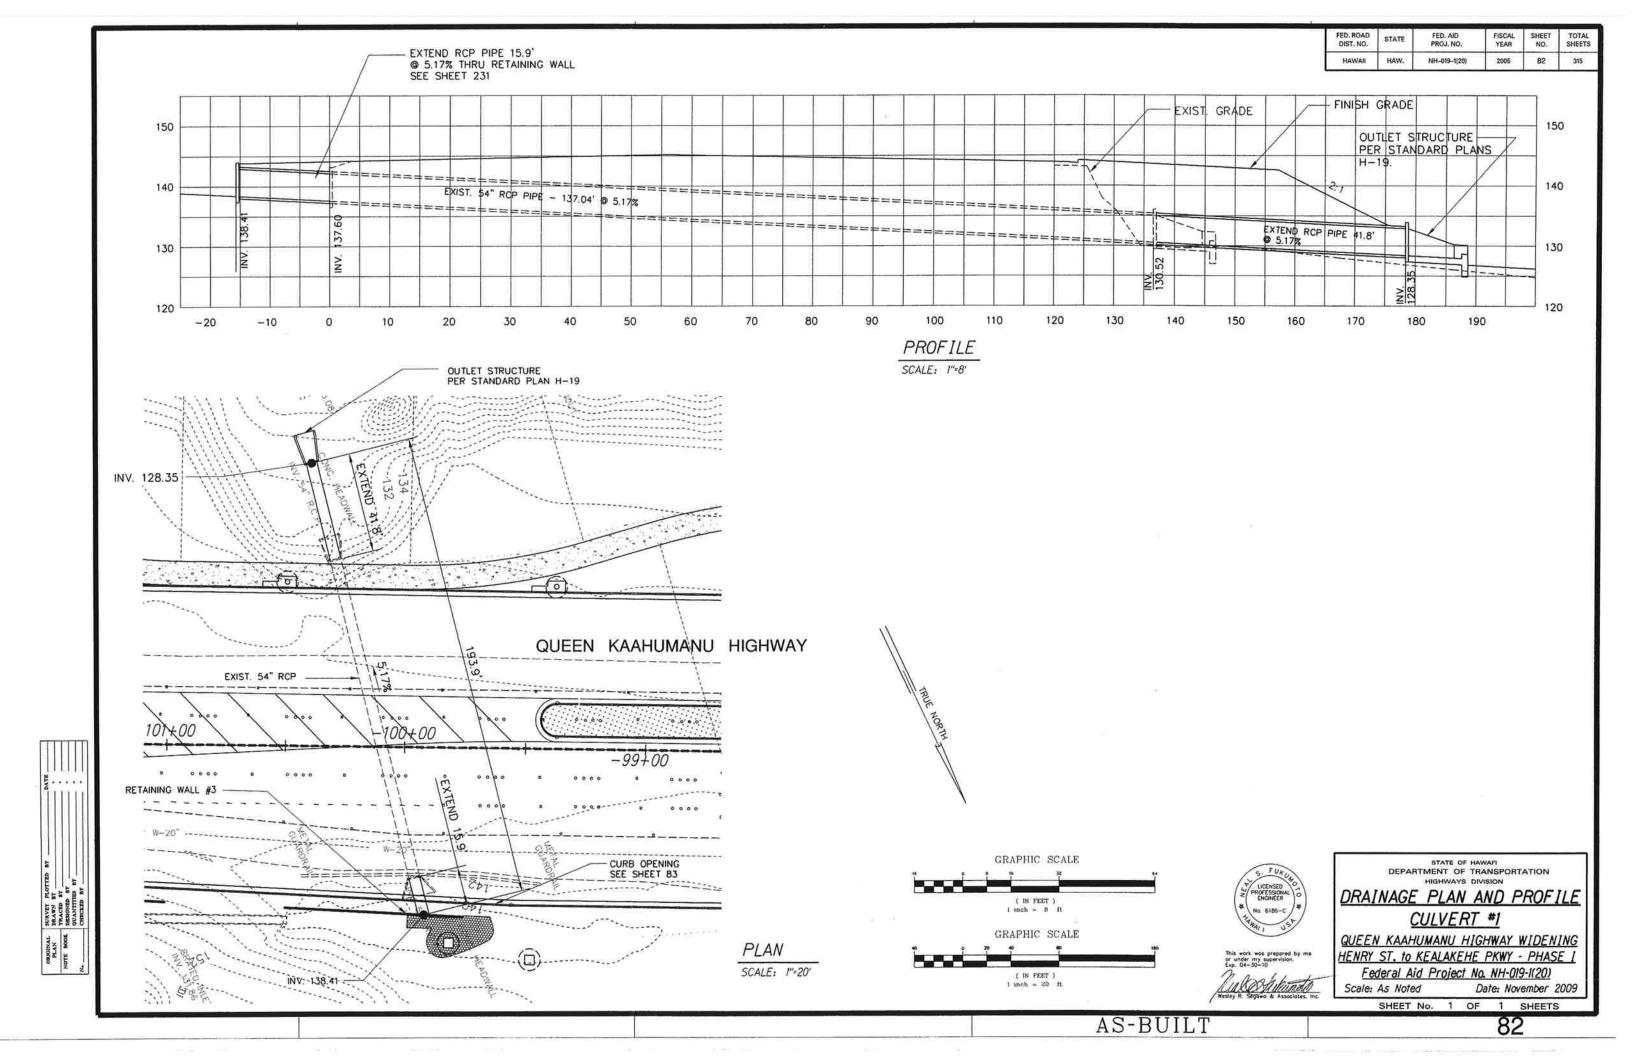

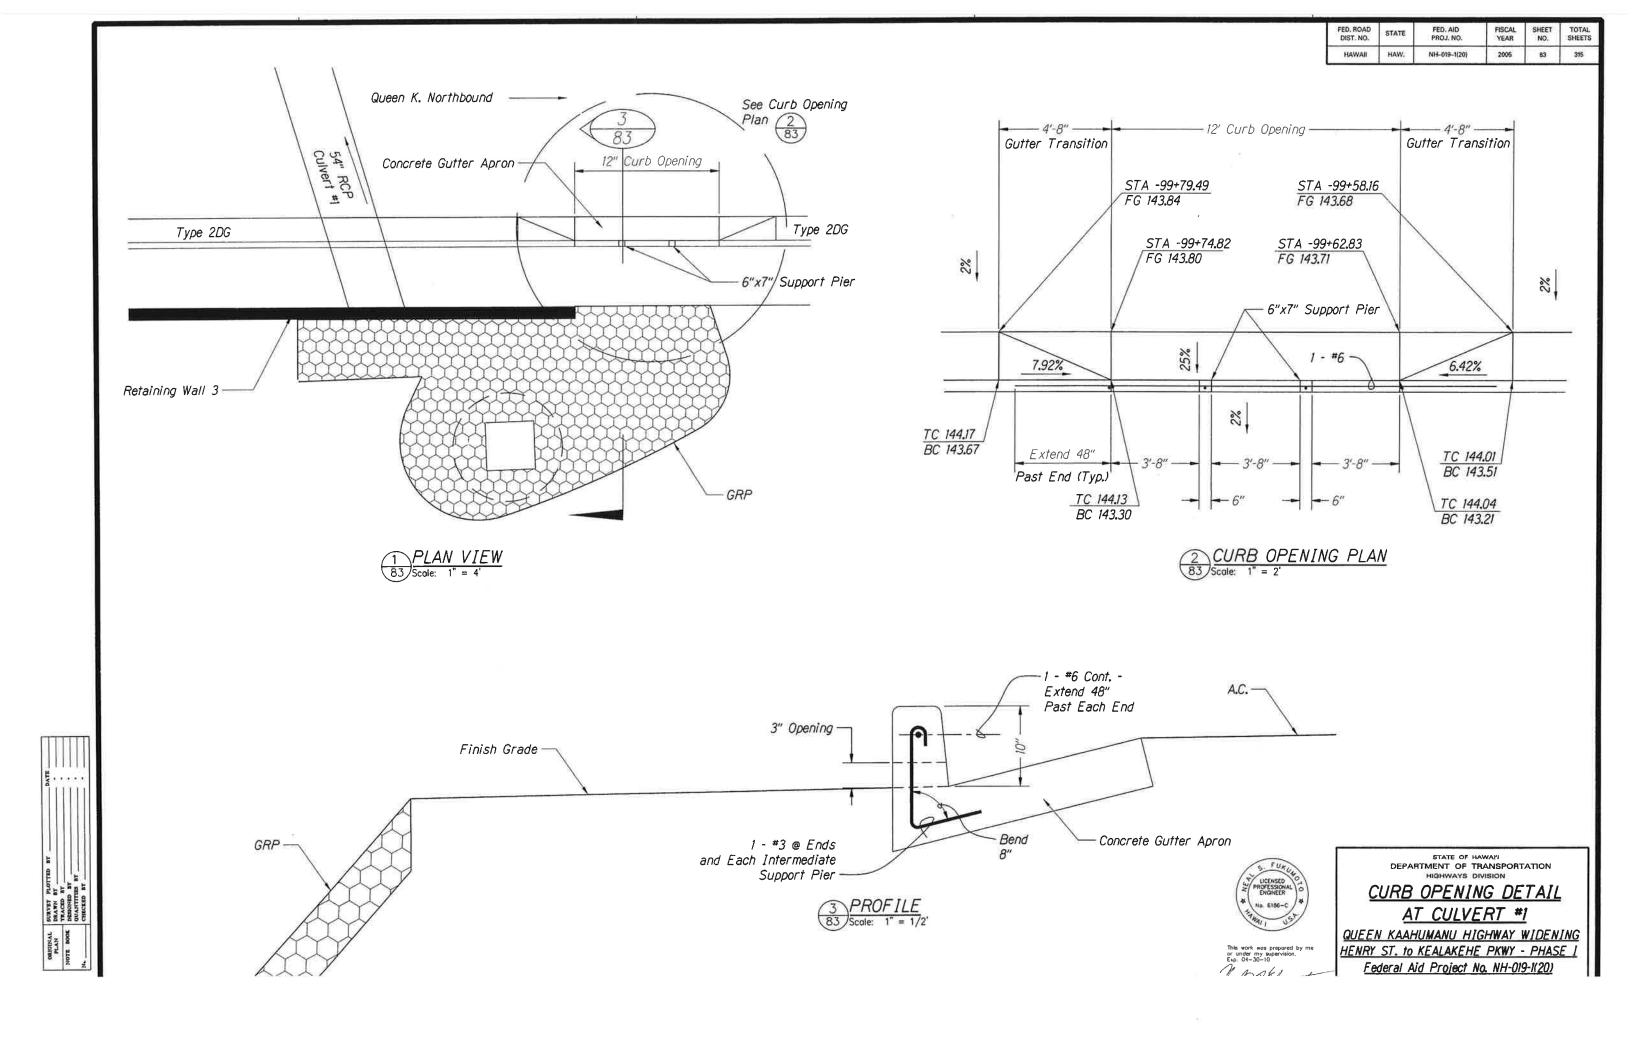

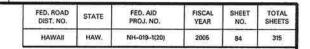

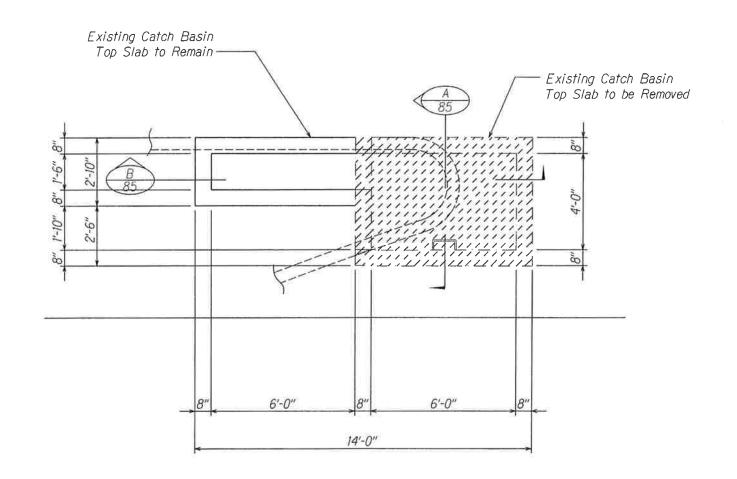

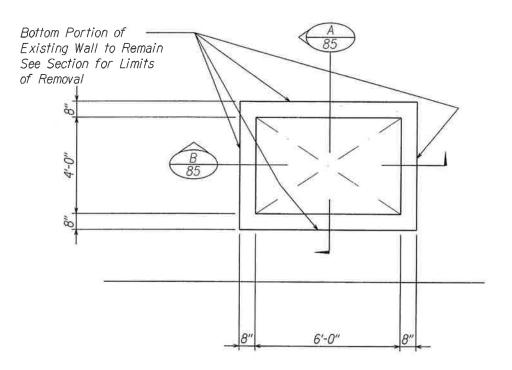

WALL DEMO PLAN


SCALE: 1/2" = 1'-0"

84

TOP SLAB DEMO PLAN

SCALE: 1/2" = 1'-0"

A
84

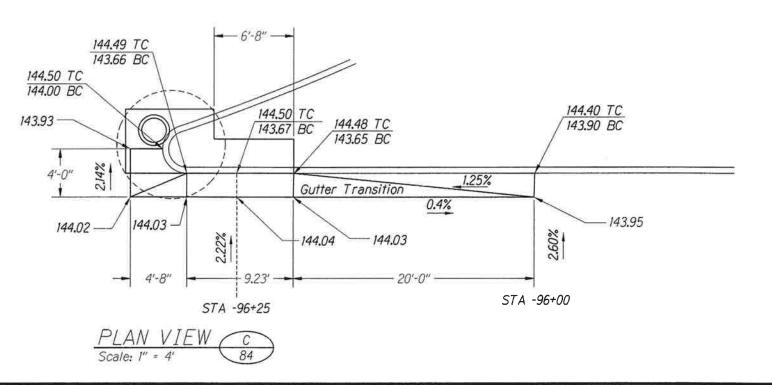



THIS WORK WAS PREPARED BY ME
OR LINDER MY SUPERVISION
EXP. 64-30-10

STATE OF HAWAI'I DEPARTMENT OF TRANSPORTATION HIGHWAYS DIVISION


CATCH BASIN "CB15"


QUEEN KAAHUMANU HIGHWAY WIDENING HENRY ST. to KEALAKEHE PKWY - PHASE I Federal Aid Project No. NH-019-1(20)

Scale: As Noted

As Noted Date: November 2009
SHEET No. 1 OF 3 SHEETS



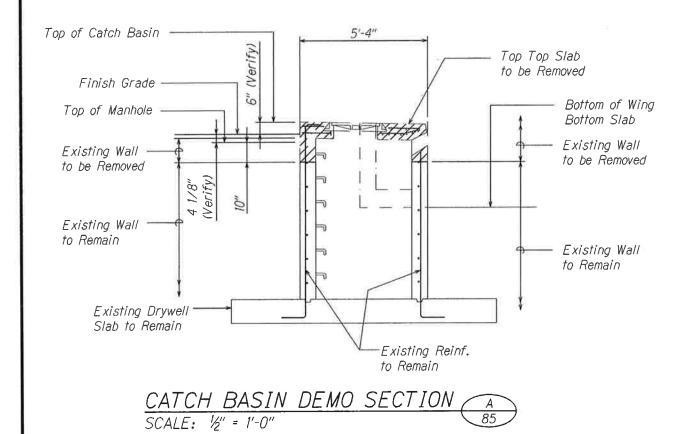

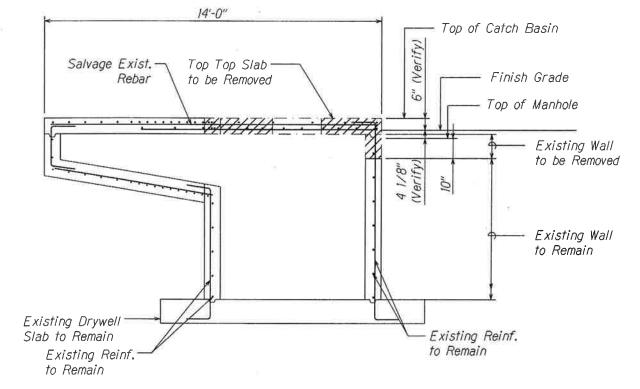

CATCH BASIN DEMO SECTION B SCALE: 1/2" = 1'-0"

> R. SCC LUCENSED W PROFESSIONAL P PROFESSION

THIS WORK WAS PREPARED BY ME OR UNDER MY SUPERVISION EXP. 04-30-10

WESLEY R. SEGAWA & ASSOCIATES, INC.

STATE OF HAWAI'I
DEPARTMENT OF TRANSPORTATION
HIGHWAYS DIVISION

## CATCH BASIN "CB15"

QUEEN KAAHUMANU HIGHWAY WIDENING HENRY ST. to KEALAKEHE PKWY - PHASE I

Federal Aid Project No. NH-019-1(20)
Scale: As Noted Date: November 2009

SHEET No. 2 OF 3 SHEETS

FED. ROAD DIST. NO.	STATE	FED. AID PROJ. NO.	FISCAL YEAR	SHEET NO.	TOTAL SHEETS
HAWAII	HAW.	NH-019-1(20)	2005	86	315

Top of Curb

Bend 4"

7'-4"

1 1/2' CIr.

#4 Continuous

1'-0", Typ.


1 1/4" CIr.


Bend 90° into

Top Slab

Existing Drywell

Slab to Remain

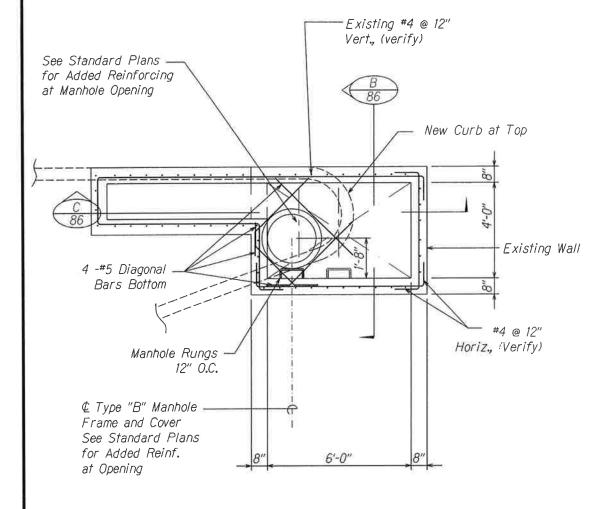

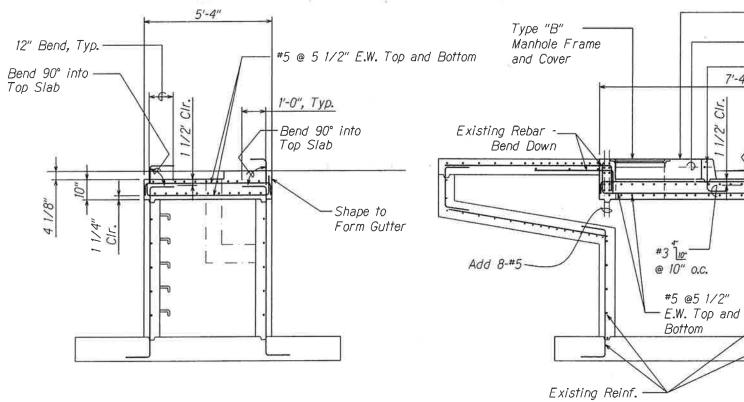

MANHOLE PLAN
SCALE: 1/2" = 1'-0"

86

SECTION

SCALE: ½" = 1'-0"

<u>SECTION</u> SCALE: ½" = 1'-0"





to Remain

STATE OF HAWAI'I
DEPARTMENT OF TRANSPORTATION
HIGHWAYS DIVISION


# CATCH BASIN "CB15"

QUEEN KAAHUMANU HIGHWAY WIDENING HENRY ST. to KEALAKEHE PKWY - PHASE I Federal Aid Project No. NH-019-1(20)

Scale: As Noted Date: November 2009

SHEET No. 3 OF 3 SHEETS


FED. ROAD DIST. NO.	STATE	FED. AID PROJ. NO.	FISCAL YEAR	SHEET NO.	TOTAL SHEETS
HAWAII	HAW.	NH-019-1(20)	2005	87	315

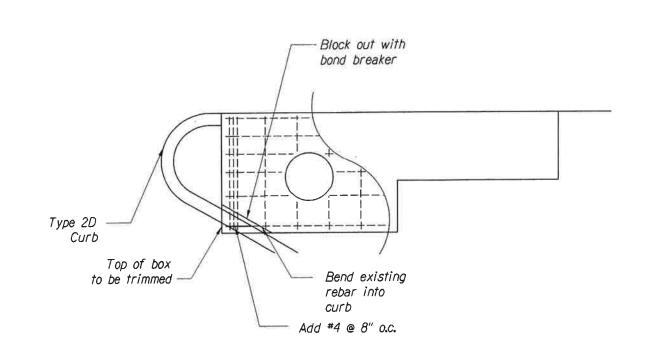

- Varies -Add 3-#4 Bond : Breaker existing rebar Type 2D -Curb 0" Add #4 @ 8" o.c. E.W. min. Bend existing rebars 12" min. into new conc. Apply cement slurry immediately before pouring concrete existing rebaron existing conc. surfaces

# PLAN VIEW OF TOP REINFORCING STEEL 87 Scale: 1/2" - 1'

2 <u>SECTION</u> 87 Scale: 2" • 1'

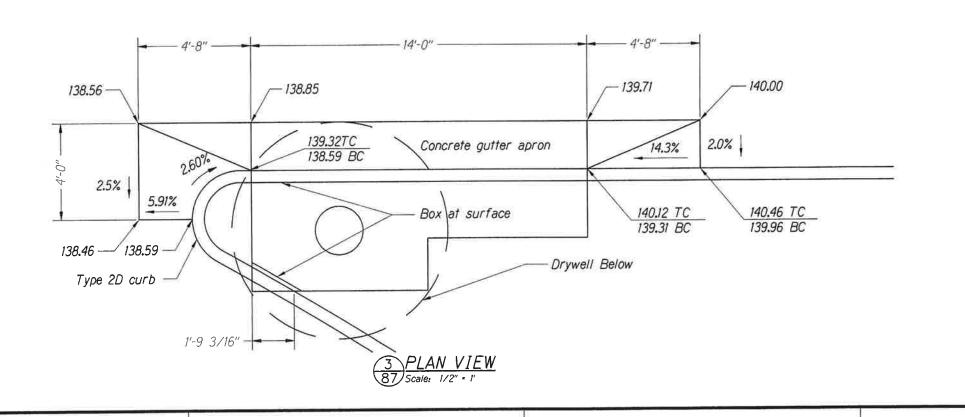



STATE OF HAWAI'I
DEPARTMENT OF TRANSPORTATION
HIGHWAYS DIVISION

# CATCH BASIN "CB16"

QUEEN KAAHUMANU HIGHWAY WIDENING HENRY ST. to KEALAKEHE PKWY - PHASE 1

Federal Aid Project No. NH-019-1(20)

Scale: As Noted Date: November 2009

SHEET No. 1 OF 1 SHEETS

