




| STATE  | PROJ. NO.   | FISCAL YEAR | SHEET NO. | TOTAL SHEETS |
|--------|-------------|-------------|-----------|--------------|
| HAWAII | 10 BC-01-71 | 1973        | 26        | 51           |

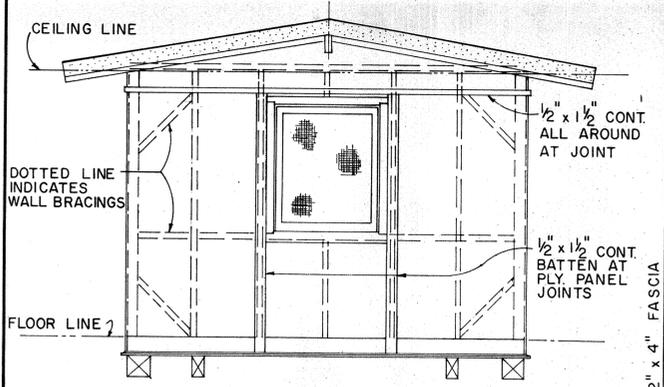


**ELEVATION B**  
ELEVATION D SIMILAR  
SCALE: 3/8" = 1'-0"

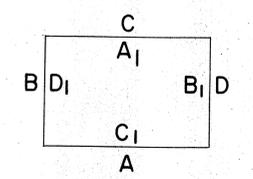


**EXTERIOR & INTERIOR KEY**

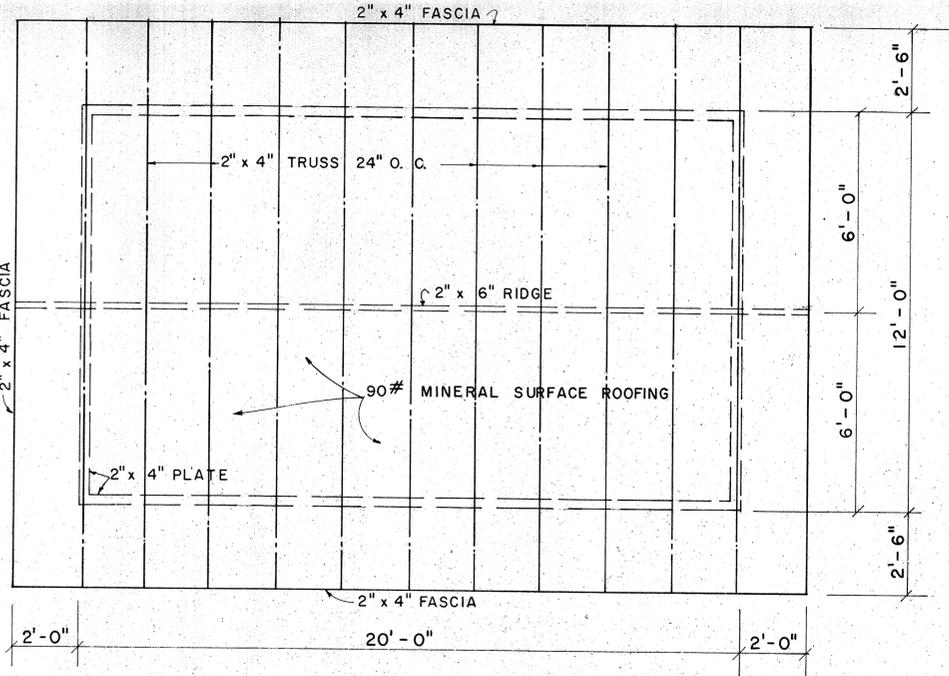


**ROOF FRAMING PLAN**  
SCALE: 3/8" = 1'-0"

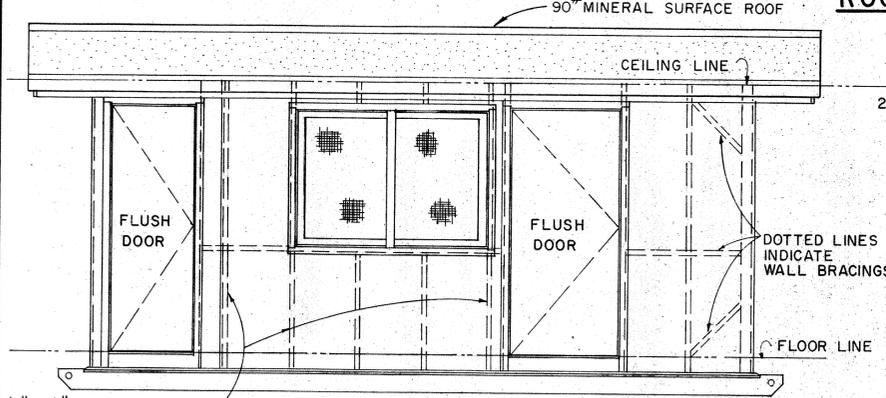


**ELEVATION A**  
SCALE: 3/8" = 1'-0"

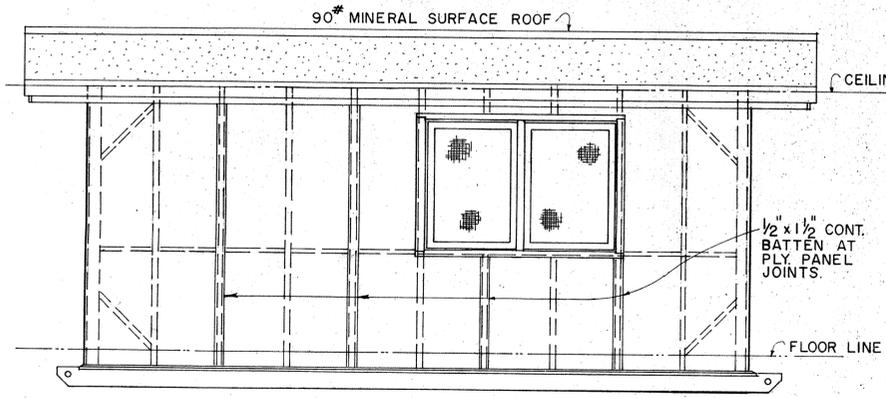


**ELEVATION C**  
SCALE: 3/8" = 1'-0"

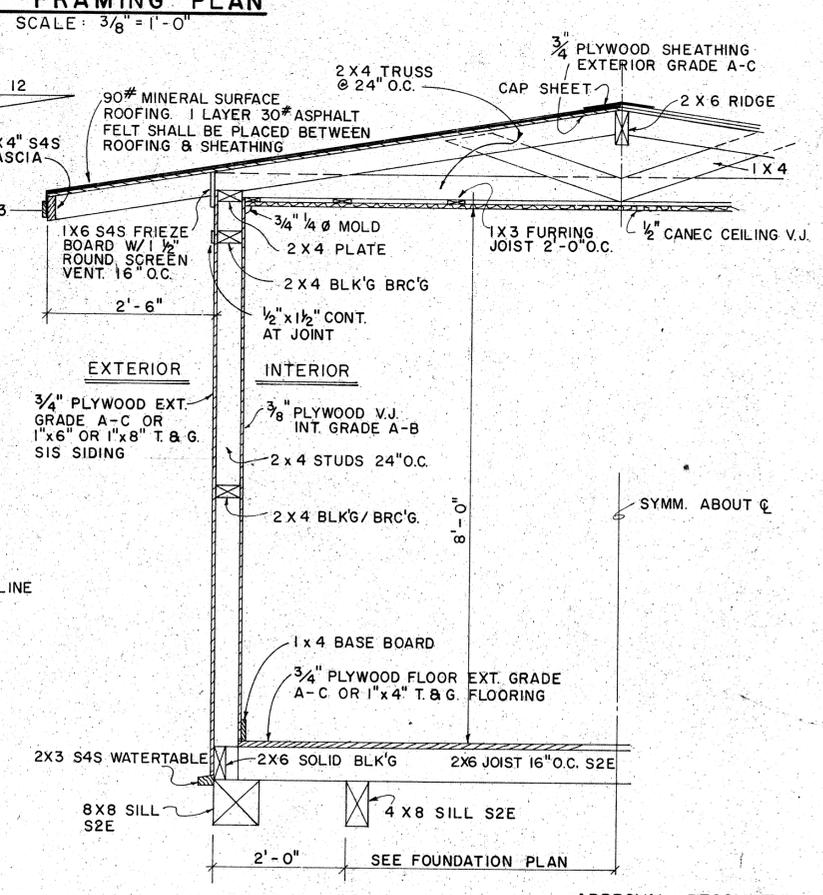

**TYPICAL WALL SECTION**  
SCALE: 3/8" = 1'-0"

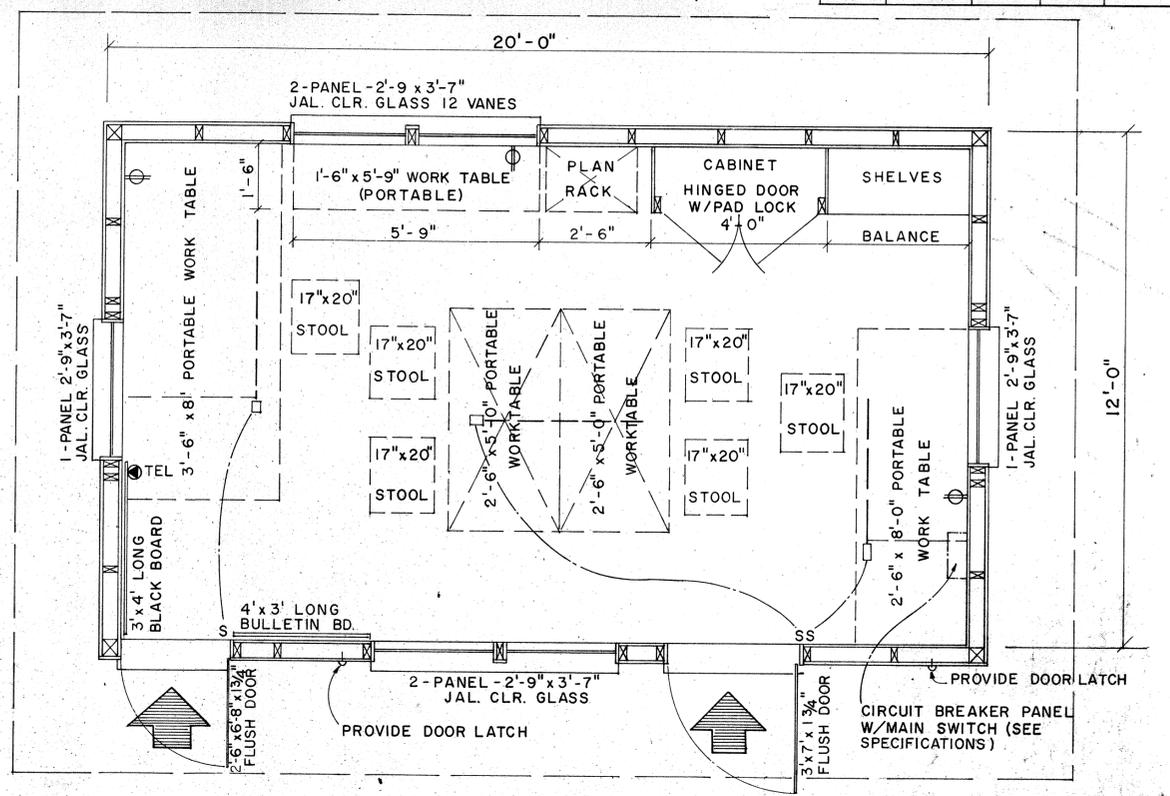

**FLOOR PLAN**  
SCALE: 1/2" = 1'-0"

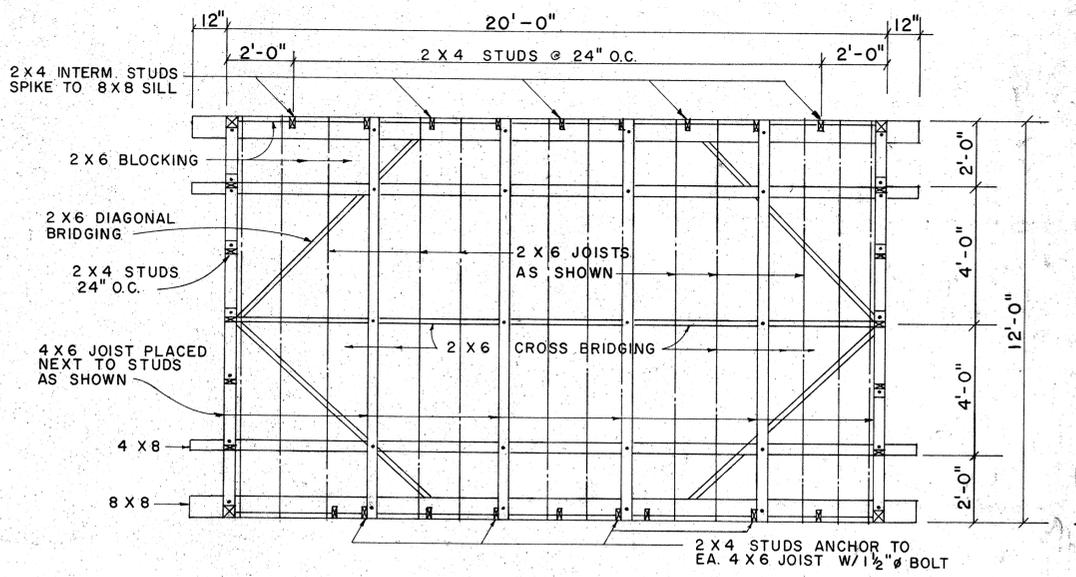

**FOUNDATION FRAMING PLAN**  
SCALE: 3/8" = 1'-0"




APPROVAL RECOMMENDED:  
  
 HIGHWAY DESIGN ENGINEER 12-4-69 DATE  
 APPROVED:  
  
 ASSISTANT CHIEF, ENGINEERING 12-10-69 DATE

| NO. | REVISION | APPROVED BY | DATE |
|-----|----------|-------------|------|
|     |          |             |      |





STATE OF HAWAII  
 DEPARTMENT OF TRANSPORTATION  
**FIELD OFFICE**  
 Scale: As Noted  
**SHEET NO. 1 OF 5 SHEETS** DD 636.1

SURVEY PLOTTED BY: \_\_\_\_\_ DATE: \_\_\_\_\_  
 PLAN TRACED BY: \_\_\_\_\_  
 NOTE BOOK DESIGNED BY: \_\_\_\_\_  
 QUANTITIES BY: \_\_\_\_\_  
 CHECKED BY: \_\_\_\_\_  
 ORIGINAL No. \_\_\_\_\_



|        |            |             |           |              |
|--------|------------|-------------|-----------|--------------|
| STATE  | PROJ. NO.  | FISCAL YEAR | SHEET NO. | TOTAL SHEETS |
| HAWAII | 19BC-01-71 | 1973        | 27        | 51           |

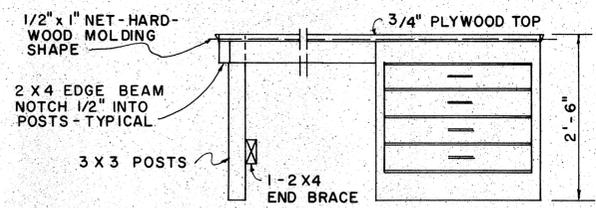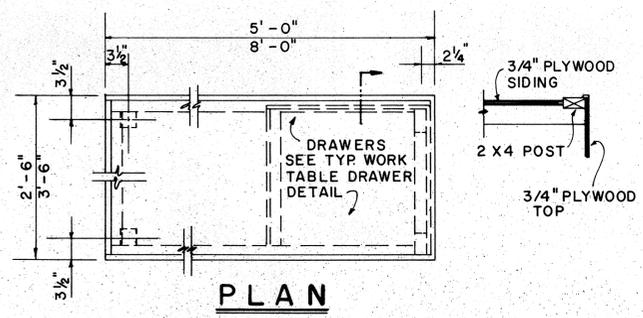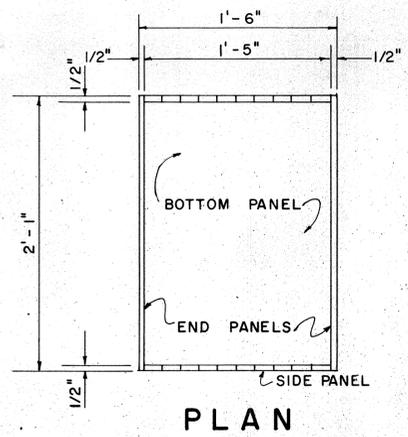


- PORTABLE WORK TABLE DETAIL**  
SCALE: 3/4" = 1'-0"
- 2'-6" x 5'-0" 2 REQ'D
  - 3'-6" x 8'-0" 1 REQ'D
  - 2'-6" x 8'-0" 1 REQ'D

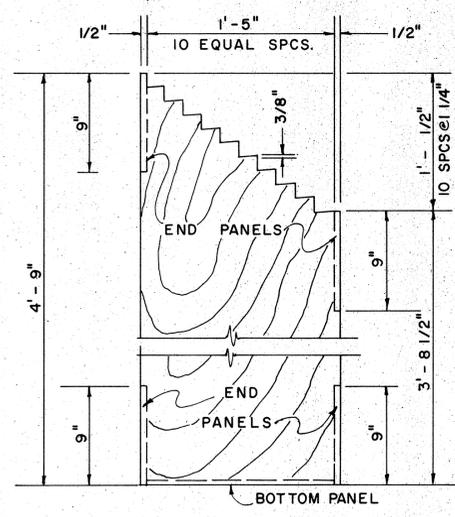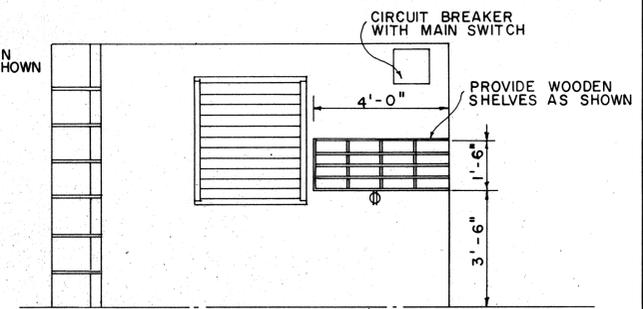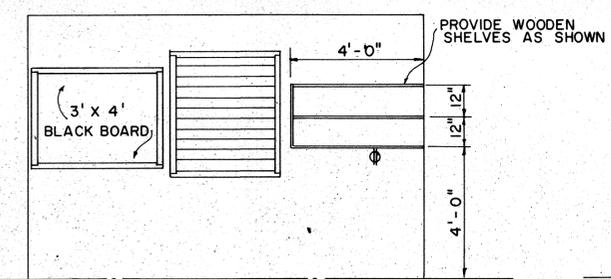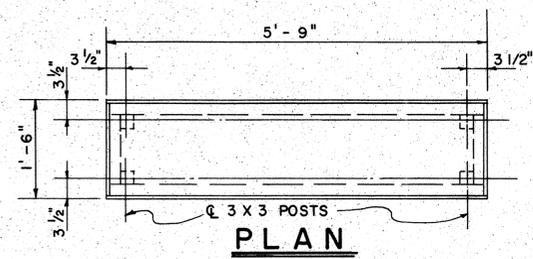

**PLAN RACK DETAIL**  
SCALE: 1 1/2" = 1'-0"  
(ONE REQUIRED)

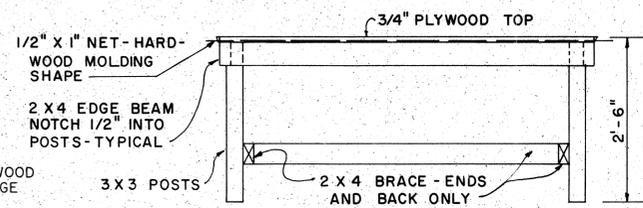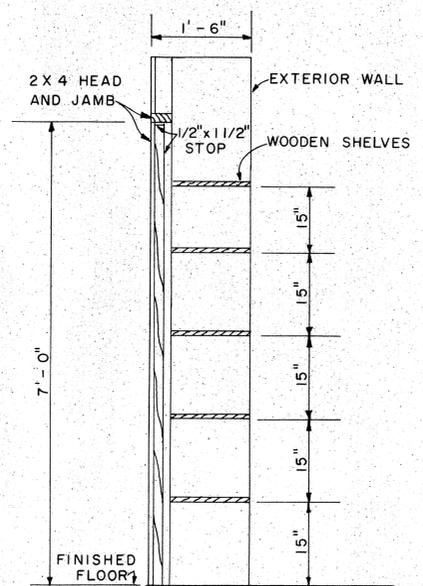

**1'-6" x 5'-9" PORTABLE WORK TABLE DETAIL**  
SCALE: 3/4" = 1'-0"

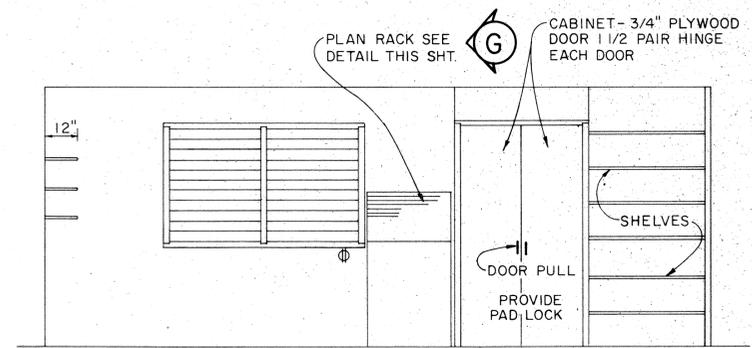

APPROVAL RECOMMENDED:  
*[Signature]* 12-4-69  
HIGHWAY DESIGN ENGINEER DATE

APPROVED:  
*[Signature]* 12-10-69  
ASSISTANT CHIEF, ENGINEERING DATE

| NO. | REVISION | APPROVED BY | DATE |
|-----|----------|-------------|------|
|     |          |             |      |



STATE OF HAWAII  
DEPARTMENT OF TRANSPORTATION  
HIGHWAYS DIVISION

**FIELD OFFICE**

Scale: As Noted




DATE: \_\_\_\_\_  
SURVEY PLOTTED BY: \_\_\_\_\_  
DRAWN BY: \_\_\_\_\_  
DESIGNED BY: \_\_\_\_\_  
NOTE BOOK: \_\_\_\_\_  
QUANTITIES BY: \_\_\_\_\_  
CHECKED BY: \_\_\_\_\_  
No. \_\_\_\_\_

| STATE | PROJ. NO. | FISCAL YEAR | SHEET NO. | TOTAL SHEETS |
|-------|-----------|-------------|-----------|--------------|
| HAW.  | 1986-71   | 1975        | 28        | 51           |

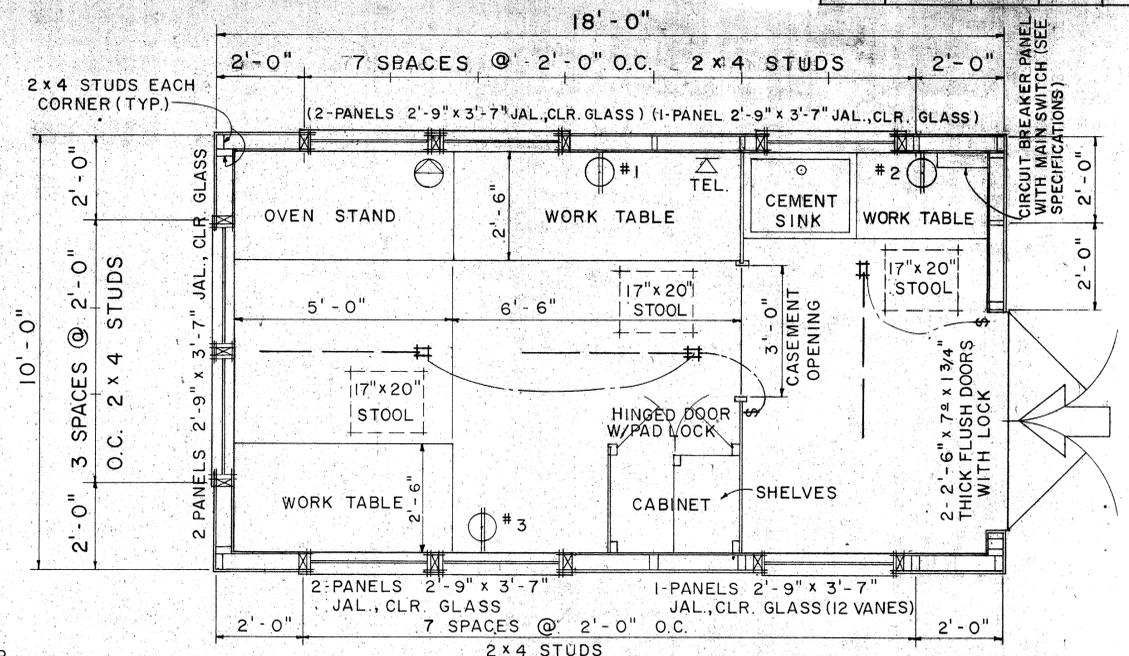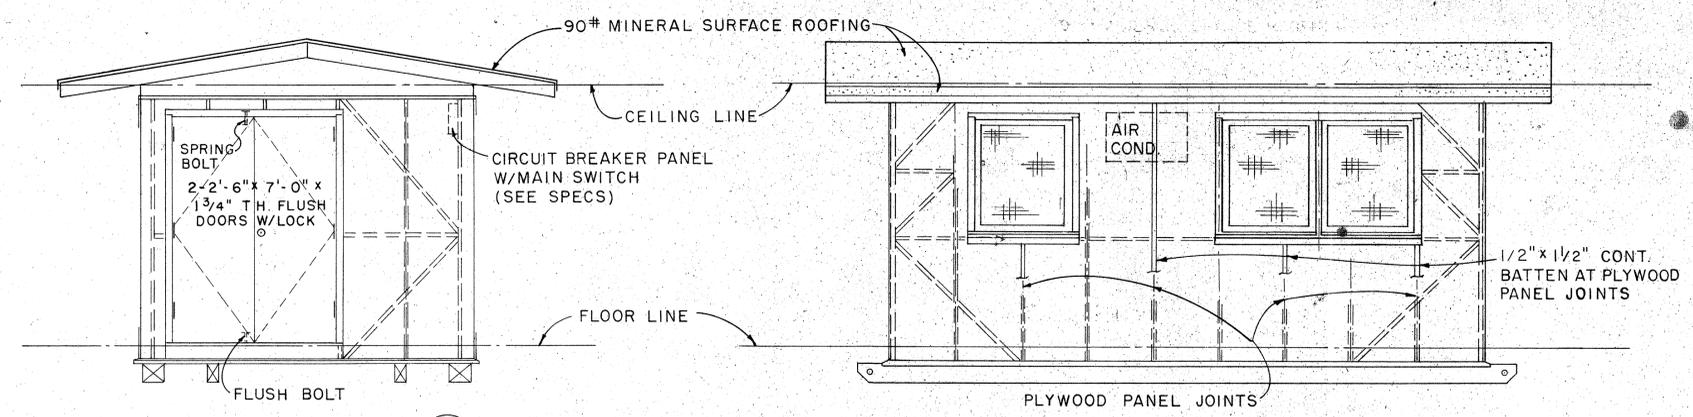

- NOTE:**
1. FLUORESCENT FIXTURE SHALL BE 48", 2 LAMP, 40 WATT, RAPID START.
  2. TELEPHONE AND WALL OUTLET 4'-0" ABOVE FLOOR.

**EXTERIOR & INTERIOR KEY**

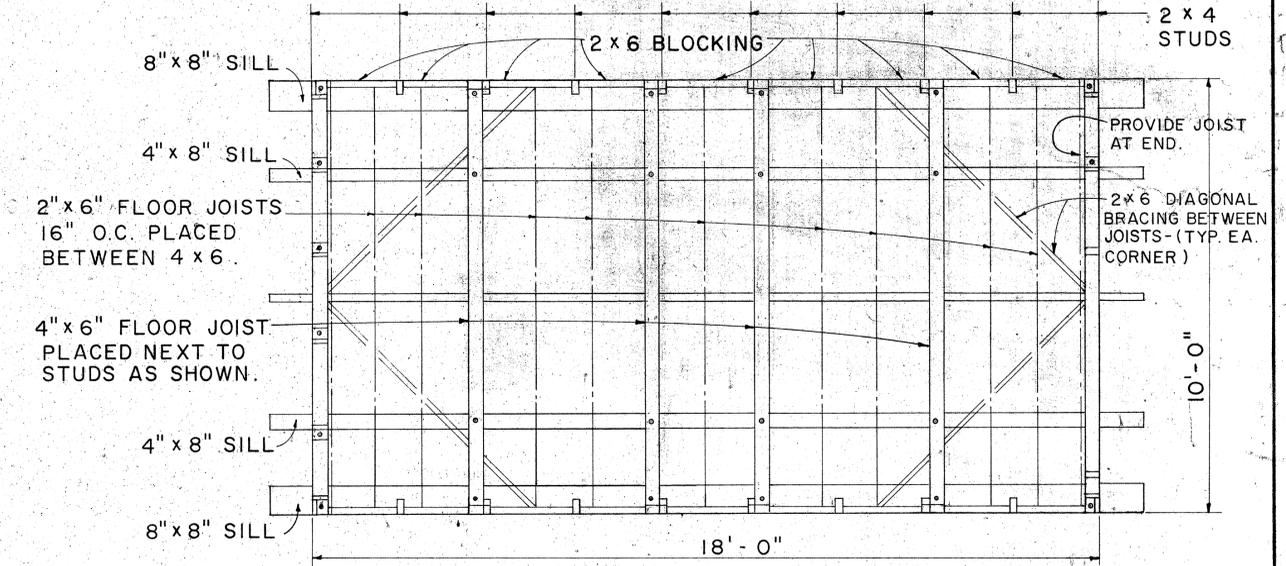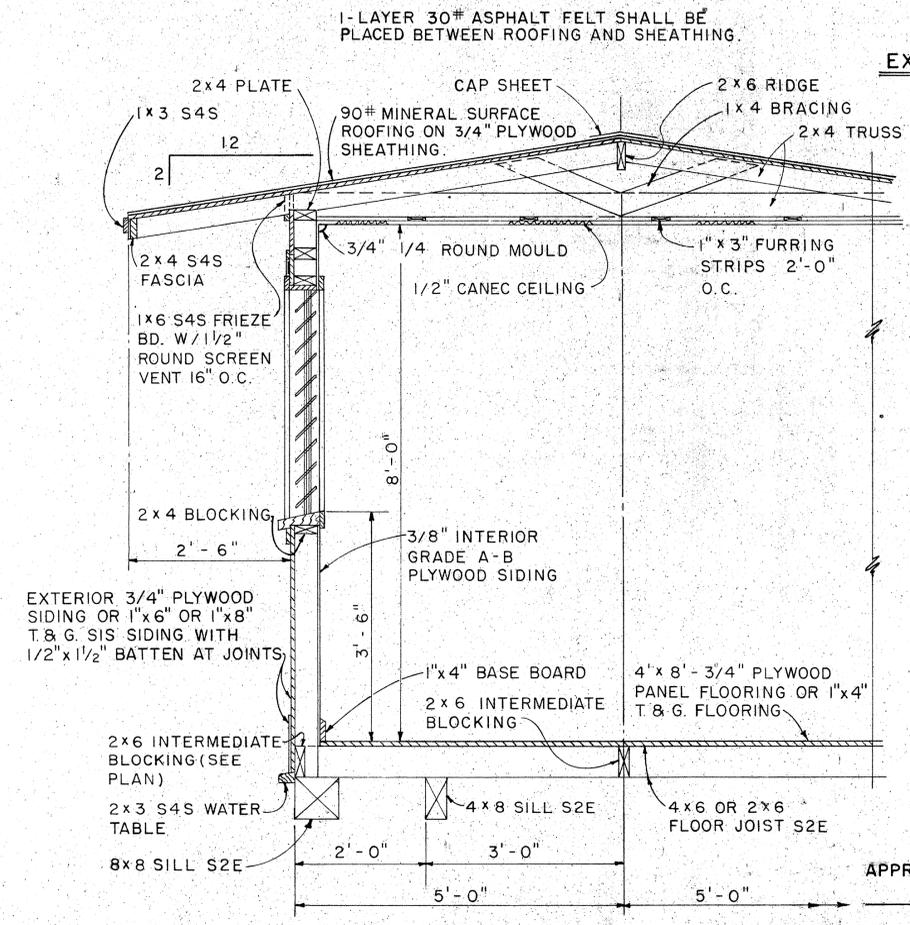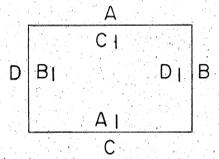

**NOTE:**  
ALL 3/4" PLYWOOD SHALL BE EXTERIOR GRADE A-C OR BETTER.

APPROVAL RECOMMENDED:  
  
 HIGHWAY DESIGN ENGINEER 12-4-69 DATE

APPROVED:  
  
 ASSISTANT CHIEF, ENGINEERING 12-10-69 DATE

| NO. | REVISION | APPROVED BY | DATE |
|-----|----------|-------------|------|
|     |          |             |      |


STATE OF HAWAII  
 DEPARTMENT OF TRANSPORTATION  
 HIGHWAYS DIVISION

**PROJECT SITE LABORATORY**

Scale: As Noted


**SHEET No. 3 OF 5 SHEETS DD 636.3**

|       |            |             |           |              |
|-------|------------|-------------|-----------|--------------|
| STATE | PROJ. NO.  | FISCAL YEAR | SHEET NO. | TOTAL SHEETS |
| HAW.  | 19BC-01-71 | 1973        | 29        | 51           |

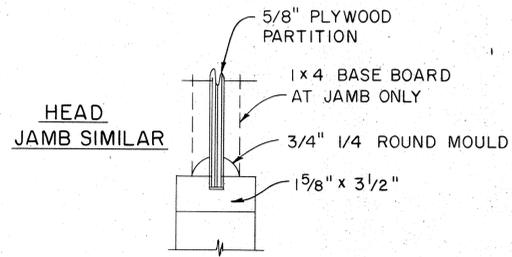


**CASEMENT DETAIL**

SCALE: 3" = 1'-0"

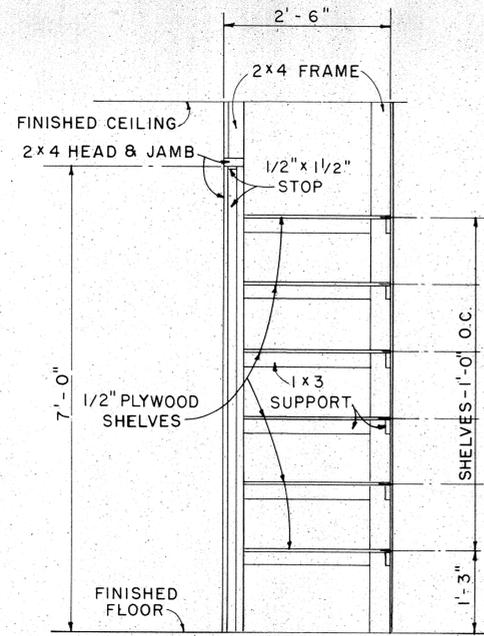


**CABINET DETAIL**

SCALE: 3/4" = 1'-0"

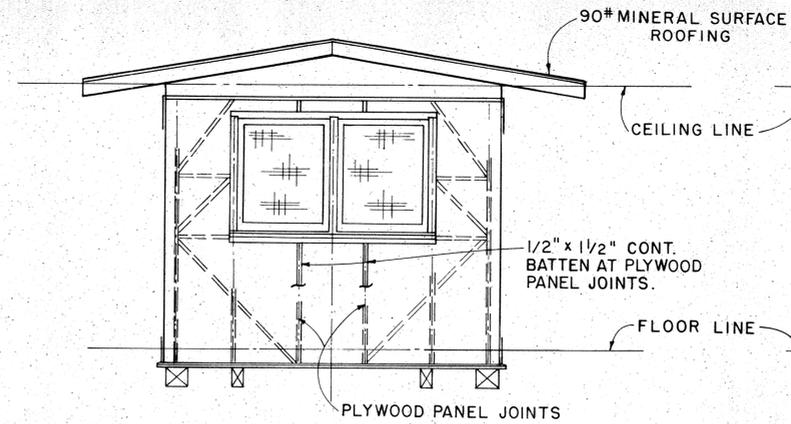


**ELEVATION (D)**

SCALE: 3/8" = 1'-0"

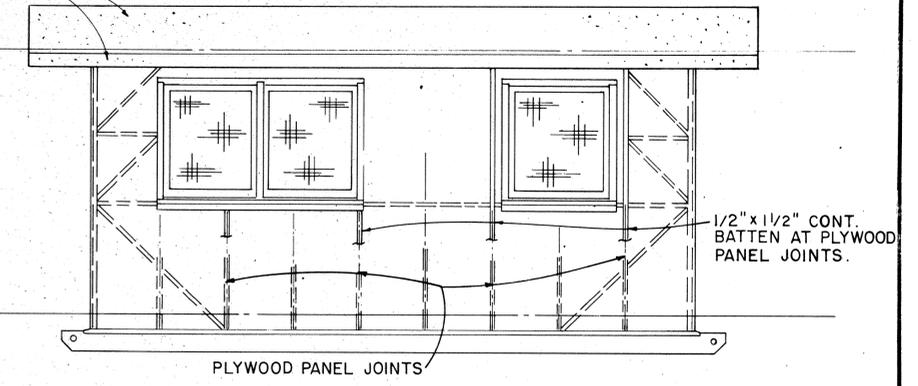


**ELEVATION (C)**

SCALE: 3/8" = 1'-0"

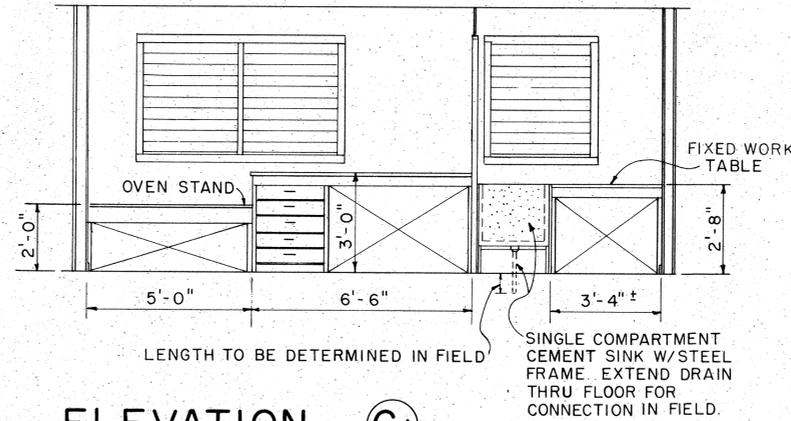

**ELEVATION (CI)**

SCALE: 3/8" = 1'-0"

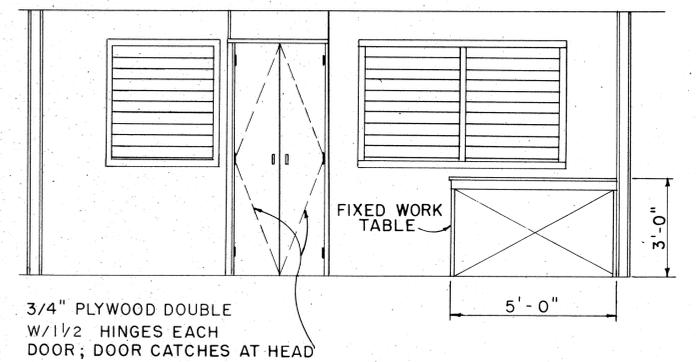

**ELEVATION (AI)**

SCALE: 3/8" = 1'-0"

APPROVAL RECOMMENDED:  
  
 HIGHWAY DESIGN ENGINEER 12-4-69  
 DATE

APPROVED:  
  
 ASSISTANT CHIEF, ENGINEERING 12-10-69  
 DATE

| NO. | REVISION | APPROVED BY | DATE |
|-----|----------|-------------|------|
|     |          |             |      |

STATE OF HAWAII  
 DEPARTMENT OF TRANSPORTATION  
 HIGHWAYS DIVISION


**PROJECT SITE LABORATORY**

Scale: As Noted

SHEET No. 4 OF 5 SHEETS DD 636.4

|               |                   |      |
|---------------|-------------------|------|
| ORIGINAL PLAN | SURVEY PLOTTED BY | DATE |
| NOTE BOOK     | DESIGNED BY       |      |
|               | QUANTITIES BY     |      |
|               | CHECKED BY        |      |


| STATE  | PROJ. NO.  | FISCAL YEAR | SHEET NO. | TOTAL SHEETS |
|--------|------------|-------------|-----------|--------------|
| HAWAII | 19BC-01-71 | 1973        | 30        | 51           |

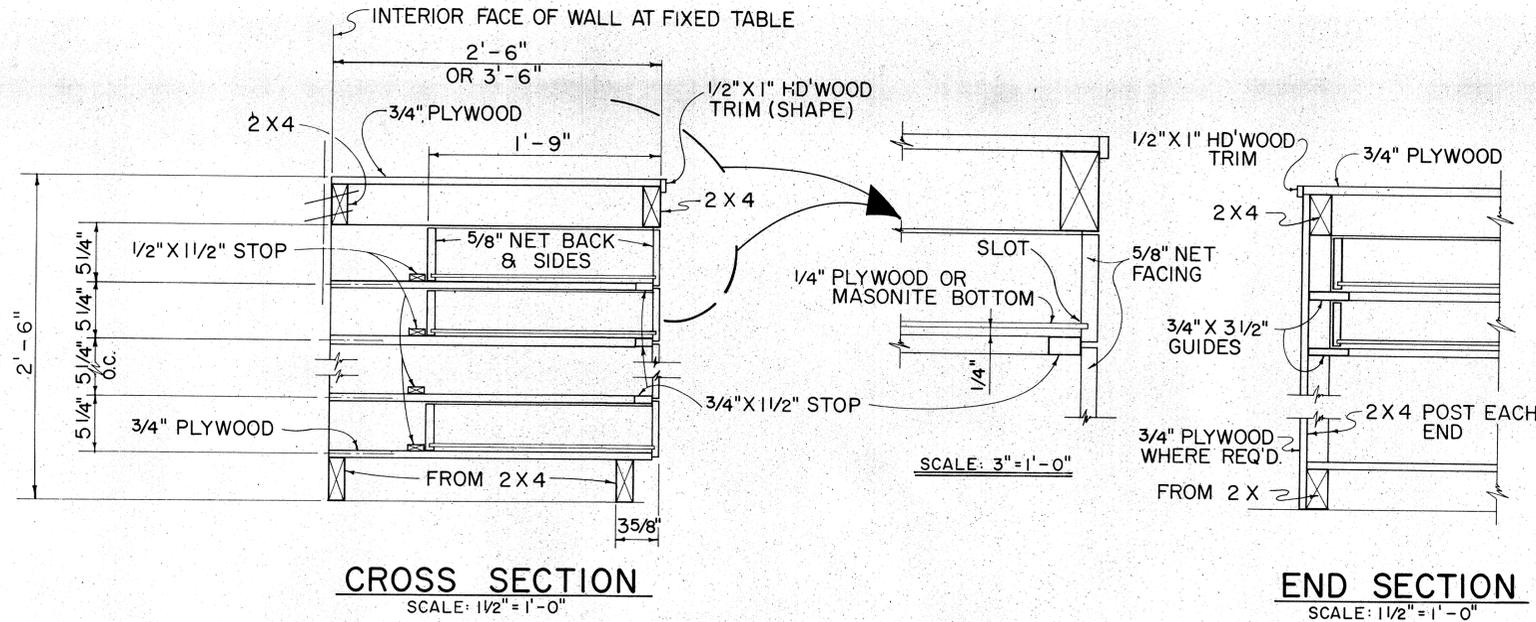

**CROSS SECTION**  
SCALE: 3"=1'-0"


**END SECTION**  
SCALE: 1 1/2"=1'-0"

**TYPICAL WORK TABLE DRAWER DETAIL**

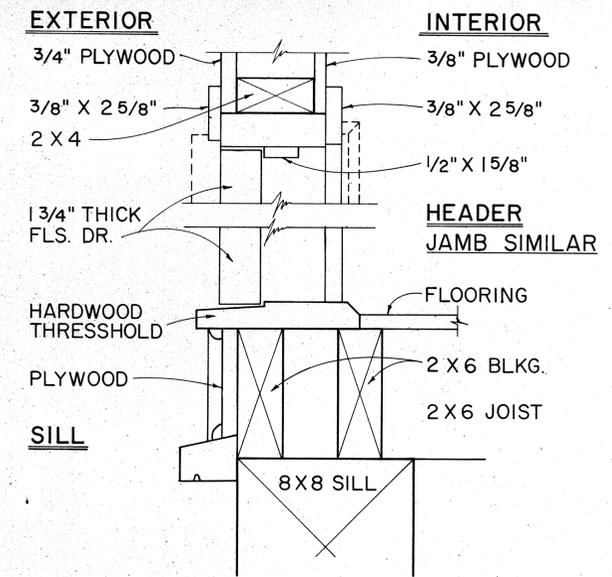


**TYP. SWING OUT DOOR**

**TYPICAL SINGLE OR DOUBLE EXTERIOR DOOR DETAIL**

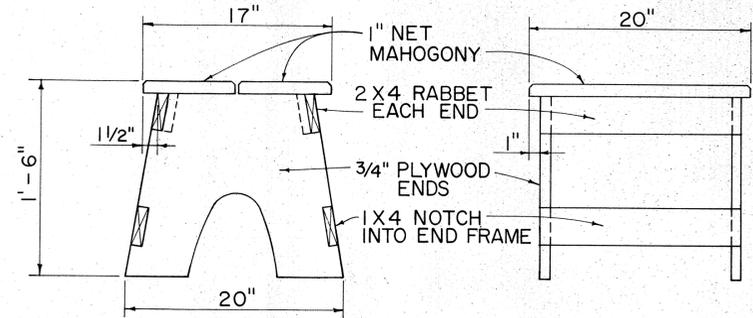

**TYPICAL STOOL DETAIL**  
SCALE: 1 1/2"=1'-0"


NOTE: CONTRACTOR MAY WITH THE APPROVAL OF THE ENGINEER FURNISH THE FIELD OFFICE OR PROJECT SITE LABORATORY WITH STOOLS OTHER THAN THE TYPE SHOWN IN THE DETAIL.

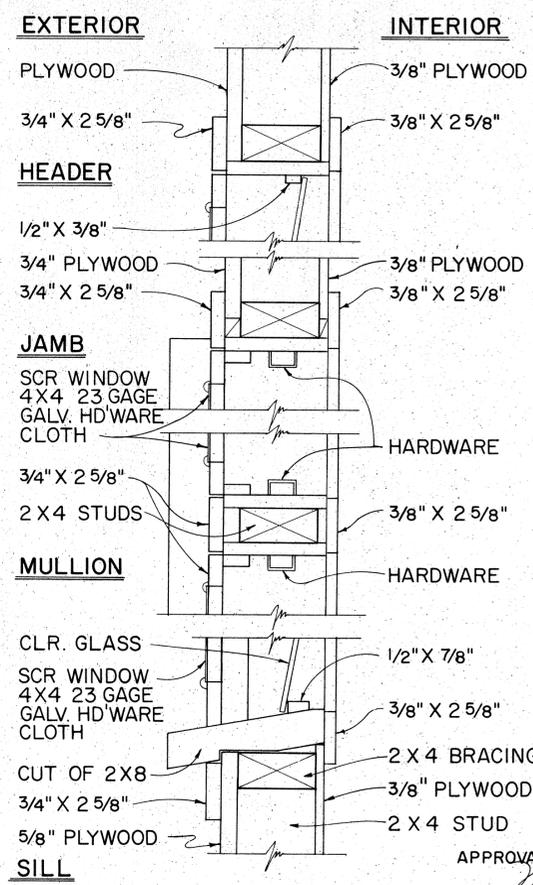

**TYPICAL DETAIL JALOUSIES WINDOWS**  
SCALE: 3"=1'-0"

APPROVAL RECOMMENDED:  
*M. Hirozawa*  
HIGHWAY DESIGN ENGINEER 12-4-69 DATE

APPROVED:  
*John S. Saha*  
ASSISTANT CHIEF, ENGINEERING 12-10-69 DATE

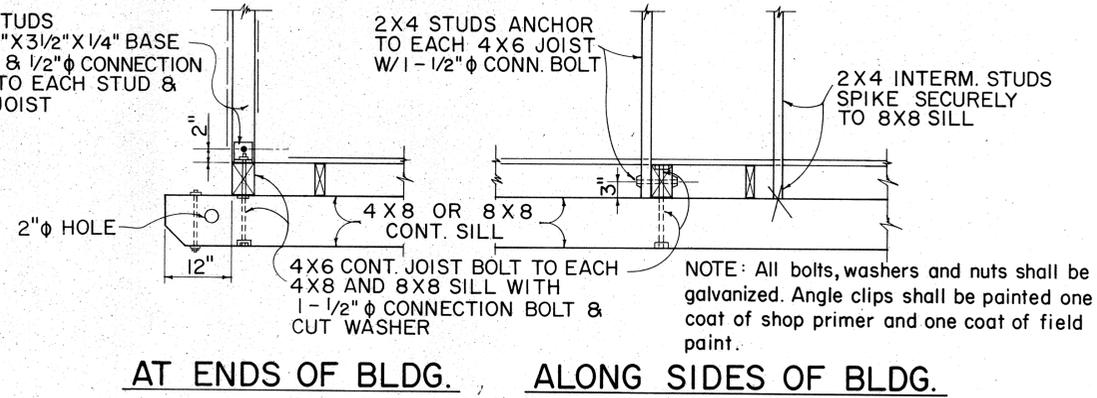

**TYPICAL 2 X 4 STUD & 4 X 6 FLOOR JOIST BASE CONNECTION DETAILS**

| NO. | REVISION | APPROVED BY | DATE |
|-----|----------|-------------|------|
|     |          |             |      |




STATE OF HAWAII  
DEPARTMENT OF TRANSPORTATION  
HIGHWAYS DIVISION

FIELD OFFICE  
&  
PROJECT SITE LABORATORY





Scale: As Noted

DATE: \_\_\_\_\_  
DRAWN BY: \_\_\_\_\_  
DESIGNED BY: \_\_\_\_\_  
QUANTITIES BY: \_\_\_\_\_  
CHECKED BY: \_\_\_\_\_  
ORIGINAL PLAN: \_\_\_\_\_  
NOTE BOOK: \_\_\_\_\_  
No. \_\_\_\_\_


| STATE | PROJ. NO. | FISCAL YEAR | SHEET NO. | TOTAL SHEETS |
|-------|-----------|-------------|-----------|--------------|
| HAW.  | 193C-0171 | 1973        | 31        | 51           |

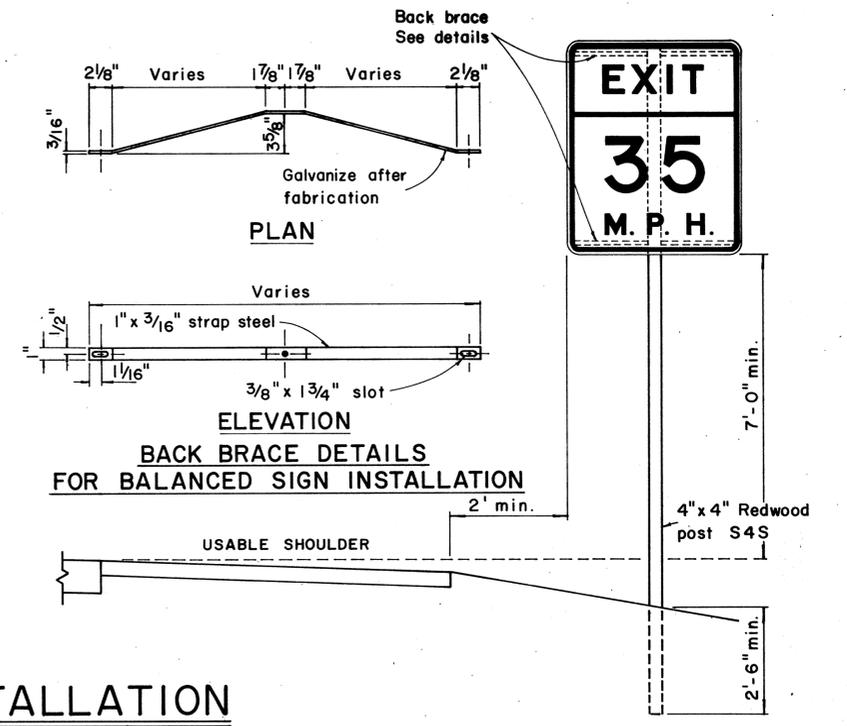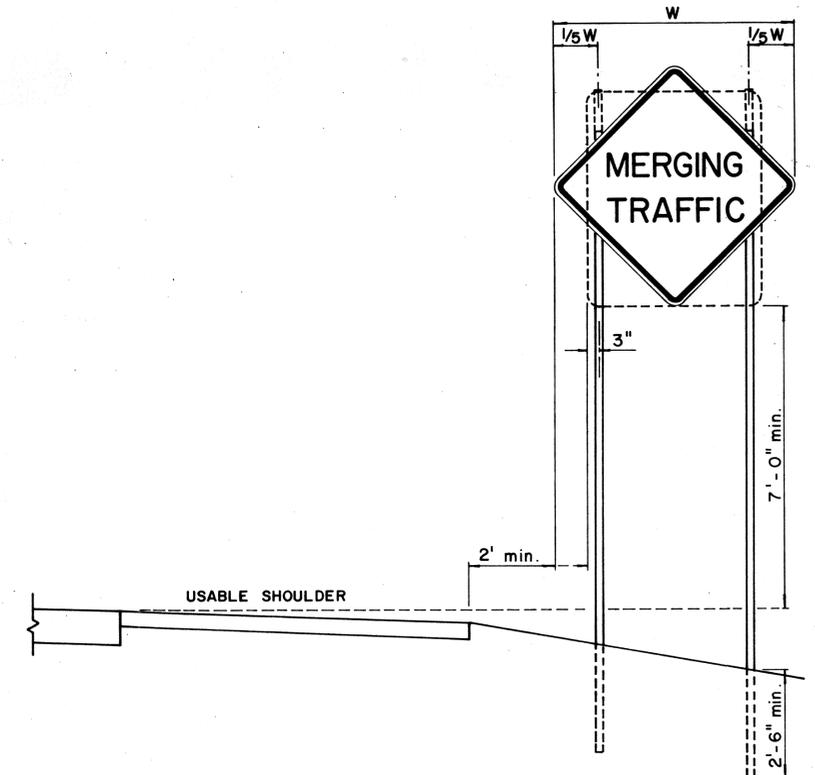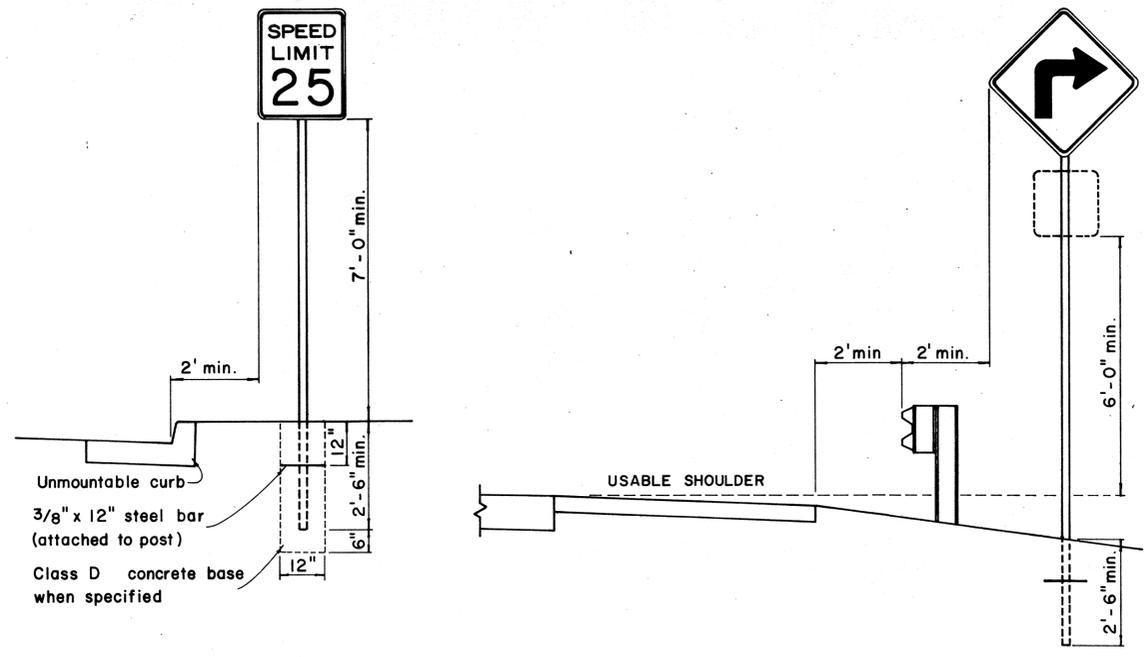

## HEIGHT AND LATERAL LOCATION OF SIGNS - TYPICAL INSTALLATION

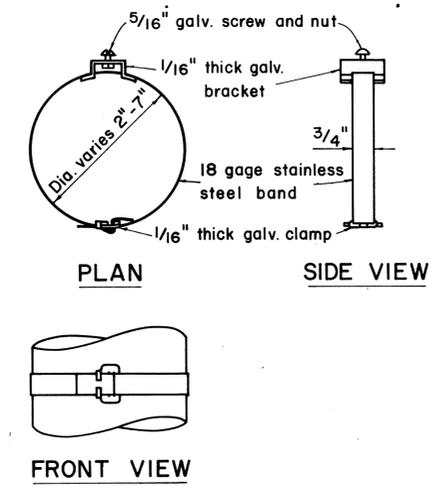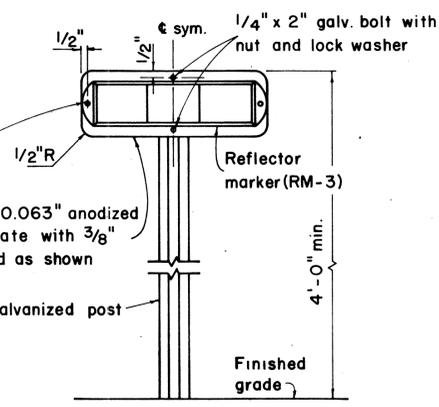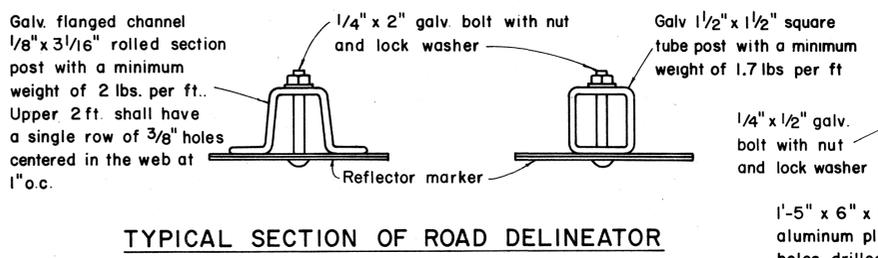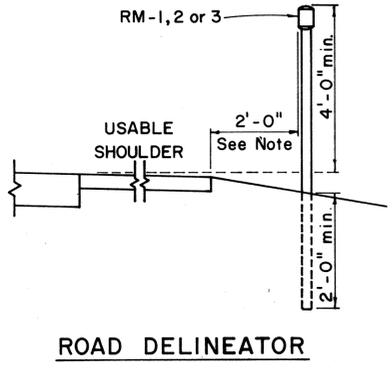

- GENERAL NOTES:**
- Sign posts shall be 2" galv. standard pipe or 2" x 2" galv. sq. tube post.
  - Signs 48" and wider or larger than 10 sq. ft. in area shall be mounted on two 2" galv. standard pipe or two 2" x 2" galv. sq. tube post or 4" x 4" redwood post S4S.
  - Signs shall be attached to post with 5/16" galv. bolts with nuts and 7/8" x 0.06 stainless steel washers with neoprene rubber gasket.
  - Sign posts shall extend 3 1/2" above sign where required for City and County street name signs.
  - Reflector markers RM-1, 2, 3 shall be glass sphere reflector markers with 4" x 5" reflector units (as shown) or plastic prismatic reflector markers with 3" diameter reflector units.
  - Clearance markers (RM-3, RM-4) shall be installed with the edge of the marker in line with the inner edge of the obstruction.
  - (R) or (L) indicates right or left and shall be as shown on the plans.

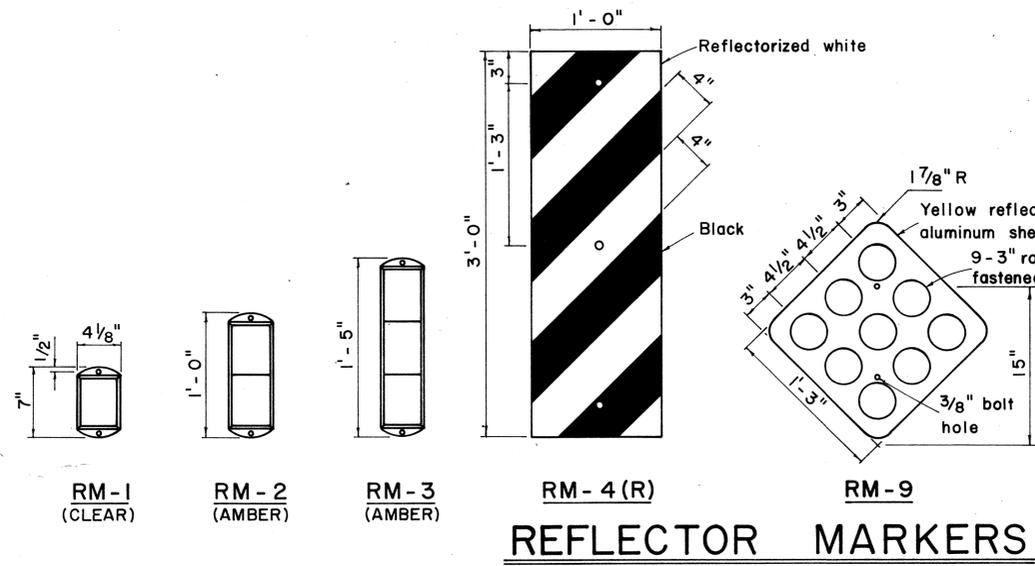

## TYPICAL BAND BRACKET FOR MOUNTING TRAFFIC SIGNS

| NO. | REVISION | APPROVED BY | DATE |
|-----|----------|-------------|------|
|     |          |             |      |

APPROVAL RECOMMENDED:  
*Etschi Tanaka* 12/22/69  
 TRAFFIC ENGINEER DATE

APPROVED:  
*[Signature]* 12-20-69  
 ASSISTANT CHIEF, ENGINEERING DATE

STATE OF HAWAII  
 DEPARTMENT OF TRANSPORTATION  
 HIGHWAYS DIVISION

**STANDARD DETAILS**  
 MISCELLANEOUS SIGN DETAILS

Not to scale March, 1968

SHEET No. 1 OF 19 SHEETS DT 100

SURVEY LOCATED BY  
 DRAWN BY  
 CHECKED BY  
 QUANTITIES BY  
 NOTE BOOK  
 CHECKED BY  
 No.

| STATE | PROJ. NO. | FISCAL YEAR | SHEET NO. | TOTAL SHEETS |
|-------|-----------|-------------|-----------|--------------|
| HAW.  | 19BC-0171 | 1973        | 32        | 51           |



R1-1 30"x30"  
R1-1-A 36"x36"  
R1-3 12"x6"  
R1-3-A 18"x9"



R1-2 36"x36"x36"  
R1-2-A 48"x48"x48"



R2-1(50) 24"x30"  
R2-1(50)-A 48"x60"



R2-2(40) 24"x24"  
R2-2(40)-A 48"x48"



R2-4a(50/40) 24"x48"  
R2-4a(50/40)-A 48"x96"



R2-5b(30) 24"x30"  
R2-5b(30)-A 48"x60"



R3-1 24"x24"  
24"x18"  
48"x48"  
48"x36"



R3-2 24"x24"  
24"x18"  
48"x48"  
48"x36"



R3-3 24"x24"  
R3-3-A 48"x48"



R3-4 24"x24"  
24"x18"  
48"x48"  
48"x36"



R3-5(L) 30"x36"  
R3-5(L)-A 48"x60"



R3-6(L) 30"x36"  
R3-6(L)-A 48"x60"



R3-7(R) 30"x30"  
R3-7(R)-A 48"x48"



R3-8(L) 30"x30"  
R3-8(L)-A 36"x36"  
R3-8(L)-B 48"x48"



R3-9 24"x30"



R4-1 24"x30"



R4-2 24"x30"



R4-3 24"x30"  
R4-3-A 48"x60"



R4-5 24"x30"



R4-6(500) 24"x30"



R4-7 24"x30"  
24"x18"



R4-8 24"x30"  
24"x18"



R5-1 30"x30"  
R5-1-A 48"x48"



R5-2 24"x24"  
24"x18"



R5-4 24"x30"



R5-6 24"x24"  
24"x18"



R5-9 36"x24"



R6-1 (R) 36"x12"



R6-2(R) 18"x24"



R7-1 12"x18"  
R7-1-A 24"x30"



R7-4 12"x18"  
R7-4-A 24"x30"



R7-107(R) 12"x18"



R7-108 12"x18"



R7-201 12"x6"  
R7-201-A 24"x12"



R8-1 24"x30"



R8-2 24"x30"



R8-3 24"x30"



R8-4 30"x24"  
R8-4-A 48"x36"



R8-5 24"x30"



R8-6 24"x30"



R8-7 30"x24"  
R8-7-A 48"x36"



R9-1 18"x24"



R9-2 12"x18"



R9-3 12"x18"



R9-4 18"x24"



R10-1 12"x18"



R10-2 12"x18"



R10-3 9"x12"



R10-4 9"x12"



R10-5 24"x30"



R10-6 24"x36"



R10-7 24"x30"



R10-8 24"x30"



R10-9 24"x30"




R10-10 24"x30"



R11-1 24"x30"



R11-2 48"x30"

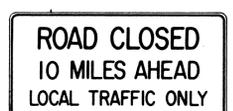

R11-3(10) 60"x30"



R11-4 60"x30"



R12-1(10) 24"x30"

**GENERAL NOTES**

- Sign details shall conform to the FHWA publications "Manual on Uniform Traffic Control Devices for Streets and Highways," 1971, and "Standard Highway Signs."
- All regulatory signs shall be reflectorized unless otherwise specified.
- All regulatory signs shall have 3/8" bolt holes drilled at appropriate locations.
- Numerals in ( ) indicates numerals to be inserted for sign message. (R) or (L) indicates right or left.

APPROVAL RECOMMENDED:  
*Eishi Tanaka* 3/17/72  
TRAFFIC ENGINEER DATE

APPROVED:  
*Robert D. ...* 3-20-72  
ASSISTANT CHIEF, ENGINEERING DATE

| NO. | REVISION                                 | APPROVED BY | DATE    |
|-----|--|-------------|---------|
| 1   | Supersedes Sht. DT 101 Approved 12-30-69 | H.C.        | 3/20/72 |






STATE OF HAWAII  
DEPARTMENT OF TRANSPORTATION  
HIGHWAYS DIVISION




**STANDARD DETAILS**  
**REGULATORY SIGNS**




NOT TO SCALE

SURVEY PLOTTED BY: \_\_\_\_\_  
 DATE: \_\_\_\_\_  
 DRAWN BY: \_\_\_\_\_  
 DESIGNED BY: \_\_\_\_\_  
 NOTE BOOK: \_\_\_\_\_  
 CHECKED BY: \_\_\_\_\_  
 ORIGINAL PLAN: \_\_\_\_\_  
 NO. \_\_\_\_\_

| STATE | PROJ. NO. | FISCAL YEAR | SHEET NO. | TOTAL SHEETS |
|-------|-----------|-------------|-----------|--------------|
| HAW.  | 193C-0171 | 1973        | 33        | 51           |
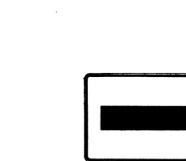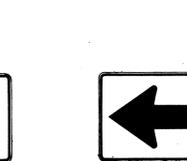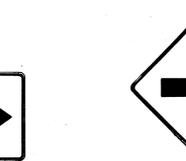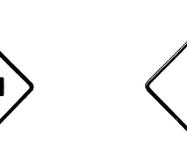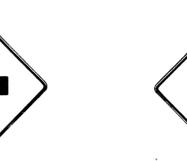
|   |   |   |   |   |   |   |   |   |   |
|---|---|---|---|---|---|---|---|---|---|
| <br>W1-1(R) 30"x30"<br>W1-1(R)-A 48"x48" | <br>W1-2(R) 30"x30"<br>W1-2(R)-A 48"x48" | <br>W1-3(R) 30"x30"<br>W1-3(R)-A 48"x48" | <br>W1-4(R) 30"x30"<br>W1-4(R)-A 48"x48" | <br>W1-5(R) 30"x30"<br>W1-5(R)-A 48"x48" | <br>W1-6 48"x24" | <br>W1-7 48"x24" | <br>W2-1 30"x30"<br>W2-1-A 48"x48" | <br>W2-2 30"x30"<br>W2-2-A 48"x48" | <br>W2-3(R) 30"x30"<br>W2-3(R)-A 48"x48" |
|---|---|---|---|---|---|---|---|---|---|
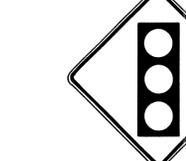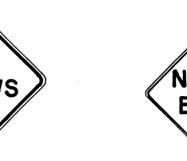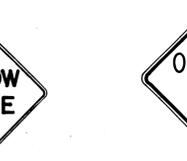
|   |   |   |   |  |  |   |   |  |  |
|---|---|---|---|--|--|---|---|--|--|
| <br>W2-4 30"x30"<br>W2-4-A 48"x48" | <br>W2-5 30"x30"<br>W2-5-A 48"x48" | <br>W3-1 30"x30"<br>W3-1-A 36"x36" | <br>W3-2 30"x30"<br>W3-2-A 36"x36" | <br>SIGNAL AHEAD<br>W3-3 36"x36"<br>24"x18" | <br>MERGE<br>W4-1(R) 30"x30"<br>24"x18"<br>W4-1(R)-A 48"x48"<br>24"x18" | <br>W4-2(R) 36"x36"<br>W4-2(R)-A 48"x48" | <br>ROAD NARROWS<br>W5-1 36"x36" | <br>NARROW BRIDGE<br>W5-2 30"x30"<br>W5-2-A 36"x36" | <br>ONE LANE BRIDGE<br>W5-3 36"x36" |
|---|---|---|---|--|--|---|---|--|--|
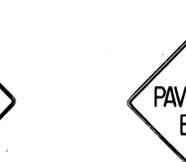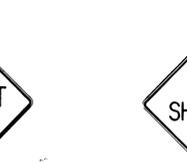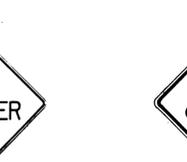
|  |   |  |  |  |  |   |   |   |   |
|--|---|--|--|--|--|---|---|---|---|
| <br>DIVIDED HIGHWAY<br>W6-1 36"x36"<br>24"x18" | <br>DIVIDED HIGHWAY ENDS<br>W6-2 36"x36"<br>24"x18" | <br>TWO WAY TRAFFIC<br>W6-3 30"x30"<br>24"x18"<br>W6-3-A 36"x36"<br>24"x18"<br>W6-3-B 48"x48"<br>24"x18" | <br>HILL<br>W7-1 30"x30"<br>24"x18"<br>W7-1-A 36"x36"<br>24"x18" | <br>USE LOW GEAR<br>W7-2 24"x18" | <br>BUMP<br>W8-1 30"x30"<br>W8-1-A 36"x36" | <br>DIP<br>W8-2 30"x30"<br>W8-2-A 36"x36" | <br>PAVEMENT ENDS<br>W8-3 30"x30"<br>W8-3-A 36"x36" | <br>SOFT SHOULDER<br>W8-4 30"x30"<br>W8-4-A 36"x36" | <br>SLIPPERY WHEN WET<br>W8-5 30"x30"<br>24"x18"<br>W8-5-A 36"x36"<br>24"x18" |
|--|---|--|--|--|--|---|---|---|---|

|   |   |   |  |   |  |   |
|---|---|---|--|---|--|---|
| <br>RIGHT LANE ENDS<br>W9-1(R) 30"x30"<br>W9-1(R)-A 36"x36"<br>W9-1(R)-B 48"x48" | <br>LANE ENDS MERGE LEFT<br>W9-2(L) 36"x36"<br>W9-2(L)-A 48"x48" | <br>W10-1 36" Diameter | <br>BIKE XING<br>W11-1 30"x30"<br>24"x18"<br>W11-1-A 36"x36"<br>24"x18" | <br>PED XING<br>W11-2 30"x30"<br>24"x18"<br>W11-2-A 36"x36"<br>24"x18" | <br>CATTLE XING<br>W11-4 30"x30"<br>24"x18"<br>W11-4-A 36"x36"<br>24"x18" | <br>FARM MACHINERY<br>W11-5 30"x30"<br>24"x18"<br>W11-5-A 36"x36"<br>24"x18" |
|---|---|---|--|---|--|---|

|   |  |  |  |  |  |   |
|---|--|--|--|--|--|---|
| <br>LOW CLEARANCE<br>W12-1 24"x24"<br>W12-1-A 36"x36"<br>W12-1-B 48"x48" | <br>12'-6"<br>LOW CLEARANCE<br>W12-2(12'-6") 36"x36"<br>24"x18" | <br>25 M.P.H.<br>W13-1(25) 18"x18"<br>W13-1(25)-A 24"x24" | <br>EXIT 25 M.P.H.<br>W13-2(25) 48"x60" | <br>RAMP 25 M.P.H.<br>W13-3(25) 48"x60" | <br>DEAD END<br>W14-1 30"x30" | <br>NO PASSING ZONE<br>W14-3 36"x48"x48" |
|---|--|--|--|--|--|---|

**GENERAL NOTES**

- Sign details shall conform to the FHWA publications "Manual on Uniform Traffic Control Devices for Streets and Highways," 1971, and "Standard Highway Signs."
- All warning signs shall be reflectorized unless otherwise specified.
- All warning signs shall have 3/8" bolt holes drilled at appropriate locations.
- Numerals in ( ) indicates numerals to be inserted for sign message. (R) or (L) indicates right or left.
- Signs prefixed with "CW" on the plans shall indicate orange and black construction signs.

APPROVAL RECOMMENDED:  
*Eishi Tanaka* 3/17/72  
TRAFFIC ENGINEER DATE

APPROVED:  
*Walter Belsin* 3-20-72  
ASSISTANT CHIEF, ENGINEERING DATE

| NO. | REVISION                                 | APPROVED BY | DATE    |
|-----|--|-------------|---------|
| 1   | Supersedes Sht. DT 102 Approved 12-30-69 | H.T.        | 3/20/72 |

STATE OF HAWAII  
DEPARTMENT OF TRANSPORTATION  
HIGHWAYS DIVISION

**STANDARD DETAILS**  
**WARNING SIGNS**

NOT TO SCALE

DATE \_\_\_\_\_  
SURVEY PLOTTED BY \_\_\_\_\_  
DRAWN BY \_\_\_\_\_  
DESIGNED BY \_\_\_\_\_  
QUANTITIES BY \_\_\_\_\_  
CHECKED BY \_\_\_\_\_  
ORIGINAL PLAN \_\_\_\_\_  
NOTE BOOK \_\_\_\_\_  
No. \_\_\_\_\_

| STATE | PROJ. NO.  | FISCAL YEAR | SHEET NO. | TOTAL SHEETS |
|-------|------------|-------------|-----------|--------------|
| HAW.  | 198C-01-71 | 1973        | 34        | 51           |



R16-1 24" x 30"



R16-2 24" x 30"



R16-3 18" x 24"




R16-4 18" x 24"



R16-5 36" x 42"



R16-6 24" x 30"

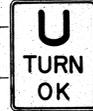

R16-7 24" x 30"



R16-8 24" x 30"



W15-1 24" x 24"



W15-2 24" x 24"



S1-1 36" x 36"



S2-1 36" x 36"



S3-1 30" x 30"



S4-1 24" x 10"



S4-2 24" x 10"



S4-3 24" x 8"



S4-4 24" x 10"

**GENERAL NOTES**

1. Sign details shall conform to the FHWA publications "Manual on Uniform Traffic Control Devices for Streets and Highways," 1971, and "Standard Highway Signs."
2. All regulatory and warning signs shall be reflectorized unless otherwise specified.
3. All regulatory and warning signs shall have 3/8" bolt holes drilled at appropriate locations.
4. Numerals in ( ) indicates numerals to be inserted for sign message. (R) or (L) indicates right or left.

APPROVAL RECOMMENDED:  
*Eishi Tanaka*  
 TRAFFIC ENGINEER DATE 3/17/72

APPROVED:  
*Shigeru Zatside*  
 ASSISTANT CHIEF, ENGINEERING DATE 2-20-72

| NO. | REVISION                                 | APPROVED BY | DATE    |
|-----|--|-------------|---------|
| 1   | Supersedes Sht. DT 103 Approved 12-30-69 | N.T.        | 3/20/72 |

STATE OF HAWAII  
 DEPARTMENT OF TRANSPORTATION  
 HIGHWAYS DIVISION

**STANDARD DETAILS  
 MISCELLANEOUS  
 REGULATORY & WARNING SIGNS**

NOT TO SCALE

SURVEY PLOTTED BY \_\_\_\_\_ DATE \_\_\_\_\_  
 DRAWN BY \_\_\_\_\_  
 DESIGNED BY \_\_\_\_\_  
 QUANTITIES BY \_\_\_\_\_  
 CHECKED BY \_\_\_\_\_  
 ORIGINAL PLAN No. \_\_\_\_\_  
 NOTE BOOK No. \_\_\_\_\_

| STATE | PROJ. NO.  | FISCAL YEAR | SHEET NO. | TOTAL SHEETS |
|-------|------------|-------------|-----------|--------------|
| HAW.  | 198C-01-71 | 1973        | 35        | 51           |



CW20-1a 48" x 48"



CW20-2d 48" x 48"



CW20-3b 48" x 48"



CW20-4d 48" x 48"



CW20-5d(L) 48" x 48"



CW20-7c 48" x 48"



CW21-1 30" x 30"



CW21-2 30" x 30"



CW21-3 36" x 36"



CW21-4 36" x 36"



CW21-5 30" x 30"



CW21-6 30" x 30"



CW22-1b 48" x 48"



CW22-2 42" x 36"



CW22-3 42" x 36"



CG 20-1(5) 60" x 36"



CG 20-2 60" x 24"



CM4-9(R) 30" x 24"




CM4-10(R) 48" x 18"



CG20-4 36" x 18"



CW23-1 36" x 36"

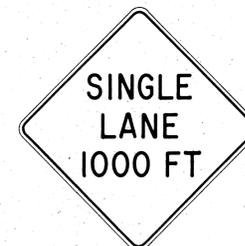

CW23-2b 48" x 48"



CW23-3(R) 48" x 48"

**GENERAL NOTES**

1. Sign details shall conform to the FHWA publications "Manual on Uniform Traffic Control Devices for Streets and Highways," 1971, and "Standard Highway Signs."
2. All construction signs shall be reflectorized unless otherwise specified.
3. All construction signs shall have 3/8" bolt holes drilled at appropriate locations.
4. Numerals in ( ) indicates numerals to be inserted for sign message. (R) or (L) indicates right or left.
5. For "CW" series signs, suffixes a,b,c and d are as follows:  
a-1500 FT, b-1000 FT, c-500 FT and d-AHEAD.

APPROVAL RECOMMENDED:  
*Eiichi Tanaka* 3/21/72  
TRAFFIC ENGINEER DATE

APPROVED:  
*Shun Sakai* 3/23/72  
ASSISTANT CHIEF, ENGINEERING DATE

| NO. | REVISION                                 | APPROVED BY | DATE    |
|-----|--|-------------|---------|
| 1   | Supersedes Sht. DT 104 Approved 12-30-69 | HT          | 3/23/72 |


STATE OF HAWAII  
DEPARTMENT OF TRANSPORTATION  
HIGHWAYS DIVISION

**STANDARD DETAILS**  
**CONSTRUCTION SIGNS**

NOT TO SCALE

|               |      |
|---------------|------|
| DESIGNED BY   | DATE |
| PLANNED BY    |      |
| CHECKED BY    |      |
| QUANTITIES BY |      |
| ORDERED BY    |      |
| ORIGINAL PLAN |      |
| NOTE BOOK     |      |
| No.           |      |


|       |            |             |           |              |
|-------|------------|-------------|-----------|--------------|
| STATE | PROJ. NO.  | FISCAL YEAR | SHEET NO. | TOTAL SHEETS |
| HAW.  | 19BC-01-71 | 1973        | 36        | 51           |

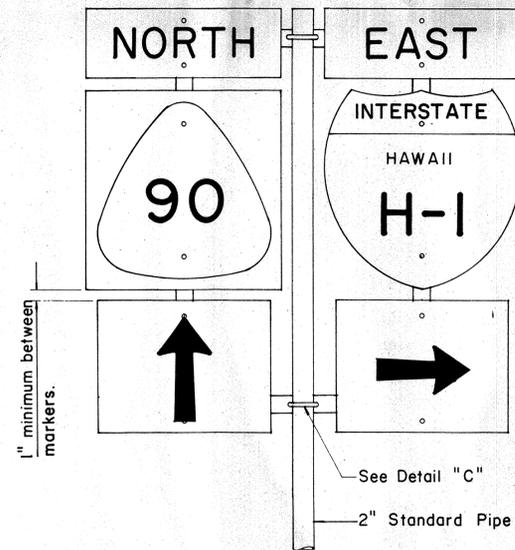

FRONT ELEVATION

**TYPE "B" ASSEMBLY**


Not to Scale

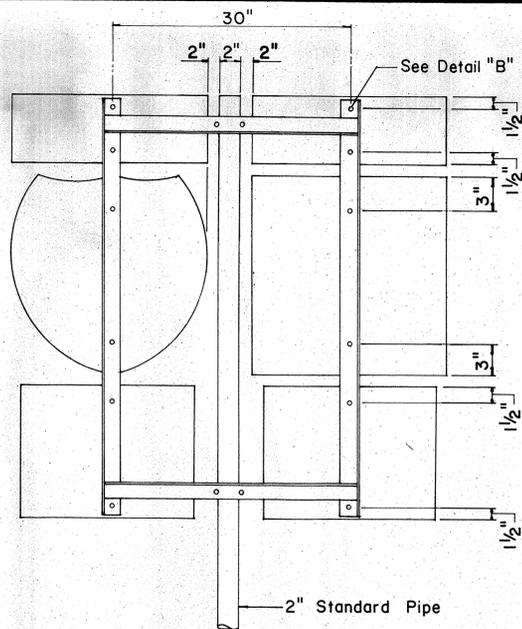


REAR ELEVATION

**NOTE:**

1. Minimum clearance between markers shall be one inch. (Larger clearances shall be in multiples of one inch.)
2. Pipe post for Type "A" & Type "B" Assembly shall be 2" Standard Pipe.

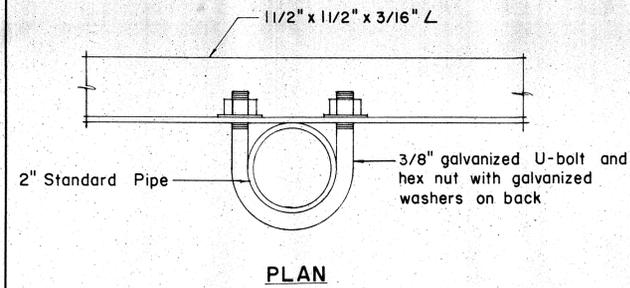


PLAN

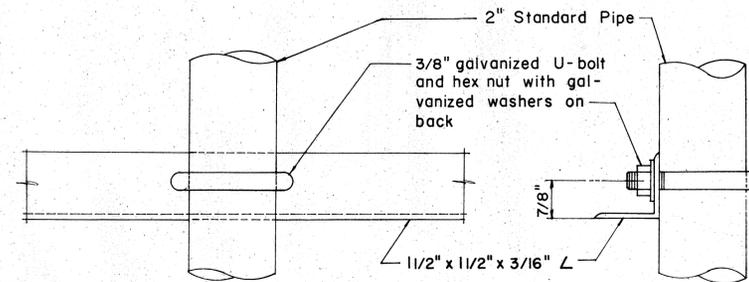

FRONT ELEVATION

SIDE ELEVATION


**DETAIL "C"**

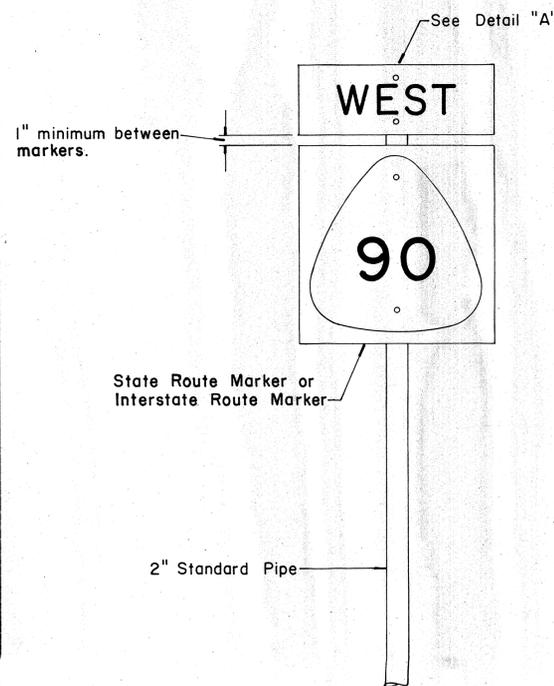

FRONT ELEVATION

**TYPE "A" ASSEMBLY**


Not to Scale

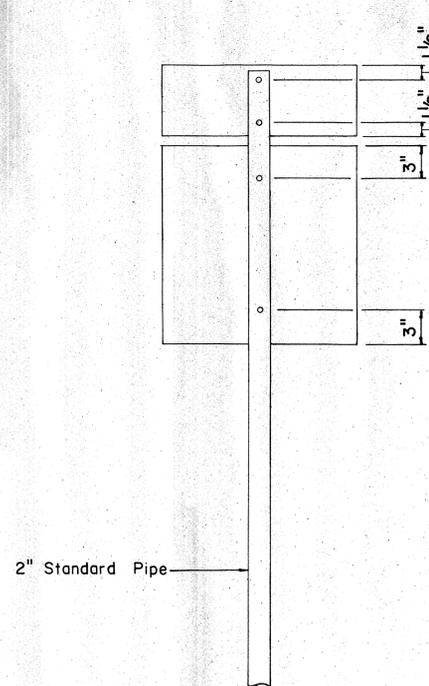


REAR ELEVATION

**NOTE:**

For height and lateral location of Route Marker Assembly, see plan sheet DT 100.

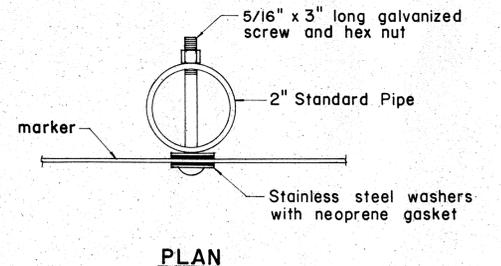


PLAN

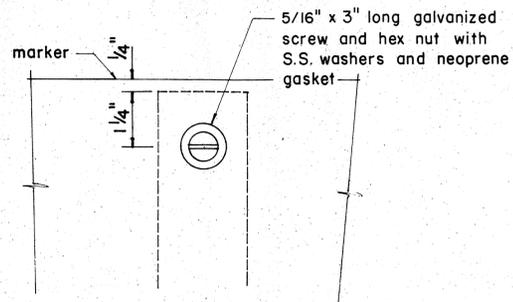


FRONT ELEVATION

**DETAIL "A"**

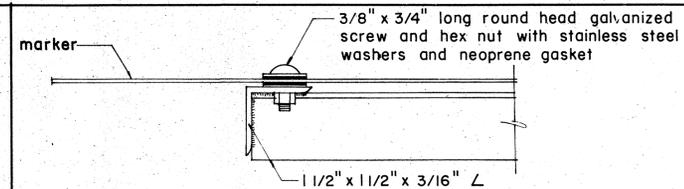


PLAN

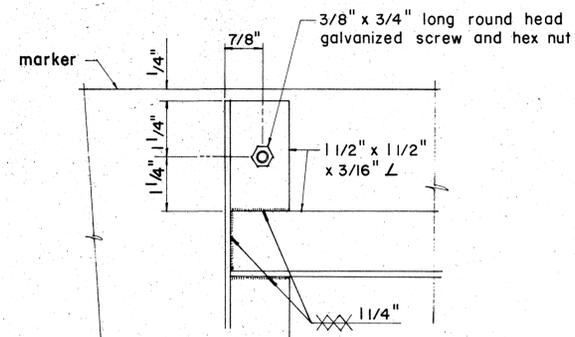

ELEVATION

**DETAIL "B"**

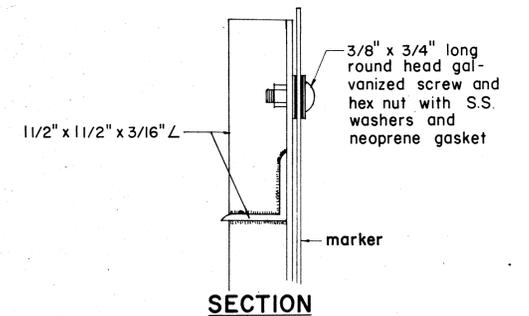

SECTION

APPROVAL RECOMMENDED:  
*E. J. Tanaka*  
 TRAFFIC ENGINEER 12/29/69 DATE

APPROVED:  
*W. J. Sakai*  
 ASSISTANT CHIEF, ENGINEERING 12-30-69 DATE

| NO. | REVISION                              | APPROVED BY | DATE   |
|-----|---------------------------------------|-------------|--------|
| 1   | Revisions to Route Marker Assemblies. | H.T.        | 6/1/72 |

STATE OF HAWAII  
 DEPARTMENT OF TRANSPORTATION  
 HIGHWAYS DIVISION

**STANDARD DETAILS**  
**ROUTE MARKER ASSEMBLIES**


Scale: As Shown

SHEET No. 6 OF 19 SHEETS DT 107

|                   |       |
|-------------------|-------|
| DATE              | ..... |
| SURVEY PLOTTED BY | ..... |
| ORIGINAL PLAN     | ..... |
| DRAWN BY          | ..... |
| DESIGNED BY       | ..... |
| QUANTITIES BY     | ..... |
| NOTE BOOK         | ..... |
| CHECKED BY        | ..... |
| No.               | ..... |


\* For moment calculations only. Post shall be from top of foundation to top of sign.  
 \*\* For fills with side slopes flatter than 4:1, Minimum Footing Depth shall be 4 1/2 feet.

| DATA TABLE FOR TYPE VI FOOTING |                   |   |            |        |     |         |        |    |        |         |        |     |        |                  |                       |        |        |
|--------------------------------|-------------------|---|------------|--------|-----|---------|--------|----|--------|---------|--------|-----|--------|------------------|-----------------------|--------|--------|
| POST SIZE                      | MAXIMUM SIGN AREA | POST HEIGHT TOP OF FOUNDATION TO CENTER OF SIGN * | DIMENSIONS |        |     |         |        |    |        |         |        |     |        | ANCHOR BOLT DIA. | MINIMUM FOOTING DEPTH |        |        |
|                                |                   |   | H          | J      | K   | M       | N      | O  | P      | S       | T      | U   | V      |                  | W                     | CUT    | FILL** |
| 8 J 10                         | 50 sq. ft.        | 14'   | 14"        | 5"     | 24" | 17 1/4" | 1 3/8" | 6" | 1 1/4" | 9"      | 6"     | 10" | 2"     | 1"               | 1 3/8" ø              | 4 1/2' | 4 1/2' |
| 8 WF 24                        | 90 sq. ft.        | 21'   |            |        |     |         |        |    |        |         |        |     |        |                  |                       |        | 5'     |
| 8 WF 35                        | 190 sq. ft.       | 15'   | 16 1/2"    | 6 3/4" | 30" | 20"     | 1 3/4" | 6" | 1 3/8" | 11 3/4" | 6 1/2" | 10" | 1 3/4" | 1"               | 1 1/4" ø              | 6'     | 7'     |
| 10 WF 45                       | 190 sq. ft.       | 25'   |            |        |     |         |        |    |        |         |        |     |        |                  |                       |        |        |
| 10 WF 45                       | 200 sq. ft.       | 25'   |            |        |     |         |        |    |        |         |        |     |        |                  |                       |        |        |
| 12 WF 50                       | 230 sq. ft.       | 25'   |            |        |     |         |        |    |        |         |        |     |        |                  |                       |        |        |
| 12 WF 50                       | 250 sq. ft.       | 23'   |            |        |     |         |        |    |        |         |        |     |        |                  |                       |        |        |

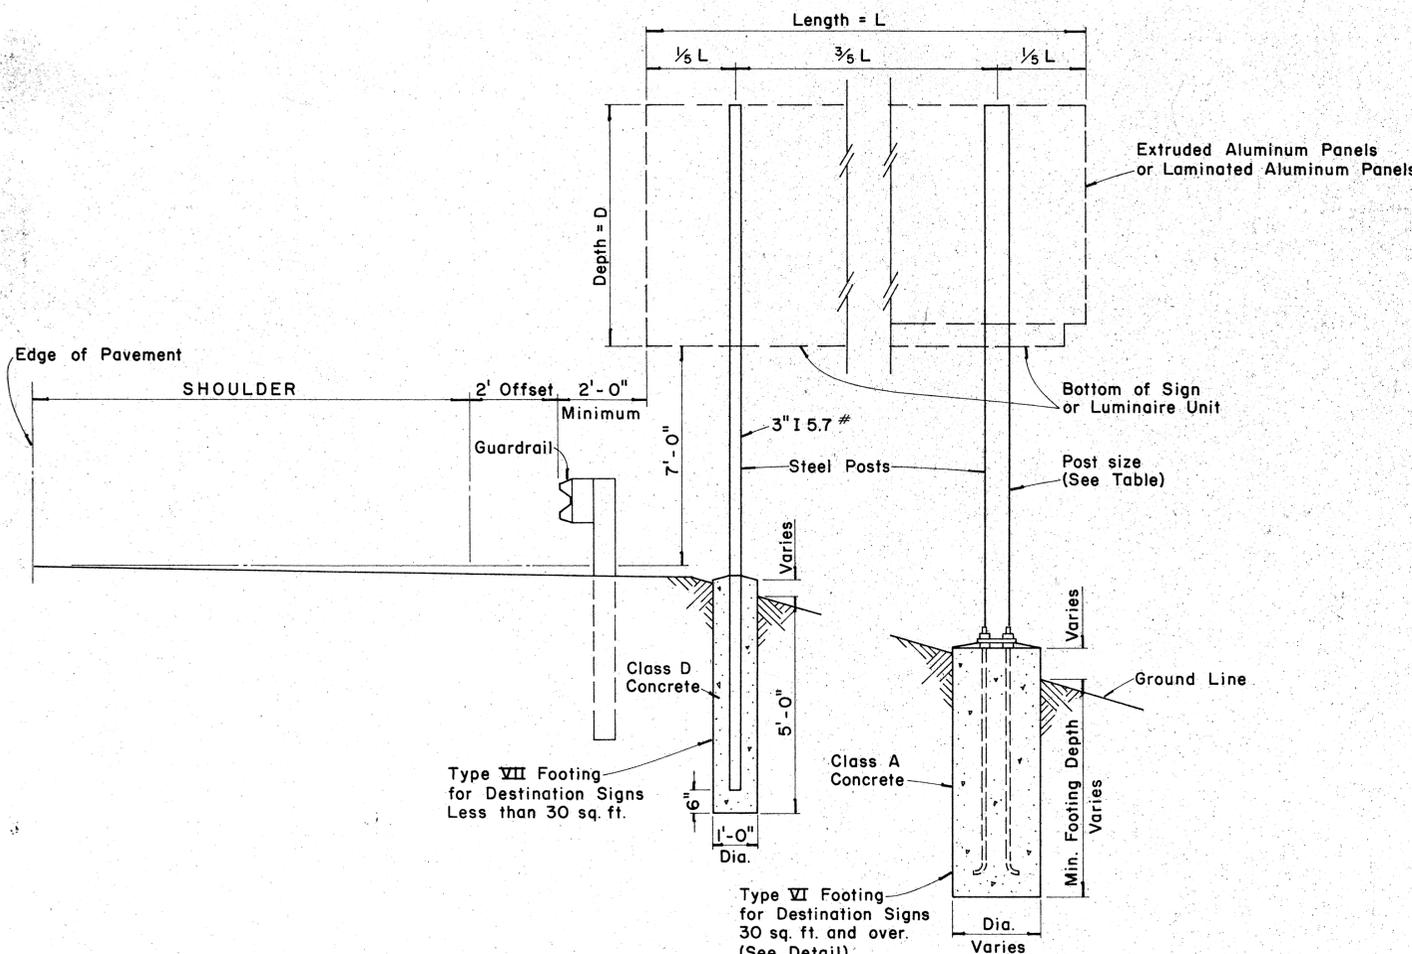


TYPICAL DESTINATION & GROUND MOUNTED EXPRESSWAY SIGN

Not to Scale

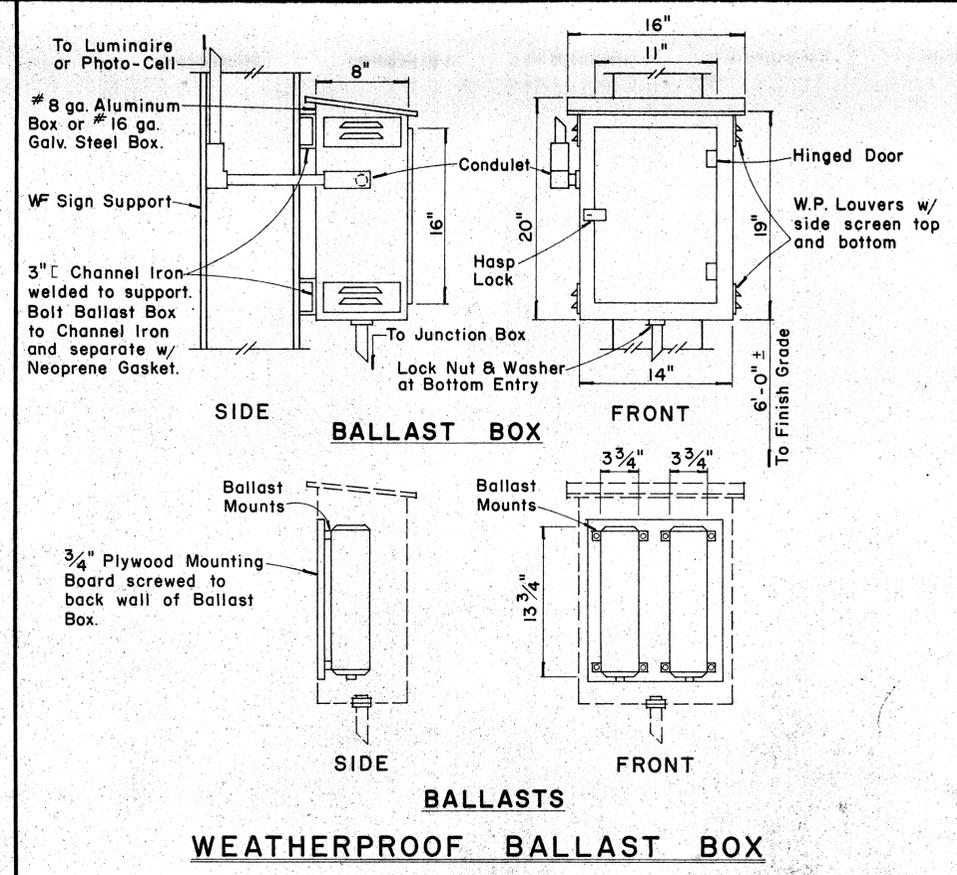

WEATHERPROOF BALLAST BOX

Scale: 1/2" = 1'-0"

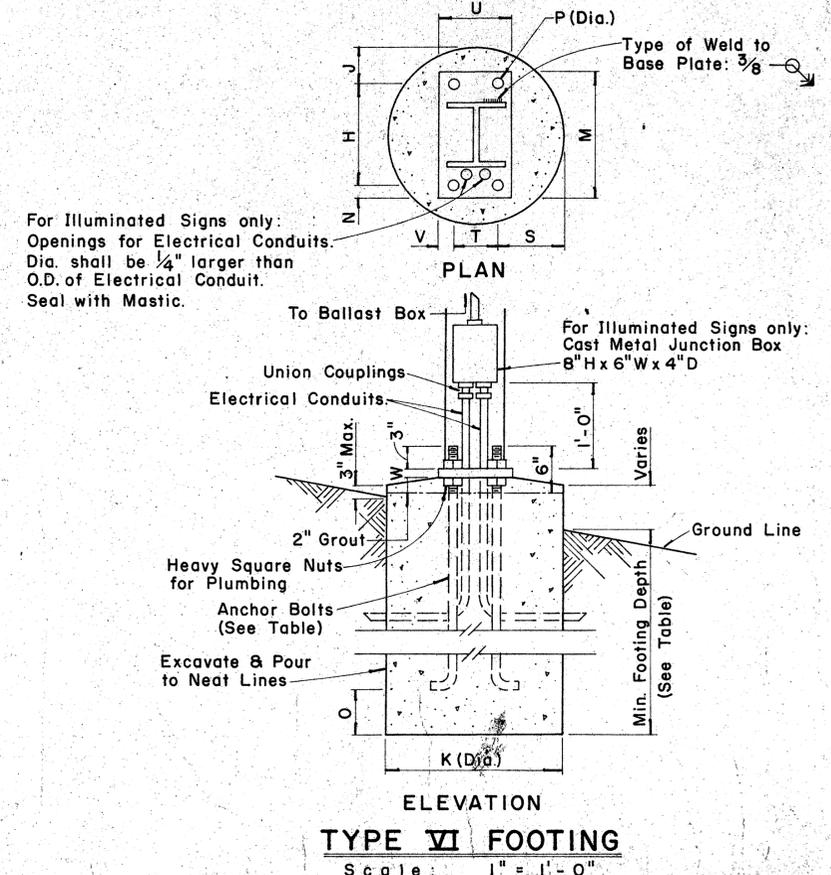

TYPE VI FOOTING

Scale: 1" = 1'-0"

| STATE | PROJ. NO.  | FISCAL YEAR | SHEET NO. | TOTAL SHEETS |
|-------|------------|-------------|-----------|--------------|
| HAW.  | 198C-01-71 | 1975        | 37        | 51           |

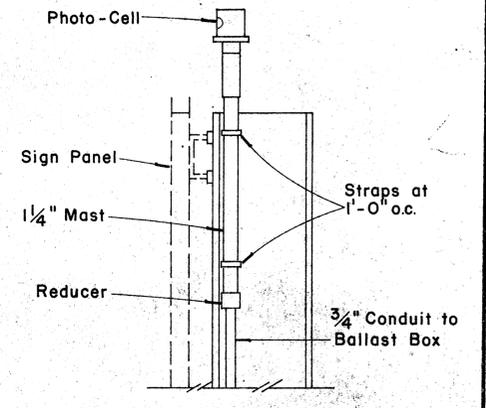


PHOTO-CELL DETAIL

Scale: 1/2" = 1'-0"

APPROVAL RECOMMENDED:  
*Euschi Tanaka* 12/29/69  
 TRAFFIC ENGINEER DATE

APPROVED:  
*John J. ...* 12-30-69  
 ASSISTANT CHIEF, ENGINEERING DATE

| NO. | REVISION | APPROVED BY | DATE |
|-----|----------|-------------|------|
|     |          |             |      |





STATE OF HAWAII  
 DEPARTMENT OF TRANSPORTATION  
 HIGHWAYS DIVISION  
 STANDARD DETAILS  
 DESTINATION & GROUND MOUNTED  
 EXPRESSWAY SIGNS

Scale: As Shown  
 SHEET No. 7 OF 19 SHEETS DT 203





DATE  
 SURVEY LOCATED BY  
 PLAN  
 TRACED BY  
 DESIGNED BY  
 QUANTITIES BY  
 CHECKED BY  
 No.

| STATE | PROJ. NO. | FISCAL YEAR | SHEET NO. | TOTAL SHEETS |
|-------|-----------|-------------|-----------|--------------|
| HAW.  | 198C-0171 | 1973        | 38        | 51           |

| BASE CONNECTION DATA TABLE |                                   |                |        |        |        |        |      |      |       |         | FUSE PLATE DATA TABLE |        |        |        |        |        |      |         |       |           | FOUNDATION DATA     |             |                 |                  |             |
|----------------------------|-----------------------------------|----------------|--------|--------|--------|--------|------|------|-------|---------|-----------------------|--------|--------|--------|--------|--------|------|---------|-------|-----------|---------------------|-------------|-----------------|------------------|-------------|
| Post Size                  | Bolt Size & Torque                | A              | B      | C      | D      | E      | t1   | t2   | W     | R       | F                     | G      | H      | J      | K      | L      | N    | d1      | t3    | Bolt Dia. | Wt. of each Fuse lb | Stub Length | Stub Projection | Footing Diameter | Bars V Size |
| 6 B 8.5                    |                                   |                |        |        |        |        |      |      |       |         | 3 5/8"                | 2"     | 1 1/8" | 4"     | 2 1/4" | 7/8"   | 1/2" | 9/16"   | 1/4"  | 1/2"      | 1.09#               | 2'-0"       | 3"              | 2'-0"            | #5          |
| 6 B 12                     | 5/8" ϕ x 2 3/4"<br>Torque = 450"# | 5"             | 2"     | 1 1/4" | 2 3/4" | 1 1/8" | 3/4" | 1/2" | 1/4"  | 1 1/32" | 3 3/4"                | 2"     | 1 1/8" | 4"     | 2 1/4" | 7/8"   | 5/8" | 1 1/16" | 3/8"  | 5/8"      | 1.60#               | 2'-0"       | 3"              | 2'-0"            | #5          |
| 6 B 15.5                   |                                   |                |        |        |        |        |      |      |       |         | 4 1/2"                | 2 1/2" | 1 1/4" | 6"     | 3 1/2" | 1 1/4" | 3/4" | 1 3/16" | 1/2"  | 3/4"      | 3.75#               | 2'-6"       | 3"              | 2'-0"            | #6          |
| 8 WF 17                    |                                   |                |        |        |        |        |      |      |       |         | 4 1/2"                | 2 1/2" | 1 1/4" | 5 1/4" | 2 3/4" | 1 1/4" | 3/4" | 1 3/16" | 1/2"  | 3/4"      | 3.27#               | 2'-6"       | 3"              | 2'-0"            | #7          |
| 8 WF 20                    |                                   |                |        |        |        |        |      |      |       |         | 4 7/8"                | 2 1/2" | 1 1/2" | 5 1/4" | 2 3/4" | 1 1/4" | 7/8" | 1 5/16" | 9/16" | 7/8"      | 3.93#               | 3'-0"       | 2 1/2"          | 2'-0"            | #8          |
| 10 WF 21                   | 3/4" ϕ x 3 1/2"<br>Torque = 750"# | 6"             | 2 1/4" | 1 3/8" | 3 1/2" | 1 1/4" | 1"   | 3/4" | 5/16" | 1 3/32" | 5 3/8"                | 3"     | 1 1/2" | 5 3/4" | 2 3/4" | 1 1/2" | 7/8" | 1 5/16" | 9/16" | 7/8"      | 4.75#               | 3'-0"       | 2 1/2"          | 2'-0"            | #9          |
| 10 WF 25                   |                                   |                |        |        |        |        |      |      |       |         | 5 3/8"                | 3"     | 1 1/2" | 5 3/4" | 2 3/4" | 1 1/2" | 7/8" | 1 5/16" | 9/16" | 7/8"      | 4.79#               | 3'-0"       | 2 1/2"          | 2'-0"            | #10         |
| 12 WF 27                   |                                   |                |        |        |        |        |      |      |       |         | 5 3/8"                | 3"     | 1 1/2" | 6 1/2" | 3 1/2" | 1 1/2" | 7/8" | 1 5/16" | 9/16" | 7/8"      | 5.42#               | 3'-0"       | 2 1/2"          | 2'-0"            | #11         |
| 3 I 5.7                    | 1/2" ϕ x 2 1/2"<br>Torque = 200"# | SEE DETAIL "A" |        |        |        |        |      |      |       |         | 3 1/8"                | 1 1/2" | 1 1/8" | 2 5/8" | 1 1/2" | 9/16"  | 1/2" | 9/16"   | 1/4"  | 1/2"      | 0.64#               | 1'-6"       | 3 1/2"          | 1'-6"            | #5          |
| 4 I 7.7                    |                                   | SEE DETAIL "A" |        |        |        |        |      |      |       |         | 3 1/8"                | 1 1/2" | 1 1/8" | 2 5/8" | 1 1/2" | 9/16"  | 1/2" | 9/16"   | 1/4"  | 1/2"      | 0.64#               | 1'-6"       | 3 1/2"          | 1'-6"            | #5          |

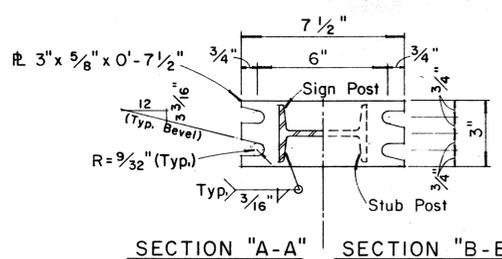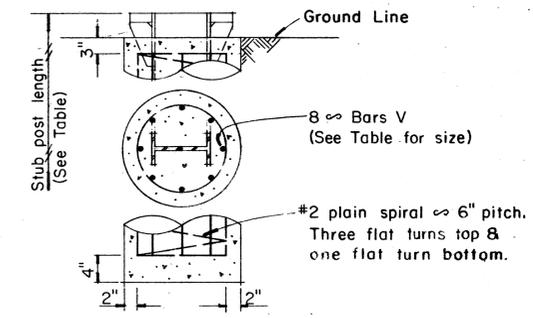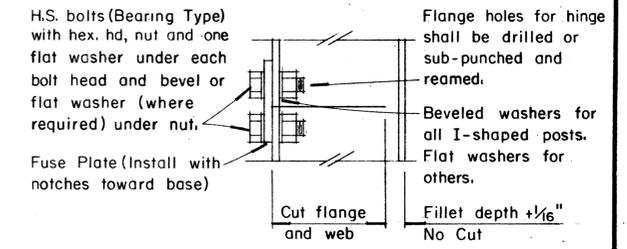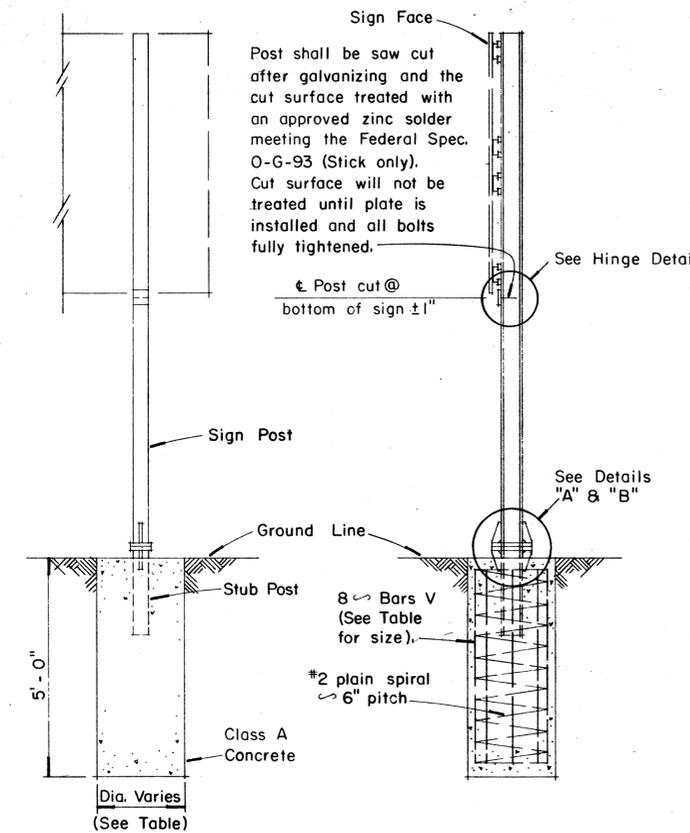

NOTE:  
Sections shown are for installations on right shoulder and in gore. Reverse plate slot bevels for installations on left shoulder.

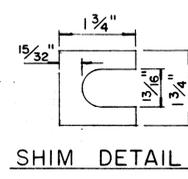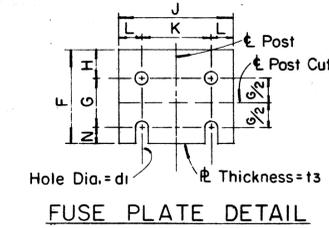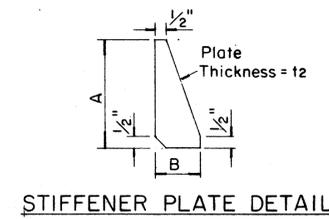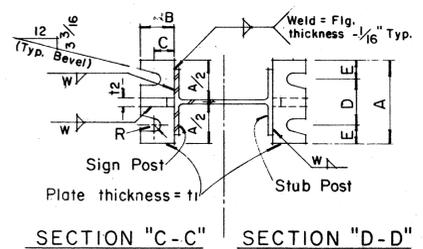

Furnish 2  $\times$  .012"  $\pm$  thick and 2  $\times$  .032"  $\pm$  thick shims per post. Shims shall be fabricated from brass shim stock or strip conforming to A.S.T.M.-B 36.

GENERAL NOTES

- Design conforms with AASHO Specifications for the design and Construction of Structural Supports for Highway Signs.
- Materials and Fabrication shall conform to the requirements of the Standard Specifications and Special Provisions.
- All holes shall be drilled. All plate cuts shall preferably be saw cuts, however; flame cutting will be permitted provided all edges are ground. Metal projecting beyond the plane of the plate face will not be tolerated.
- Tighten the high strength bolts in the base connection only to the torque shown, do not overtighten. All bolts other than high strength bolts shall conform to ASTM A 307, Class A.
- All structural steel, bolts, nuts and washers shall be galvanized as per the Standard Specifications and Special Provisions. Structural steel to be galvanized after fabrication except as noted.
- Structural steel shall conform with with the requirements of ASTM A 441
- Galvanizing of all posts shall be projection above concrete plus 6" minimum.
- All friction fuse bolts shall be tightened in the shop following a method approved by the Engineer. Tightening shall be to such a degree as to obtain the following minimum residual tension in each bolt:

| Bolt Size | Min. Tension | Bolt Size | Min. Tension |
|-----------|--------------|-----------|--------------|
| 1/2" ϕ    | 12050 Lbs.   | 3/4" ϕ    | 28400 Lbs.   |
| 5/8" ϕ    | 19200 Lbs.   | 7/8" ϕ    | 36050 Lbs.   |

APPROVAL RECOMMENDED:  
*Erich Tanaka* 12/29/69  
TRAFFIC ENGINEER DATE

APPROVED:  
*John J. Steh* 12-30-69  
ASSISTANT CHIEF, ENGINEERING DATE

| NO. | REVISION | APPROVED BY | DATE |
|-----|----------|-------------|------|
|     |          |             |      |

STATE OF HAWAII  
DEPARTMENT OF TRANSPORTATION  
HIGHWAYS DIVISION

STANDARD DETAILS  
BREAK-AWAY SIGN SUPPORTS  
FOR  
GROUND MOUNTED GUIDE SIGNS


Not to Scale

DATE  
SURVEY PLATTED BY  
DRAWN BY  
DESIGNED BY  
QUANTITIES BY  
CHECKED BY  
NO. 1


| STATE | PROJ. NO. | FISCAL YEAR | SHEET NO. | TOTAL SHEETS |
|-------|-----------|-------------|-----------|--------------|
| HAW.  | 190C01-71 | 1973        | 39        | 51           |

(GROUND MOUNTED SIGNS)  
SUPPORT SPACING TABLE


| PANEL THICK. | LENGTH OF SIGN | NO. OF SUPPORTS | OVERHANG |   | SUPPORT SPACING |
|--------------|----------------|-----------------|----------|---|-----------------|
|              |                |                 | A        | B |                 |
| 1"           | 6'-0"          | 2               | 12"      |   | 48"             |
| 1"           | 6'-6"          | 2               | 15"      |   | 48"             |
| 1"           | 7'-0"          | 2               | 15"      |   | 54"             |
| 1"           | 7'-6"          | 2               | 18"      |   | 54"             |
| 1"           | 8'-0"          | 2               | 18"      |   | 60"             |
| 1"           | 8'-6"          | 2               | 20"      |   | 62"             |
| 1"           | 9'-0"          | 2               | 22"      |   | 64"             |
| 1"           | 9'-6"          | 2               | 23"      |   | 68"             |
| 1"           | 10'-0"         | 2               | 24"      |   | 72"             |
| 1"           | 10'-6"         | 2               | 24"      |   | 78"             |
| 1"           | 11'-0"         | 2               | 24"      |   | 84"             |
| 1"           | 11'-6"         | 2               | 27"      |   | 84"             |
| 1"           | 12'-0"         | 2               | 30"      |   | 84"             |
| 1"           | 12'-6"         | 2               | 30"      |   | 90"             |
| 1"           | 13'-0"         | 2               | 30"      |   | 96"             |
| 1"           | 13'-6"         | 2               | 30"      |   | 102"            |
| 1"           | 14'-0"         | 2               | 30"      |   | 108"            |
| 1"           | 14'-6"         | 2               | 36"      |   | 102"            |
| 1"           | 15'-0"         | 2               | 36"      |   | 108"            |
| 2.5"         | 15'-6"         | 2               | 36"      |   | 114"            |
| 2.5"         | 16'-0"         | 2               | 39"      |   | 114"            |
| 2.5"         | 16'-6"         | 2               | 39"      |   | 120"            |
| 2.5"         | 17'-0"         | 2               | 39"      |   | 126"            |
| 2.5"         | 17'-6"         | 2               | 42"      |   | 126"            |
| 2.5"         | 18'-0"         | 2               | 42"      |   | 132"            |
| 2.5"         | 18'-6"         | 2               | 45"      |   | 132"            |
| 2.5"         | 19'-0"         | 2               | 45"      |   | 138"            |
| 2.5"         | 19'-6"         | 2               | 45"      |   | 144"            |
| 2.5"         | 20'-0"         | 2               | 48"      |   | 144"            |
| 2.5"         | 20'-6"         | 2               | 48"      |   | 150"            |
| 2.5"         | 21'-0"         | 2               | 51"      |   | 150"            |
| 2.5"         | 21'-6"         | 2               | 51"      |   | 156"            |
| 2.5"         | 22'-0"         | 2               | 51"      |   | 162"            |
| 2.5"         | 22'-6"         | 2               | 54"      |   | 162"            |
| 2.5"         | 23'-0"         | 2               | 54"      |   | 168"            |
| 2.5"         | 23'-6"         | 2               | 54"      |   | 174"            |
| 2.5"         | 24'-0"         | 2               | 57"      |   | 174"            |

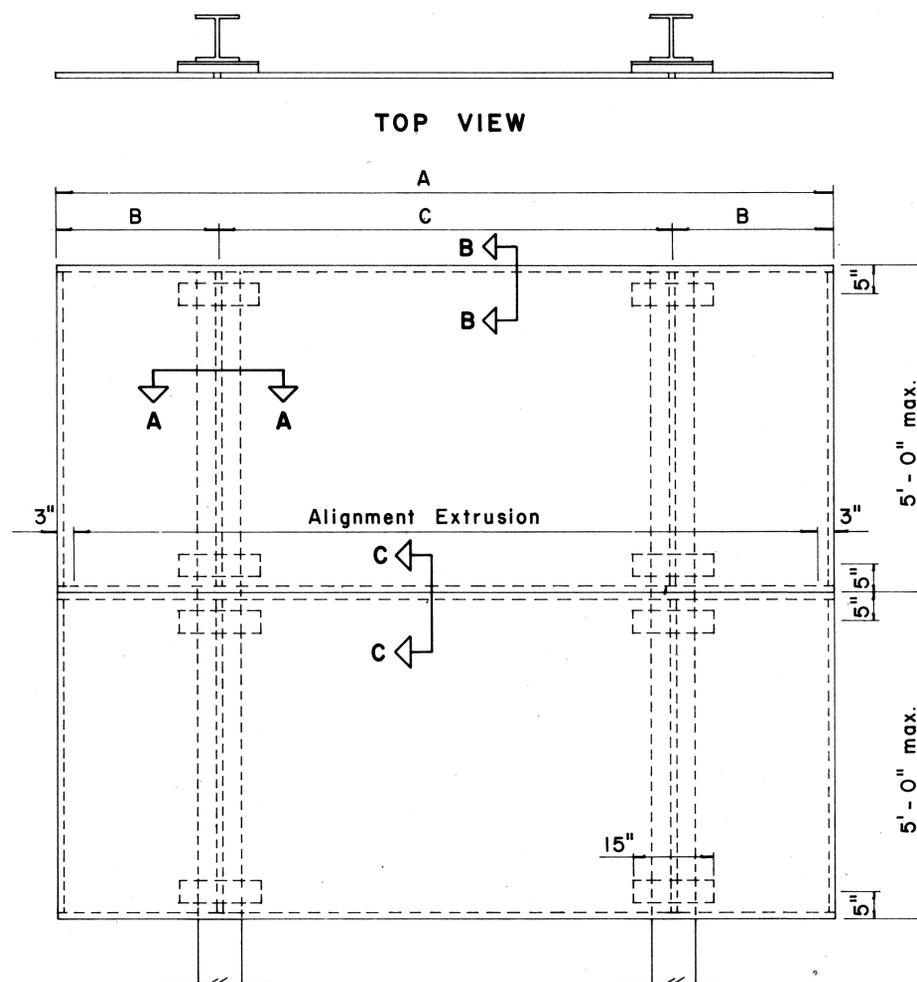


**TYPICAL SIGN ASSEMBLY**  
Scale:  $\frac{3}{4}'' = 1' - 0''$

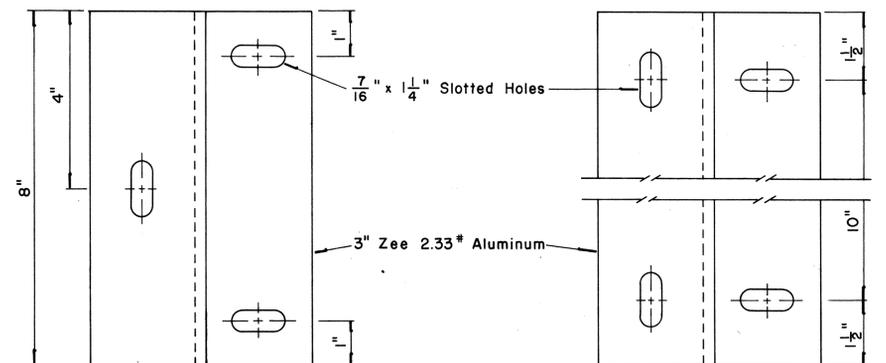


**ZEE MOUNTING DETAILS**  
Scale:  $\frac{1}{2}'' = 1''$

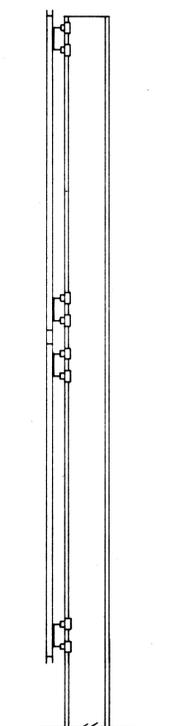


**SIDE VIEW**

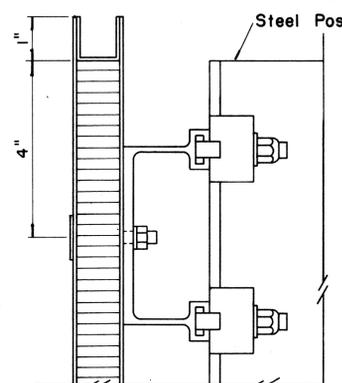


**SECTION "B-B"**  
Scale:  $\frac{1}{2}'' = 1''$

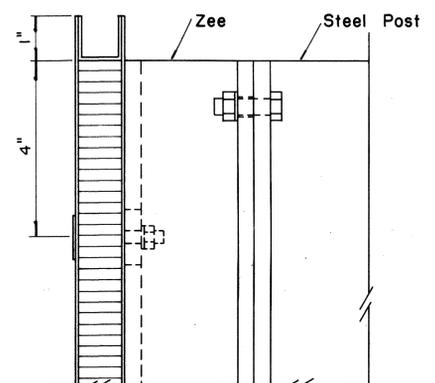


**SECTION "B-B" (Alternate)**  
Scale:  $\frac{1}{2}'' = 1''$

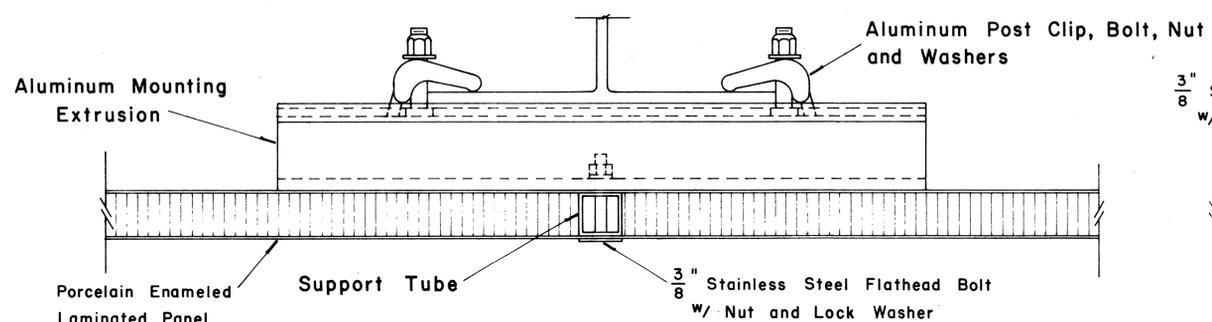

**SECTION "A-A"**  
Scale:  $\frac{1}{2}'' = 1''$

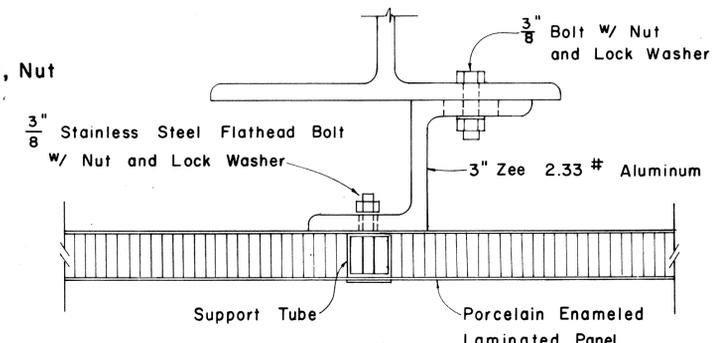

**SECTION "A-A" (Alternate)**  
Scale:  $\frac{1}{2}'' = 1''$

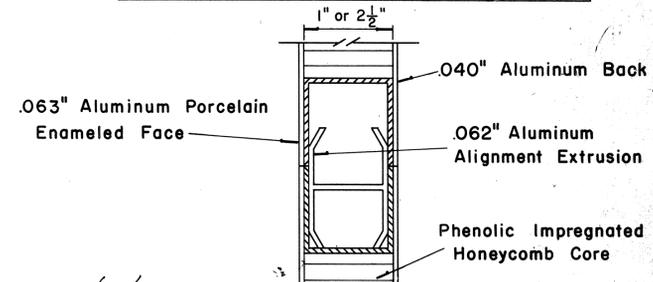

**CLOSURE DETAIL SECTION "C-C"**  
FULL SCALE

APPROVAL RECOMMENDED:  
*Eishi Tanaka* 12/29/69 DATE  
TRAFFIC ENGINEER

APPROVED:  
*John J. Stein* 12-30-69 DATE  
ASSISTANT CHIEF, ENGINEERING



| NO. | REVISION | APPROVED BY | DATE |
|-----|----------|-------------|------|
|     |          |             |      |

STATE OF HAWAII  
DEPARTMENT OF TRANSPORTATION  
HIGHWAYS DIVISION




**STANDARD DETAILS**  
LAMINATED ALUMINUM  
SIGN PANELS  
(GROUND MOUNTED)  
Scale: As Shown

SURVEY PLOTTED BY  
 DRAWN BY  
 DESIGNED BY  
 QUANTITIES BY  
 CHECKED BY  
 ORIGINAL PLAN  
 NOTE BOOK  
 No.

|       |            |             |           |              |
|-------|------------|-------------|-----------|--------------|
| STATE | PROJ. NO.  | FISCAL YEAR | SHEET NO. | TOTAL SHEETS |
| HAW.  | 193C-01-71 | 1973        | 40        | 51           |

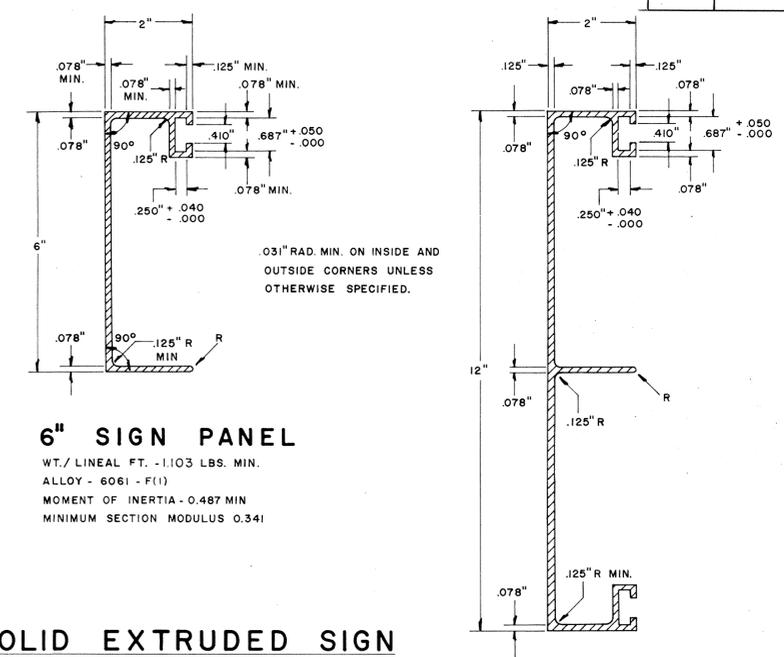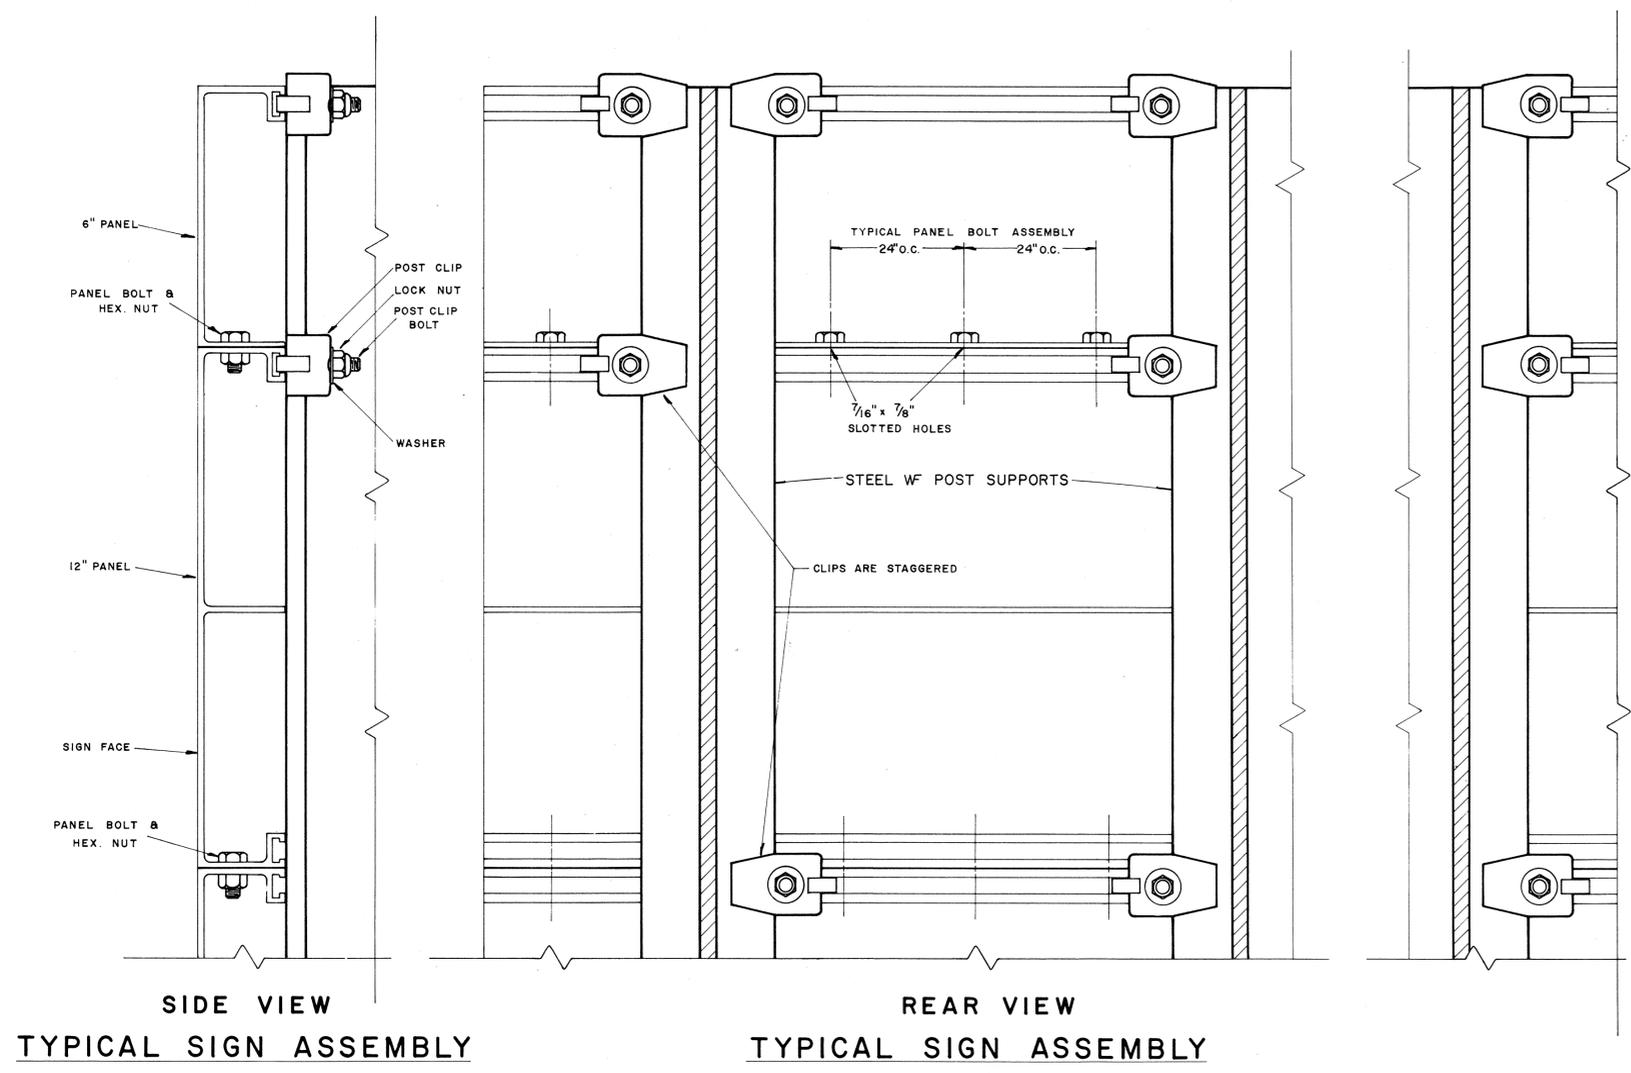

**SOLID EXTRUDED SIGN PANEL DETAILS**

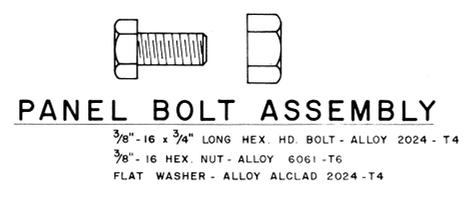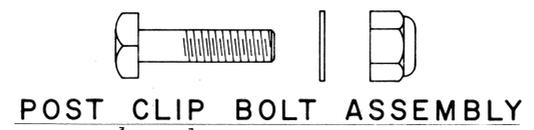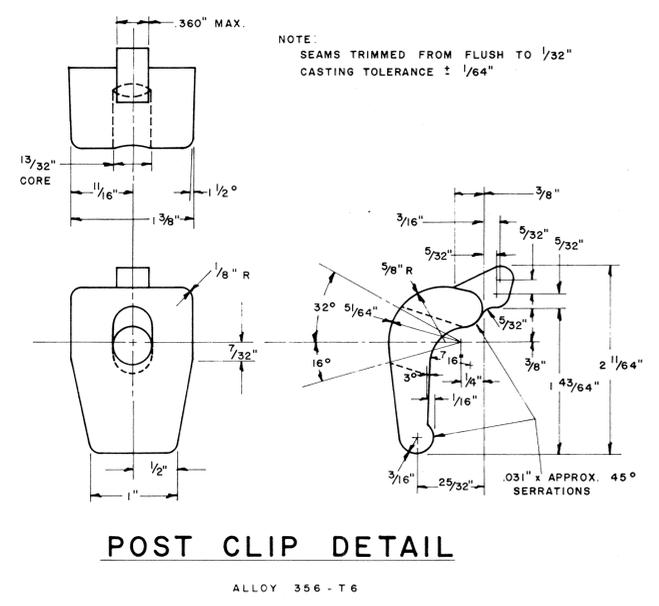

NOTE:  
Extruded Aluminum Panels to be used for  
Destination Signs with Reflective Sheeting Background

APPROVAL RECOMMENDED:  
*Euchi Tanaka* 12/29/69  
TRAFFIC ENGINEER DATE

APPROVED:  
*[Signature]* 12-30-69  
ASSISTANT CHIEF, ENGINEERING DATE


| NO. | REVISION | APPROVED BY | DATE |
|-----|----------|-------------|------|
|     |          |             |      |

STATE OF HAWAII  
DEPARTMENT OF TRANSPORTATION  
HIGHWAYS DIVISION  
**STANDARD DETAILS**  
SOLID ALUMINUM  
EXTRUDED SIGN PANEL  
AND  
ACCESSORY DETAILS  
SCALE:

DATE  
SURVEY PLOTTED BY  
DRAWN BY  
TRACED BY  
NOTE BOOK  
QUANTITIES CHECKED BY  
No.

| STATE | PROJ. NO.  | FISCAL YEAR | SHEET NO. | TOTAL SHEETS |
|-------|------------|-------------|-----------|--------------|
| HAW.  | 10BC-01-71 | 1973        | 41        | 51           |

| MARKER SIZE | MULTIPLY DIMENSIONS BY | NUMERAL SIZE |
|-------------|------------------------|--------------|
| 16"         | 1                      | 6"           |
| 21"         | 1.3                    | 8"           |
| 32"         | 2.0                    | 12"          |
| 42"         | 2.63                   | 16"          |

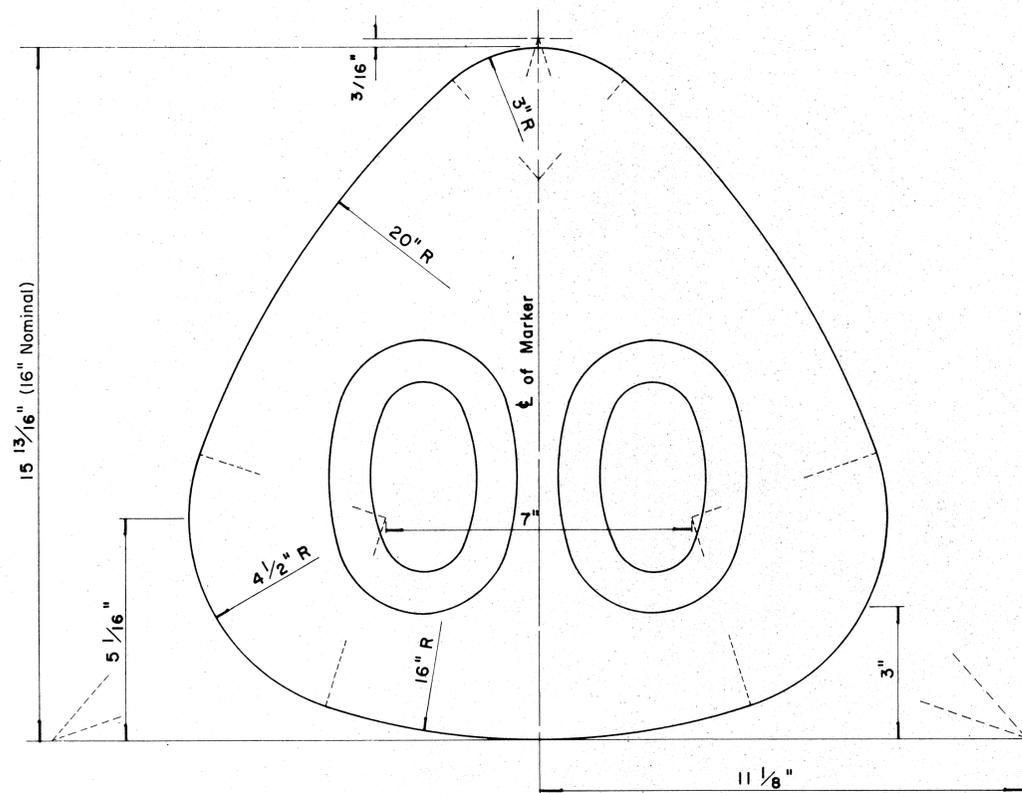


**STATE ROUTE MARKER  
FOR GUIDE SIGNS**

Scale: Half Size

**NOTE:**

1. State Route Markers on Guide signs shall have black numerals on a white reflectorized background mounted on a flat aluminum cut-out.
2. Numerals shall conform to the FHWA publication "Standard Alphabets for Highway Signs," 1966.
3. Cut-outs shall be fastened on sign panel with aluminum blind rivets. See Standard Specifications.
- \* 4. The 16" State Route Marker shall be used only with the Construction Identification sign.

| RADI FOR SIGNS          |    |     |
|-------------------------|----|-----|
| Least Dimension of Sign | W  | R   |
| 2'- 0" to 4'- 6"        | 2" | 3"  |
| 4'- 9" to 5'- 6"        | 2" | 6"  |
| 5'- 9" to 7'- 6"        | 2" | 9"  |
| 7'- 9" and greater      | 2" | 12" |

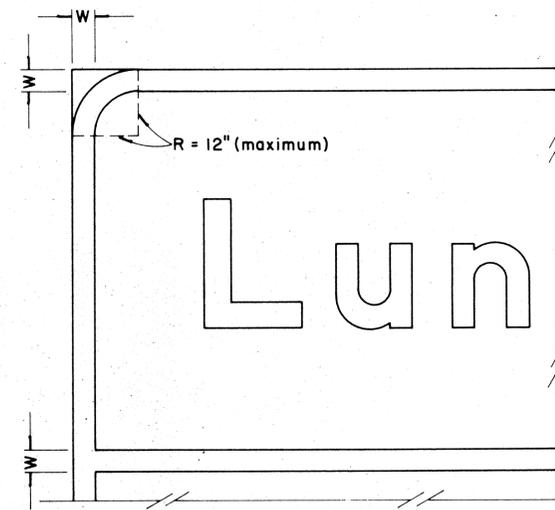

**BORDER DETAIL  
FOR GUIDE SIGNS**

Not to Scale

**NOTE:**

1. Area outside corner radius need not be trimmed.
2. All borders shall be embossed cut-outs, white and reflectorized.
3. All Guide signs shall have borders.

APPROVAL RECOMMENDED:

*Etsuko Tanaka* 4/11/72  
TRAFFIC ENGINEER DATE

APPROVED:

*Shuji S. Sakai* 4/12/72  
ASSISTANT CHIEF, ENGINEERING DATE

| NO | REVISION                                 | APPROVED BY | DATE    |
|----|--|-------------|---------|
| 1  | Supersedes Sht. DT 209 Approved 12-30-69 | N.C.        | 4/12/72 |

STATE OF HAWAII  
DEPARTMENT OF TRANSPORTATION  
HIGHWAYS DIVISION


**STANDARD DETAILS  
STATE ROUTE MARKER  
AND BORDER DETAIL  
FOR GUIDE SIGNS**

Scale: As Shown


SHEET No. 11 OF 19 SHEETS DT 209

DATE: \_\_\_\_\_  
DESIGNED BY: \_\_\_\_\_  
CHECKED BY: \_\_\_\_\_  
DRAWN BY: \_\_\_\_\_  
NOTED BY: \_\_\_\_\_  
ORIGINAL PLAN: \_\_\_\_\_  
NOTE BOOK: \_\_\_\_\_  
No. \_\_\_\_\_


|       |            |             |           |              |
|-------|------------|-------------|-----------|--------------|
| STATE | PROJ. NO.  | FISCAL YEAR | SHEET NO. | TOTAL SHEETS |
| HAW.  | 198C-01-71 | 1973        | 42        | 51           |

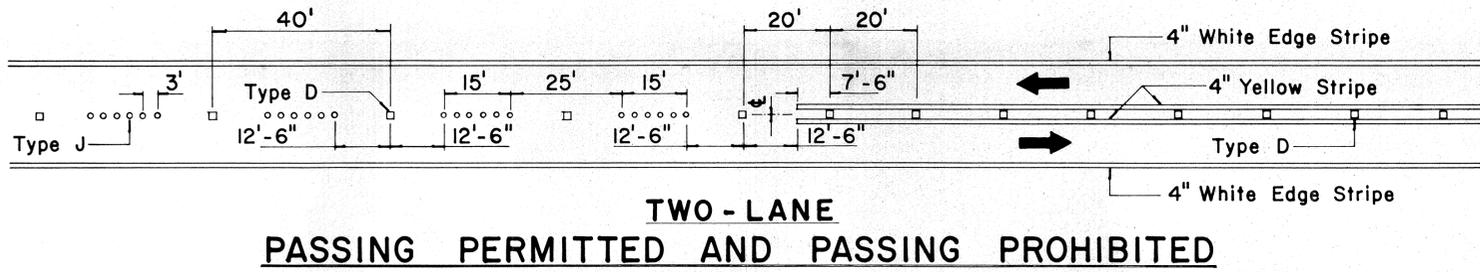


TWO - LANE

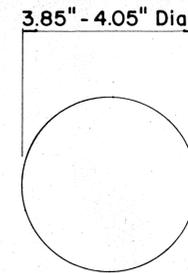


**TYPE A  
NON - REFLECTIVE WHITE MARKER**

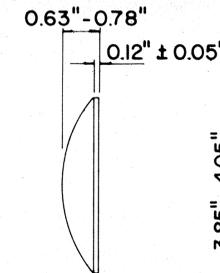


**TYPE J  
NON - REFLECTIVE YELLOW MARKER**

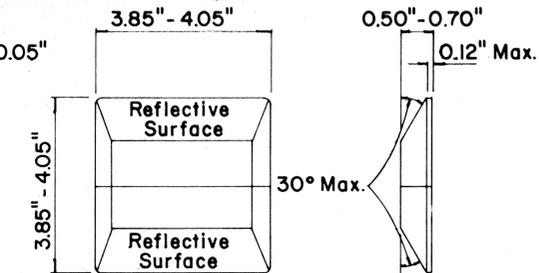


**TYPE C  
RED - CLEAR REFLECTIVE MARKER**

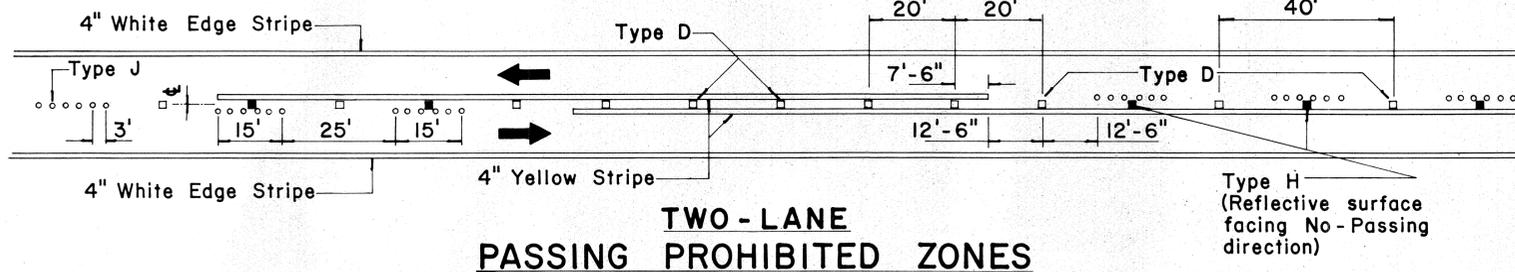


MULTI - LANE

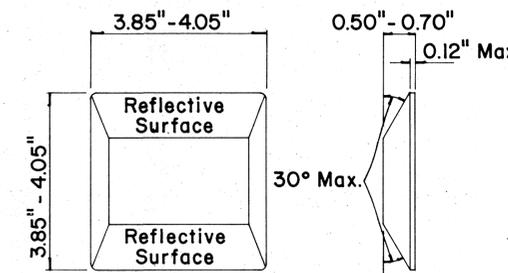


**TYPE D  
TWO - WAY YELLOW REFLECTIVE MARKER**

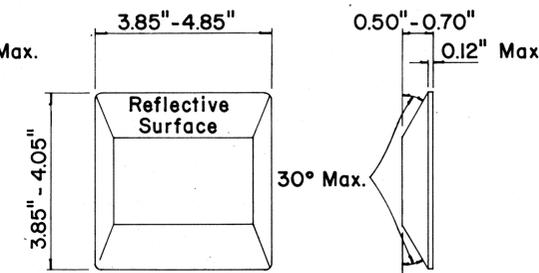

**TYPE H  
ONE - WAY YELLOW REFLECTIVE MARKER**

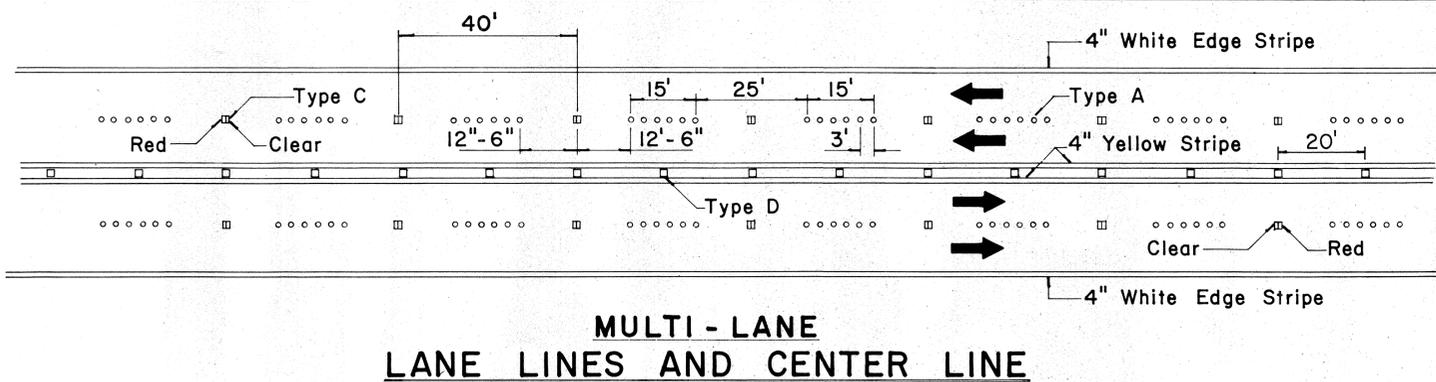

FREEWAY

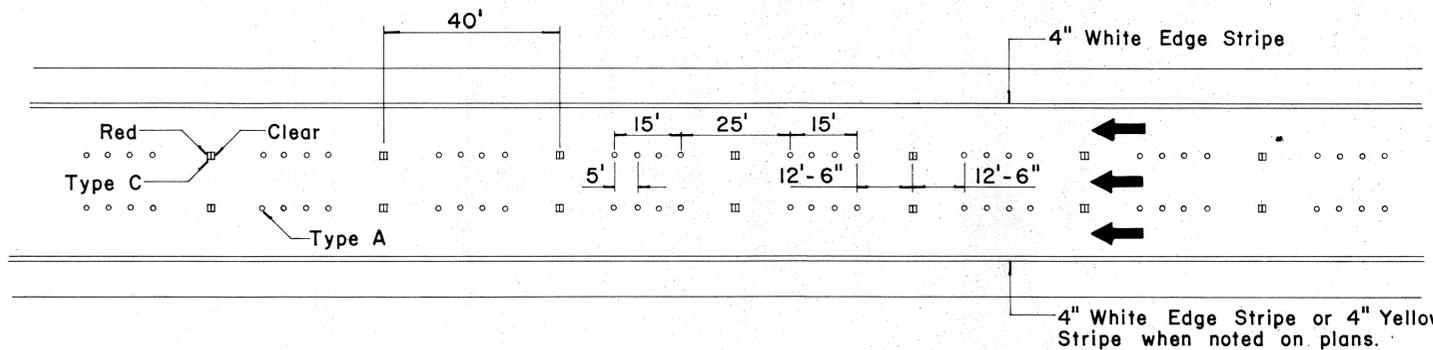

**GENERAL NOTES**

1. Painted stripes to be done by State forces unless otherwise specified.

APPROVAL RECOMMENDED:  
*Eishi Tanaka* 11/18/71  
TRAFFIC ENGINEER DATE

APPROVED:  
*Shelton Sakovich* 11/18/71  
ASSISTANT CHIEF, ENGINEERING DATE



| No. | REVISION                               | APPROVED BY | DATE     |
|-----|--|-------------|----------|
| 1   | Add reflector marker in each line gap. | H.C.        | 10-21-72 |
| 2   | Revised General Notes.                 | H.C.        | 10-21-72 |

STATE OF HAWAII  
DEPARTMENT OF TRANSPORTATION  
HIGHWAYS DIVISION

**STANDARD DETAILS  
RAISED PAVEMENT MARKERS**

Not to Scale      October 1971  
SHEET No. 12 OF 19 SHEETS DT 300




MISCELLANEOUS

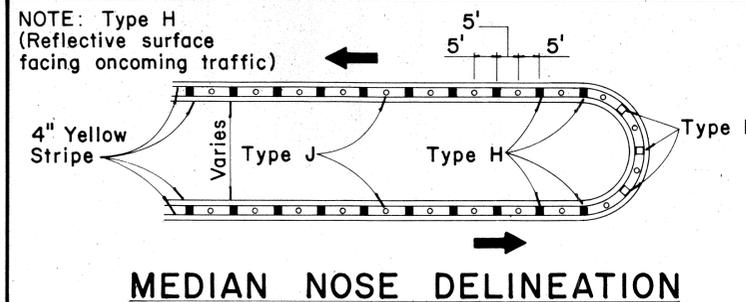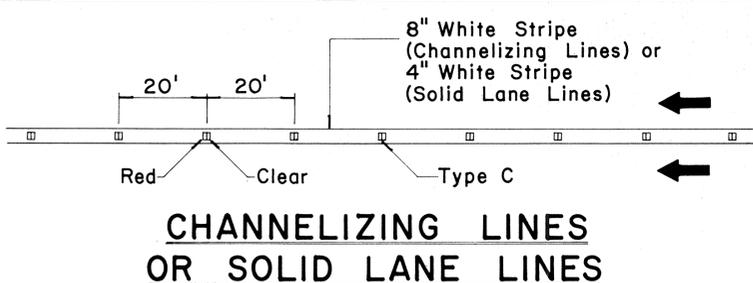





NOTE: Type H (Reflective surface facing oncoming traffic)

DATE \_\_\_\_\_  
SURVEY PLOTTED BY \_\_\_\_\_  
DRAWN BY \_\_\_\_\_  
DESIGNED BY \_\_\_\_\_  
NOTE BOOK \_\_\_\_\_  
QUANTITIES BY \_\_\_\_\_  
CHECKED BY \_\_\_\_\_  
No. \_\_\_\_\_

|       |            |             |           |              |
|-------|------------|-------------|-----------|--------------|
| STATE | PROJ. NO.  | FISCAL YEAR | SHEET NO. | TOTAL SHEETS |
| HAW.  | 19BC-01-71 | 1973        | 43        | 51           |

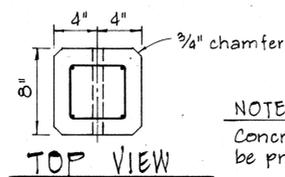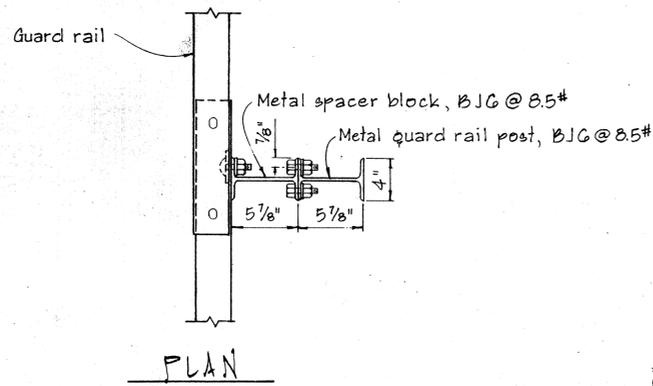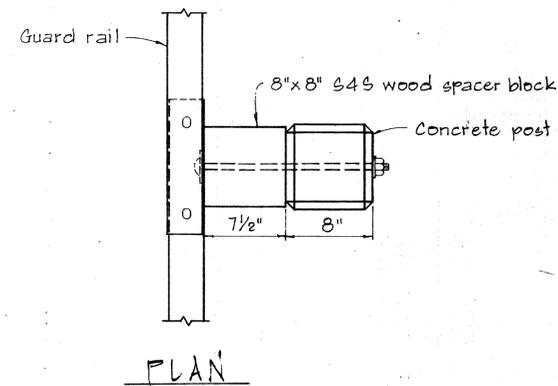

NOTE:  
Concrete post shall be precast

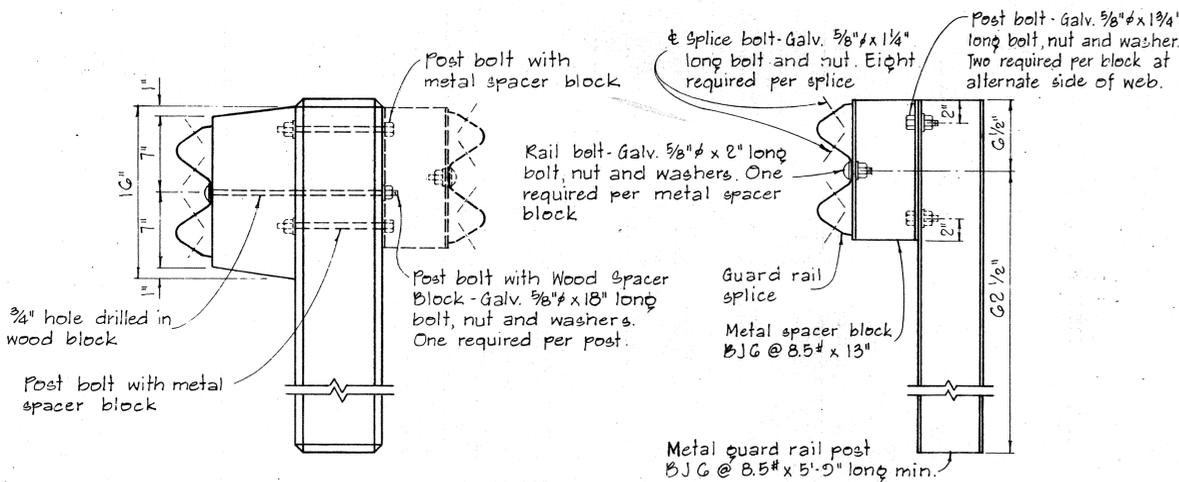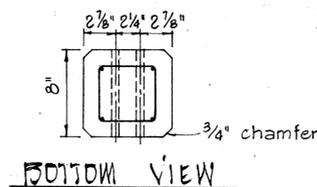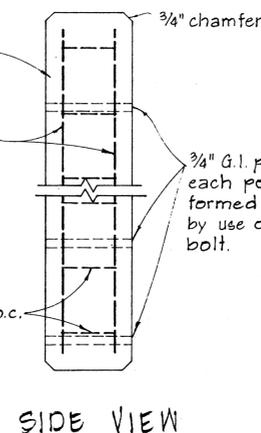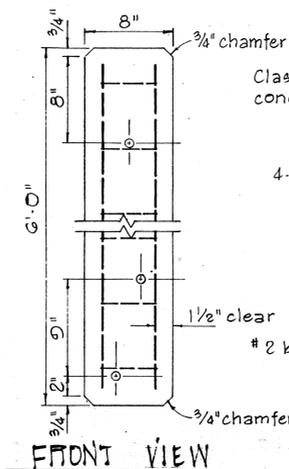


SINGLE METAL GUARD RAIL ON METAL POST WITH METAL SPACER BLOCK

SCALE: 1 1/2" = 1'-0"


DETAIL OF CONCRETE POST

SCALE: 1 1/2" = 1'-0"

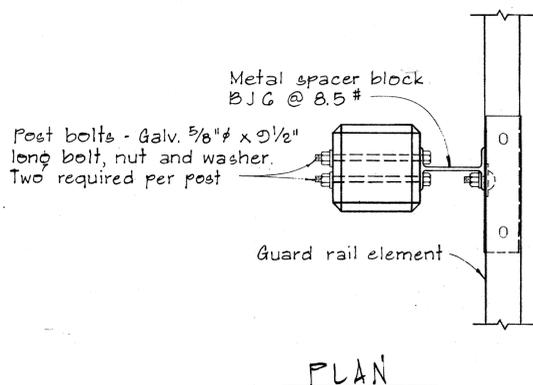

SINGLE METAL GUARD RAIL ON PRECAST CONCRETE POST WITH WOOD OR METAL SPACER BLOCK



SCALE: 1 1/2" = 1'-0"

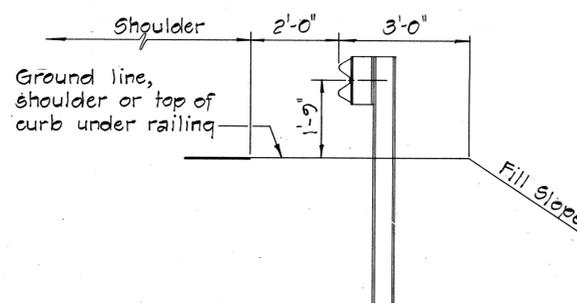

AT SHOULDER SECTION



TYPICAL METAL GUARD RAIL DETAIL

SCALE: 1/2" = 1'-0"

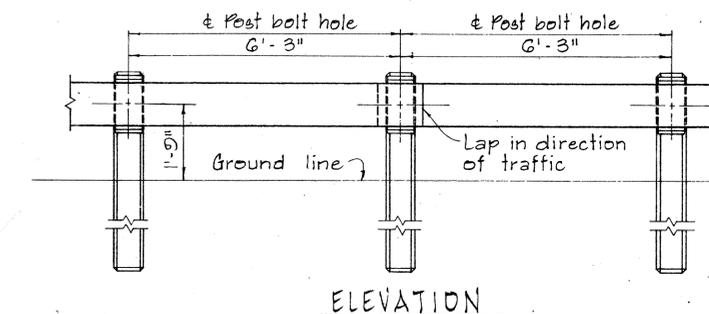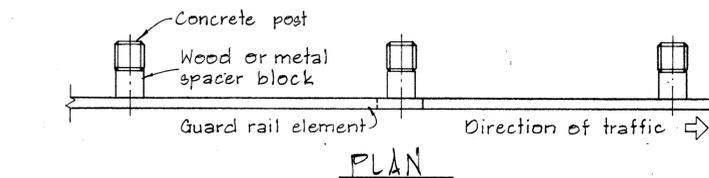

METAL GUARD RAIL ON CONCRETE POST WITH WOOD OR METAL SPACER BLOCK

SCALE: 1/2" = 1'-0"

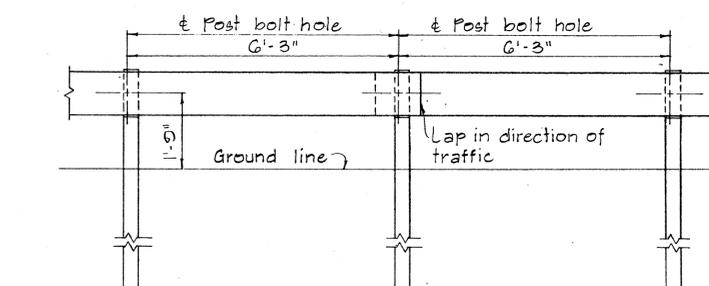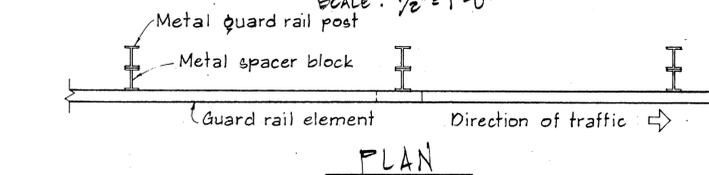

METAL GUARD RAIL ON METAL POST WITH METAL SPACER BLOCK

SCALE: 1/2" = 1'-0"

| NO. | REVISION | APPROVED BY | DATE |
|-----|----------|-------------|------|
|     |          |             |      |

APPROVAL RECOMMENDED:  
*Eishi Tanaka*  
TRAFFIC ENGINEER  
12/29/69  
DATE

APPROVED:  
*Robert J. Zelen*  
ASSISTANT CHIEF, ENGINEERING  
12-30-69  
DATE

STATE OF HAWAII  
DEPARTMENT OF TRANSPORTATION  
HIGHWAYS DIVISION

STANDARD DETAILS  
METAL GUARD RAIL


SCALE: AS SHOWN  
NOV. 1968

SHEET No. 13 OF 19 SHEETS DT 500

|       |            |             |           |              |
|-------|------------|-------------|-----------|--------------|
| STATE | PROJ. NO.  | FISCAL YEAR | SHEET NO. | TOTAL SHEETS |
| HAW.  | 198C-01-71 | 1973        | 44        | 51           |

| BOLT DIMENSIONS                                |       |        |
|--|-------|--------|
| TYPE A BOLT                                    |       |        |
| Splice Bolt                                    | D     | L      |
| Post Bolt for Conc. Post w/ Double Wood Blocks | 5/16" | 1 1/4" |
| Post Bolt for Conc. Post w/ Single Wood Block  | 3/32" | 24"    |
| Rail Bolt for Metal Block                      | 3/32" | 2"     |



| BOLT DIMENSIONS                          |  |        |
|--|--|--------|
| TYPE B BOLT                              |  |        |
| Post Bolt for Conc. Post w/ Metal Blocks |  | L      |
| Post Bolt for Metal Post w/ Metal Block  |  | 1 3/4" |

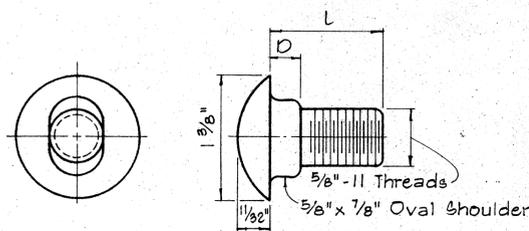

TYPE A BOLT



TYPE B BOLT

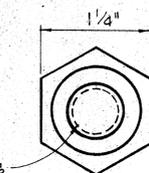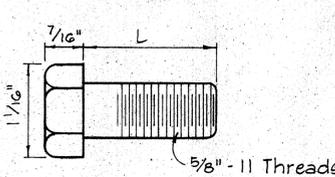

HEXAGON NUT





5/32" Deep x 1 5/16" Dia. C' Bore for Type A Bolt only. Plain nut for Type B Bolt.

SPLICE RAIL AND POST BOLTS



Scale: Full Size

Scale: Full Size

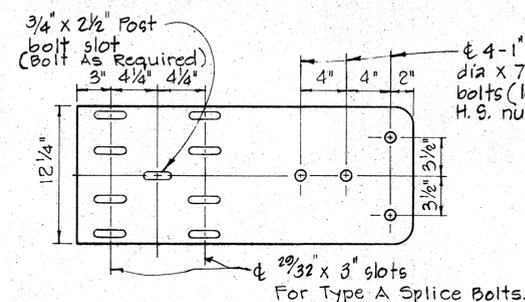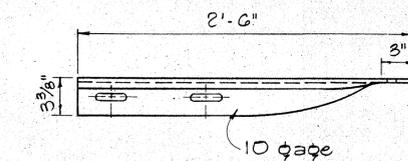


SPECIAL END SHOE

Scale: 1 1/2" = 1'-0"

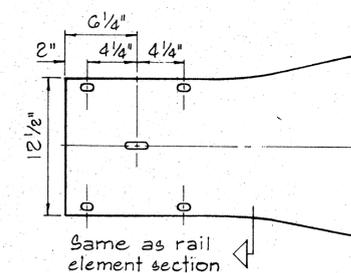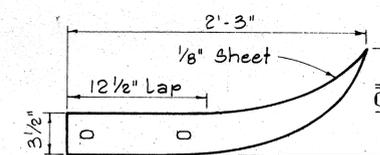


FLARED END

Scale: 1 1/2" = 1'-0"

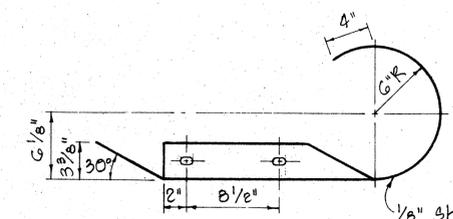


CURVED END

Scale: 1 1/2" = 1'-0"

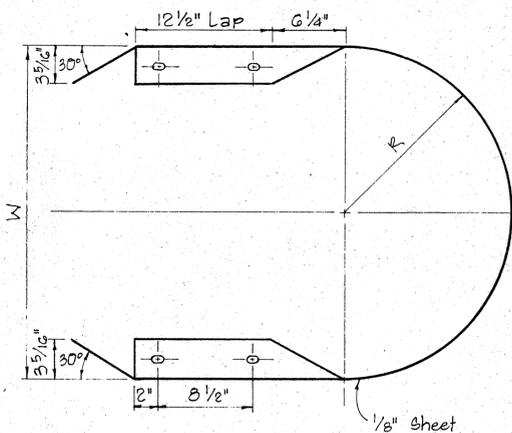

MEDIAN END

Scale: 1 1/2" = 1'-0"

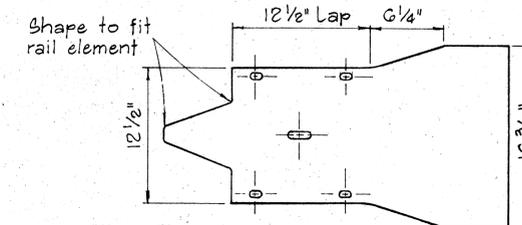

APPROVAL RECOMMENDED:

TRAFFIC ENGINEER

12/29/69  
DATE

APPROVED:

ASSISTANT CHIEF, ENGINEERING

12-30-69  
DATE

NOTES:

- H.S. Bolts shall conform to the requirements of ASTM A 325.
- Special End Shoe shall be fabricated from 10 Gage steel conforming to the requirements of AA6HO 180.


| MEDIAN END DIMENSIONS  |         |          |
|--|---------|----------|
| TYPE OF POST AND BLOCK   | W       | R        |
| Double Metal Guard Rail on Concrete Post with Wood Blocks        | 29 3/4" | 14 7/8"  |
| Double Metal Guard Rail on Concrete Post with Metal Blocks (BJG) | 26 1/2" | 13 1/4"  |
| Double Metal Guard Rail on Metal Post with Metal Blocks (BJG)    | 24 3/8" | 12 3/16" |

| NO. | REVISION | APPROVED BY | DATE |
|-----|----------|-------------|------|
|     |          |             |      |

STATE OF HAWAII  
DEPARTMENT OF TRANSPORTATION  
HIGHWAYS DIVISION


STANDARD DETAILS  
METAL GUARD RAIL

Scale: As Noted August, 1968  
SHEET No. 14 OF 19 SHEETS DT 501

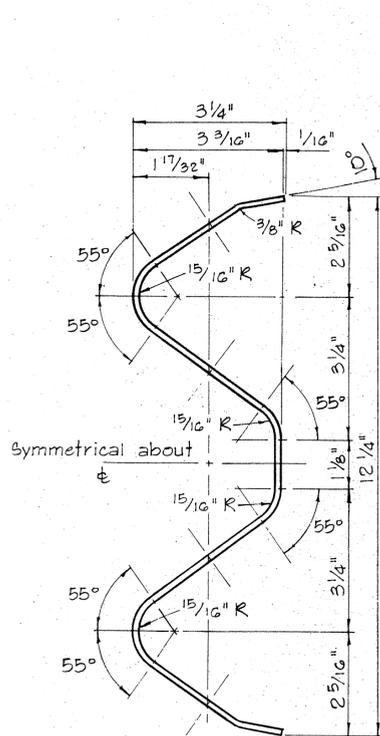


RAIL ELEMENT SECTION

Scale: 6" = 1'-0"

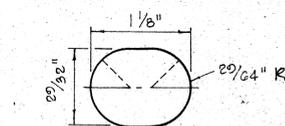


SPLICE BOLT SLOT FOR ALL ENDS


Scale: Full Size

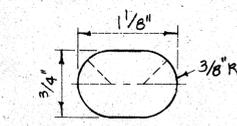


SPLICE BOLT SLOT FOR SPECIAL END SHOE

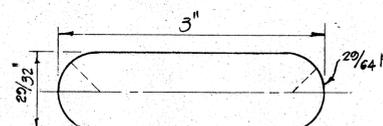


SPLICE BOLT SLOT FOR SPECIAL END SHOE

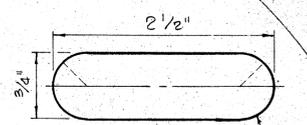

POST BOLT SLOT

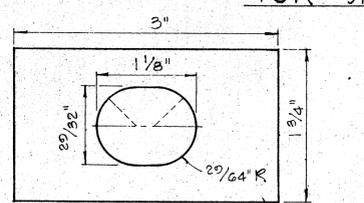

RAIL WASHER

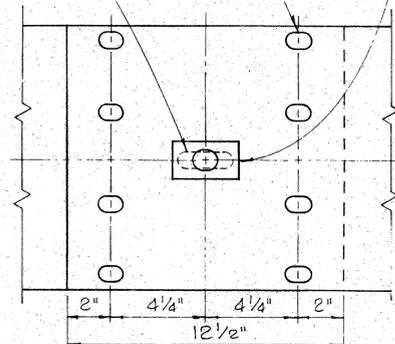









RAIL SPLICE

Scale: 3" = 1'-0"

ORIGINAL SURVEYED BY  
DRAWN BY  
CHECKED BY  
DATE

|       |            |             |           |              |
|-------|------------|-------------|-----------|--------------|
| STATE | PROJ. NO.  | FISCAL YEAR | SHEET NO. | TOTAL SHEETS |
| HAW.  | 198C-01-71 | 1973        | 45        | 51           |

NOTE:  
Metal guard rail connection to structures requires End Post Connection. See structure plans.

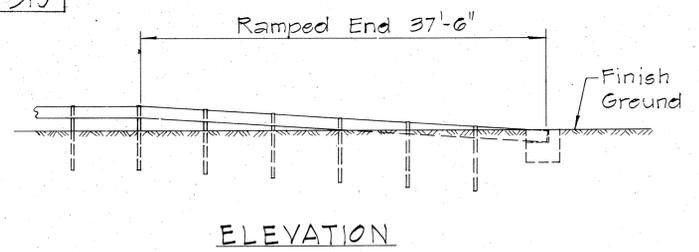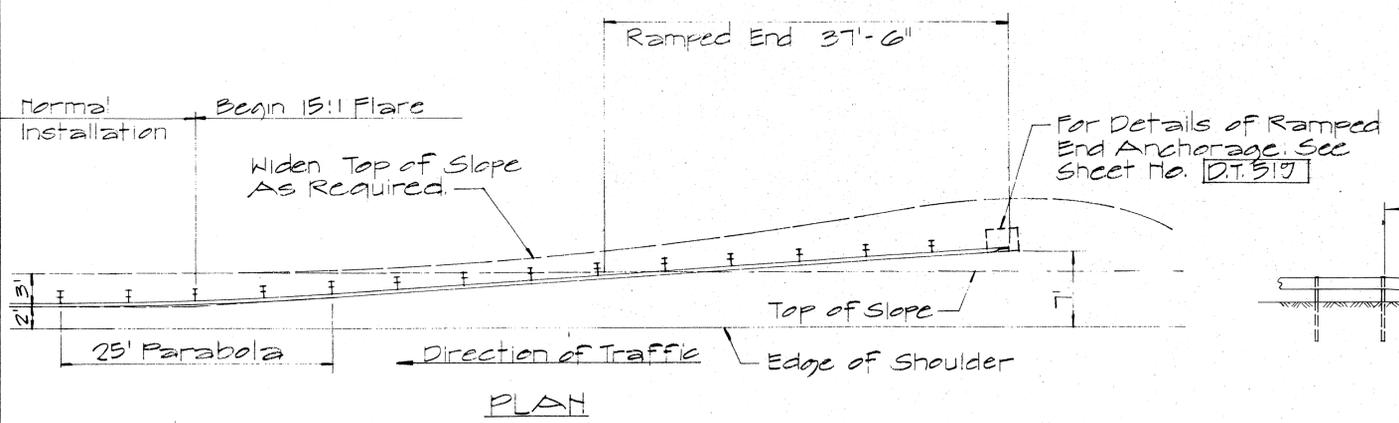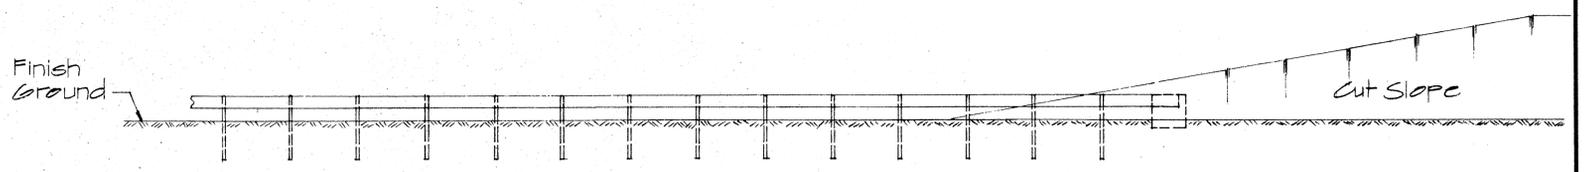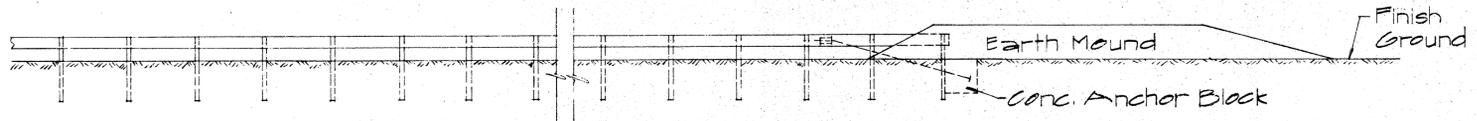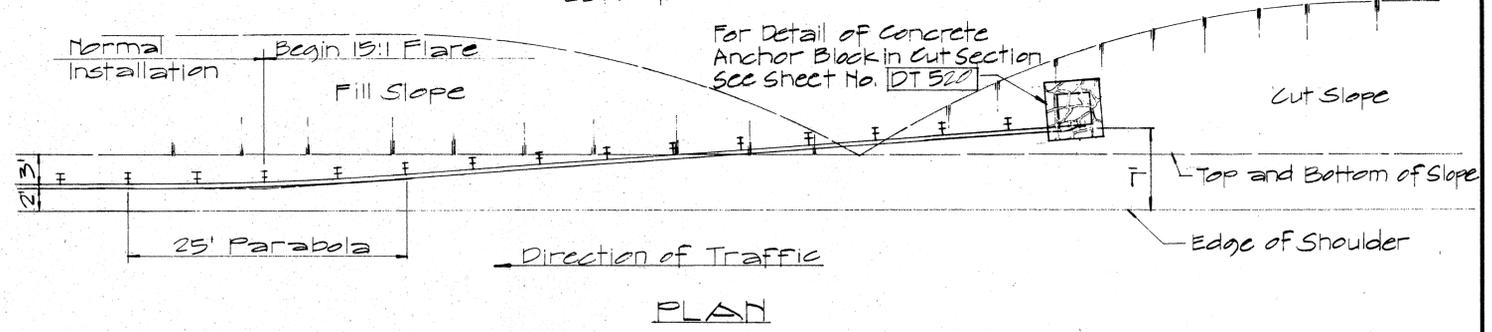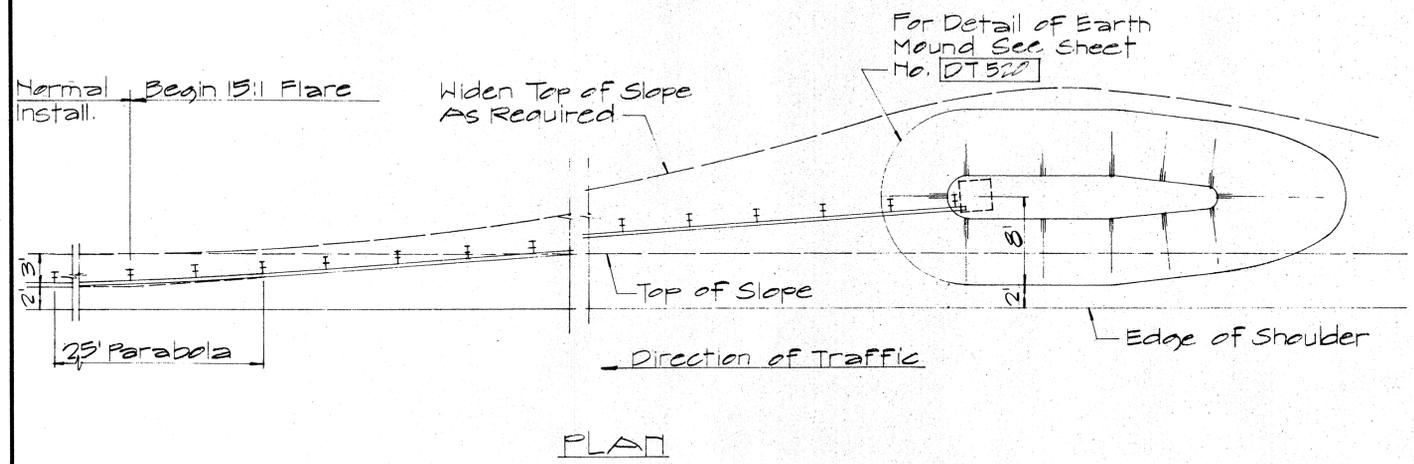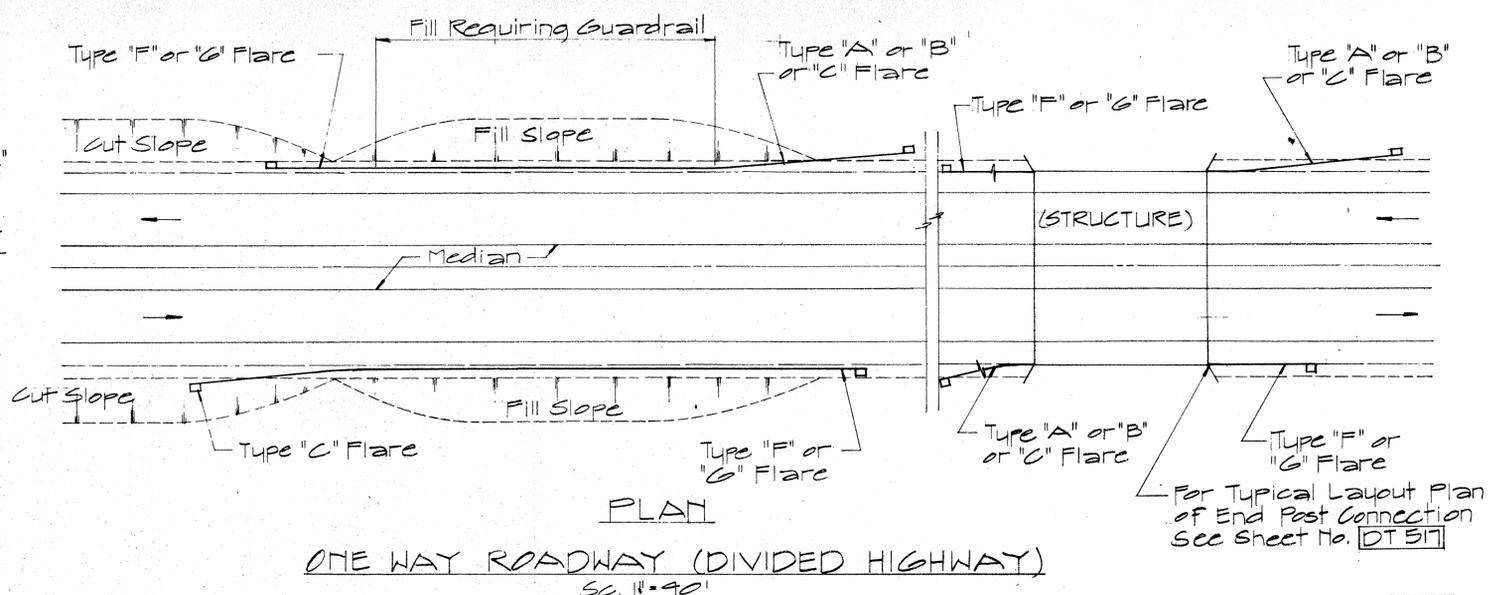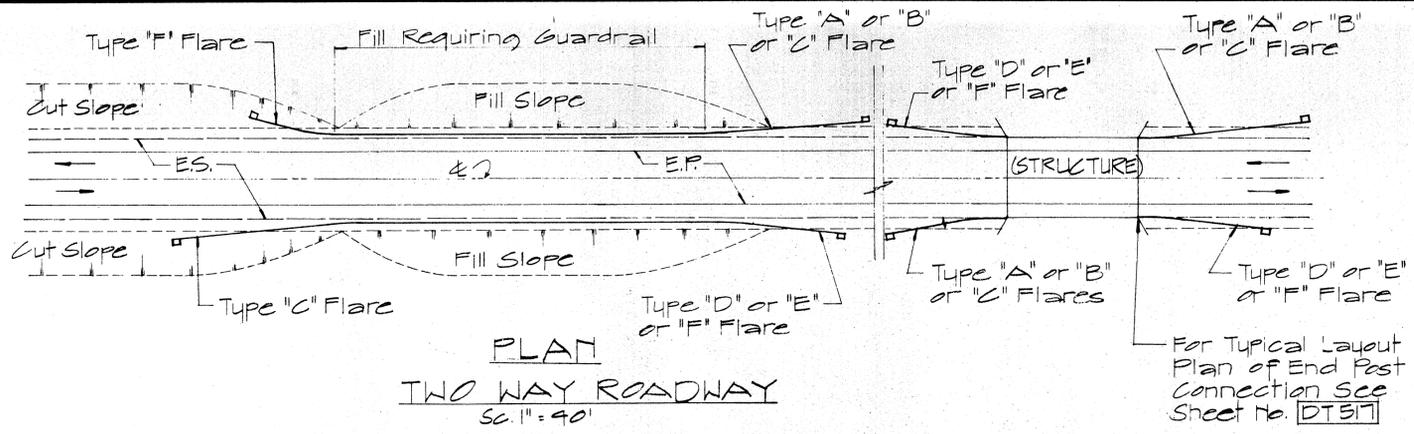

APPROVAL RECOMMENDED:  
*Eiichi Tanaka* 12/23/69  
TRAFFIC ENGINEER DATE

APPROVED:  
*Andrew B. ...* 12-30-69  
ASSISTANT CHIEF, ENGINEERING DATE

ELEVATION  
TYPE "C" FLARE  
Scale 1/8" = 1'-0"

| NO. | REVISION | APPROVED BY | DATE |
|-----|----------|-------------|------|
|     |          |             |      |

STATE OF HAWAII  
DEPARTMENT OF TRANSPORTATION  
HIGHWAYS DIVISION



**STANDARD DETAILS  
OF APPROACH END  
FLARE - ONE & TWO  
WAY ROADWAY**

Scale As Noted April 1969  
SHEET No. 15 OF 19 SHEETS DT516

SURVEY PLOTTED BY: \_\_\_\_\_  
 DATE: \_\_\_\_\_  
 ORIGINAL PLAN: \_\_\_\_\_  
 DRAWN BY: \_\_\_\_\_  
 DESIGNED BY: \_\_\_\_\_  
 NOTE BOOK: \_\_\_\_\_  
 QUANTITIES BY: \_\_\_\_\_  
 CHECKED BY: \_\_\_\_\_  
 No. \_\_\_\_\_




|       |           |             |           |              |
|-------|-----------|-------------|-----------|--------------|
| STATE | PROJ. NO. | FISCAL YEAR | SHEET NO. | TOTAL SHEETS |
| HAW.  | 0BC-01-71 | 1973        | 47        | 51           |

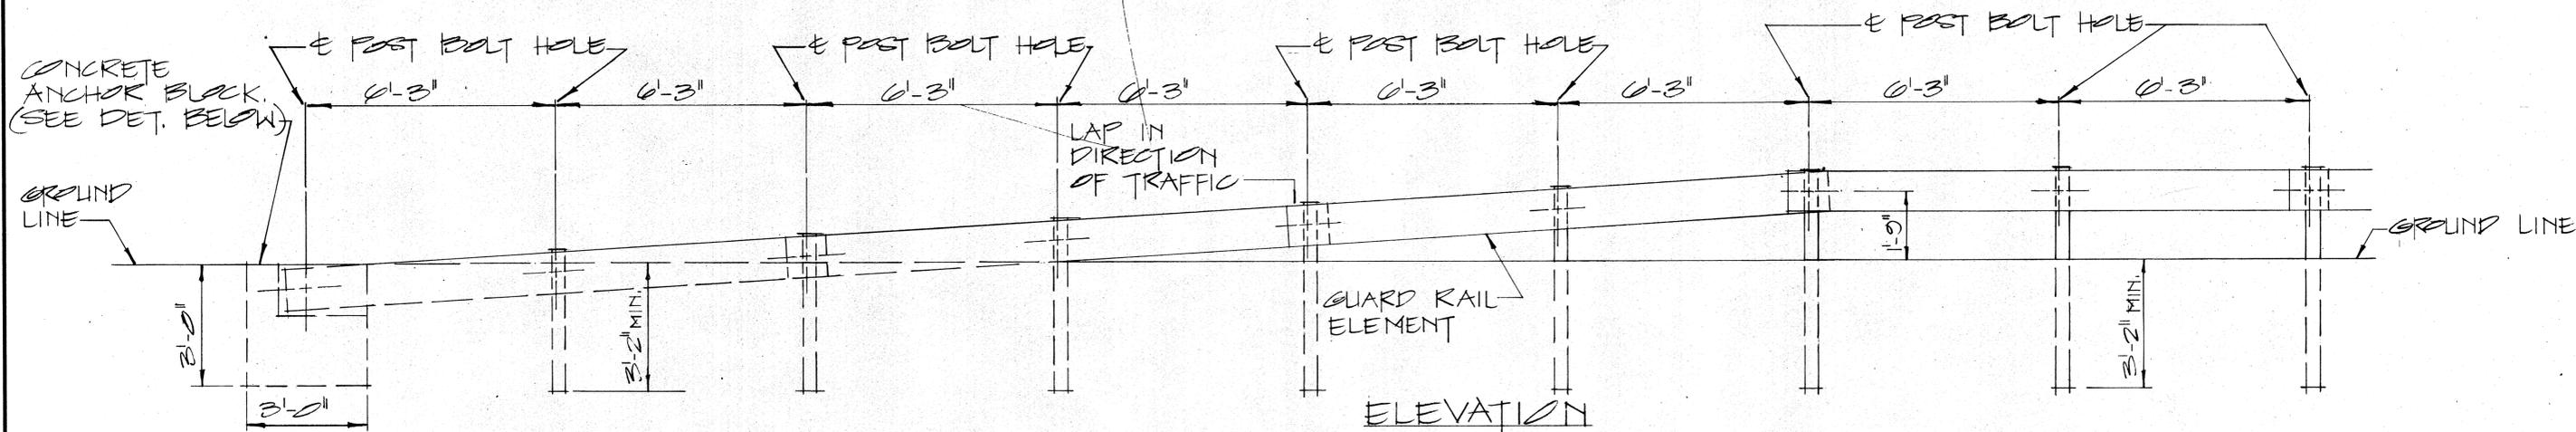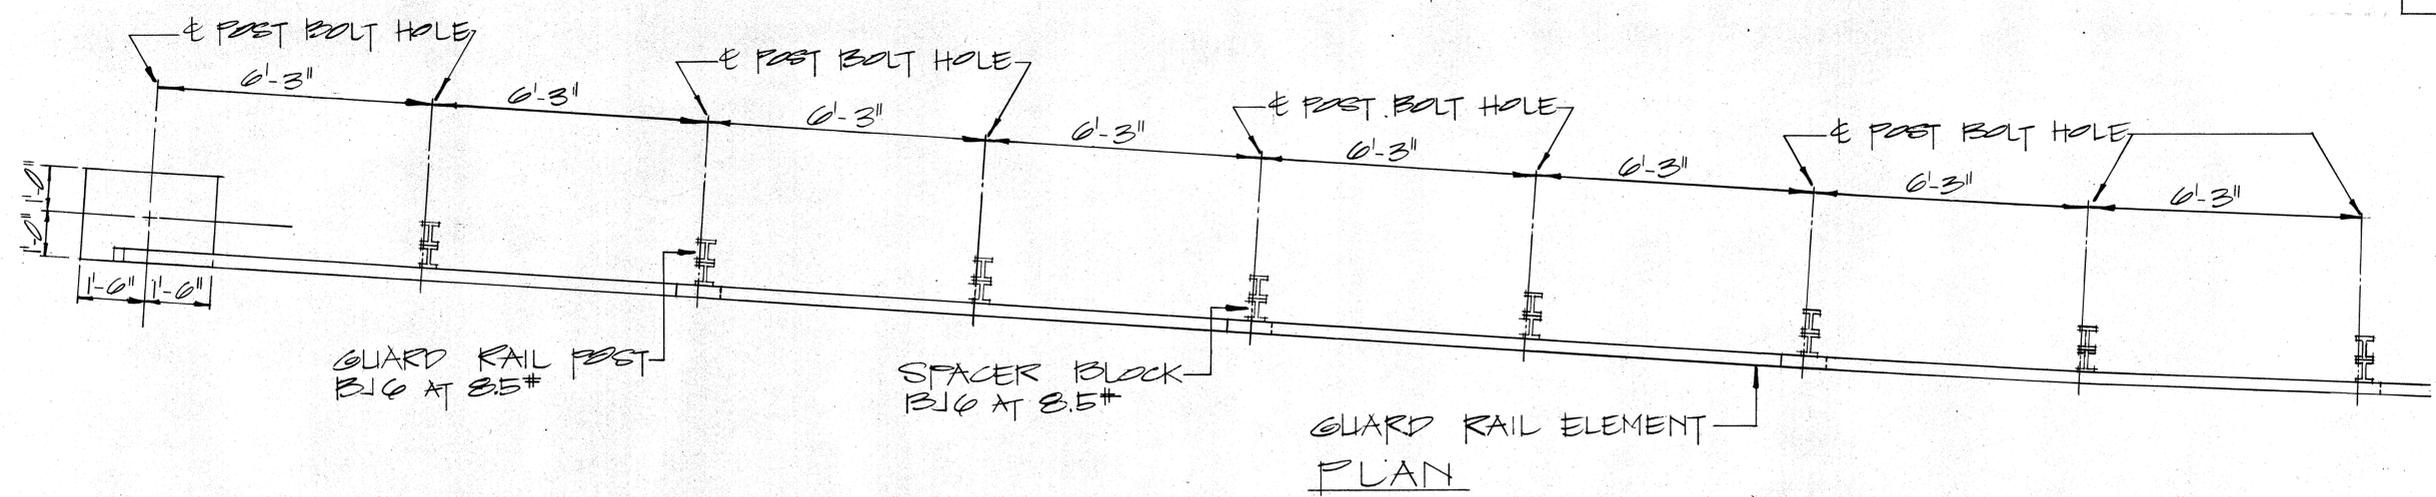


RAMP END ANCHORAGE  
SCALE: 1/2" = 1'-0"

2-5/8" x 7/4" LONG BOLTS, w/ NUTS & WASHERS INCIDENTAL TO METAL GUARD RAIL. ALL METAL PIECES SHALL BE GALVANIZED.

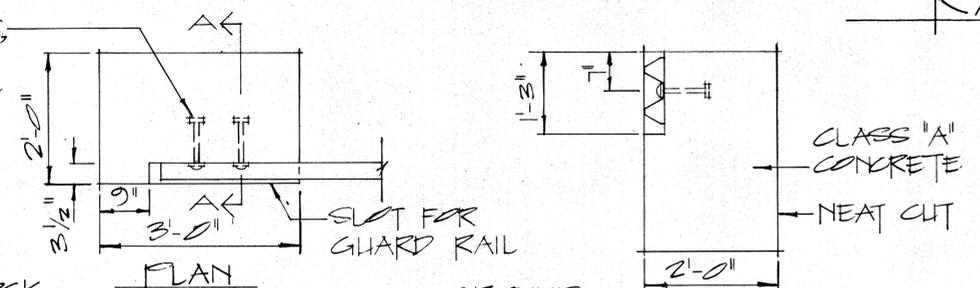

TOP OF ANCHOR BLOCK TO BE FLUSH w/ GROUND.

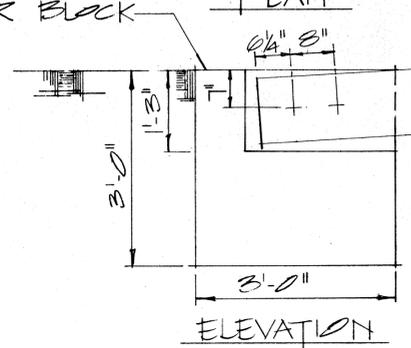

NOTE: CONCRETE, EXCAVATION AND MISCELLANEOUS APPURTENANCES NECESSARY TO ANCHOR THE GUARD RAIL ENDS, SHALL BE INCIDENTAL TO THE METAL GUARD RAIL.

CONCRETE ANCHOR BLOCK  
SCALE: 3/4" = 1'-0"

APPROVAL RECOMMENDED:  
*Eishi Tanaka*  
TRAFFIC ENGINEER 12/29/69  
DATE

APPROVED:  
*John J. Sili*  
ASSISTANT CHIEF, ENGINEERING 12-30-69  
DATE

| NO. | REVISION | APPROVED BY | DATE |
|-----|----------|-------------|------|
|     |          |             |      |







STATE OF HAWAII  
DEPARTMENT OF TRANSPORTATION  
HIGHWAYS DIVISION

STANDARD DETAILS  
GUARD RAIL, TYPE 3  
RAMP END ANCHORAGE

SCALE: AS SHOWN

|                   |  |
|-------------------|--|
| DATE              |  |
| SURVEY PLOTTED BY |  |
| PLAN              |  |
| TRACED BY         |  |
| DESIGNED BY       |  |
| NOTE BOOK         |  |
| QUANTITIES BY     |  |
| CHECKED BY        |  |
| No.               |  |

|       |           |             |           |              |
|-------|-----------|-------------|-----------|--------------|
| STATE | PROJ. NO. | FISCAL YEAR | SHEET NO. | TOTAL SHEETS |
| HAW.  | 10BC-0171 | 1973        | 48        | 51           |

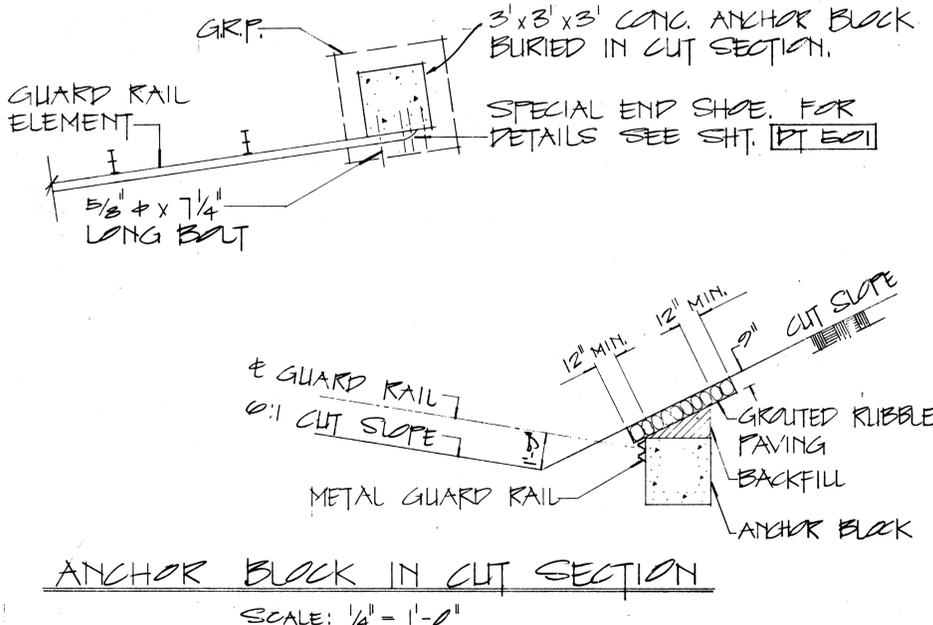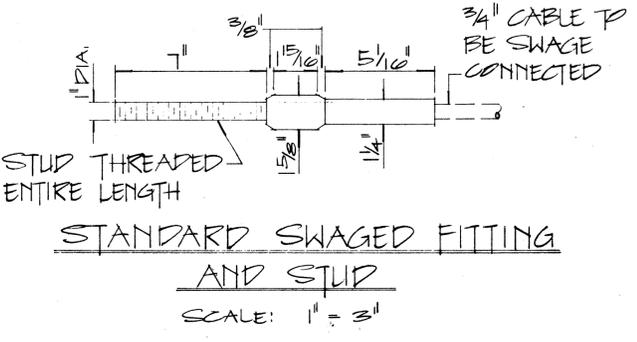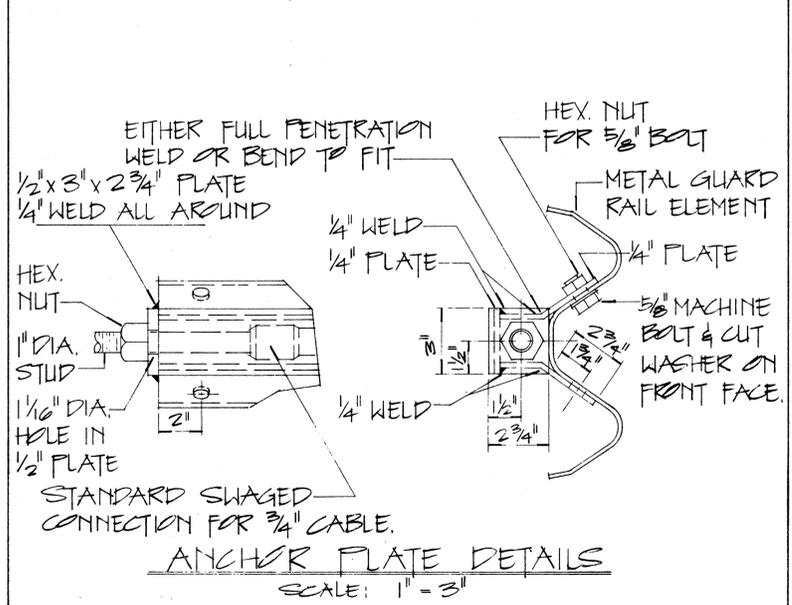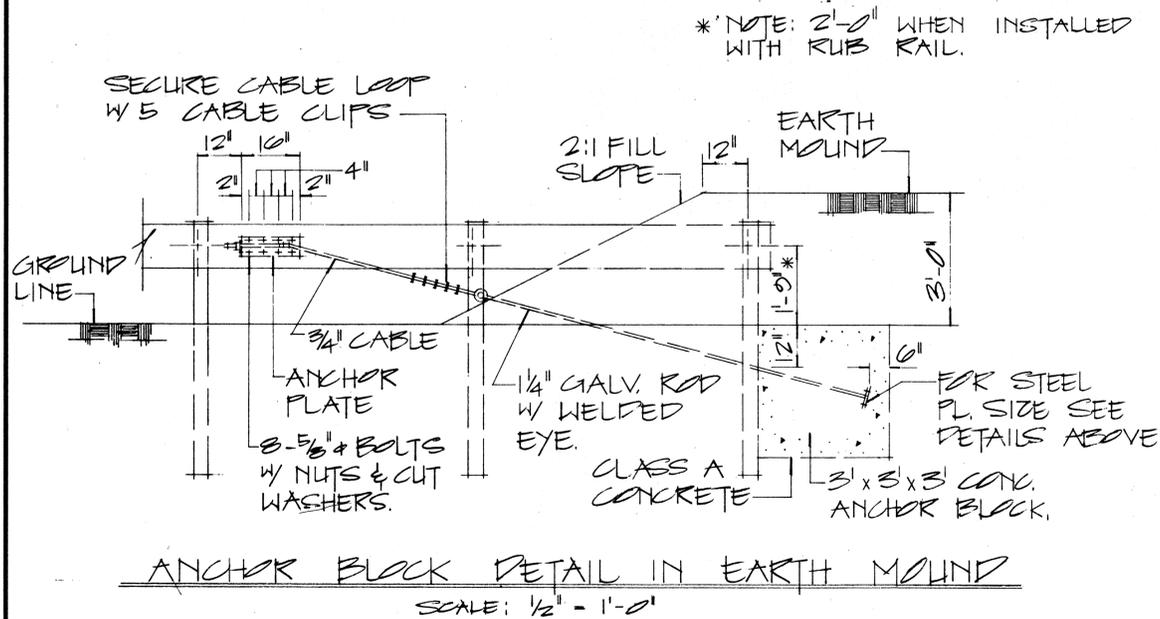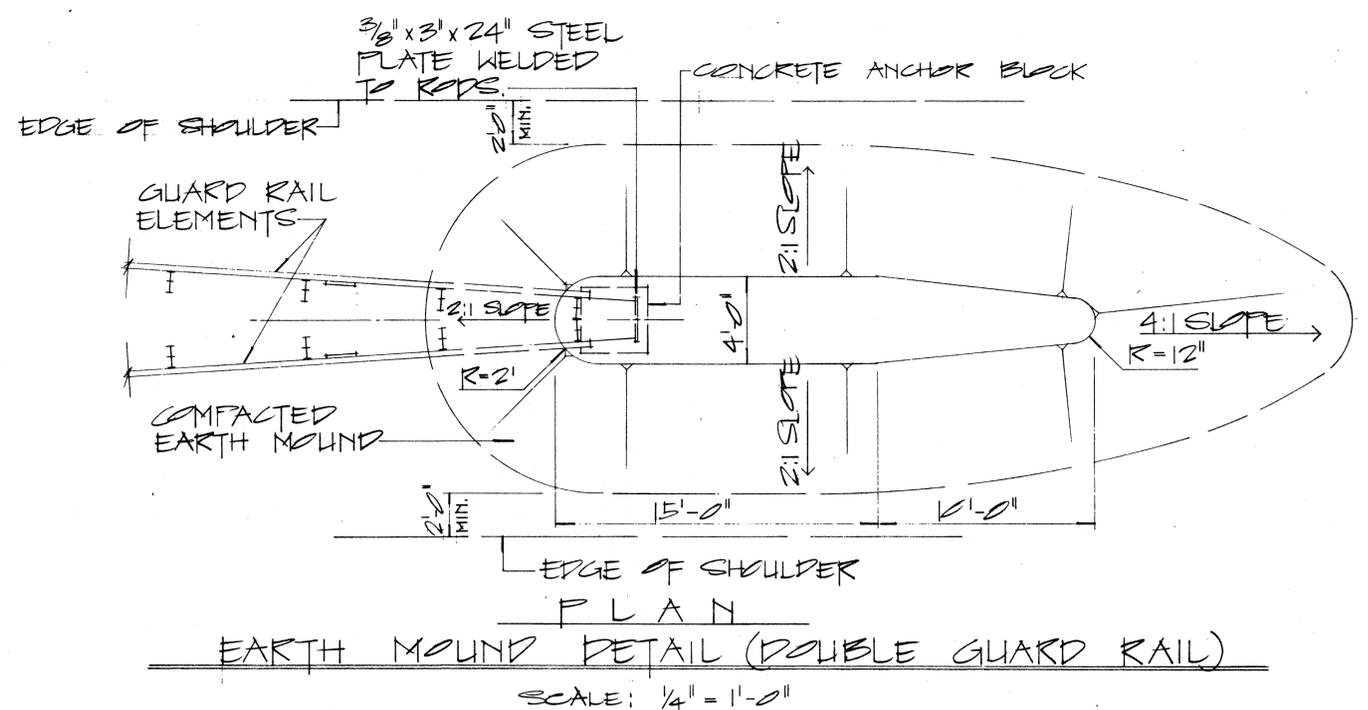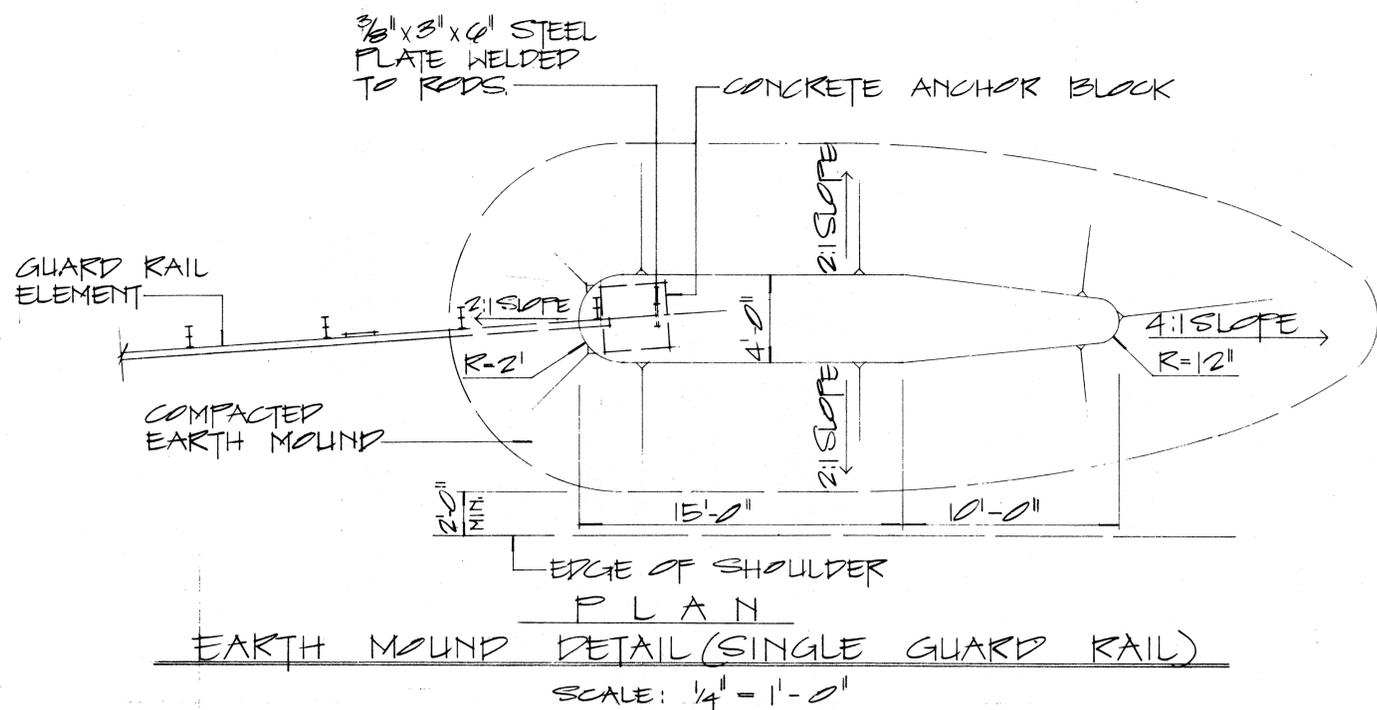

APPROVAL RECOMMENDED:  
*Eiichi Tanaka* 12/29/62  
 TRAFFIC ENGINEER DATE

APPROVED:  
*[Signature]* 12-30-69  
 ASSISTANT CHIEF, ENGINEERING DATE

| NO. | REVISION | APPROVED BY | DATE |
|-----|----------|-------------|------|
|     |          |             |      |


STATE OF HAWAII  
 DEPARTMENT OF TRANSPORTATION  
 HIGHWAYS DIVISION

STANDARD DETAILS  
EARTH MOUND AND  
ANCHOR BLOCK DETAILS

SCALE: AS SHOWN 2/19/60

DATE: \_\_\_\_\_  
 DRAWN BY: \_\_\_\_\_  
 DESIGNED BY: \_\_\_\_\_  
 CHECKED BY: \_\_\_\_\_


|                     |       |                    |             |           |              |
|---------------------|-------|--------------------|-------------|-----------|--------------|
| FED. ROAD DIST. NO. | STATE | FED. AID PROJ. NO. | FISCAL YEAR | SHEET NO. | TOTAL SHEETS |
| HAWAII              | HAW.  | 19BC-01-71         | 1973        | 49        | 51           |

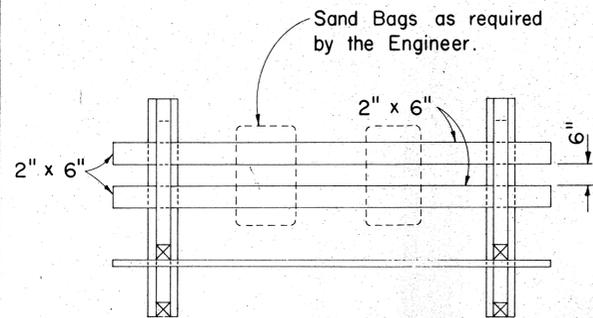

PLAN VIEW

**GENERAL NOTES**


1. The Contractor shall construct, install and maintain the wood barricades at the locations shown on the Plans.
2. The permanent wood barricades shall be left in place or relocated upon completion of the project as ordered by the Engineer and are to become State property.
3. The orange and white stripes shall slant downward toward the side on which traffic is to pass and shall be reflectorized.

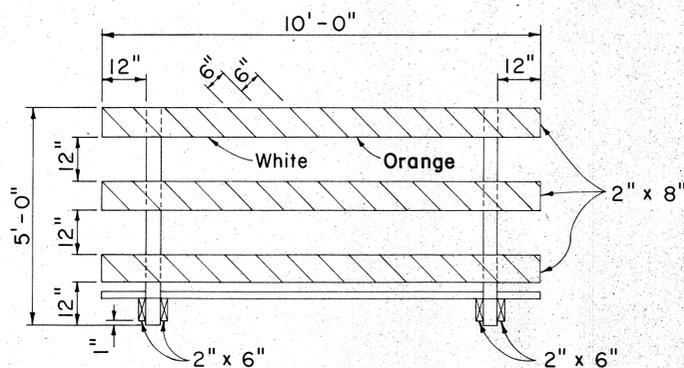


FRONT VIEW

**CLASS I BARRICADE**

Scale: 1/2" = 1'-0"

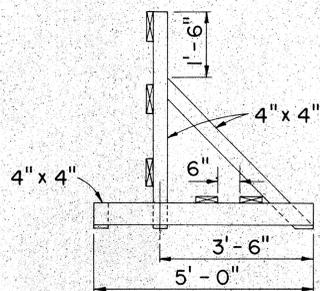


END VIEW

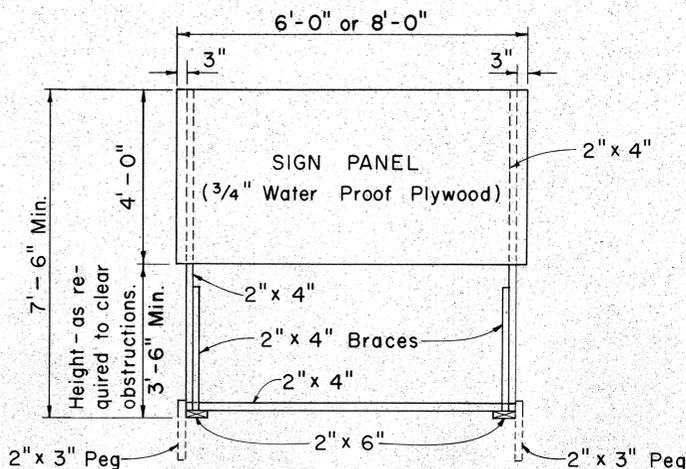

FRONT VIEW


Scale: 1/2" = 1'-0"

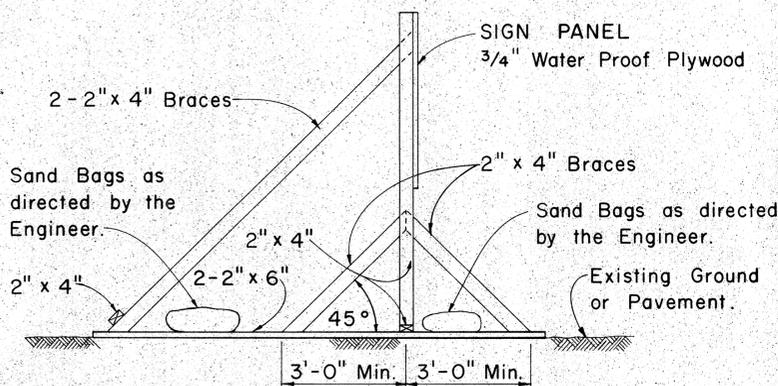


SIDE VIEW

(SIGN FRAME WEIGHTED DOWN)

Scale: 1/2" = 1'-0"

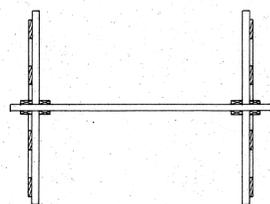


PLAN VIEW

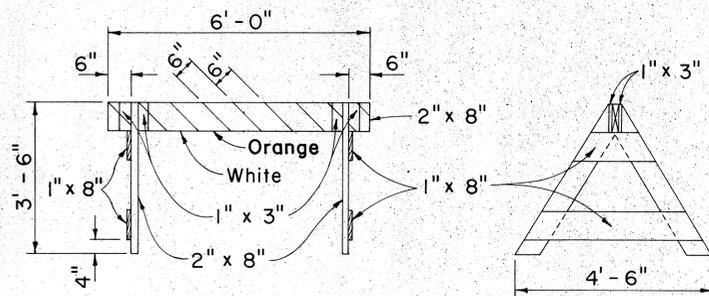


FRONT VIEW

**CLASS II BARRICADE**

Scale: 1/2" = 1'-0"

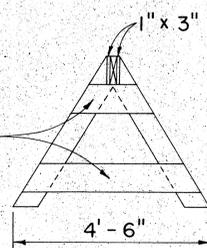

END VIEW

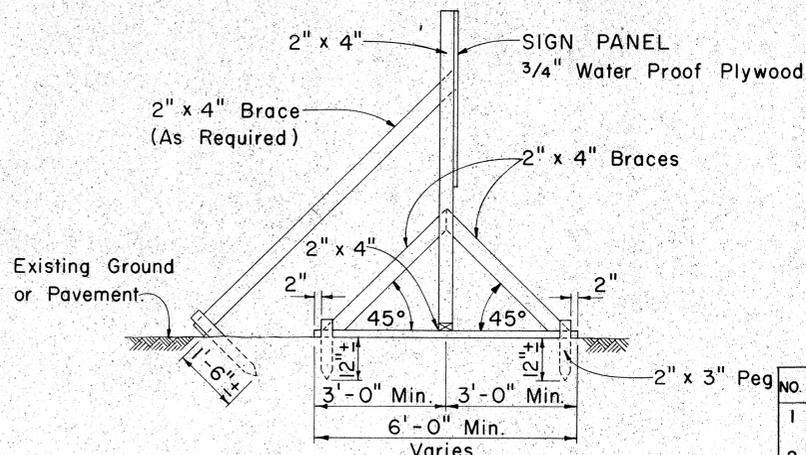


SIDE VIEW

(SIGN FRAME ANCHORED IN GROUND)

Scale: 1/2" = 1'-0"

**CONSTRUCTION IDENTIFICATION SIGN**


Scale: As Shown

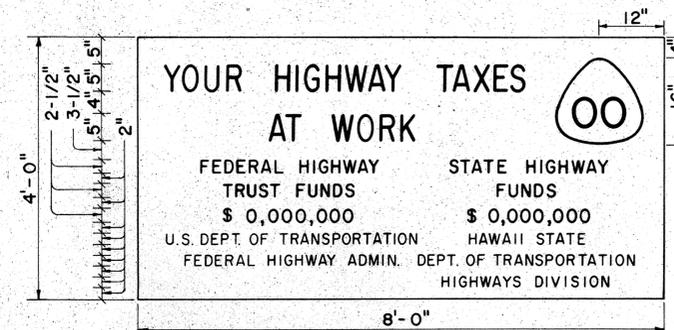

SIGN PANEL

**PRIMARY AND SECONDARY SYSTEMS**

Scale: 3/4" = 1'-0"

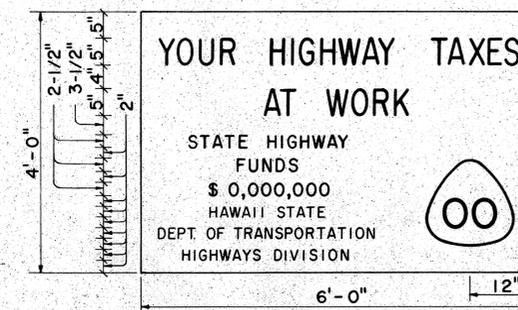

SIGN PANEL

**NON-FEDERAL AID PROJECT**

Scale: 3/4" = 1'-0"

**GENERAL NOTES**

1. The sign legend shall be black on white background.
2. The Contractor shall construct, install and maintain the project signs at the locations shown on the plans and as ordered by the Engineer.
3. Letters shall be Series "C" of the sizes shown on the plan and shall conform to the FHWA publication "Standard Alphabets for Highway Signs," 1966.
4. The Contractor shall fill in the proper numerals in place of ciphers as ordered by the Engineer.
5. For State Route Marker detail, see sht. DT 209. Include 1/2" black border around edge of marker.

APPROVAL RECOMMENDED:

*Eishi Tanaka* 12/29/69  
TRAFFIC ENGINEER DATE

APPROVED:

*John S. Sabin* 12/29/69  
ASSISTANT CHIEF, ENGINEERING DATE

| No. | REVISION                            | APPROVED BY | DATE     |
|-----|-------------------------------------|-------------|----------|
| 1   | Delete "Bureau of Public Roads"     | H.T.        | 9-29-70  |
| 2   | Add Note No.3 for Barricades        | H.T.        | 5-4-71   |
| 3   | Revise Route Marker                 | H.T.        | 4-12-72  |
| 4   | Revise stripe color for Barricades. | H.T.        | 10-21-72 |

STATE OF HAWAII  
DEPARTMENT OF TRANSPORTATION  
HIGHWAYS DIVISION  
**STANDARD DETAILS**  
CONSTRUCTION IDENTIFICATION SIGN  
AND  
WOOD BARRICADES

Scale: As Shown

SHEET No. 19 OF 19 SHEETS DT 1801