



Grated drain inlet filter shall be "Dandy Sack" Sediment Insert by Dandy Products, Inc. or pre-approved equal.



FILTER AT GRATED DRAIN INLET

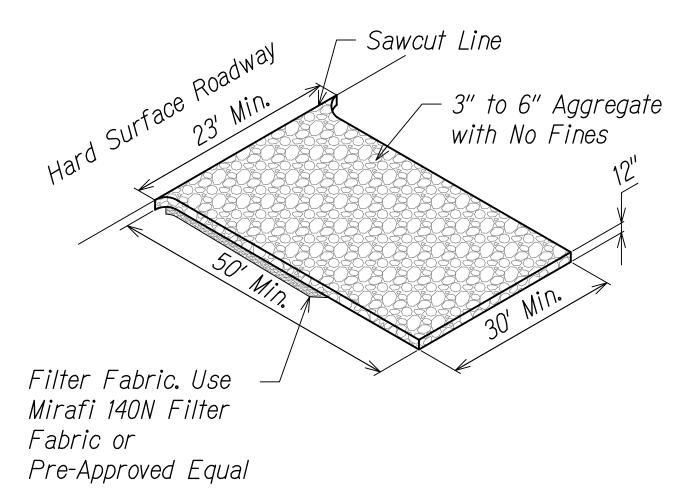


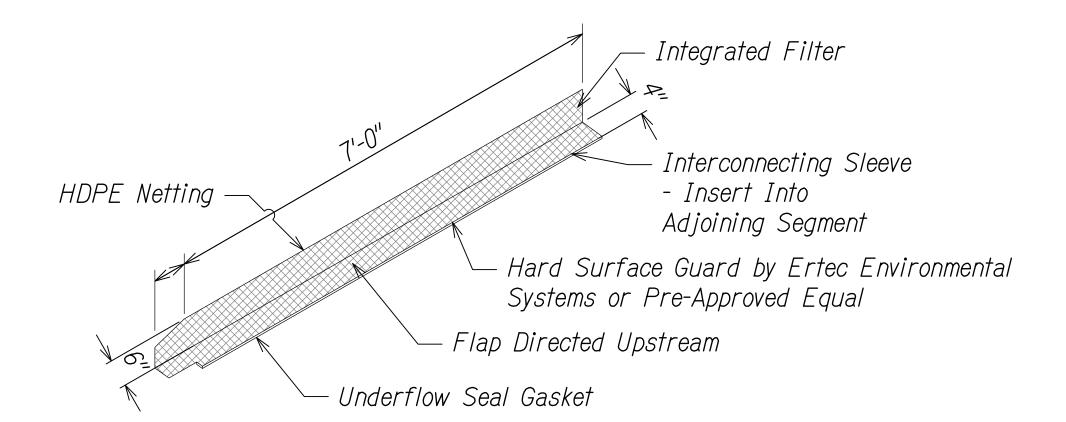



TEMPORARY DUST CONTROL MEASURES:


- The project site that is cleared shall be kept damp for (7) seven days a week. At the end of each day, the site shall be sufficiently dampened so that the site will remain moistened during the night.
- 2. The Contractor shall conduct his operations so that demolition, excavation, embankment, and imported material shall be dampened to prevent dust problems.

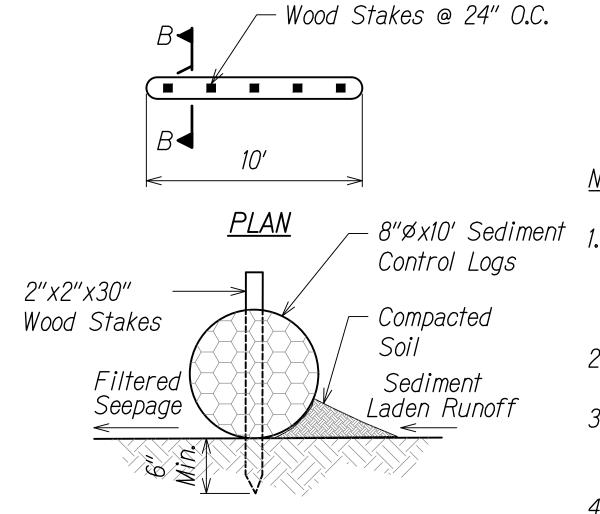

SECTION "B" 3 SEDIMENT CONTROL LOG
Not to Scale FED. ROAD DIST. NO. FED. AID PROJ. NO. FISCAL YEAR SHEET NO. STATE | HSIP-011-1(045) | 2023 | 88 HAWAII

NOTES:

- Stake sediment logs in place with 2"x2"x30" wood stakes space no less than 24" apart unless otherwise noted. Drive stakes into ground a minimum of 6".
- 2. Staking shall be installed per manufacturer's recommendations.
- 3. Minimum overlap of sediment control logs shall be 1' on the horizontal plane.
- Install sediment control logs directly on ground making sure bottom of log is in full contact with ground. Tamp soil backfill against upstream side of log to assure storm water is forced flow through log rather than under it.

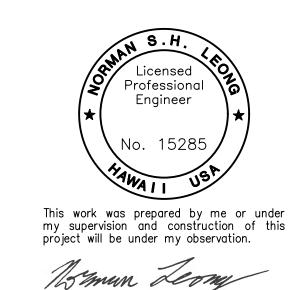


STATE OF HAWAII **DEPARTMENT OF TRANSPORTATION** HIGHWAYS DIVISION

EROSION CONTROL DETAILS

MAMALAHOA HIGHWAY SAFETY IMPROVEMENTS

Federal-Aid Project No. HSIP-011-1(045) Scale: NTS

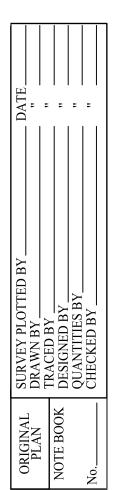

Vicinity of Haleili Street and Bruner Road Date: September 2023 SHEETS SHEET No. OF *1*