

GENERAL NOTES

1. The scope of work for this project consists of constructing HMA pavement, installing guardrail, milled pavement rumble strip, pavement marking and signing.
2. The Contractor is reminded of the requirements of Subsection 108.01 - Subletting of Contract, which requires him to perform work to not less than 30 percent of the total contract cost less deductible items. Non-compliance with this Subsection may be grounds for rejection of bid.
3. The Contractor's attention is directed to the following Sections: Subsection 104.11 - Utilities and Services; Subsection 107.06 - Contractor Duty Regarding Public Convenience; and Section 645 - Work Zone Traffic Control.
4. At the end of each day's work, the Contractor shall remove all equipment and other obstructions to permit free and safe passage of public traffic.
5. The existence and location of underground utilities, manholes, monuments and structures as shown on the plans are from the latest available data, but the accuracy is not guaranteed. The encountering of other obstacles during the course of work is possible. The Contractor shall tone for the exact locations and depths of all underground facilities, either shown on or omitted from the plans, in areas where work, such as the placement of sign posts, traffic signal conduits, etc. may affect these properties. Toning shall be considered incidental to the various contract items and will not be paid for separately. The Contractor shall be held liable for any damages incurred to the existing facilities and/or improvements as a result of his operations.
6. The Contractor shall notify the Engineer in writing, two (2) weeks prior to starting construction operations.
7. The Contractor shall indemnify and be solely responsible for the protection of adjacent properties, utilities and existing structures from damages due to construction. Repairing any damage shall be at the Contractor's own expense, to the satisfaction of the Engineer.
8. Existing drainage system will be functional at all times during construction. The Contractor shall furnish materials, equipment, labor, tools and incidentals necessary to maintain flow. This work shall be considered incidental to any culvert work or the various contract items and will not be paid for separately.
9. Earth swale shall be graded to drain. This work shall be considered incidental to various contract items.
10. Smooth riding connections shall be constructed at all limits of project, including the beginning and end of project, connecting approaches, side streets, walkways and driveways as shown on the plans and/or as directed by the Engineer. This work shall be considered incidental to asphalt concrete and will not be paid for separately.
11. The Contractor shall clean and remove any accumulation of aggregates along the roadside within 10 feet of the edge of pavement. This work shall be considered incidental to bulk of work or the various contract items and will not be paid for separately.
12. Removal and disposal of existing curb and gutter, curb, sidewalk and asphalt concrete pavement, curb, sidewalk and any debris shall be considered incidental to their respective bid items.
13. All saw cutting work shall be considered incidental to Roadway Excavation or Asphalt Concrete or Various Contract Items or their respective bid items.
14. Prior to placement of new aggregate subbase course, the existing subbase shall be compacted to a relative compaction greater than or equal to 95%.
15. The top of the Plant Mix Glassphalt Concrete Base Course prior to placement of the new A.C. Pavement, Mix No. IV shall comply with the ten-foot straight edge requirement. The variation of the surface from a straight edge with two contacts with the surface, shall not exceed 3/16."
16. Concrete sidewalk shall be reinforced with 6x6 W1.4xW1.4 welded wire fabric.
17. Dressing of sidewalk shall consist of clearing and grubbing, grading, reshaping and compacting with suitable material the area adjacent to the improvement as shown on the plans and/or as directed by the Engineer and shall be considered incidental to Sidewalk.
18. All curbing angle points within the curb ramps shall be rounded with R=6."
19. All guardrail post shall be 6.0 feet long except as noted on plans.
20. The Contractor shall provide and maintain for access to and from all existing driveways, sidewalks and ADA access routes, and side streets and cross streets at all times. This work shall be considered incidental to curb ramps, or sidewalk, or the various contract items and will not be paid for separately.
21. The Contractor shall provide and maintain a temporary pedestrian-safe and easily accessible route or detour with barricades in or near the work zone. This temporary route or detour shall be paved at least an inch of Asphalt Concrete Pavement, Mix No V or steel and/or wood planks and shall be American With Disabilities Act (ADA) compliant [This is only applicable if existing surface is dirt and/or if existing surface is non-ADA compliant]. This work shall be incidental to curb ramps, or sidewalk, or the various contract items and will not be paid for separately.
22. Provide smooth transition where new sidewalk construction meets the existing grade or sidewalk. Transition shall not be steeper than 2% cross and longitudinal slopes and not less 6.0 feet long or as specified on the plans. This work shall be considered incidental to curb ramps, or sidewalk, or the various contract items and will not be paid for separately.
23. The Contractor shall remove and dispose of all existing raised pavement markers, thermoplastic line markings, traffic tapes, and epoxy adhesives prior to the overlaying of Asphalt Concrete. This work shall be considered incidental to Asphalt Concrete Pavement, Mix No. IV and will not be paid for separately.
24. No material and/or equipment shall be stockpiled or otherwise stored within the highway right-of-way except at locations designed in writing and approved by the Engineer.
25. The Contractor shall provide and maintain a smooth transition with no drop offs between travel lanes during non-working hours. If pavement is not complete, a 6:1 wedge may be used for transition, at no increase in contract price or contract time.
26. The Contractor must shield shoulder drop offs with Type II Barricades if exposed during non-working hours.

FED. ROAD DIST. NO.	STATE	FED. AID. PROJ. NO.	FISCAL YEAR	SHEET NO.	TOTAL SHEETS
HAWAII	HAW.	HSIP-011-2(37)	2009	ADD. 3	34

LEGEND

	Reconstruction Areas
	Leveling Areas
	Cold Planing Areas
	Resurfacing Limits
	Existing Electrical Line
	New Electrical Line
	Existing Joint Pole
	Existing Power Pole
	Existing Electric Manhole
	Adjusted Elec. MH Frame/Cover
	New Electric Manhole
	Existing Telephone Line
	New Telephone Line
	Existing Telephone Pole
	Existing Telephone Manhole
	Adjusted Tele. MH Frame/Cover
	New Telephone Manhole
	Existing Signal Corps Line
	New Signal Corps Line
	Existing TV Cable
	New TV Cable
	Existing Sandwich Isles Communication Line
	Existing 12" Water Line
	New 12" Water Line
	Existing Water Manhole
	Adjusted Water MH Frame/Cover
	New Water Manhole
	Existing Water Air Valve
	Adjusted Water Air Valve
	New Water Air Valve
	Existing Water Valve Box
	Adjusted Water Valve Box
	New Water Valve Box
	Existing Water Meter
	Adjusted Water Meter
	New Water Meter
	Existing Fire Hydrant
	New Fire Hydrant

9/15/09 Revised General Note 19.
Added Notes 25 and 26.

DATE REVISION

STATE OF HAWAII
DEPARTMENT OF TRANSPORTATION
HIGHWAYS DIVISION

GENERAL NOTES & LEGEND

MAMALAHOA HIGHWAY

SAFETY IMPROVEMENTS

Vicinity of Kiolakaa Homestead

Federal Aid Project No. HSIP-011-2(37)





Date: September 2009

SHEET No. 1 OF 1 SHEETS

ADD. 3

ORIGINAL PLAN SURVEY PLOTTED BY _____ DATE X
DRAWN BY _____ DRAWN BY _____ DATE X
TRACED BY _____ QUANTITIES BY _____ CHECKED BY _____ DATE X
NOTE: BOOK 102 PAGE 1000
REINFORCING LISTS

FED. ROAD DIST. NO.	STATE	FED. AID PROJ. NO.	FISCAL YEAR	SHEET NO.	TOTAL SHEETS
HAWAII	HAW.	HSIP-011-2(37)	2009	ADD. 6	34

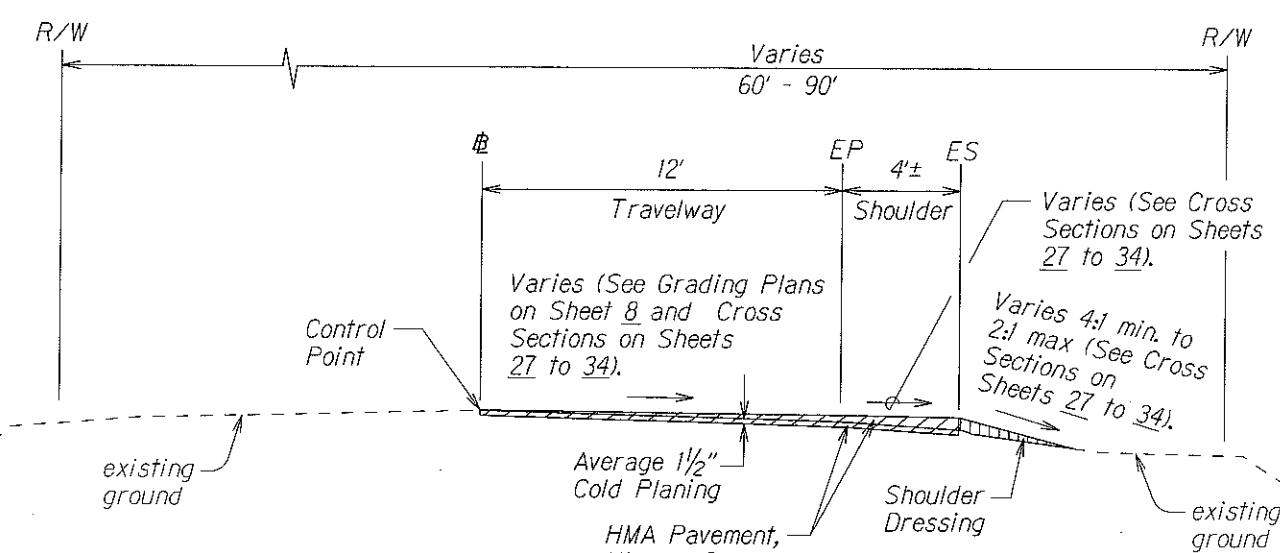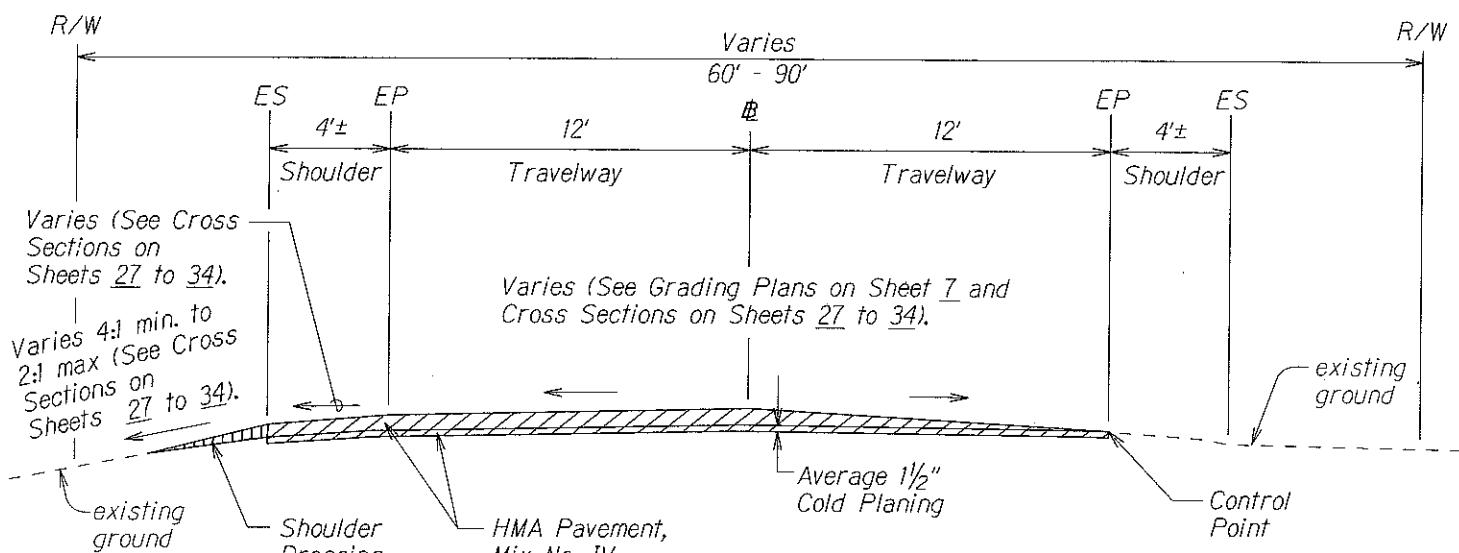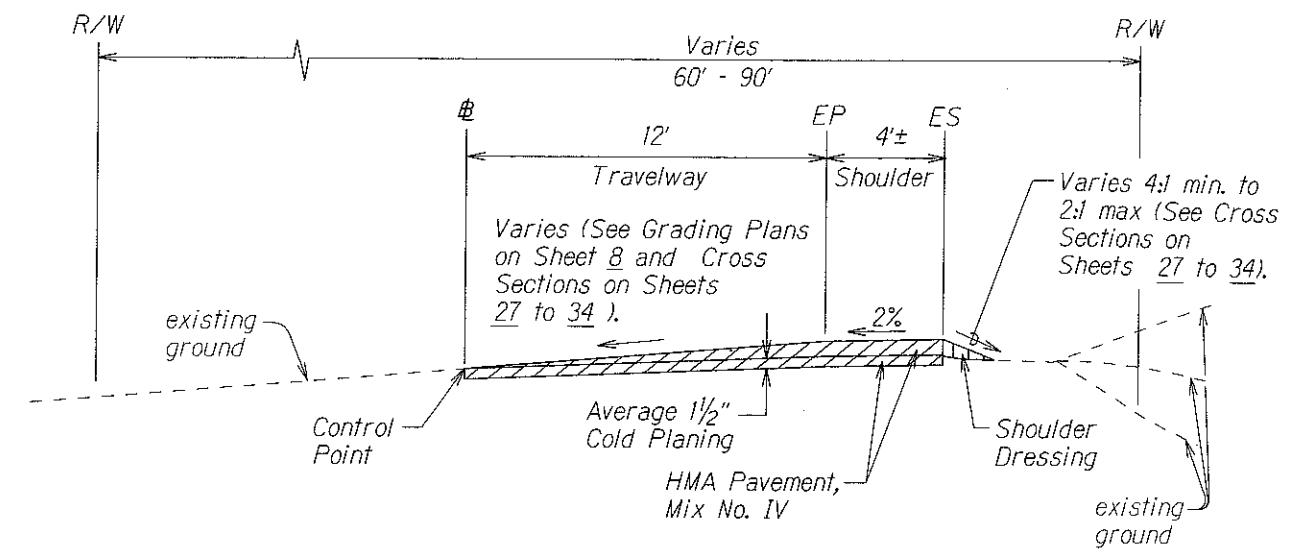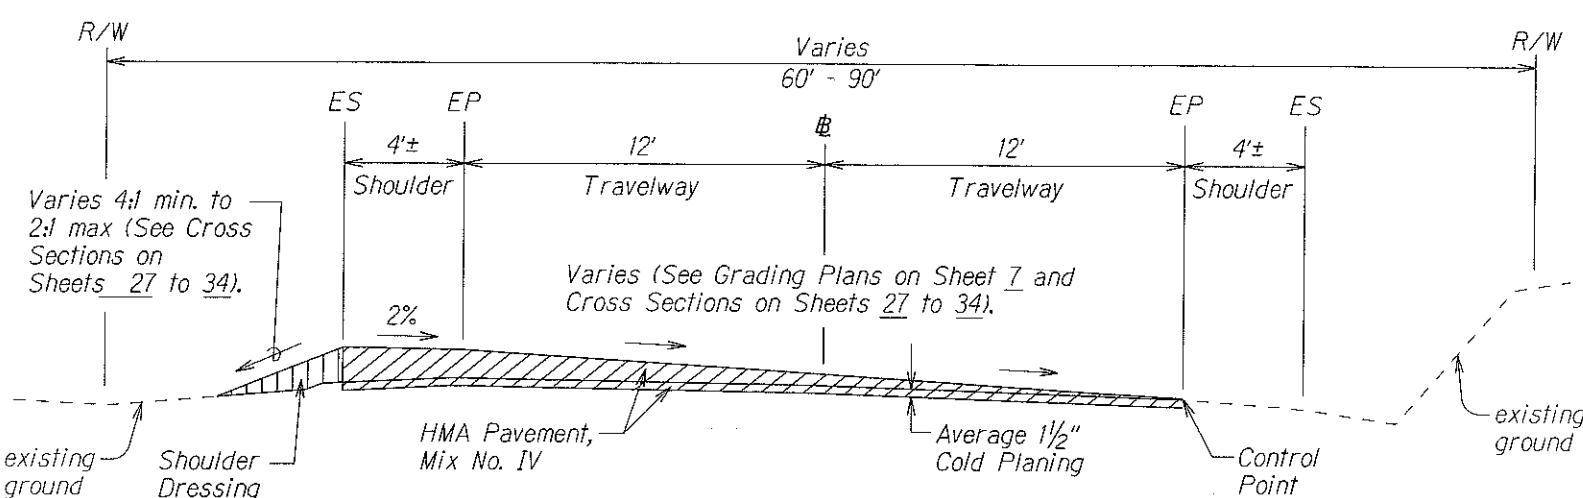

Notes:

1. Shoulder dressing shall be considered incidental to Item No. 401.0100 - HMA Pavement, Mix No. IV.
2. The Contractor shall provide and maintain a smooth transition with no drop offs between travel lanes during non-working hours. If pavement is not completed, a 6:1 wedge may be used for transition, at no increase in contract price or contract time.
3. The Contractor must shield shoulder drop offs with Type II Barricades if exposed during non-working hours.

9/15/09 Added Notes.
Revised Shoulder Slope.
Revised Stationing for each Typical Section.

DATE	REVISION
------	----------

STATE OF HAWAII
DEPARTMENT OF TRANSPORTATION
HIGHWAYS DIVISION

TYPICAL SECTIONS


MAMALAHOA HIGHWAY
SAFETY IMPROVEMENTS
Vicinity of Kiolakaa Homestead Road
Federal-Aid Project No. HSIP-011-2(37)

Scale: NTS Date: September 2009


SHEET No. 1 OF 1 SHEETS

FED. ROAD DIST. NO.	STATE	FED. AID PROJ. NO.	FISCAL YEAR	SHEET NO.	TOTAL SHEETS
HAWAII	HAW.	HSIP-011-1(37)	2009	ADD. 7	34

COLD PLANE AREA FOR HMA GRADE ADJUSTMENT

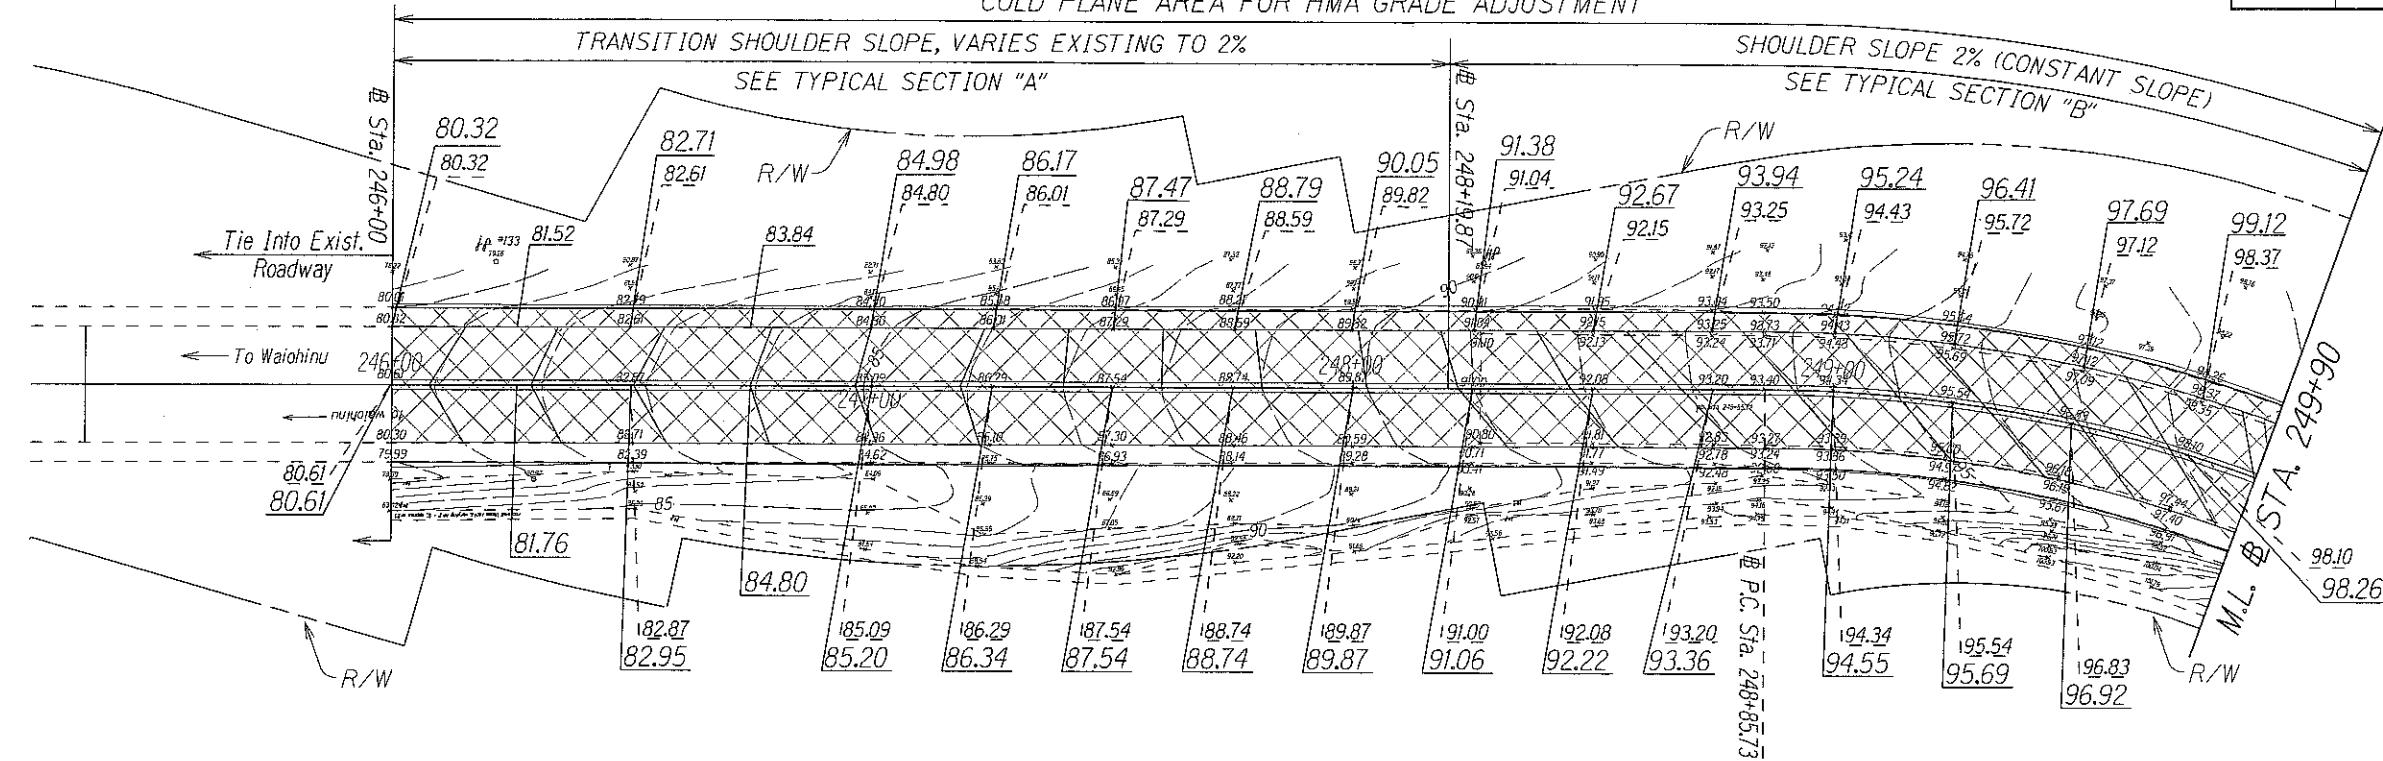

COLD PLANE AREA FOR HMA GRADE ADJUSTMENT

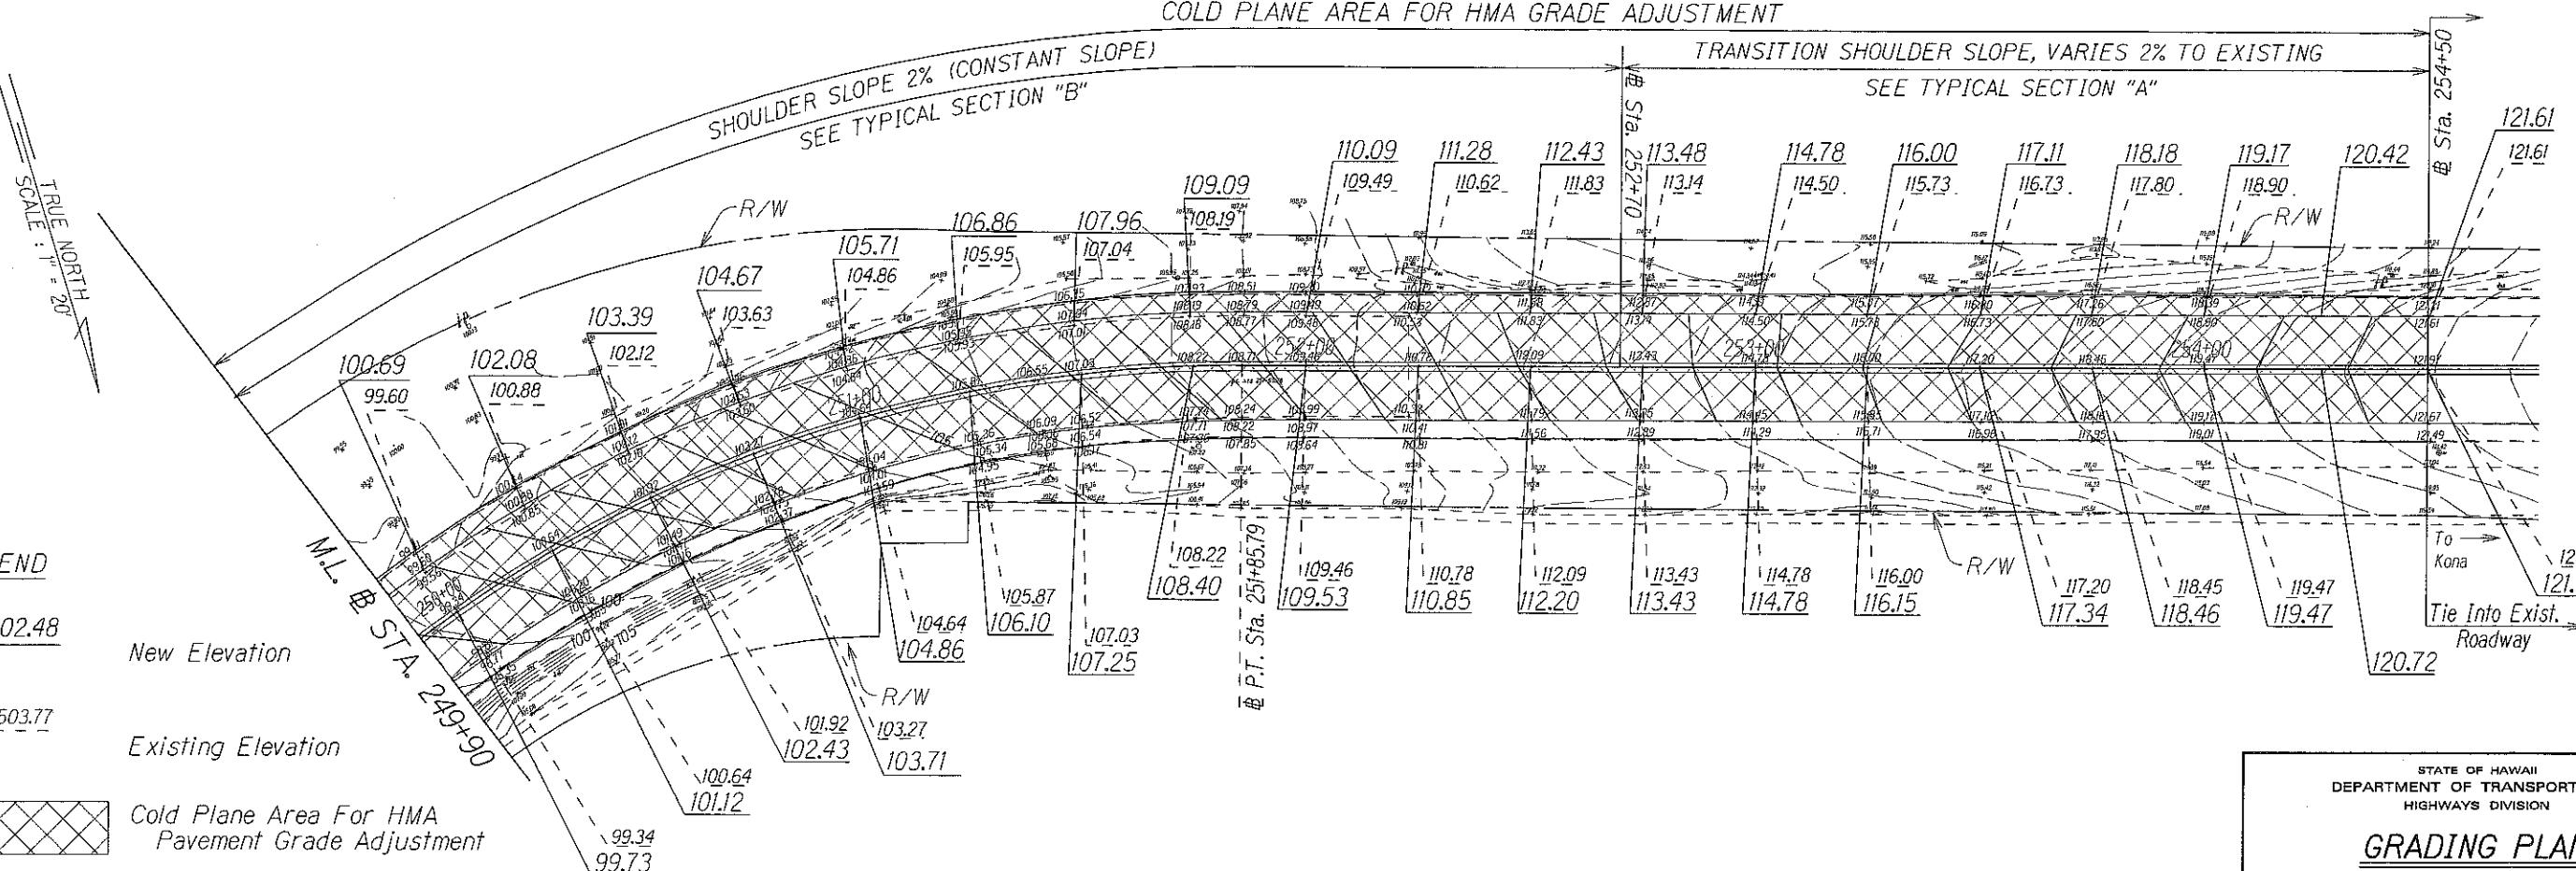

NOTE:

Shoulder Dressing Shall Be Considered
Incidental to Item No. 401.0100 - HMA
Pavement, Mix No. IV.

9/15/09 Revised Shoulder Slope.
Revised Shoulder Slope Stationing.
Deleted Right Shoulder Hatching.

DATE REVISION

STATE OF HAWAII
DEPARTMENT OF TRANSPORTATION
HIGHWAYS DIVISION

GRADING PLAN

MAMALAHOA HIGHWAY

SAFETY IMPROVEMENTS


Vicinity of Kiolakaa Homestead Road
Federal Aid Project No. HSIP-011-1(37)

Scale: 1"=20'
Date: September 2009

SHEET No. 1 OF 2 SHEETS

ADD. 7

FED. ROAD DIST. NO.	STATE	FED. AID PROJ. NO.	FISCAL YEAR	SHEET NO.	TOTAL SHEETS
HAWAII	HAW.	HSIP-011-2(37)	2009	ADD. 12	34

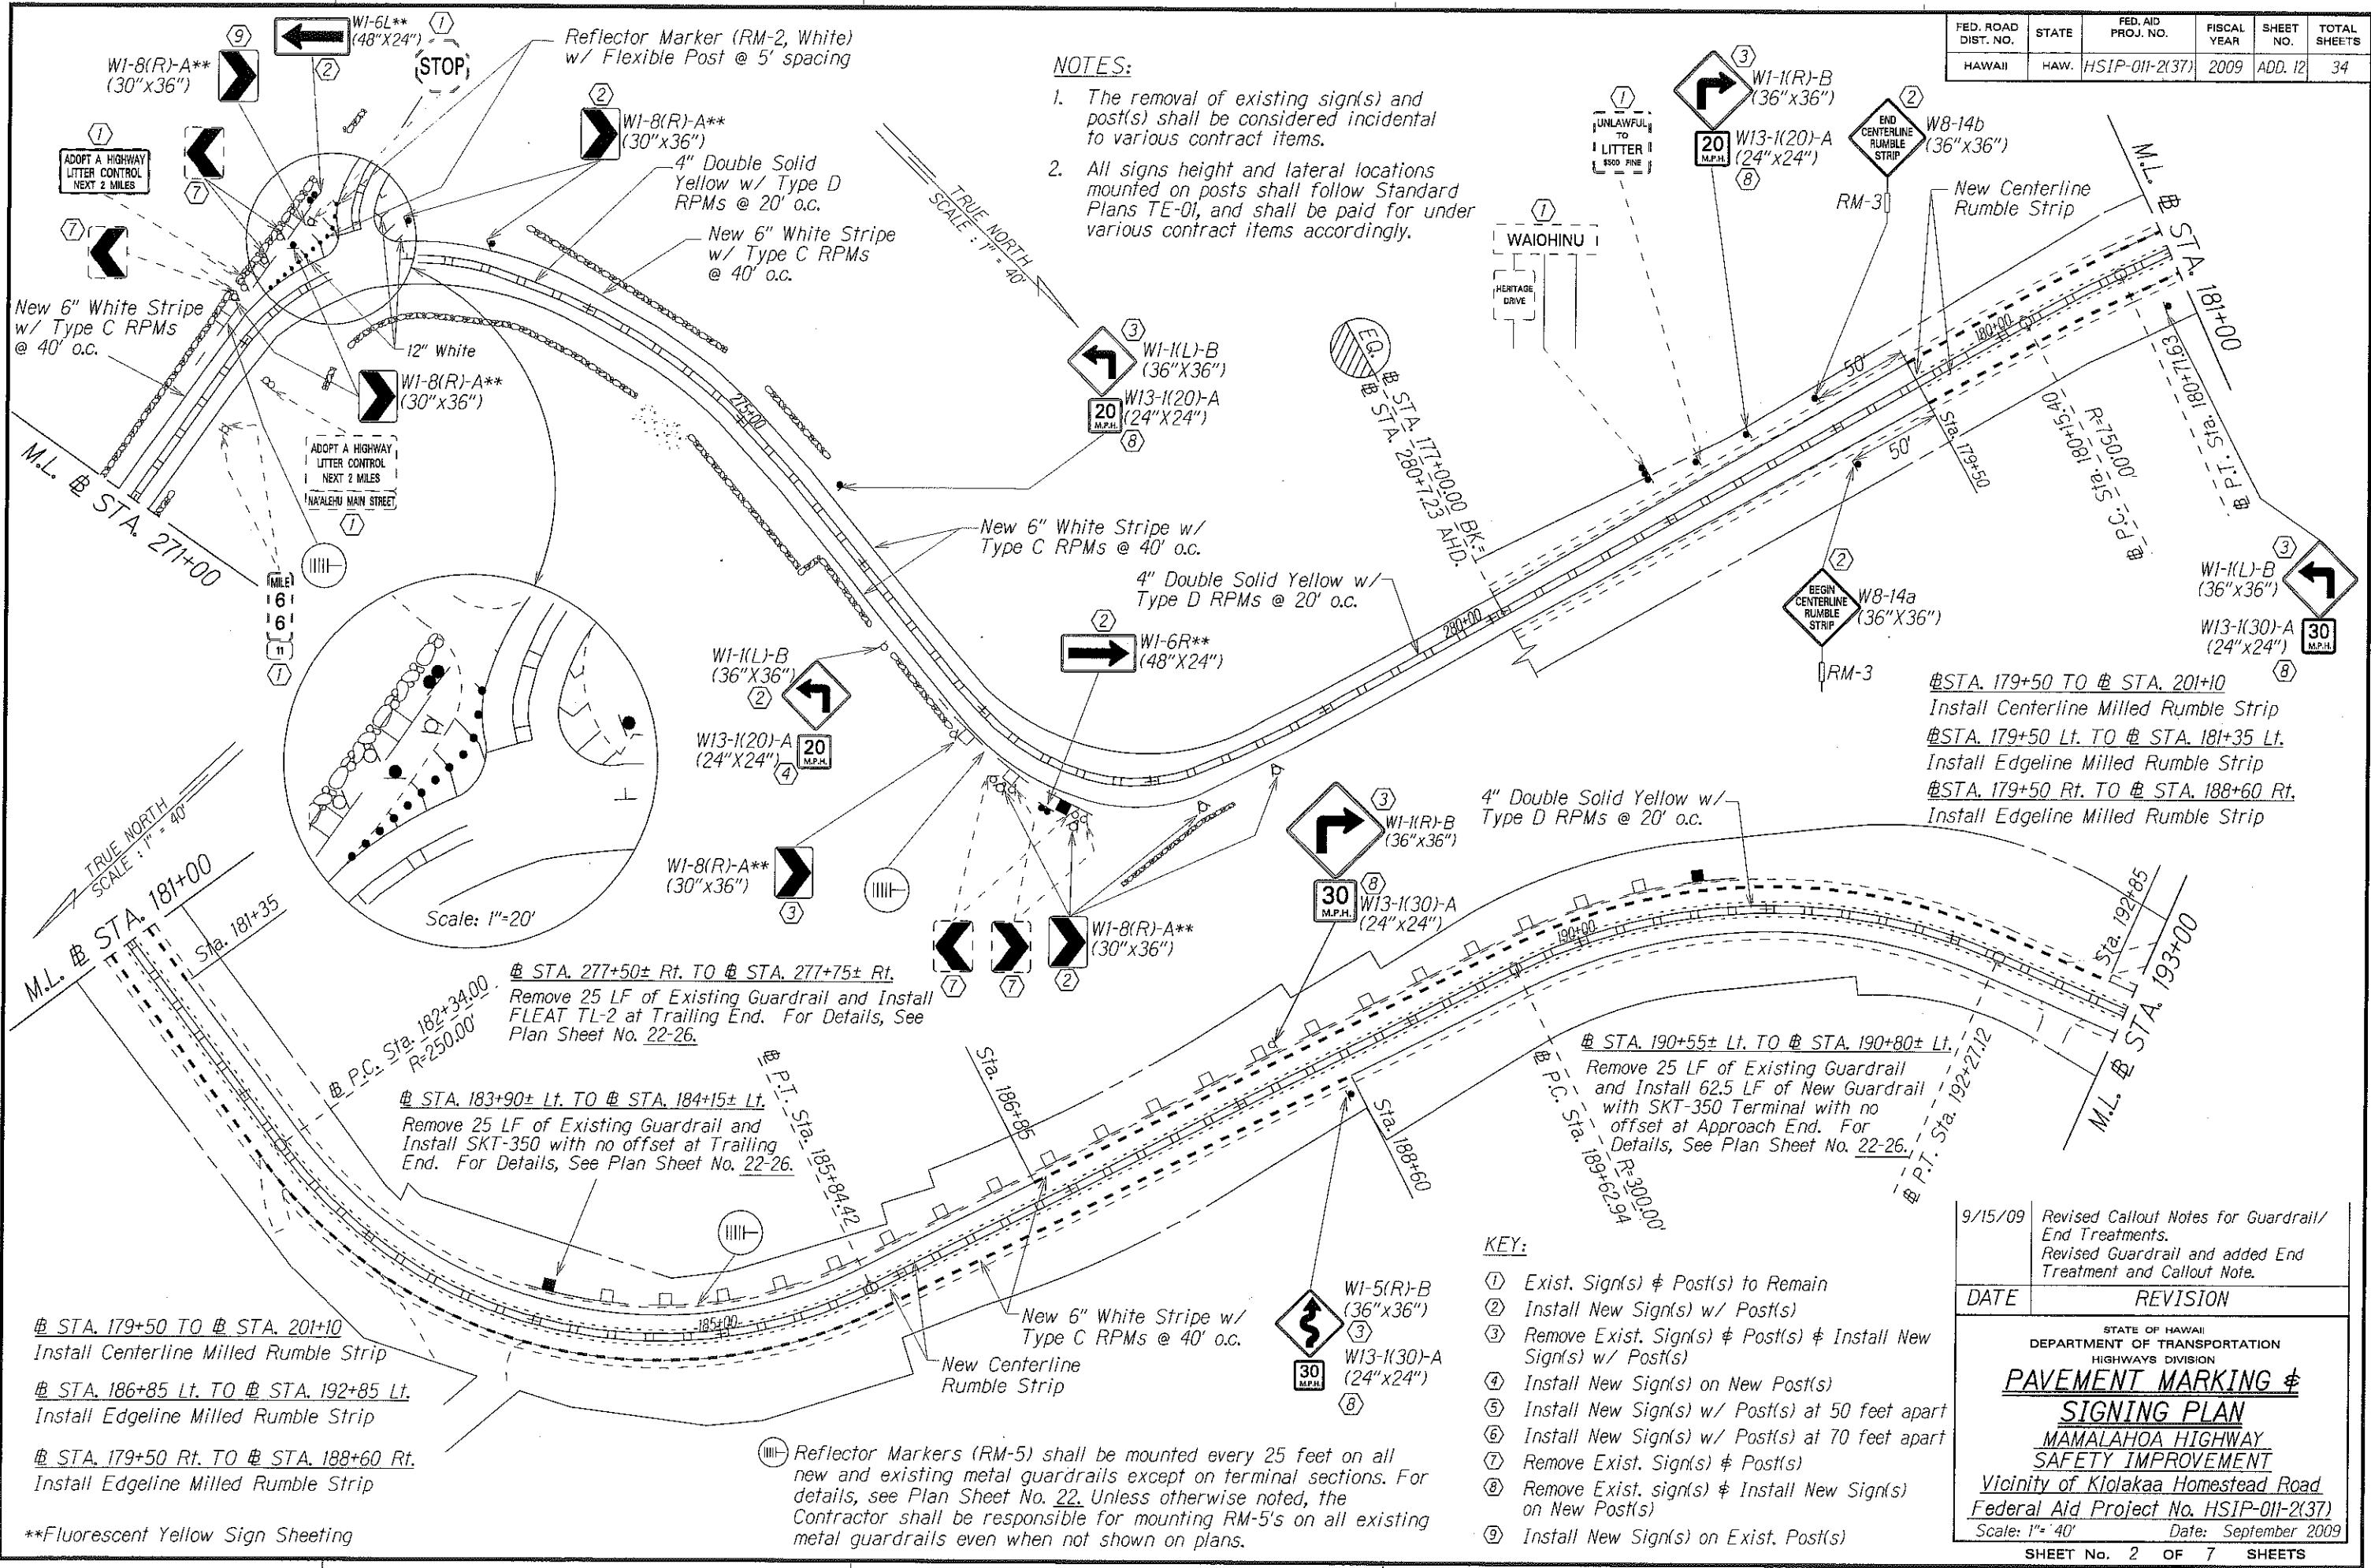

9/15/09 Revised Callout Notes for Guardrail/End Treatments.
Revised Guardrail and added End Treatment and Callout Note.

DATE REVISION

STATE OF HAWAII
DEPARTMENT OF TRANSPORTATION
HIGHWAYS DIVISION

PAVEMENT MARKING & SIGNING PLAN


MAMALAHOA HIGHWAY
SAFETY IMPROVEMENT

Vicinity of Kiolakaa Homestead Road
Federal Aid Project No. HSIP-011-2(37)

Scale: 1" = 40' Date: September 2009

SHEET NO. 2 OF 7 SHEETS

FED. ROAD DIST. NO.	STATE	FED. AID PROJ. NO.	FISCAL YEAR	SHEET NO.	TOTAL SHEETS
HAWAII	HAW.	HSIP-011-2(37)	2009	ADD. 16	34

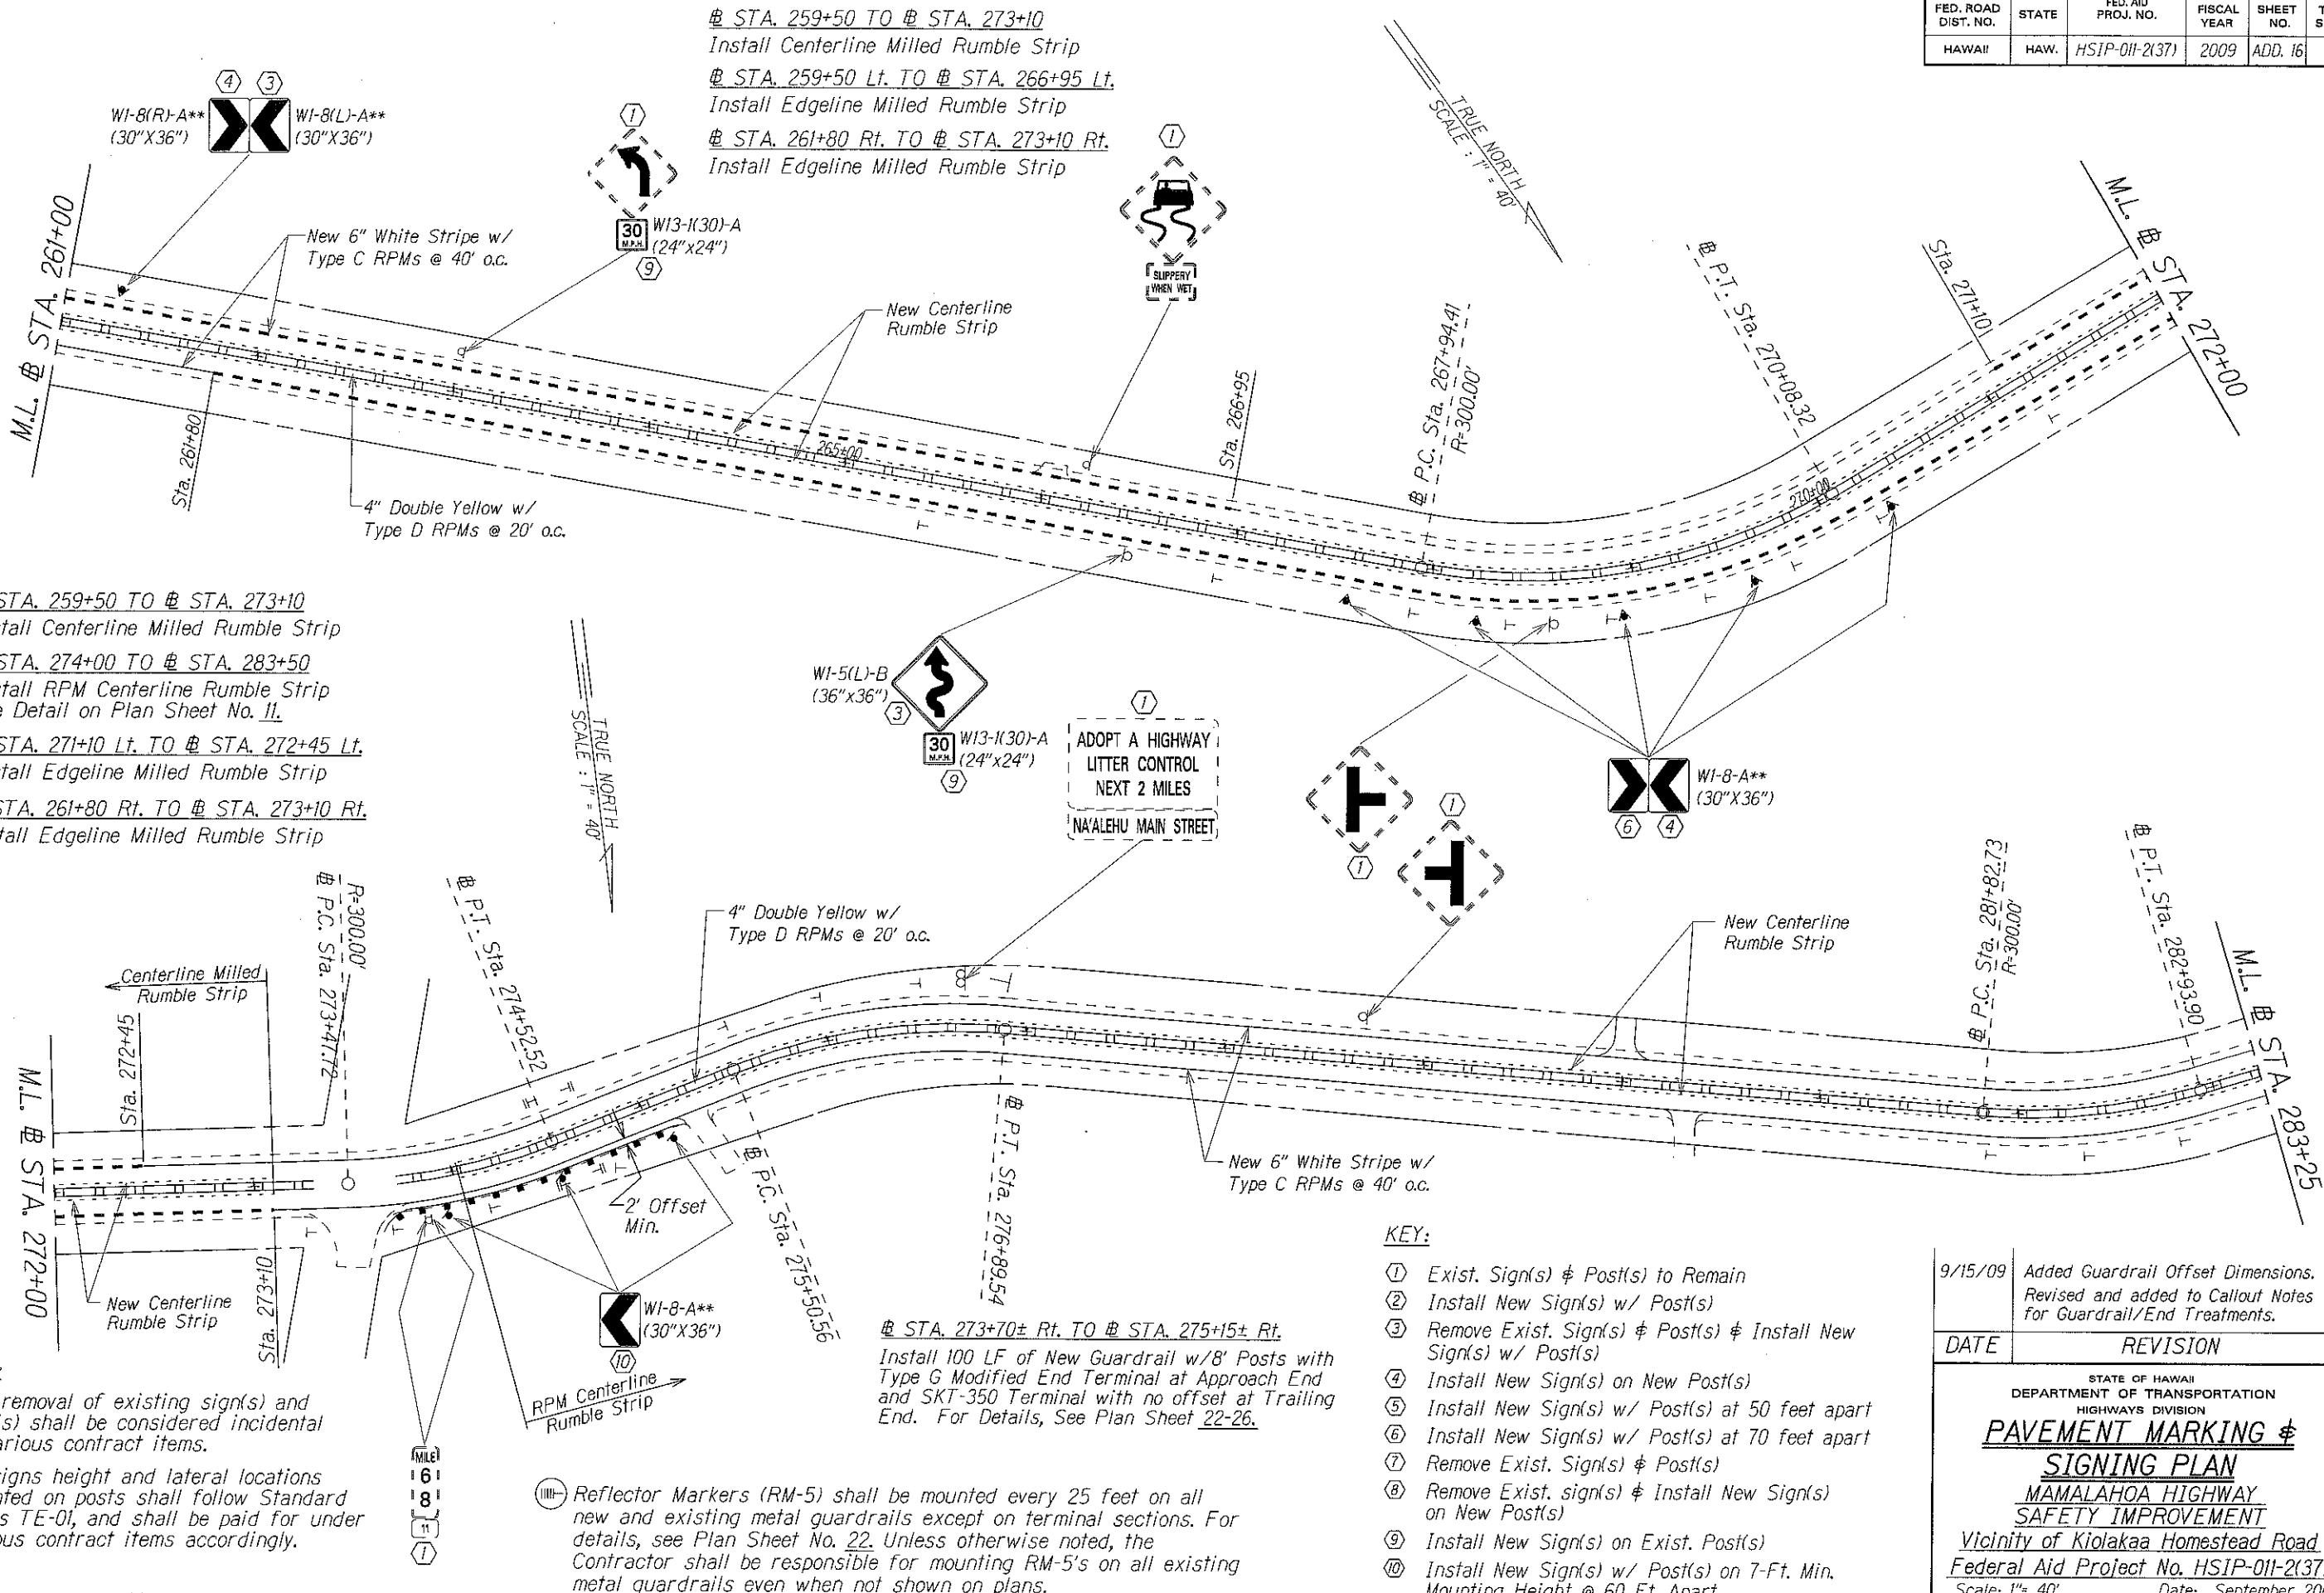

9/15/09 Added Guardrail Offset Dimensions.
Revised and added to Callout Notes
for Guardrail/End Treatments.

DATE REVISION

STATE OF HAWAII
DEPARTMENT OF TRANSPORTATION
HIGHWAYS DIVISION

PAVEMENT MARKING &

SIGNING PLAN

MAMALAHOA HIGHWAY

SAFETY IMPROVEMENT

Vicinity of Kiolakaa Homestead Road

Federal Aid Project No. HSIP-011-2(37)


Scale: 1" = 40' Date: September 2009

SHEET NO. 6 OF 7 SHEETS

FED. ROAD DIST. NO.	STATE	FED. AID PROJ. NO.	FISCAL YEAR	SHEET NO.	TOTAL SHEETS
HAWAII	HAW.	HSIP-011-2(37)	2009	ADD. 22	34

GENERAL NOTES


- All hardware, posts and fasteners shall be hot-dip zinc coated galvanized after fabrication. No punching, drilling or cutting will be permitted after galvanizing.
- Where conditions require, special post lengths in increments of 6 inches may be specified.
- All fasteners, posts, and rail elements (i.e. FBB03, PWE01, RWM02b, etc.) shall conform to the latest edition and amendments of "A Guide to Standardized Highway Barrier Rail Hardware", a report prepared and approved by the AASHTO-AGC-ARTBA Joint Cooperative Committee, Subcommittee On New Highway Materials, Task Force 13 Report. Dimensions of fasteners, posts and rail elements have been converted from metric units into their present form.
- The Recycled Plastic Block or Offset Block shall be approved by the State.
- All new guardrail systems (system consists of total length of guardrail including both end treatments) shall include the Additional Paved Area.
- After the guardrail posts are installed in the paved area, the Contractor shall fill/seal around each guardrail post and all cracks in the paved area caused during the guardrail post installation. If required by the inspector/engineer, the Contractor shall tamper the paved area around the guardrail post prior to filling/sealing. All costs associated with this work shall not be paid for separately, but shall be considered incidental to the various guardrail items.
- When standards for the fill slope area cannot be met, a site specific, engineer approved design may be used.
- New A.C. pavement at guardrails shall extend 6 feet longitudinally beyond terminal ends.
- Reflector Markers (RM-5) mounted on new guardrails shall be spaced every 25 feet. RM-5's shall not be installed on Terminal Sections. Furnishing and installing of each RM-5 shall be considered incidental to the adjacent guardrail system.
- Reflector Markers (RM-5) mounted on existing guardrails shall be spaced every 25 feet. RM-5's shall not be installed on Terminal Sections. Furnishing and installing of each RM-5 shall be considered incidental to Item No. 632.0200 - Reflector Marker (RM-5, White) Mounted on Existing Guardrail.

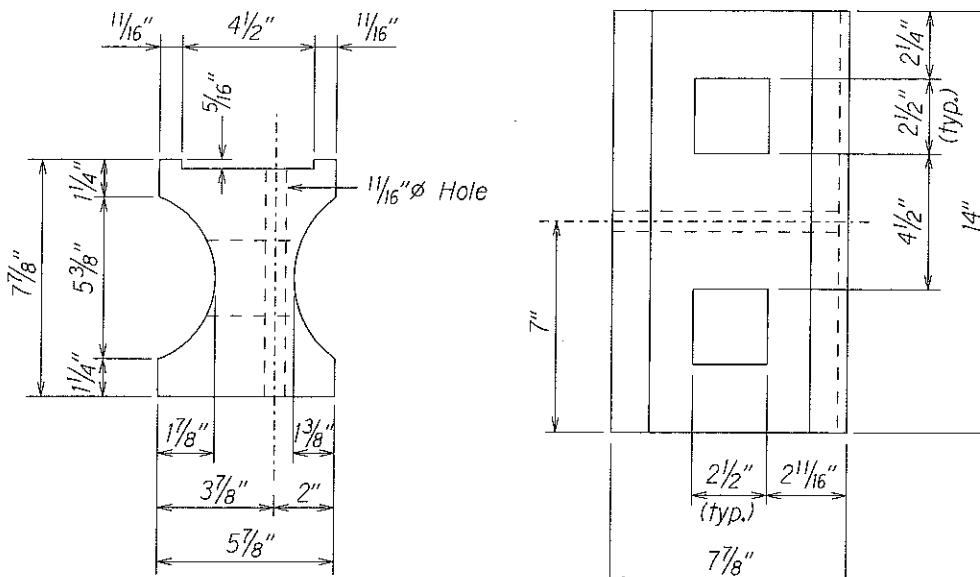

TOP

SIDE


RECYCLED PLASTIC BLOCKOUT (TYPE I)

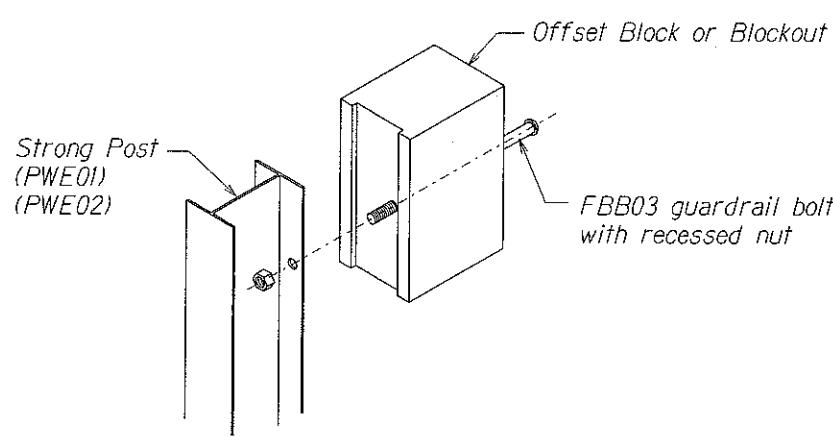


Exploded View

(Rail and washer not shown)



STEEL POST AND BLOCK DETAIL

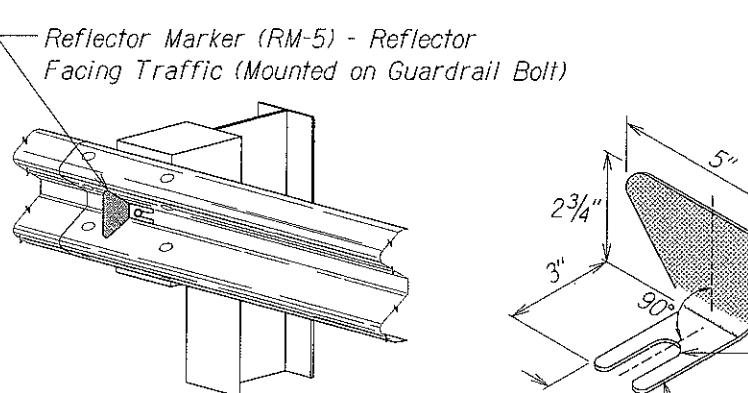

REFLECTOR MARKER (RM-5) DETAIL AND TYPICAL INSTALLATION

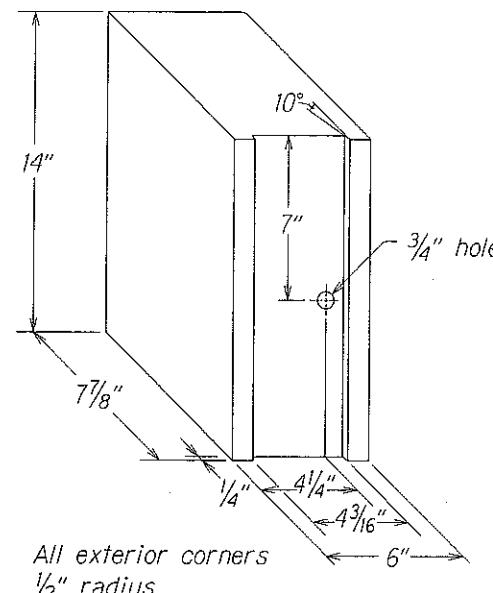

RECYCLED POLYETHYLENE OFFSET BLOCK (TYPE II)

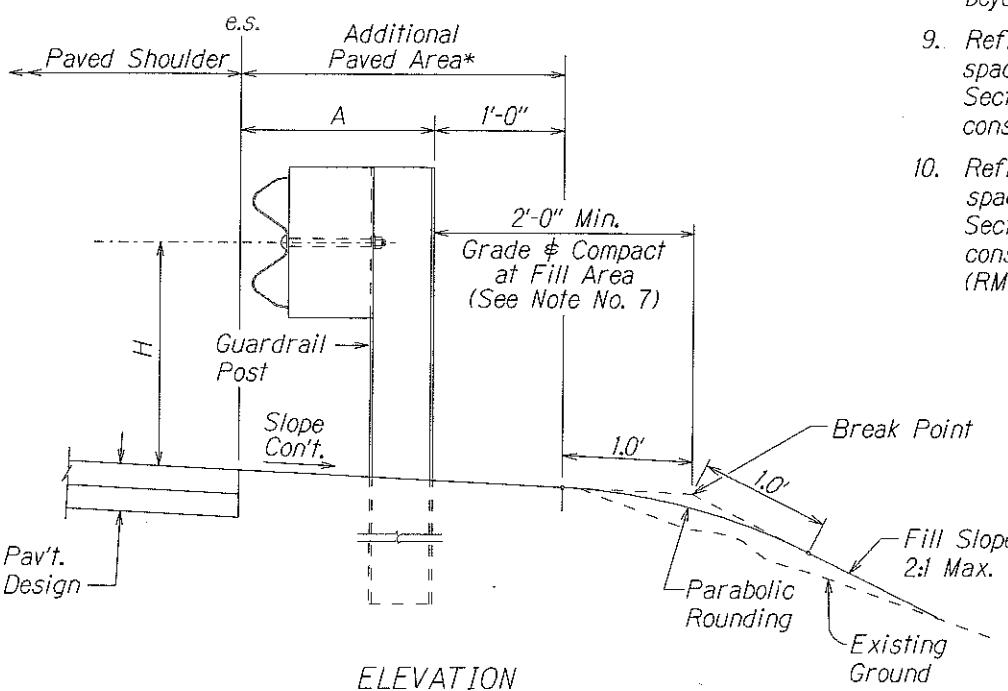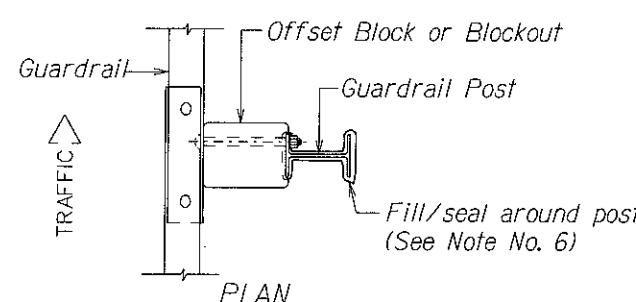

TYPICAL GUARDRAIL INSTALLATION


DATE	REVISED TYPICAL GUARDRAIL INSTALLATION (ELEVATION)
9/15/09	

DATE: September 2009


GUARDRAIL TYPE	DIMENSION	
	H	A
Strong Post W-Beam	1' 9 5/8"	1' 6"
Strong Post Rubrail (W-Beam)	2' 0"	1' 6"
Modified or Strong Post Thrie Beam	2' 0"	2' 0"

STATE OF HAWAII DEPARTMENT OF TRANSPORTATION HIGHWAYS DIVISION	
GUARDRAIL DETAILS & NOTES	
MAMALAHOA HIGHWAY SAFETY IMPROVEMENT Vicinity of Kiolakaa Homestead Road Federal Aid Project No. HSIP-011-2(37)	
Not to Scale	Date: September 2009
SHEET No. 1 OF 5 SHEETS	


FED. ROAD DIST. NO.	STATE	FED. AID PROJ. NO.	FISCAL YEAR	SHEET NO.	TOTAL SHEETS
HAWAII	HAW.	HSIP-011-2(37)	2009	ADD. 24	34

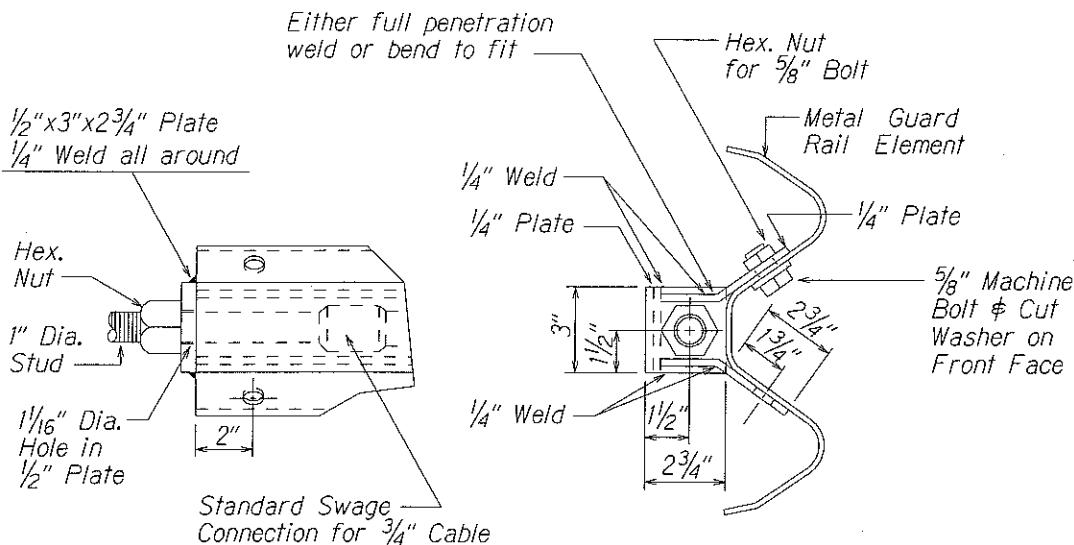

ANCHOR PLATE DETAILS

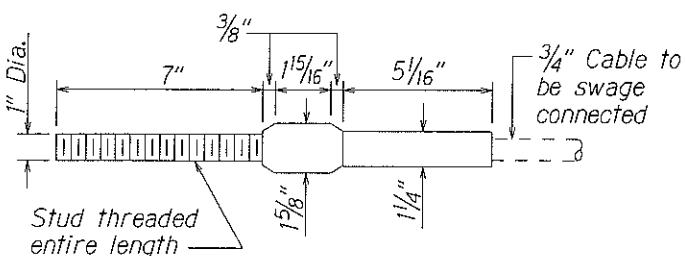


STANDARD SWAGED FITTING
AND STUD

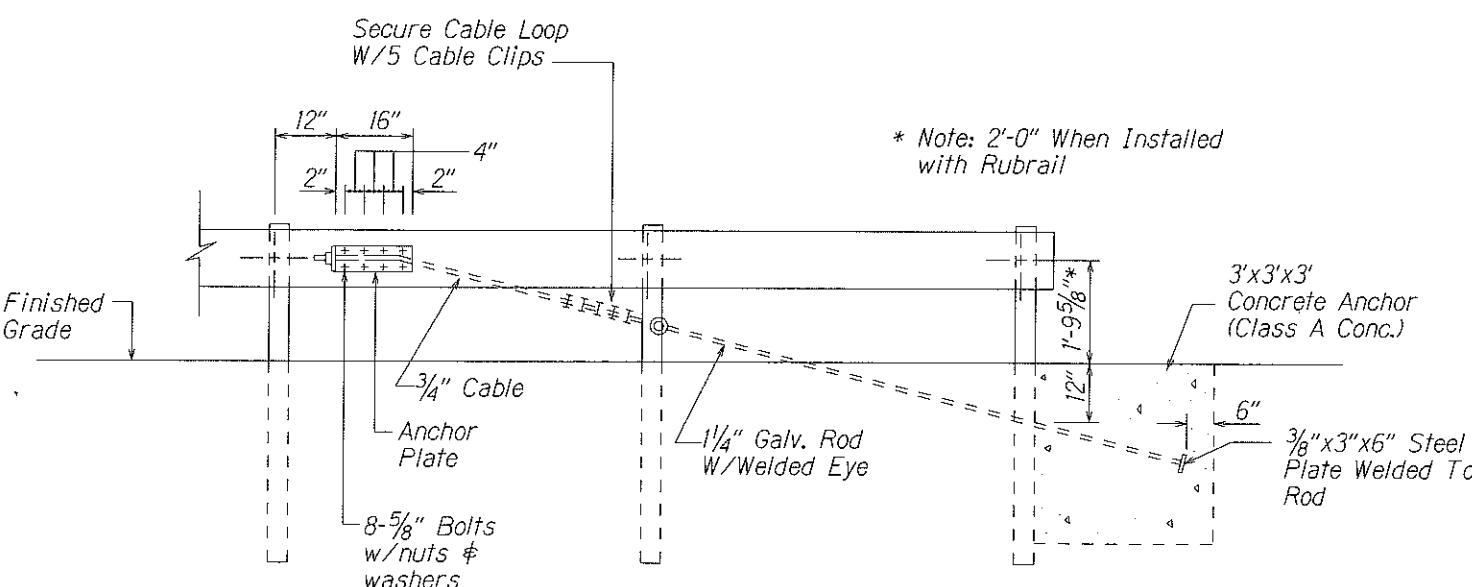

ANCHOR BLOCK DETAIL

- Concrete, G.R.P., excavation, anchor rod and miscellaneous appurtenances necessary to anchor the guardrail ends shall be incidental to metal guardrail.

For Details of Concrete Anchor Block in Ground See Det. below.

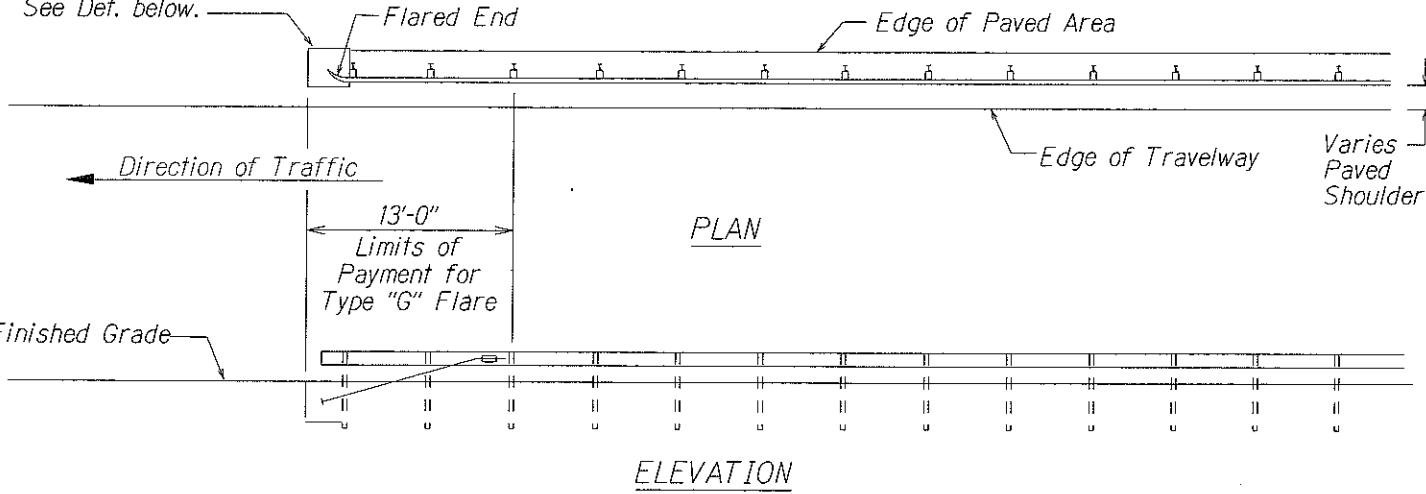

ELEVATION

TYPE "G" FLARE END TERMINAL

NOTE:

Type "G" Modified End Terminal is a site specific end terminal with a taper and radial termini. A site specific detailed drawing is required for all Type "G" Modified End Terminal and must receive Engineer's approval.

The taper (flare rate) of the guardrail shall follow the latest edition of AASHTO'S Roadside Design Guide (currently, Table 5.6 - Suggested Flare Rate for Barrier Design, page 5-21, Jan. 1996 edition).

The radius of the radial termini is an Engineer's judgement based on the site evaluation. The Engineer shall consider safety (minimize the spearing & blunt end situation); degree and potential seriousness of the hazard; bicycle and pedestrian accessibility; maintenance equipment accessibility; Right-of-Way availability; the smallest radii the metal w-beam/thrie-beam railing can be constructed (check with supplier/contractor); posted speed limit; angle of vehicle impact; and aesthetics when designing the Type "G" Modified End Terminal.

During construction, the Contractor shall layout the proposed Type "G" Modified End Terminal and receive approval from the Construction Engineer prior to installation.

9/15/09 | Revised Type "G" Flare End Terminal Elevation and Plan Drawings.

DATE | REVISION

STATE OF HAWAII
DEPARTMENT OF TRANSPORTATION
HIGHWAYS DIVISION

GUARDRAIL DETAILS

MAMALAHOA HIGHWAY
SAFETY IMPROVEMENT

Vicinity of Kiolakaa Homestead Road

Federal Aid Project No. HSIP-011-2(37)











Scale: NTS Date: September 2009



SHEET NO. 3 OF 5 SHEETS

ADD. 24

ORIGINAL SURVEY PLOTTED BY	DATE
DRAWN BY	
TRACED BY	
DESIGNED BY	
QUANTIFIED BY	
CHECKED BY	

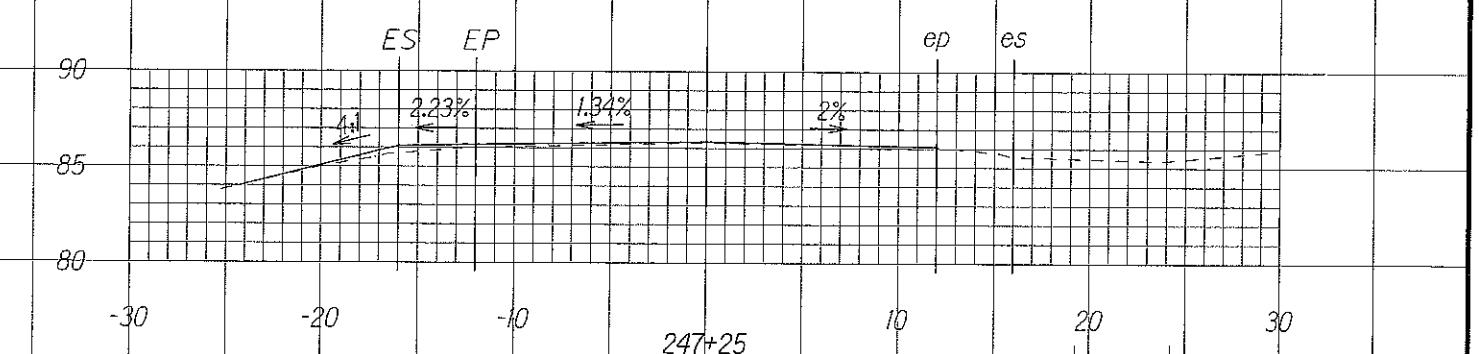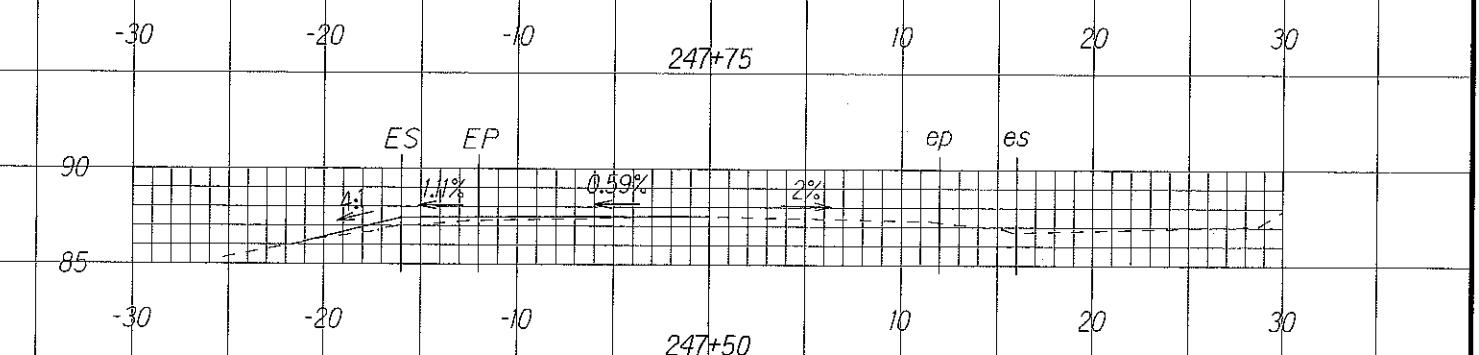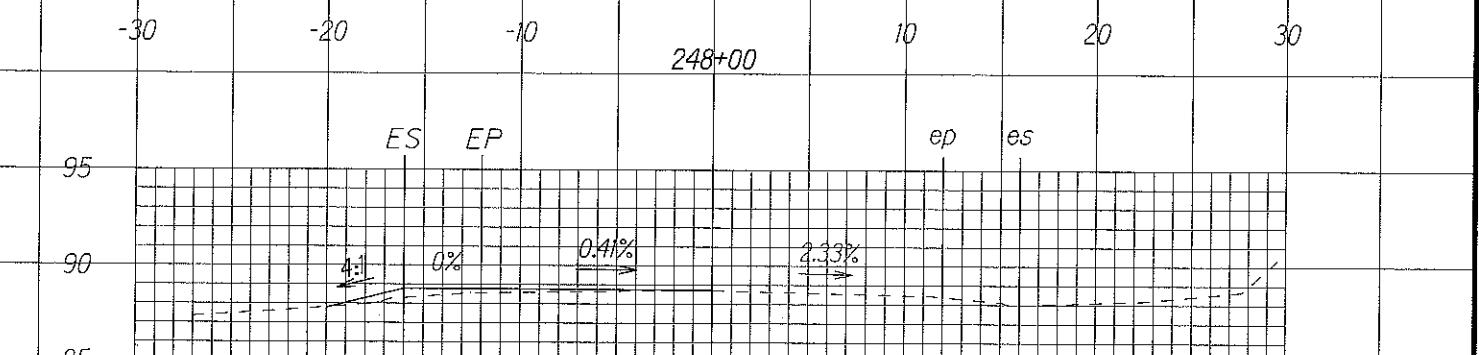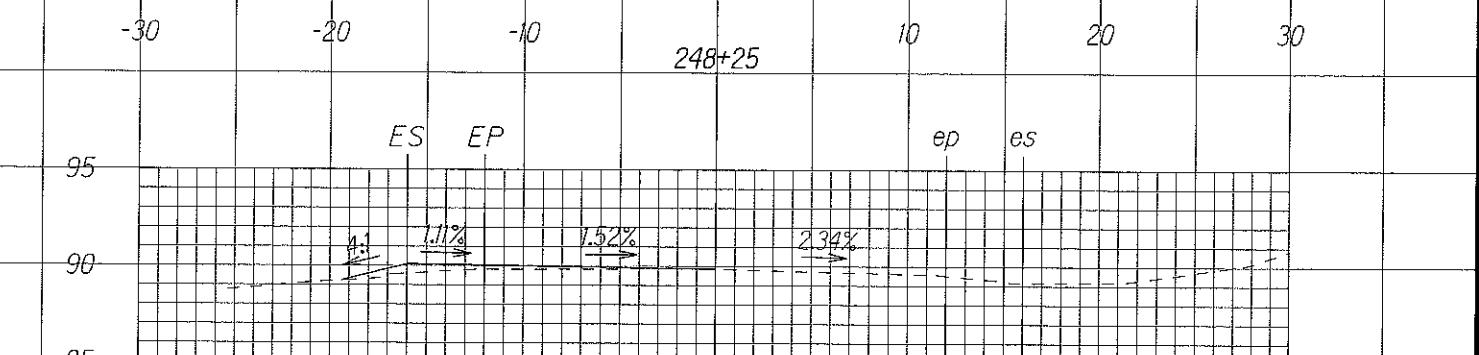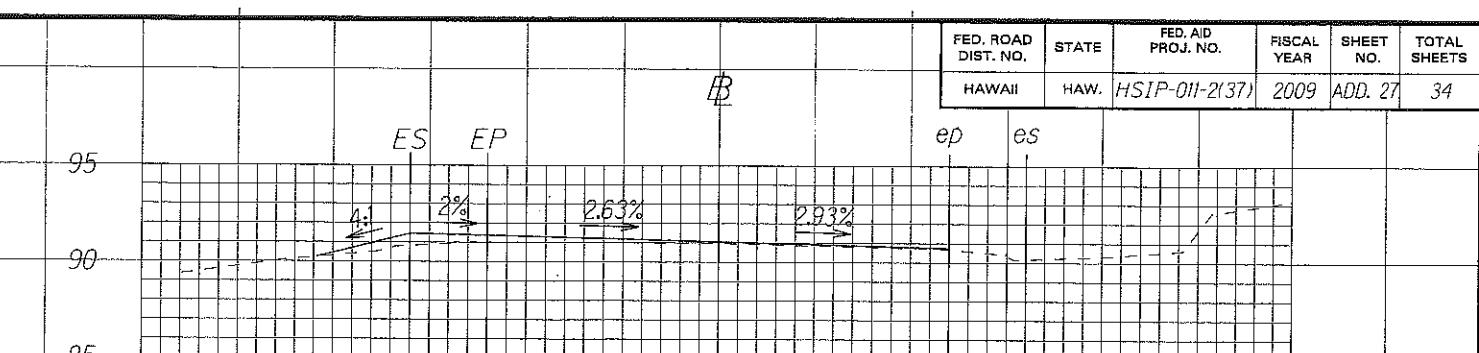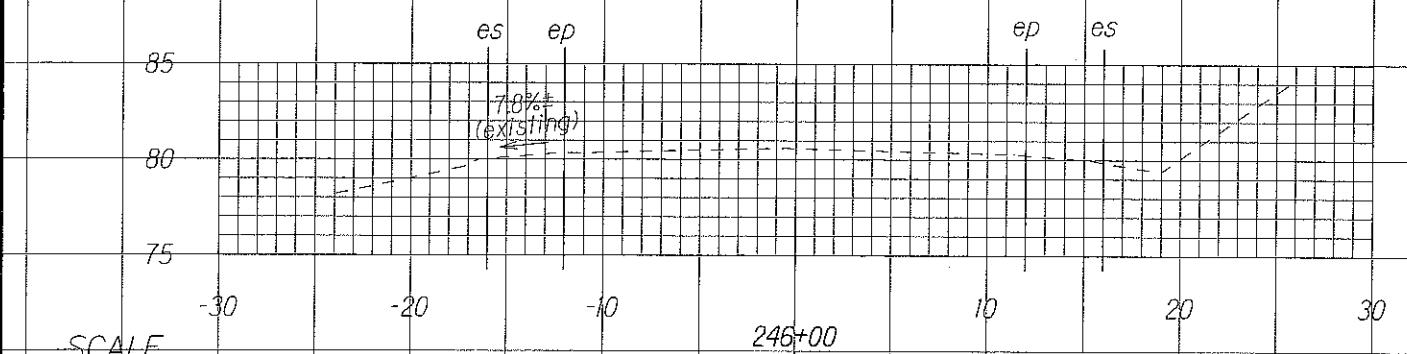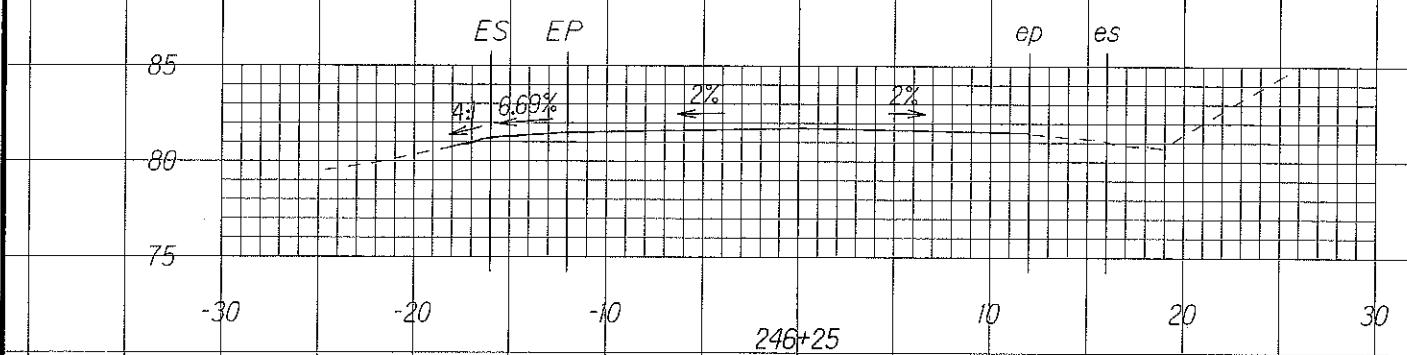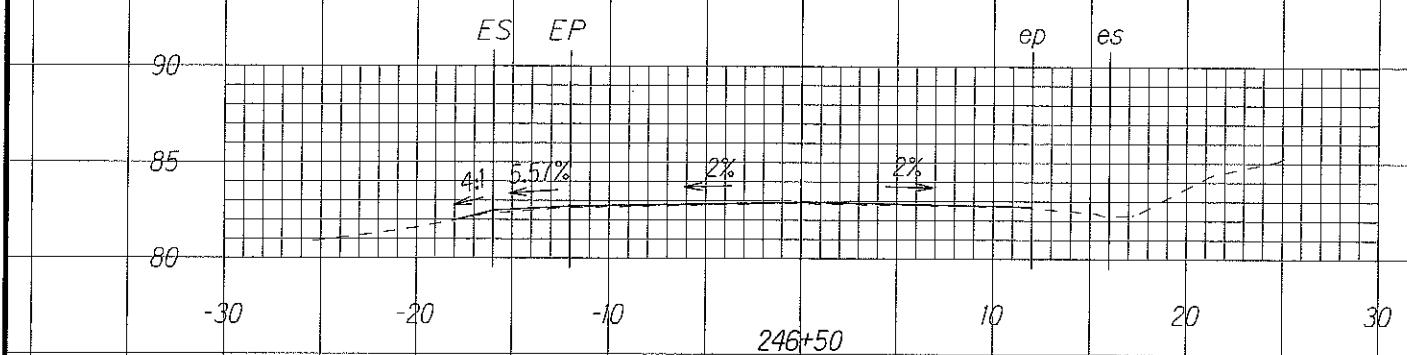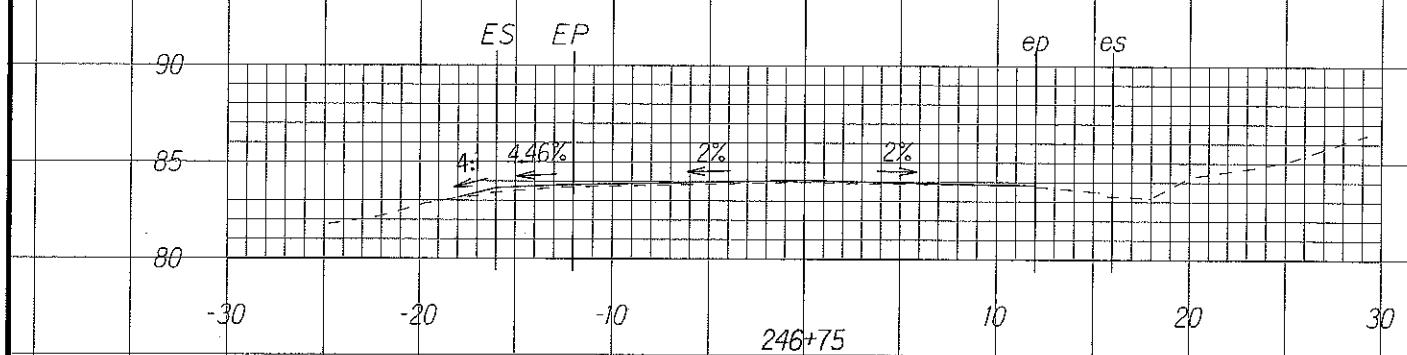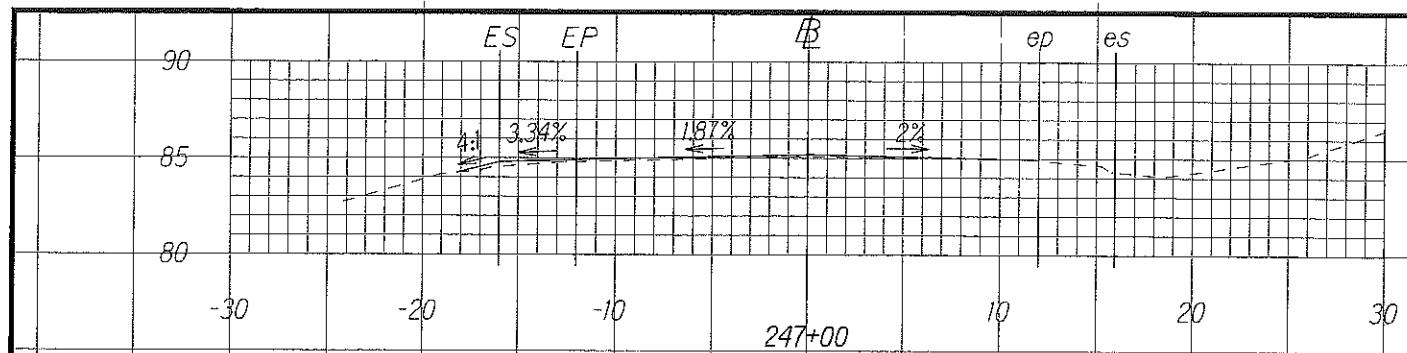


ORIGINAL PLAN	SURVEY PLOTTED BY _____	DATE _____
	DRAWN BY _____	_____
	TRACED BY _____	_____
	DESIGNED BY _____	_____
NOTE BOOK <i>(Date)</i> No. _____ <i>dimensions, bed!</i>	QUANTITIES BY _____ CHECKED BY _____	_____


SCALE

9/15/09 Revised Shoulder Slopes.
DATE **REVISION**
SHEET No. 1 OF 8 SHEET







FED. ROAD DIST. NO.	STATE	FED. AID PROJ. NO.	FISCAL YEAR	SHEET NO.	TOTAL SHEETS
HAWAII	HAW.	HSIP-011-2(37)	2009	ADD. 28	34

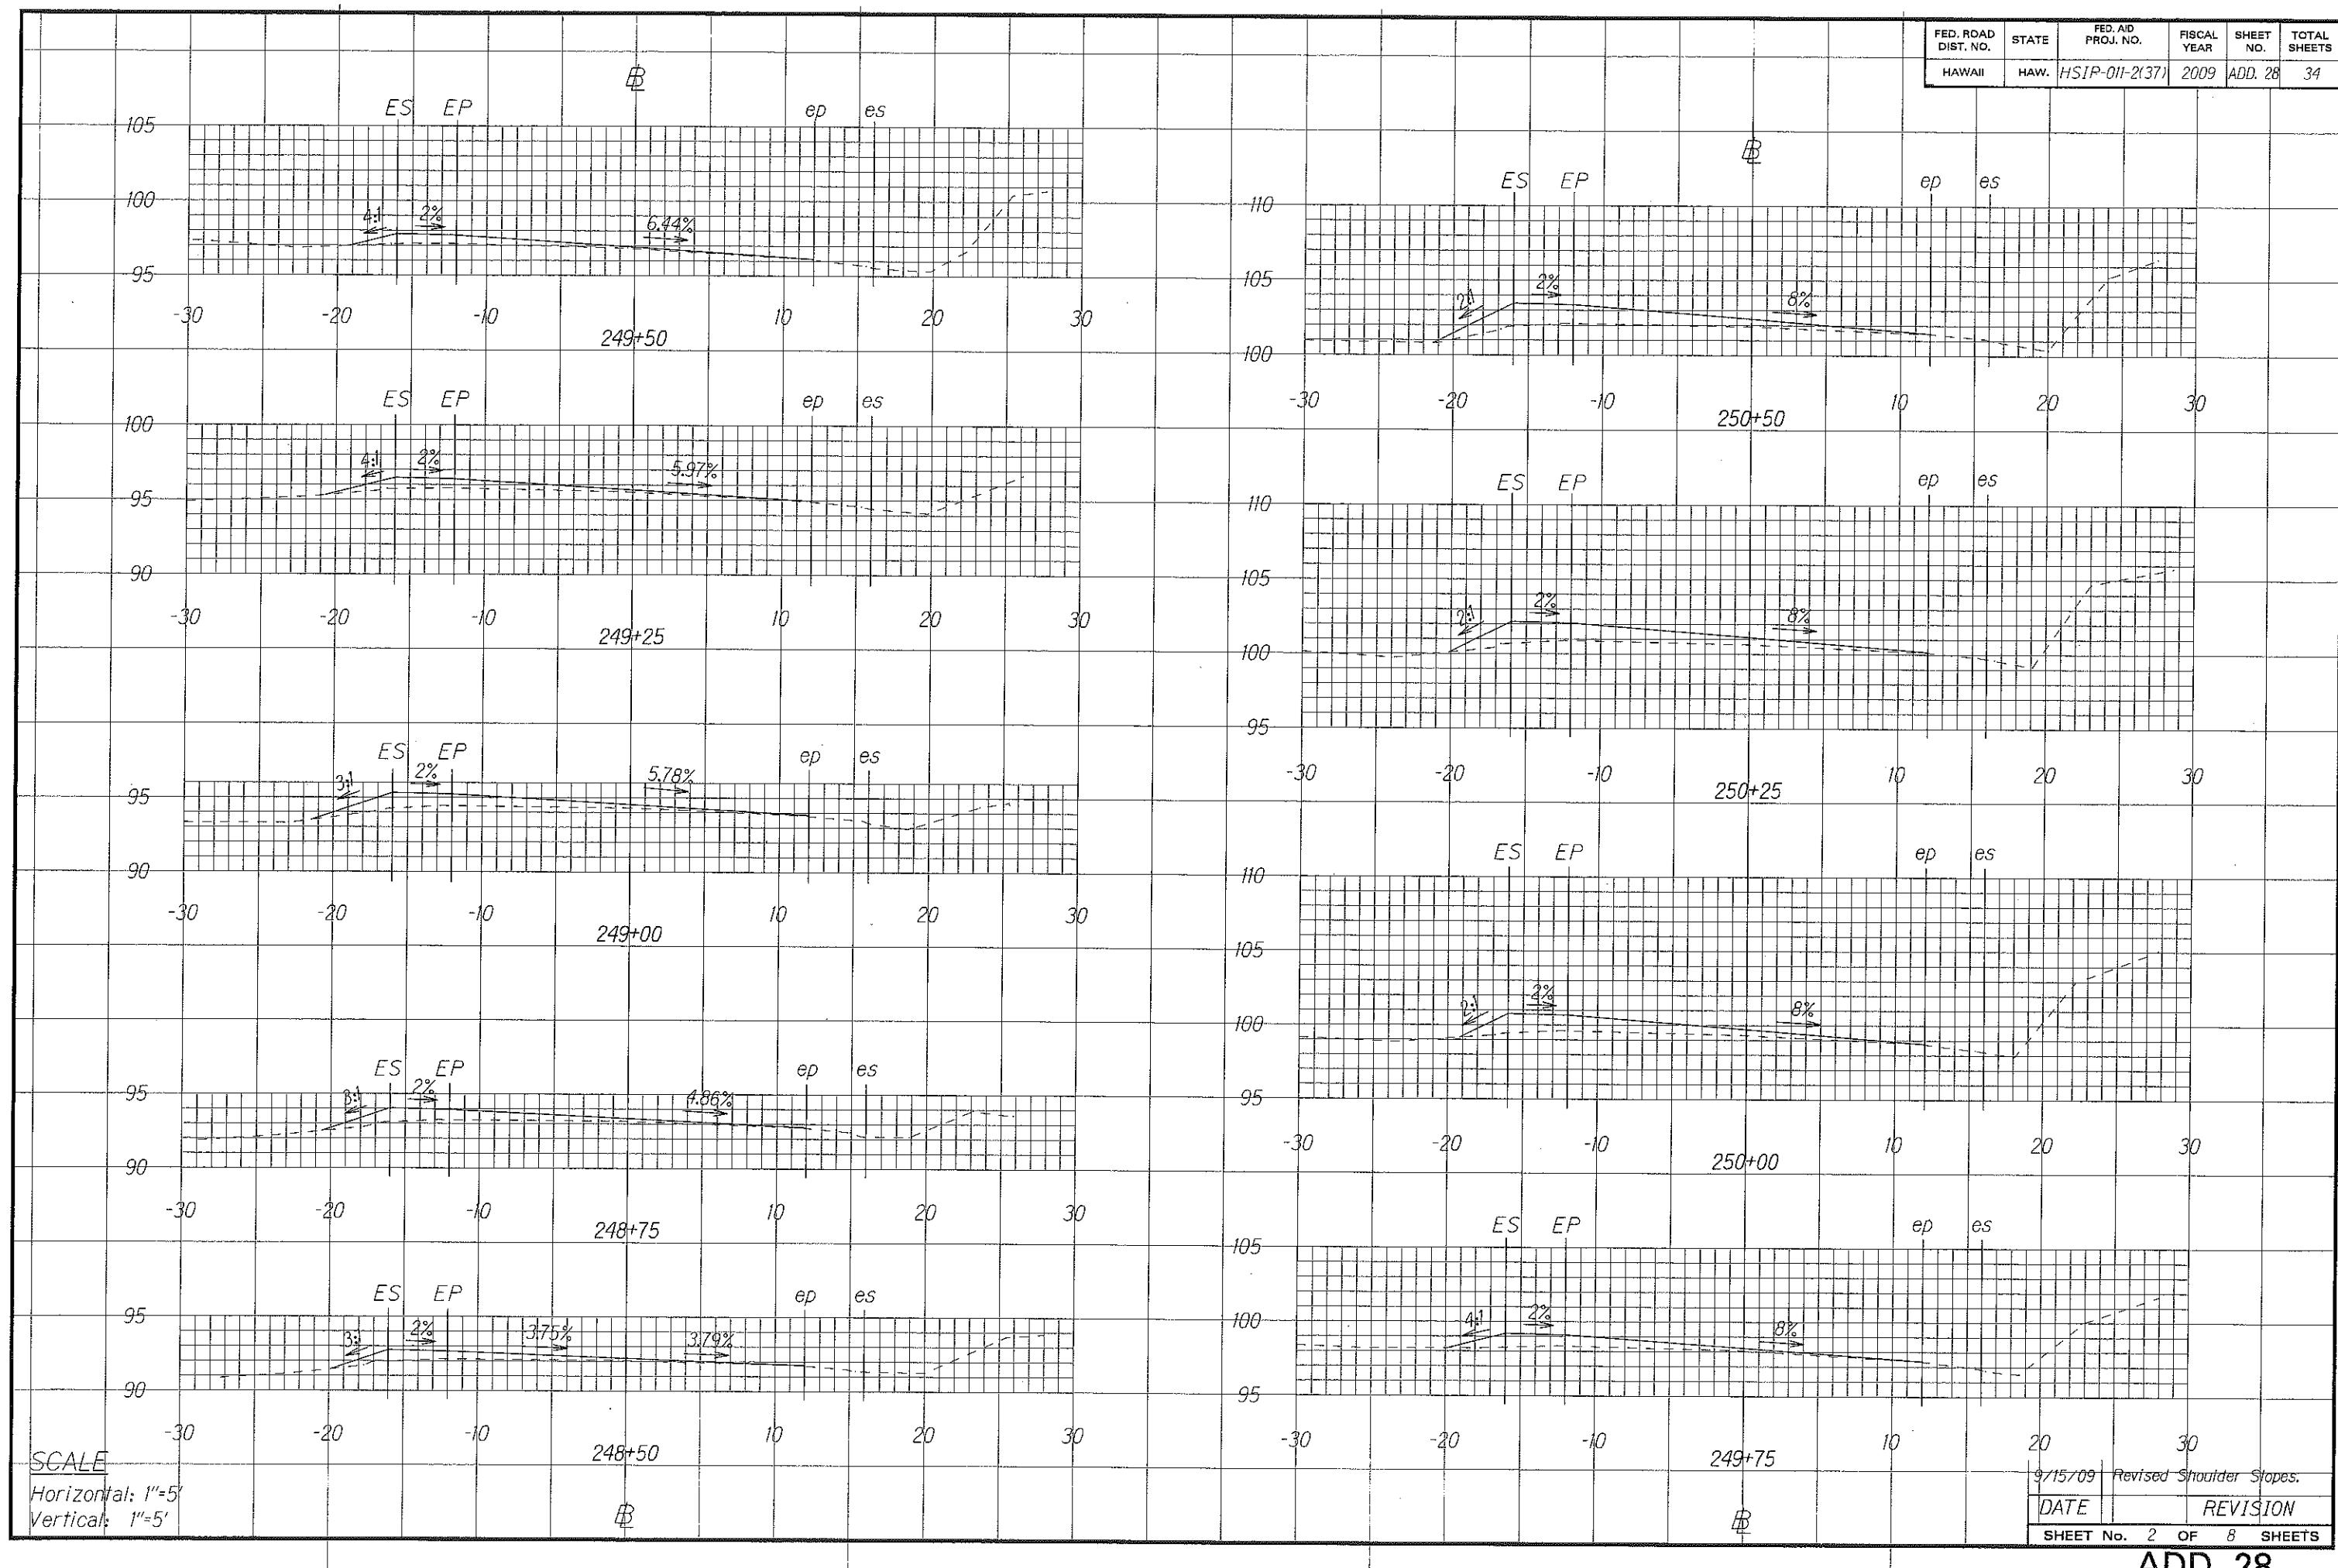

FED. ROAD DIST. NO.	STATE	FED. AID PROJ. NO.	FISCAL YEAR	SHEET NO.	TOTAL SHEETS
HAWAII	HAW.	HSIP-011-2(37)	2009	ADD. 29	34

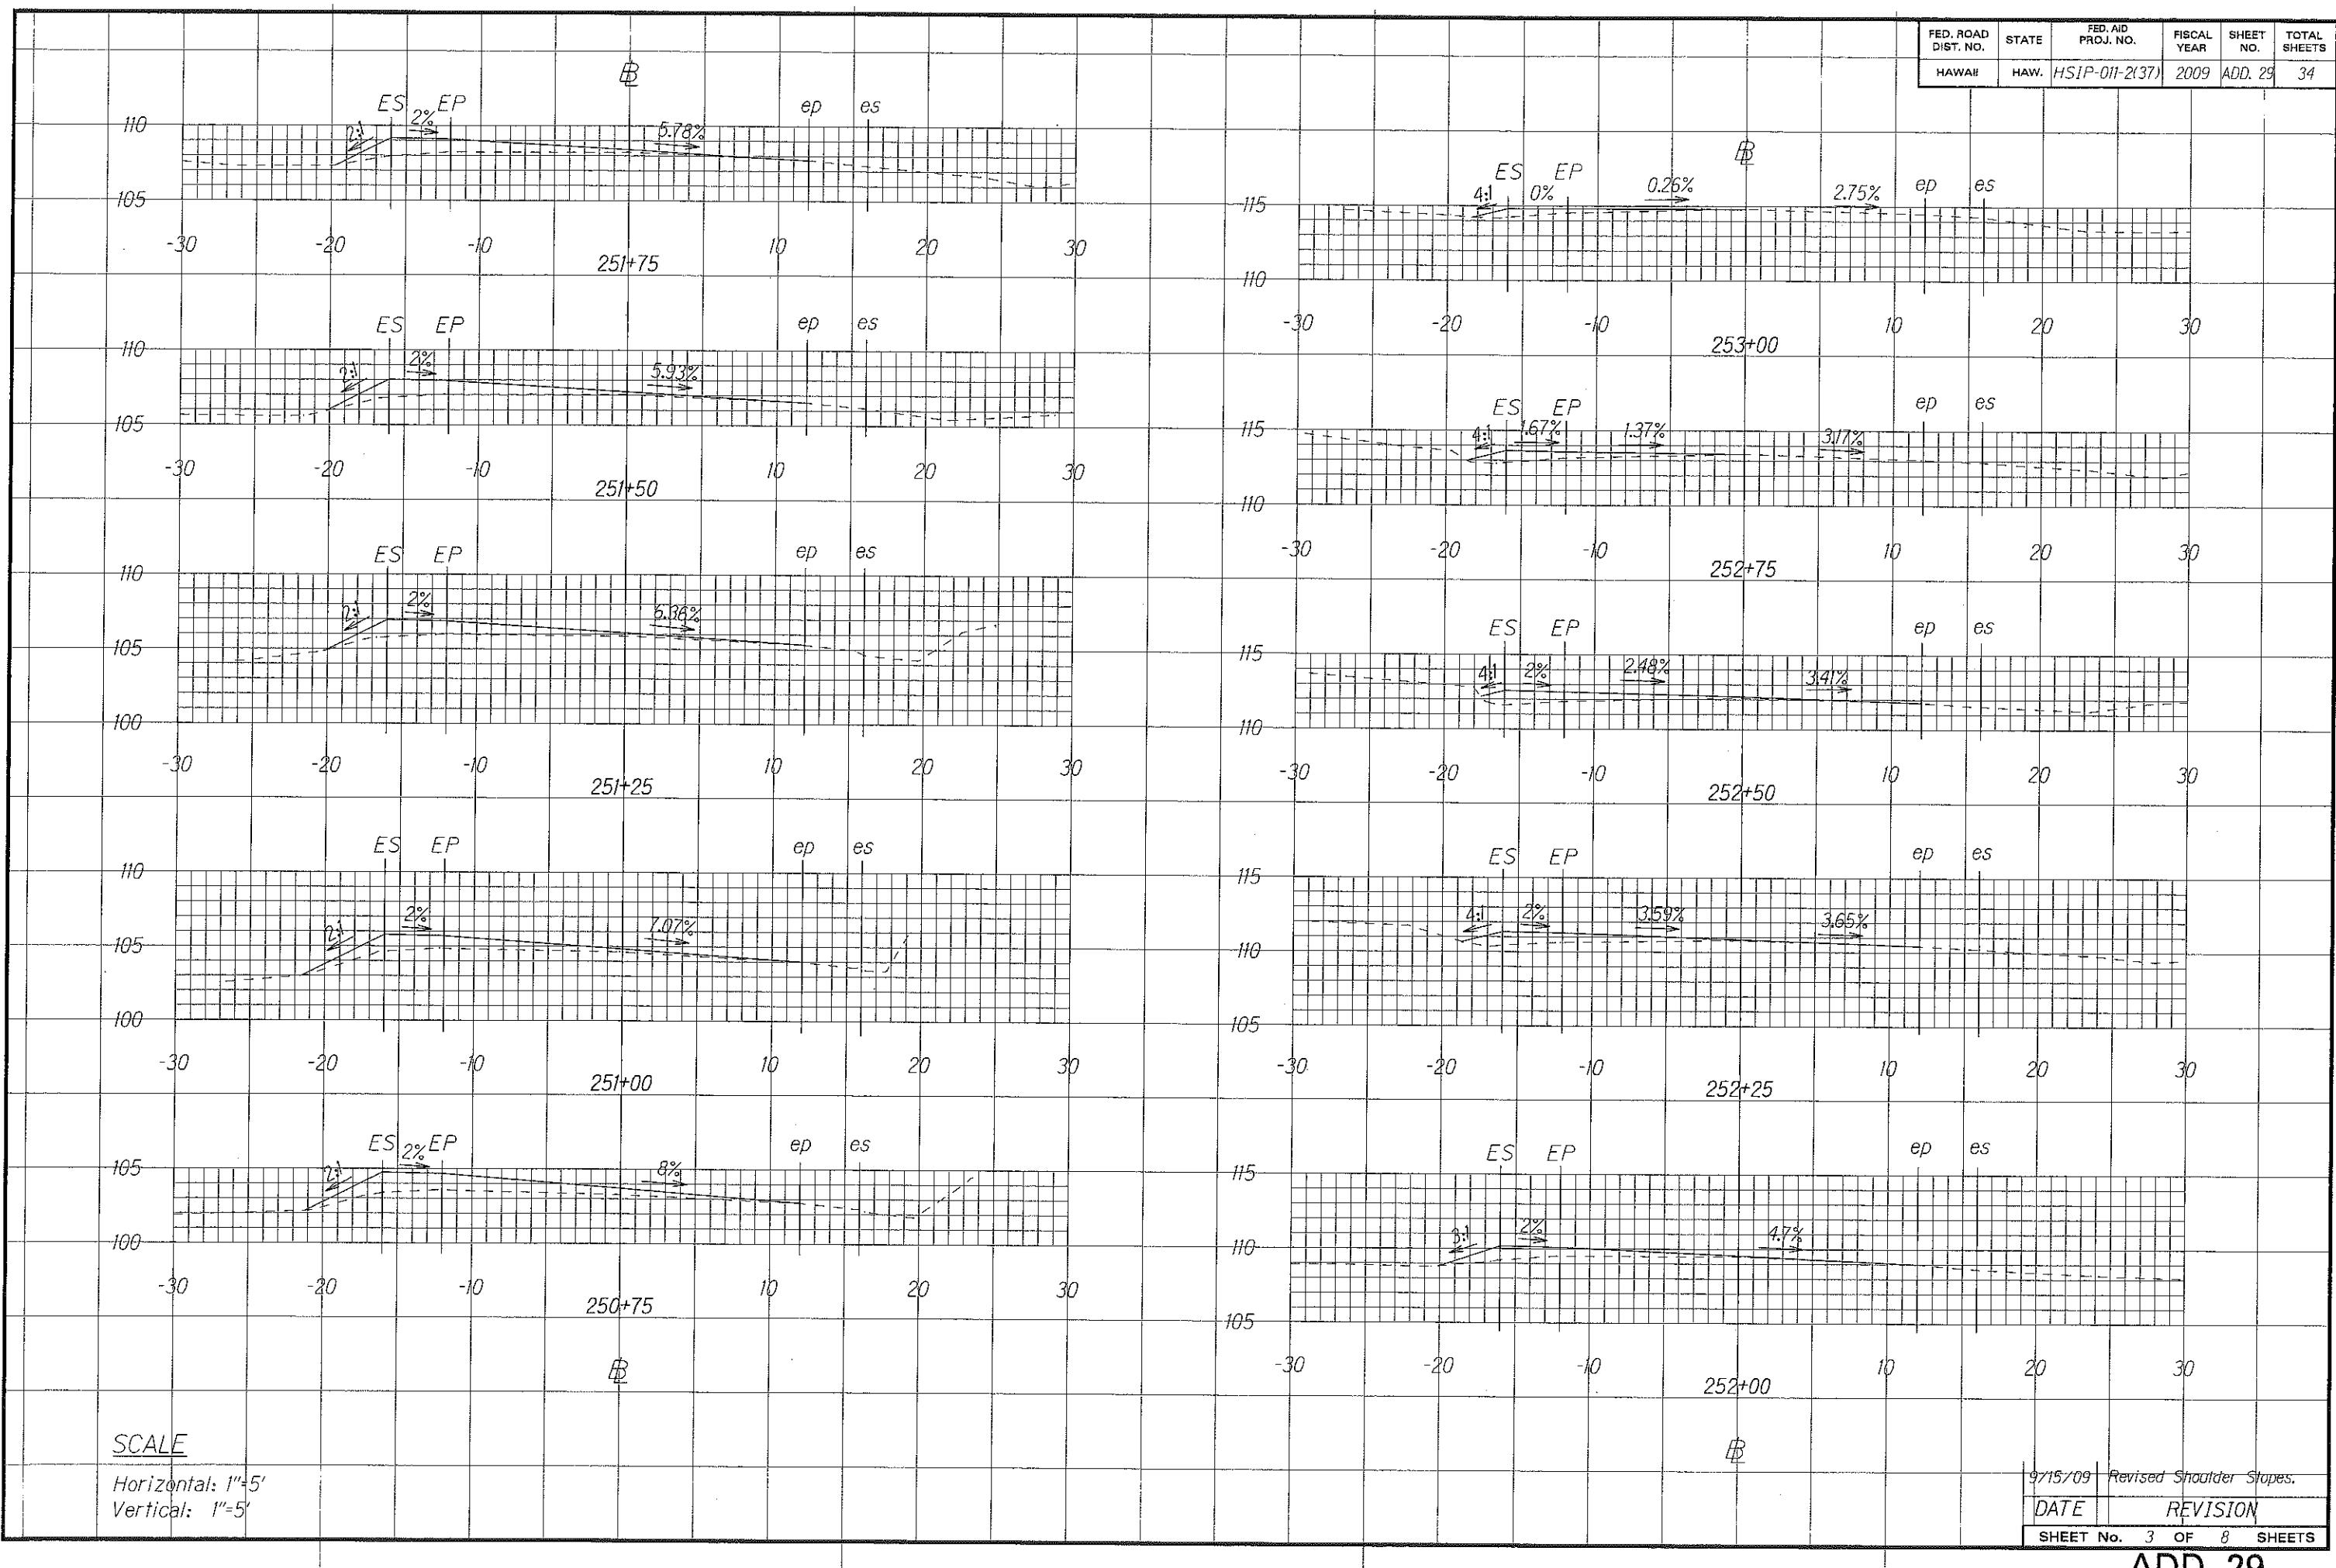

FED. ROAD DIST. NO.	STATE	FED. AID PROJ. NO.	FISCAL YEAR	SHEET NO.	TOTAL SHEETS
HAWAII	HAW.	HSIP-011-2(37)	2009	ADD. 30	34

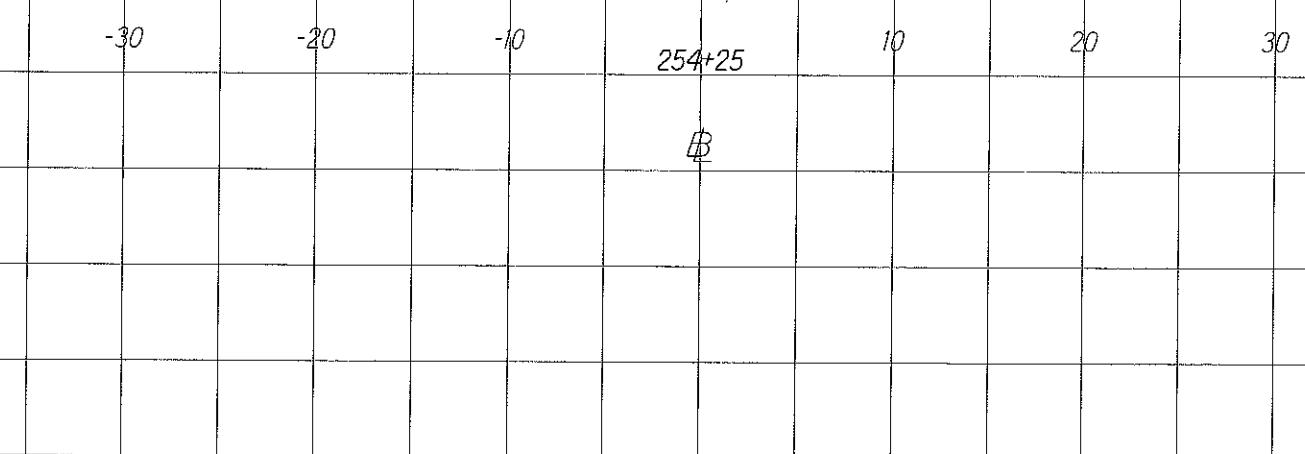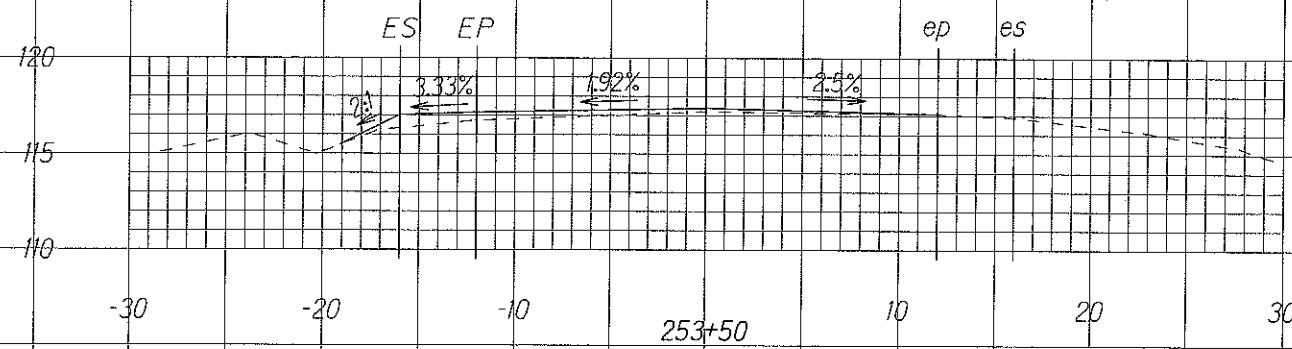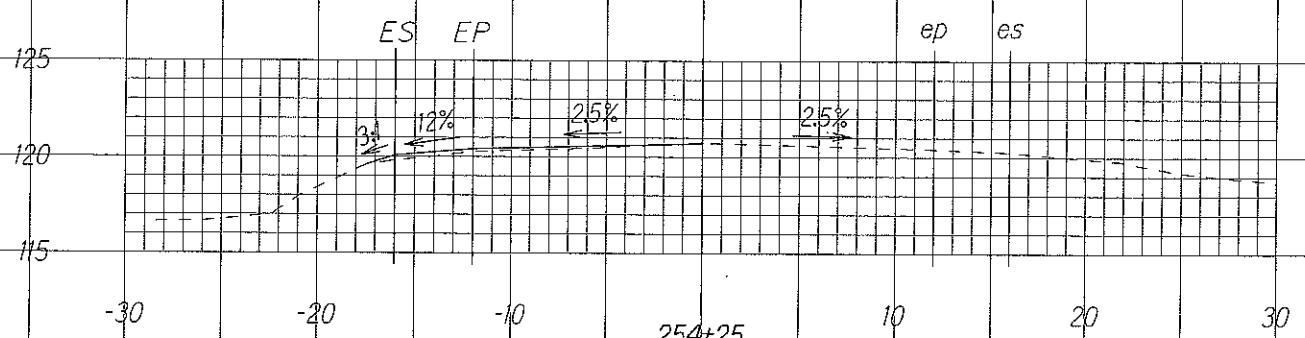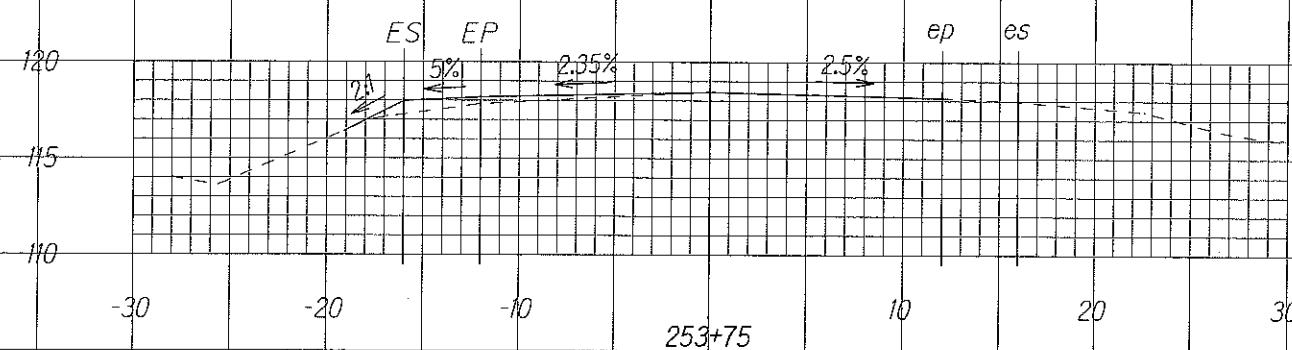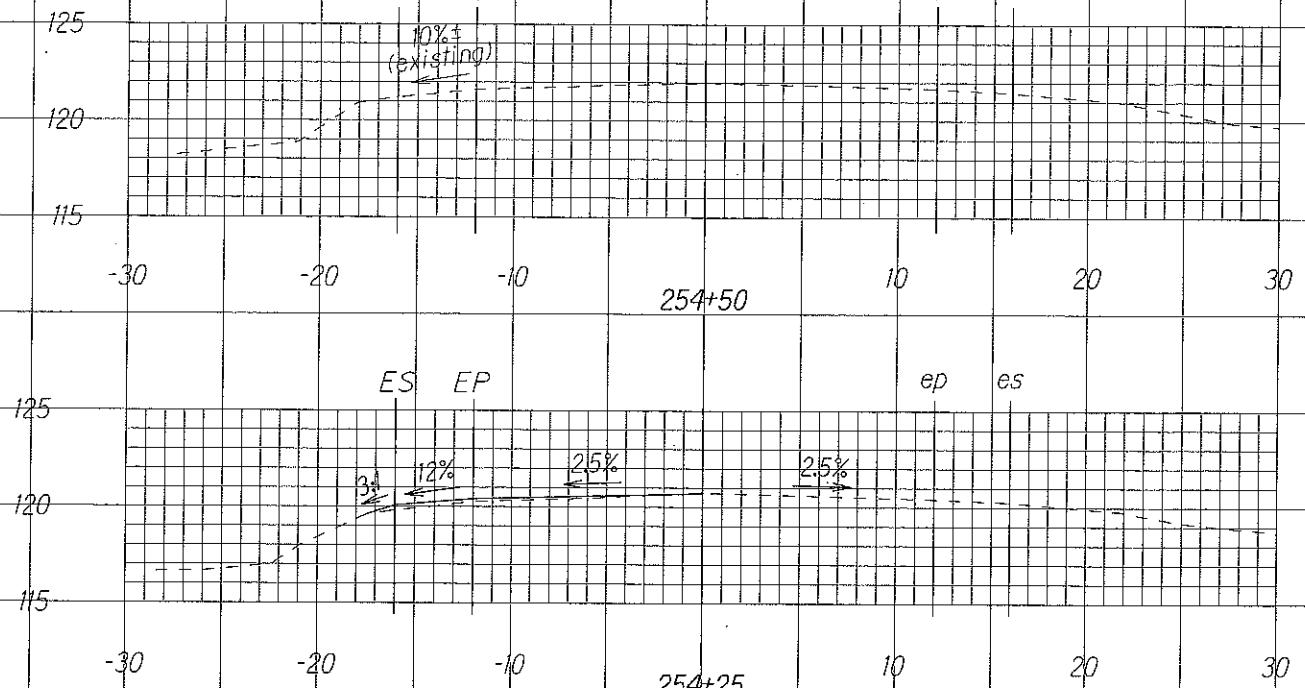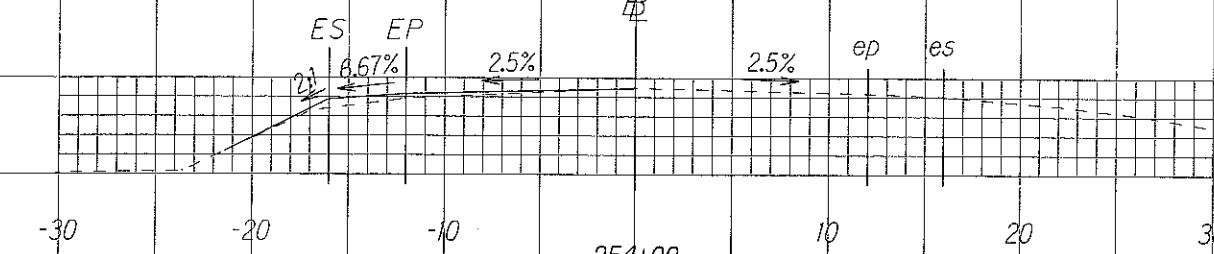

ORIGINAL PLAN	DATE
SURVEY PLOTTED BY	X
DRAWN BY	X
TRACED BY	X
DESIGNED BY	X
QUANTITIES BY	X
CHECKED BY	X

NOTES
1/2" on
Dimensions
in feet
N.

SCALE

Horizontal: 1"=5'
Vertical: 1"=5'


9/15/09 Revised Shoulder Slopes.

DATE REVISION


SHEET No. 4 OF 8 SHEETS

ADD. 30

FED. ROAD DIST. NO.	STATE	FED. AID PROJ. NO.	FISCAL YEAR	SHEET NO.	TOTAL SHEETS
HAWAII	HAW.	HSIP-011-2(37)	2009	ADD. 31	34

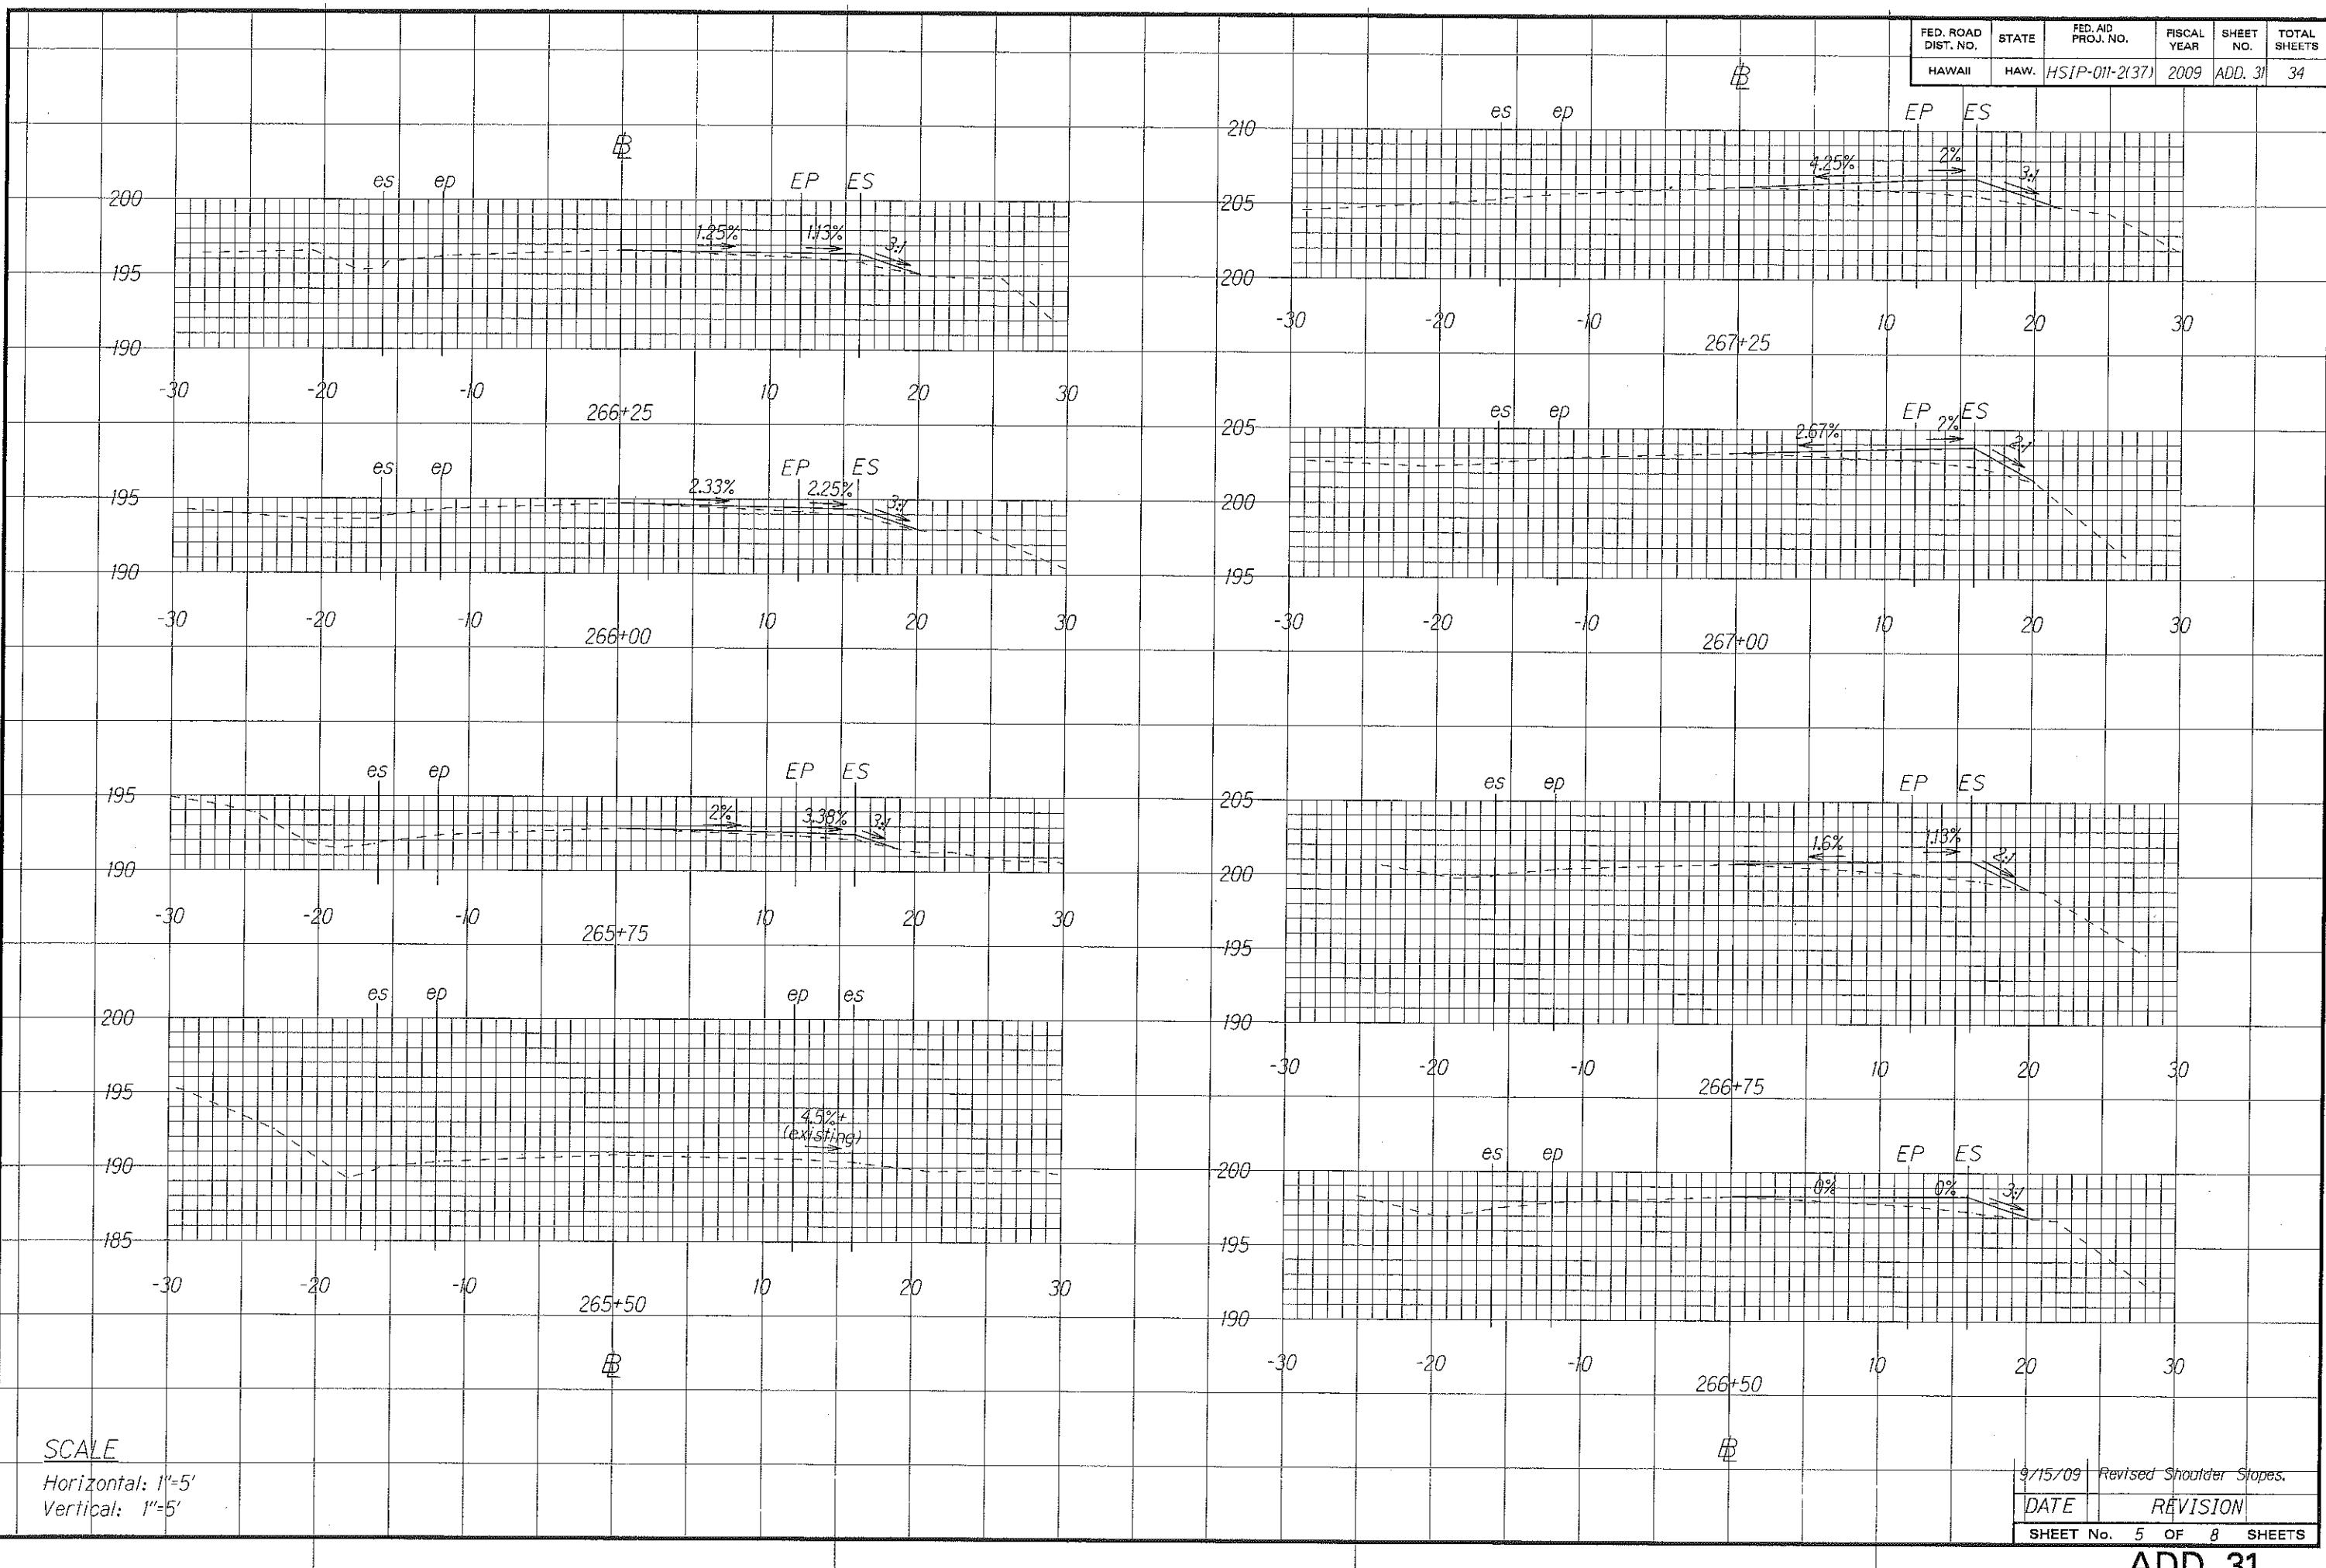


FED. ROAD DIST. NO.	STATE	FED. AID PROJ. NO.	FISCAL YEAR	HEET NO.	TOTAL SHEETS
HAWAII	HAW.	HSIP-011-2(37)	2009	ADD. 32	34

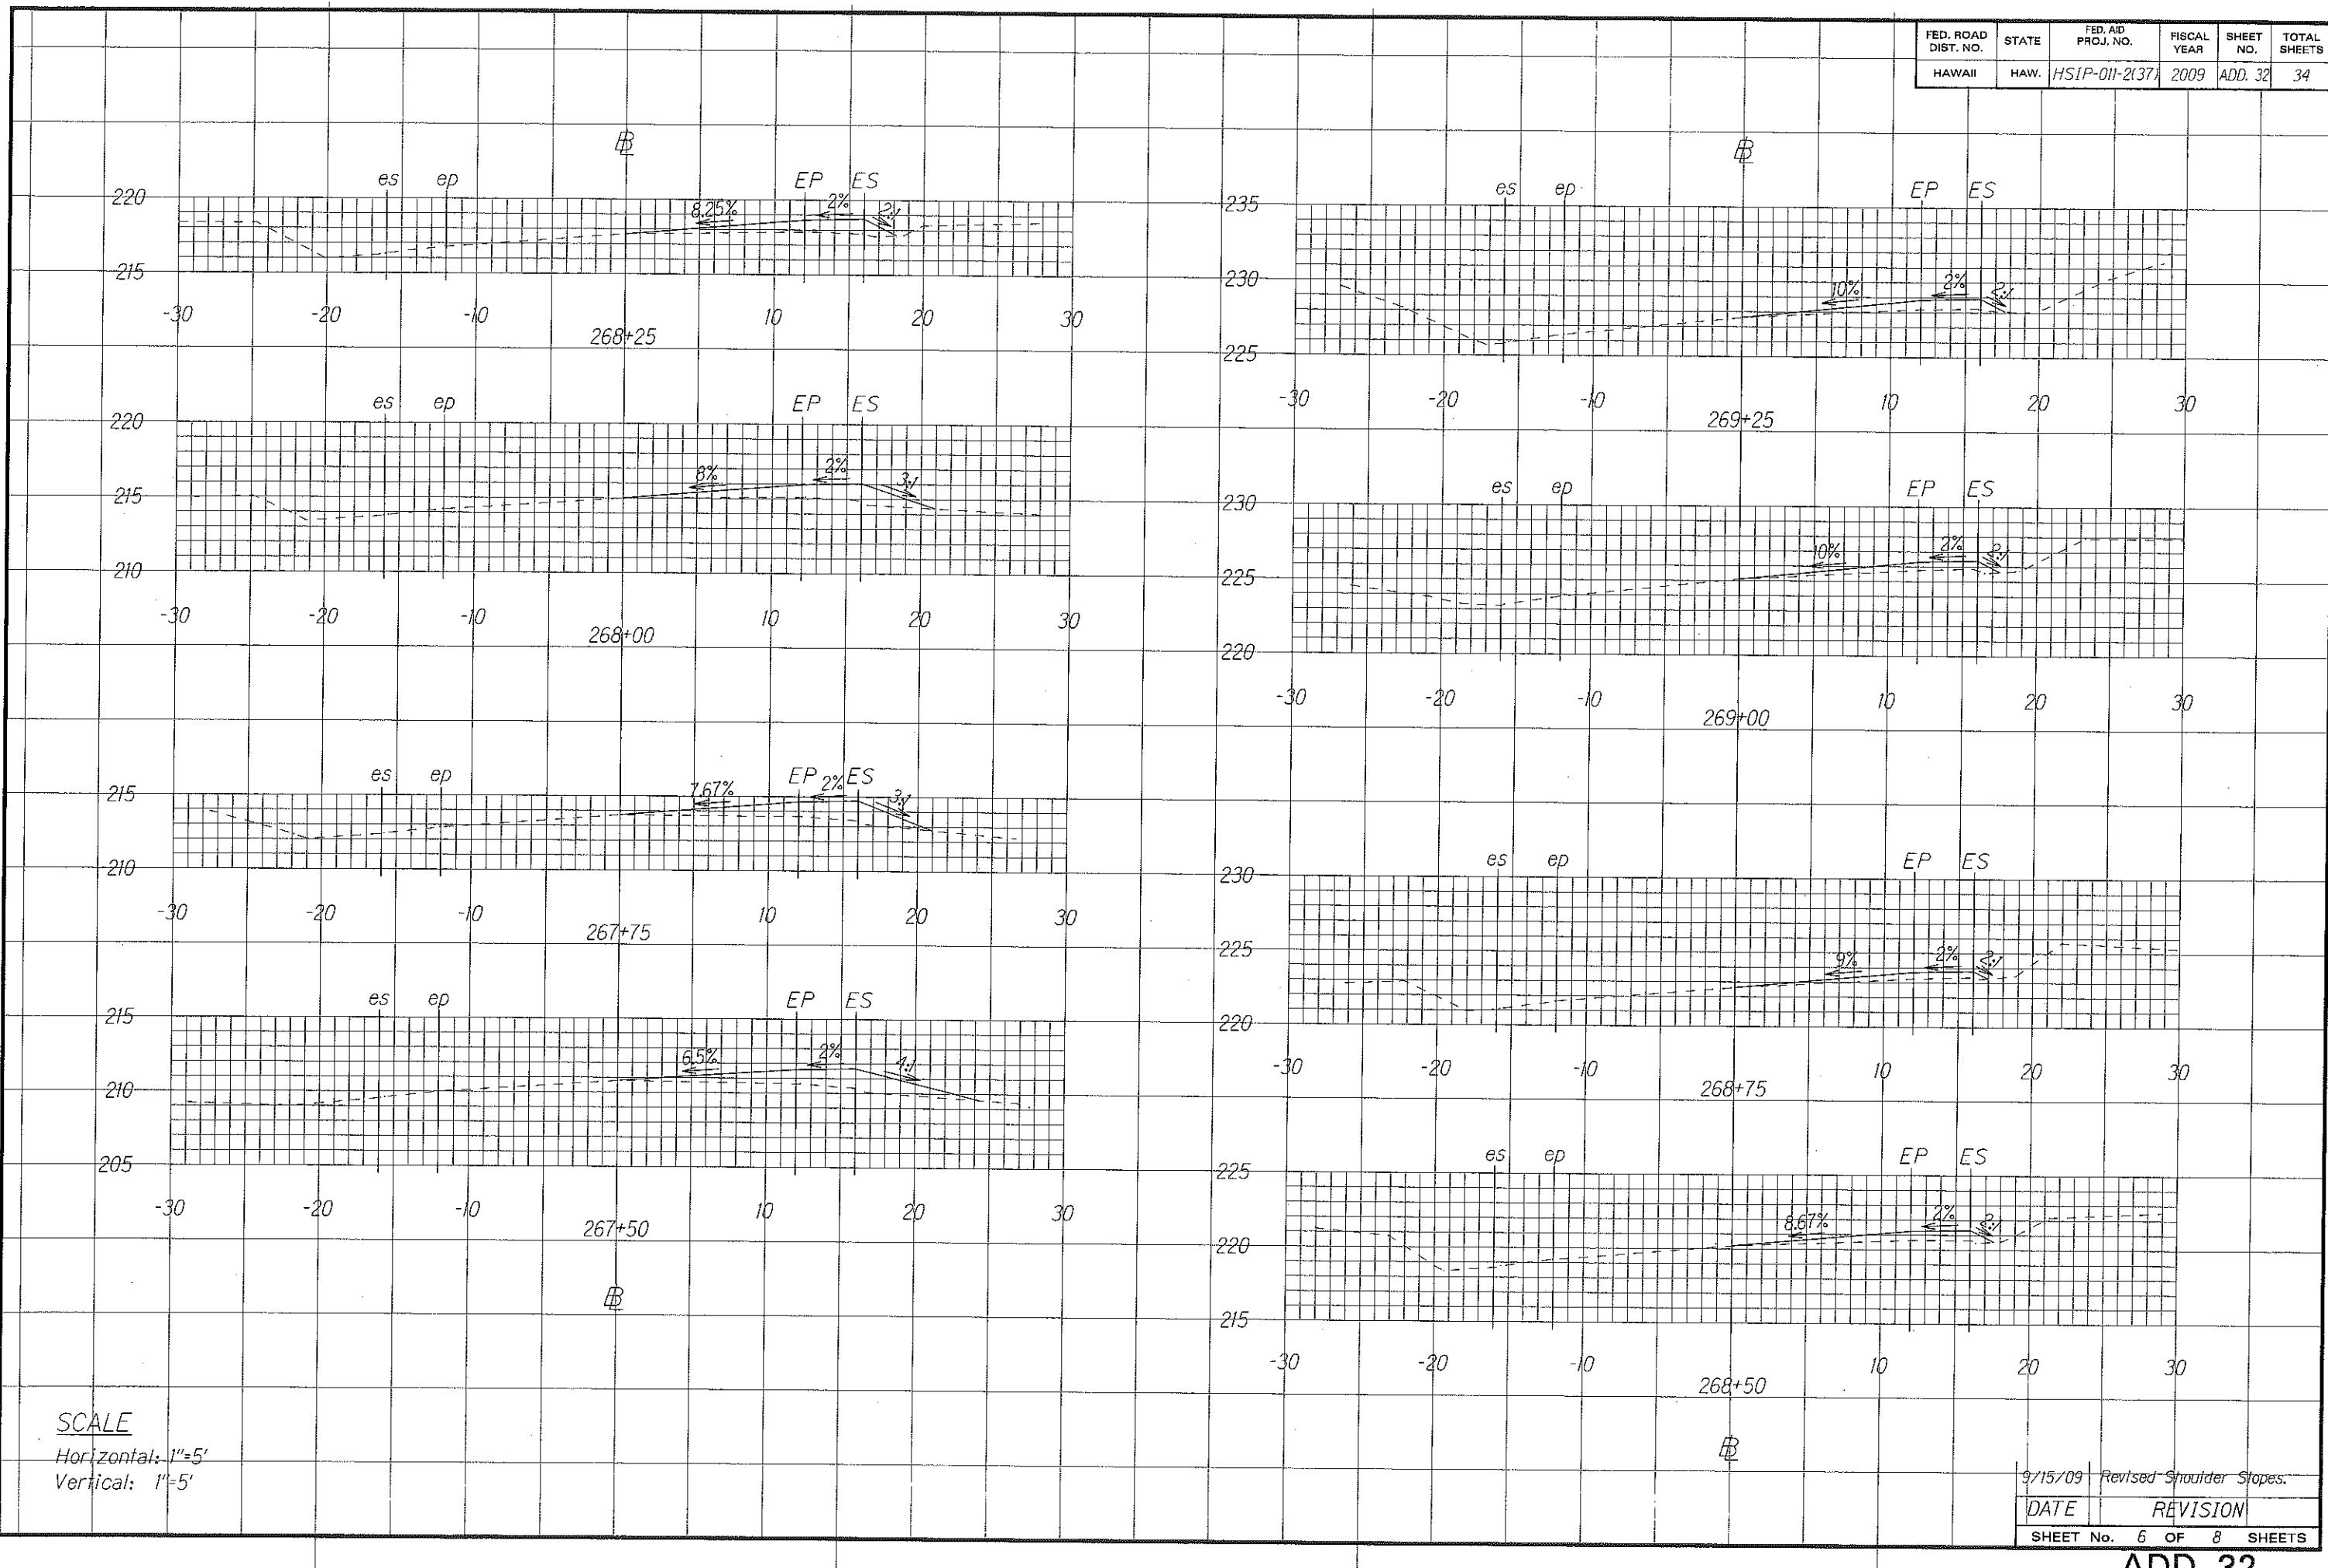


SURVEY PLOTTED BY _____	DATE _____
DRAWN BY _____	_____
TRADED BY _____	_____
DESIGNED BY _____	_____
QUANTITIES BY _____	_____
CHECKED BY _____	_____

ORIGINAL PLAN	_____
NOTES	JACOB
TRADED	_____
DESIGNED	_____
QUANTITIES	_____
CHECKED	_____

FED. ROAD DIST. NO.	STATE	FED. AID PROJ. NO.	FISCAL YEAR	SHEET NO.	TOTAL SHEETS
HAWAII	HAW.	HSIP-011-(137)	2009	ADD. 33	34

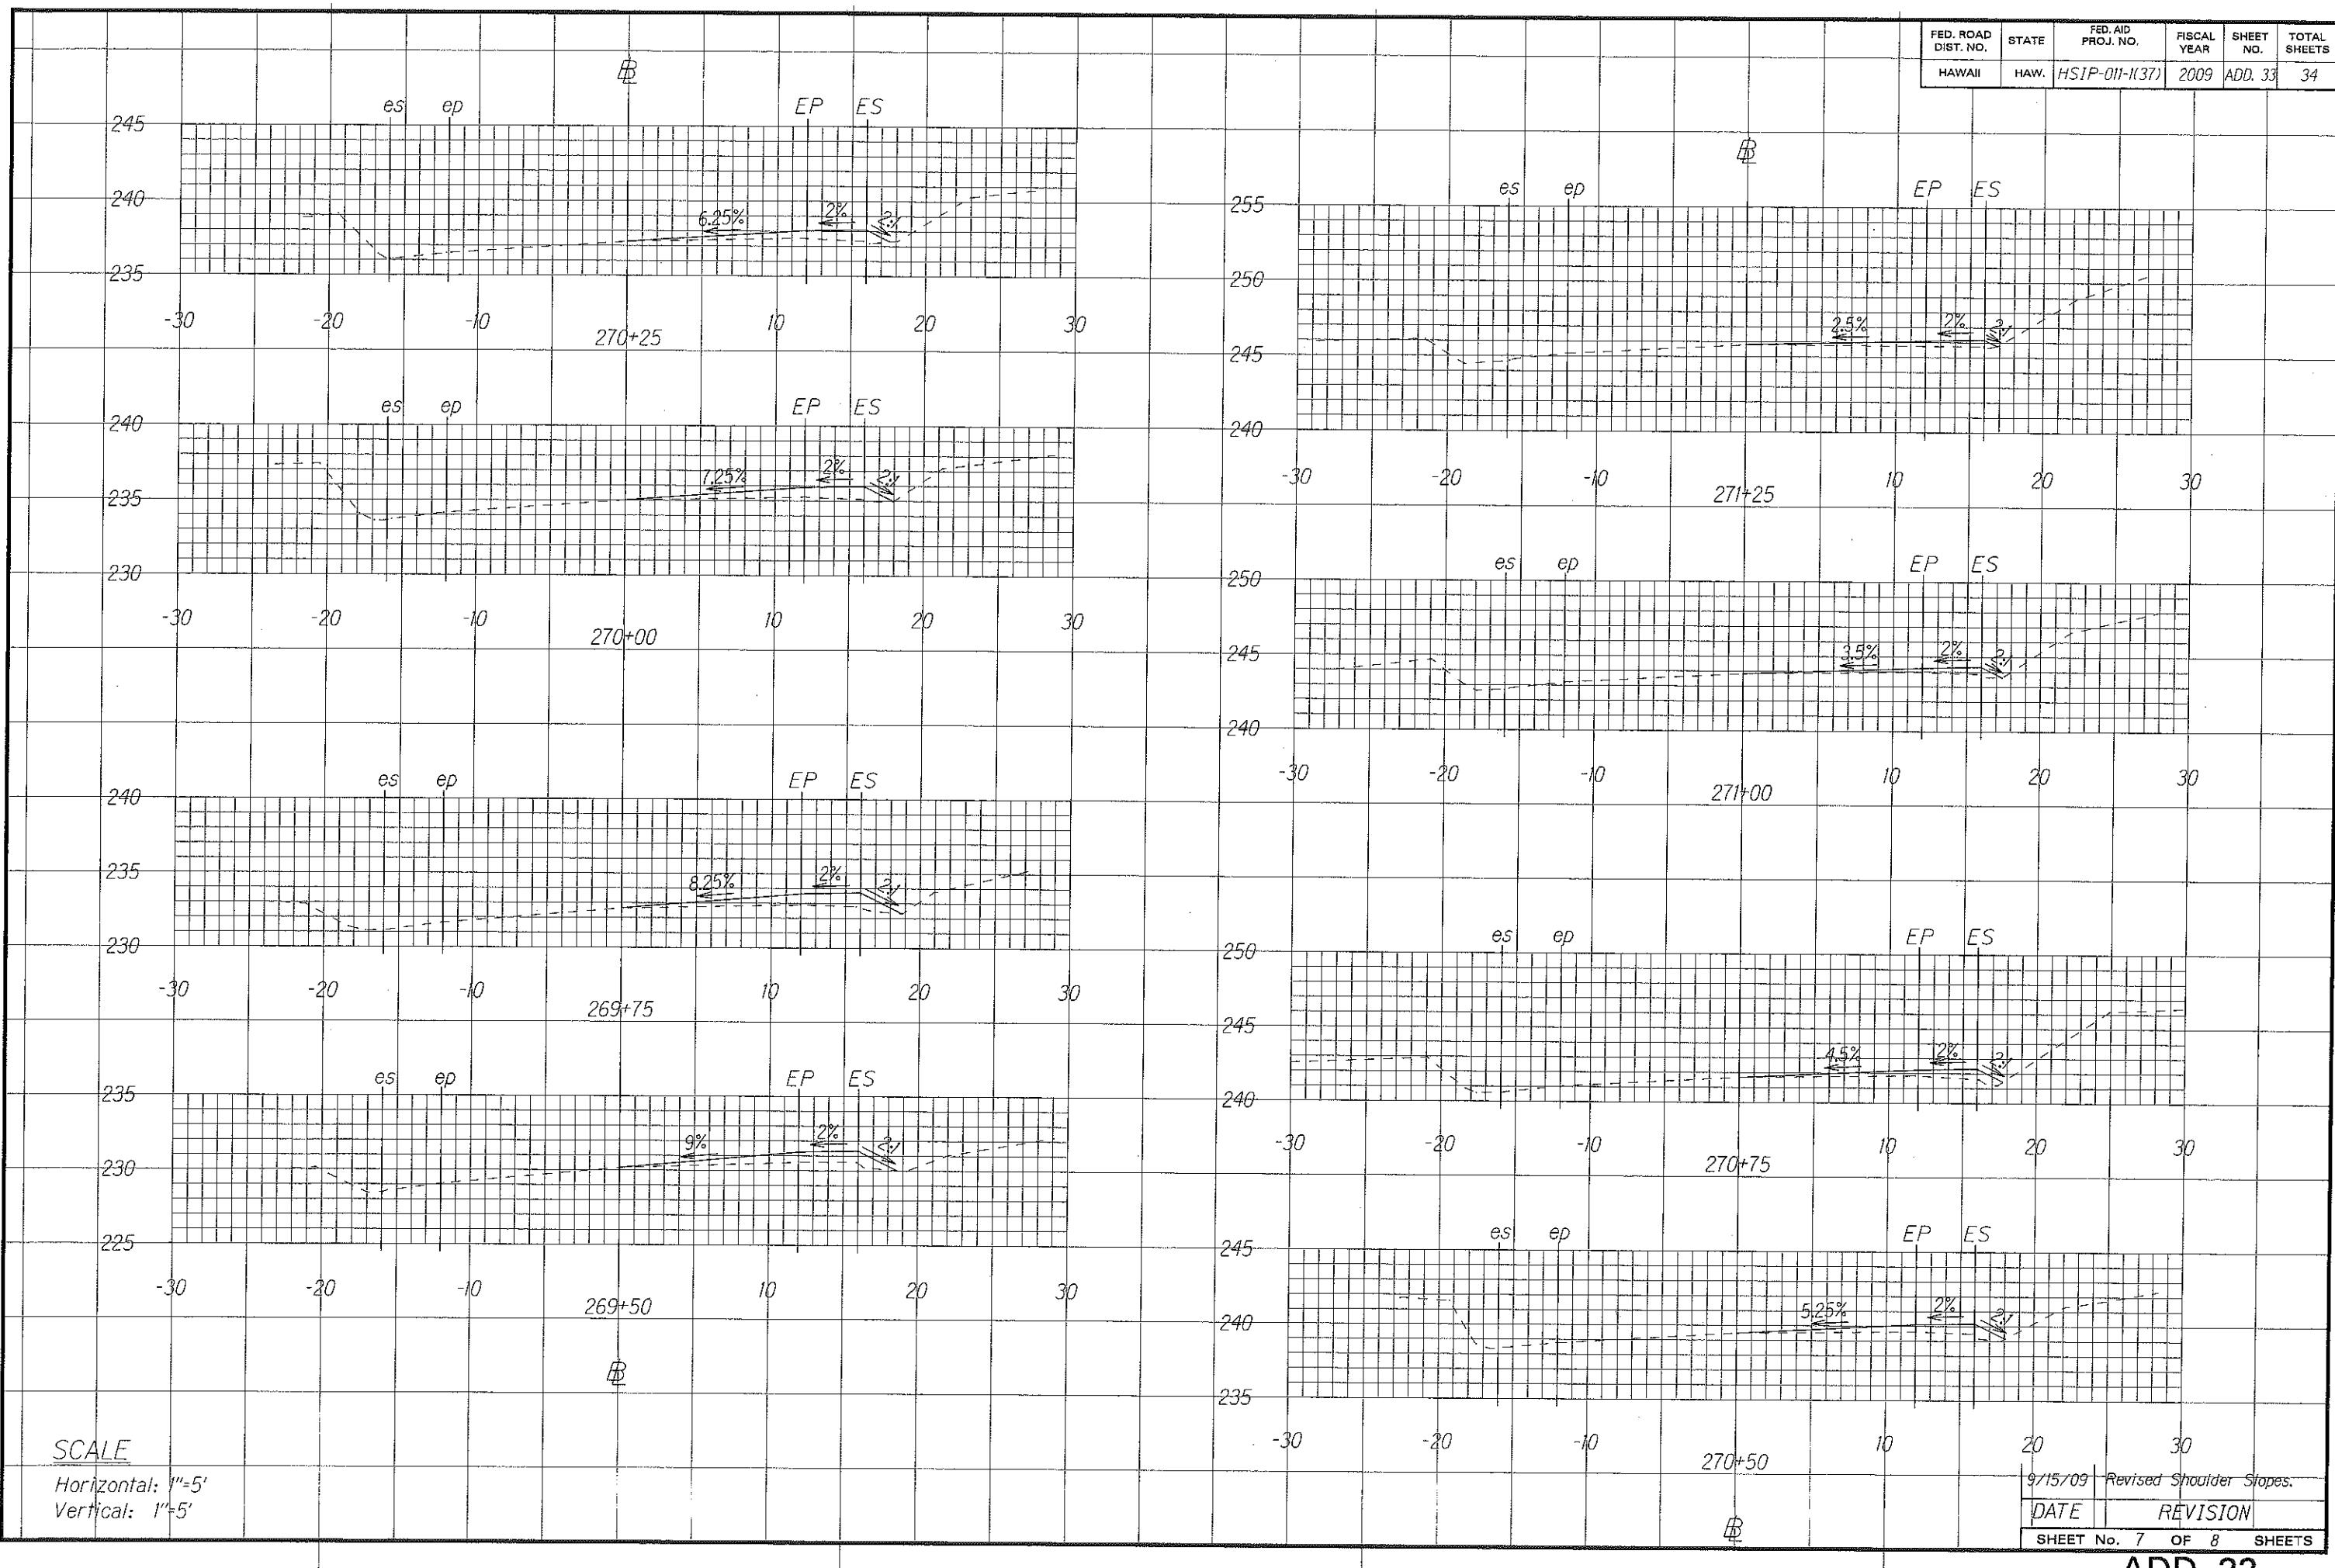

FED. ROAD DIST. NO.	STATE	FED. AID PROJ. NO.	FISCAL YEAR	SHEET NO.	TOTAL SHEETS
HAWAII	HAW.	HSIP-011-2(37)	2009	ADD. 34	34

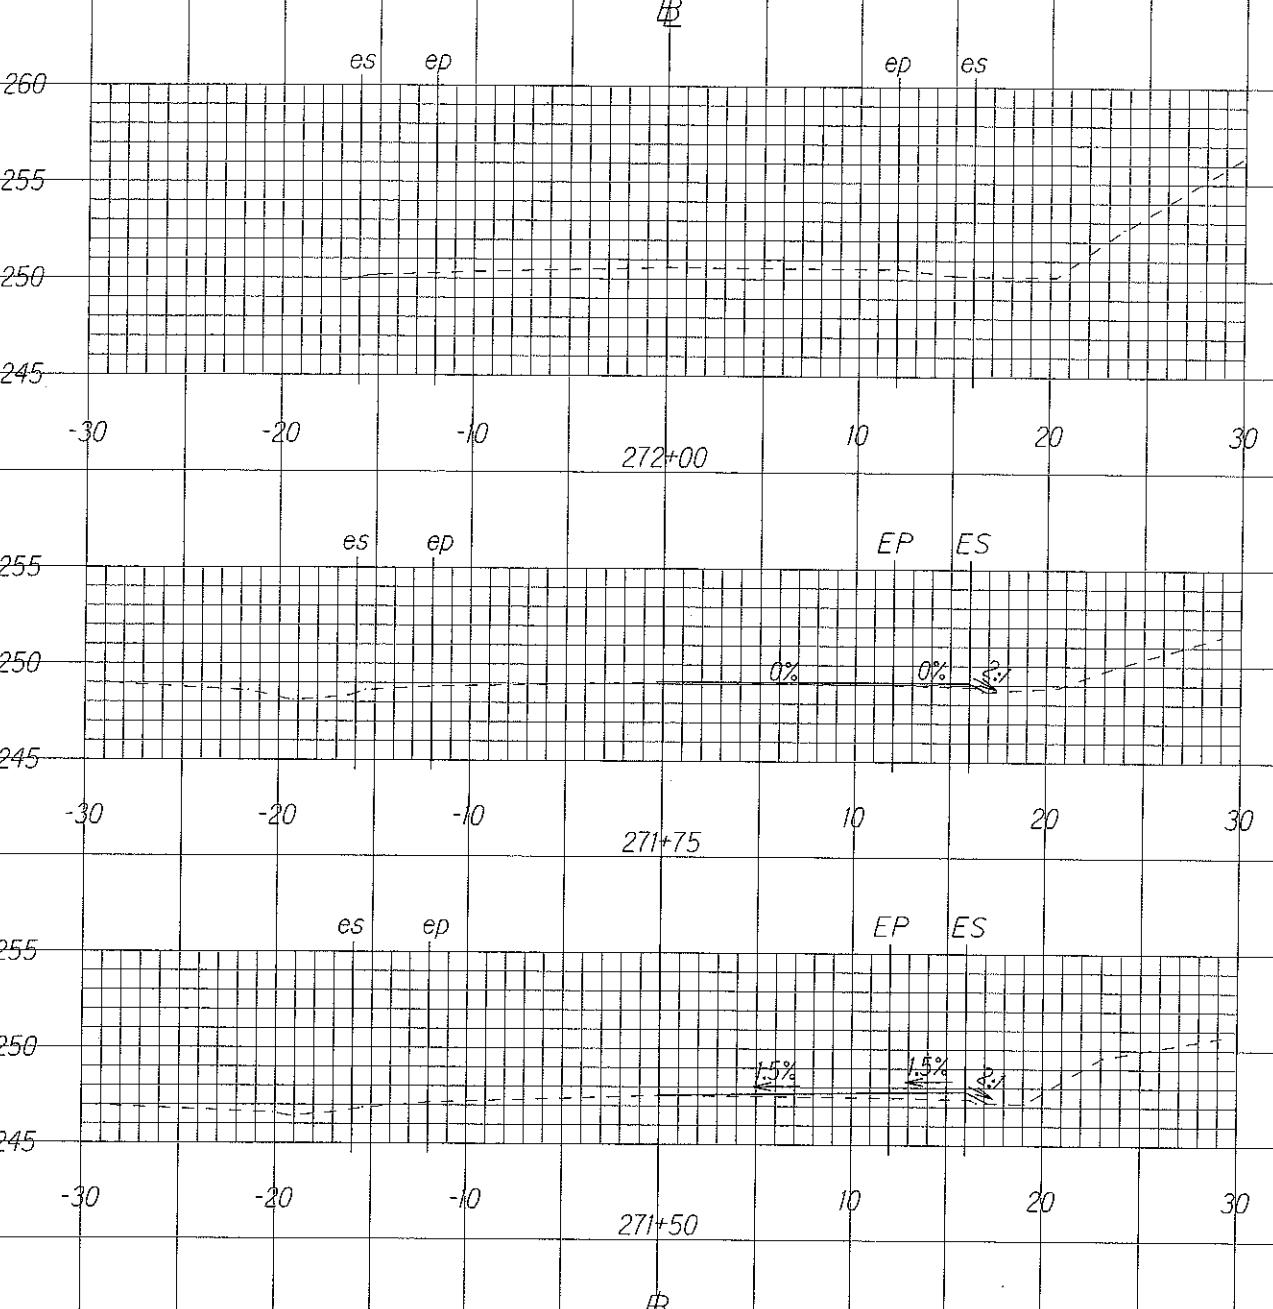

SURVEY PLOTTED BY	DATE
DRAWN BY	X
TRACED BY	
DESIGNED BY	X
QUANTIFIED BY	
CHECKED BY	

SCALE

Horizontal: 1"=5'
Vertical: 1"=5'

9/15/09 Revised Shoulder Slopes.

DATE REVISION

SHEET No. 8 OF 8 SHEETS

ADD. 34