


FED. ROAD DIST. NO. STATE FED. AID PROJ. NO. FISCAL SHEET NO. SHEETS

HAWAII HAW. HS-STP-011-2(38) 2010 44 141

TRUE NORTH

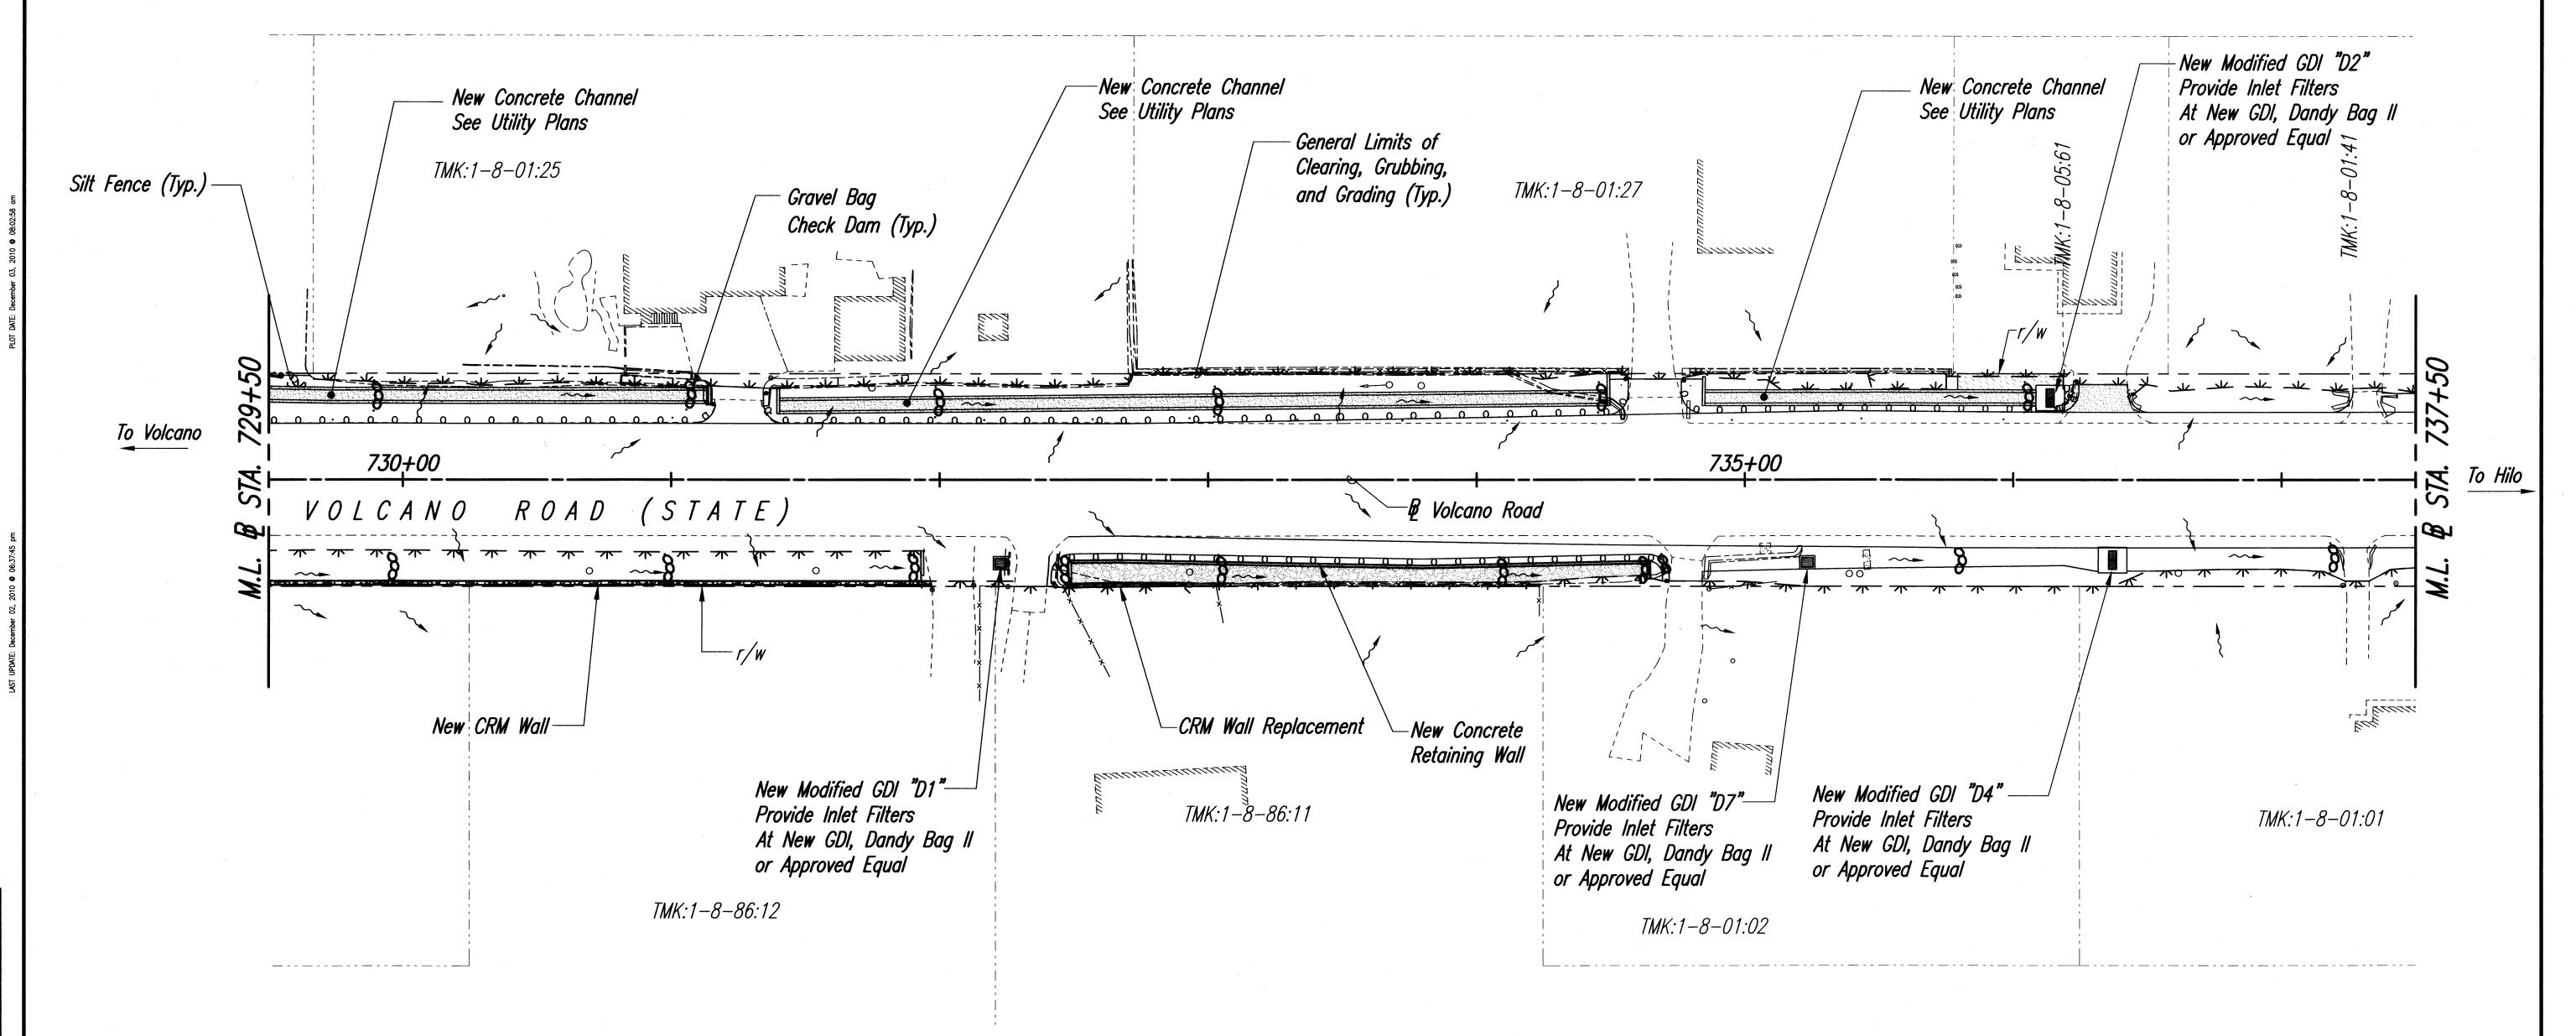

 ORIGINAL
 SURVEY PLOTTED BY
 DATE

 PLAN
 DRAWN BY
 "

 NOTE BOOK
 DESIGNED BY
 "

 QUANTITIES BY
 "

 QUANTITIES BY
 "

 CHECKED BY
 "

Legend

· coccocco · Gravel Bag

---- Silt Fence

Existing Contour

Direction of Surface Runoff

— Limits of Clearing, Grubbing, and Grading

Notes:

- 1. Place double width of curb inlet protectors at driveway entrance, where necessary. See Detail, Sheet 46.
- 2. Place gravel bag check dams at 100' o.c. in new and existing ditches/channels, and before driveway culverts.
- 3. See Sheet 46 for Typical Silt Fence Detail.



LICENSE EXPIRES 4/30/12

THIS WORK WAS PREPARED BY ME OR UNDER MY SUPERVISION

THIS WORK WAS PREPARED BY ME OR UNDER MY SUPERVISION

STATE OF HAWAII
DEPARTMENT OF TRANSPORTATION

EROSION CONTROL PLAN

<u>Volcano Road Intersection and</u>


<u>Drainage Improvements</u>

Federal-Aid Project No. HS-STP-011-2(38)


Scale: 1"=30'

Date: November 2010


SHEET No. 2 OF 4 SHEETS

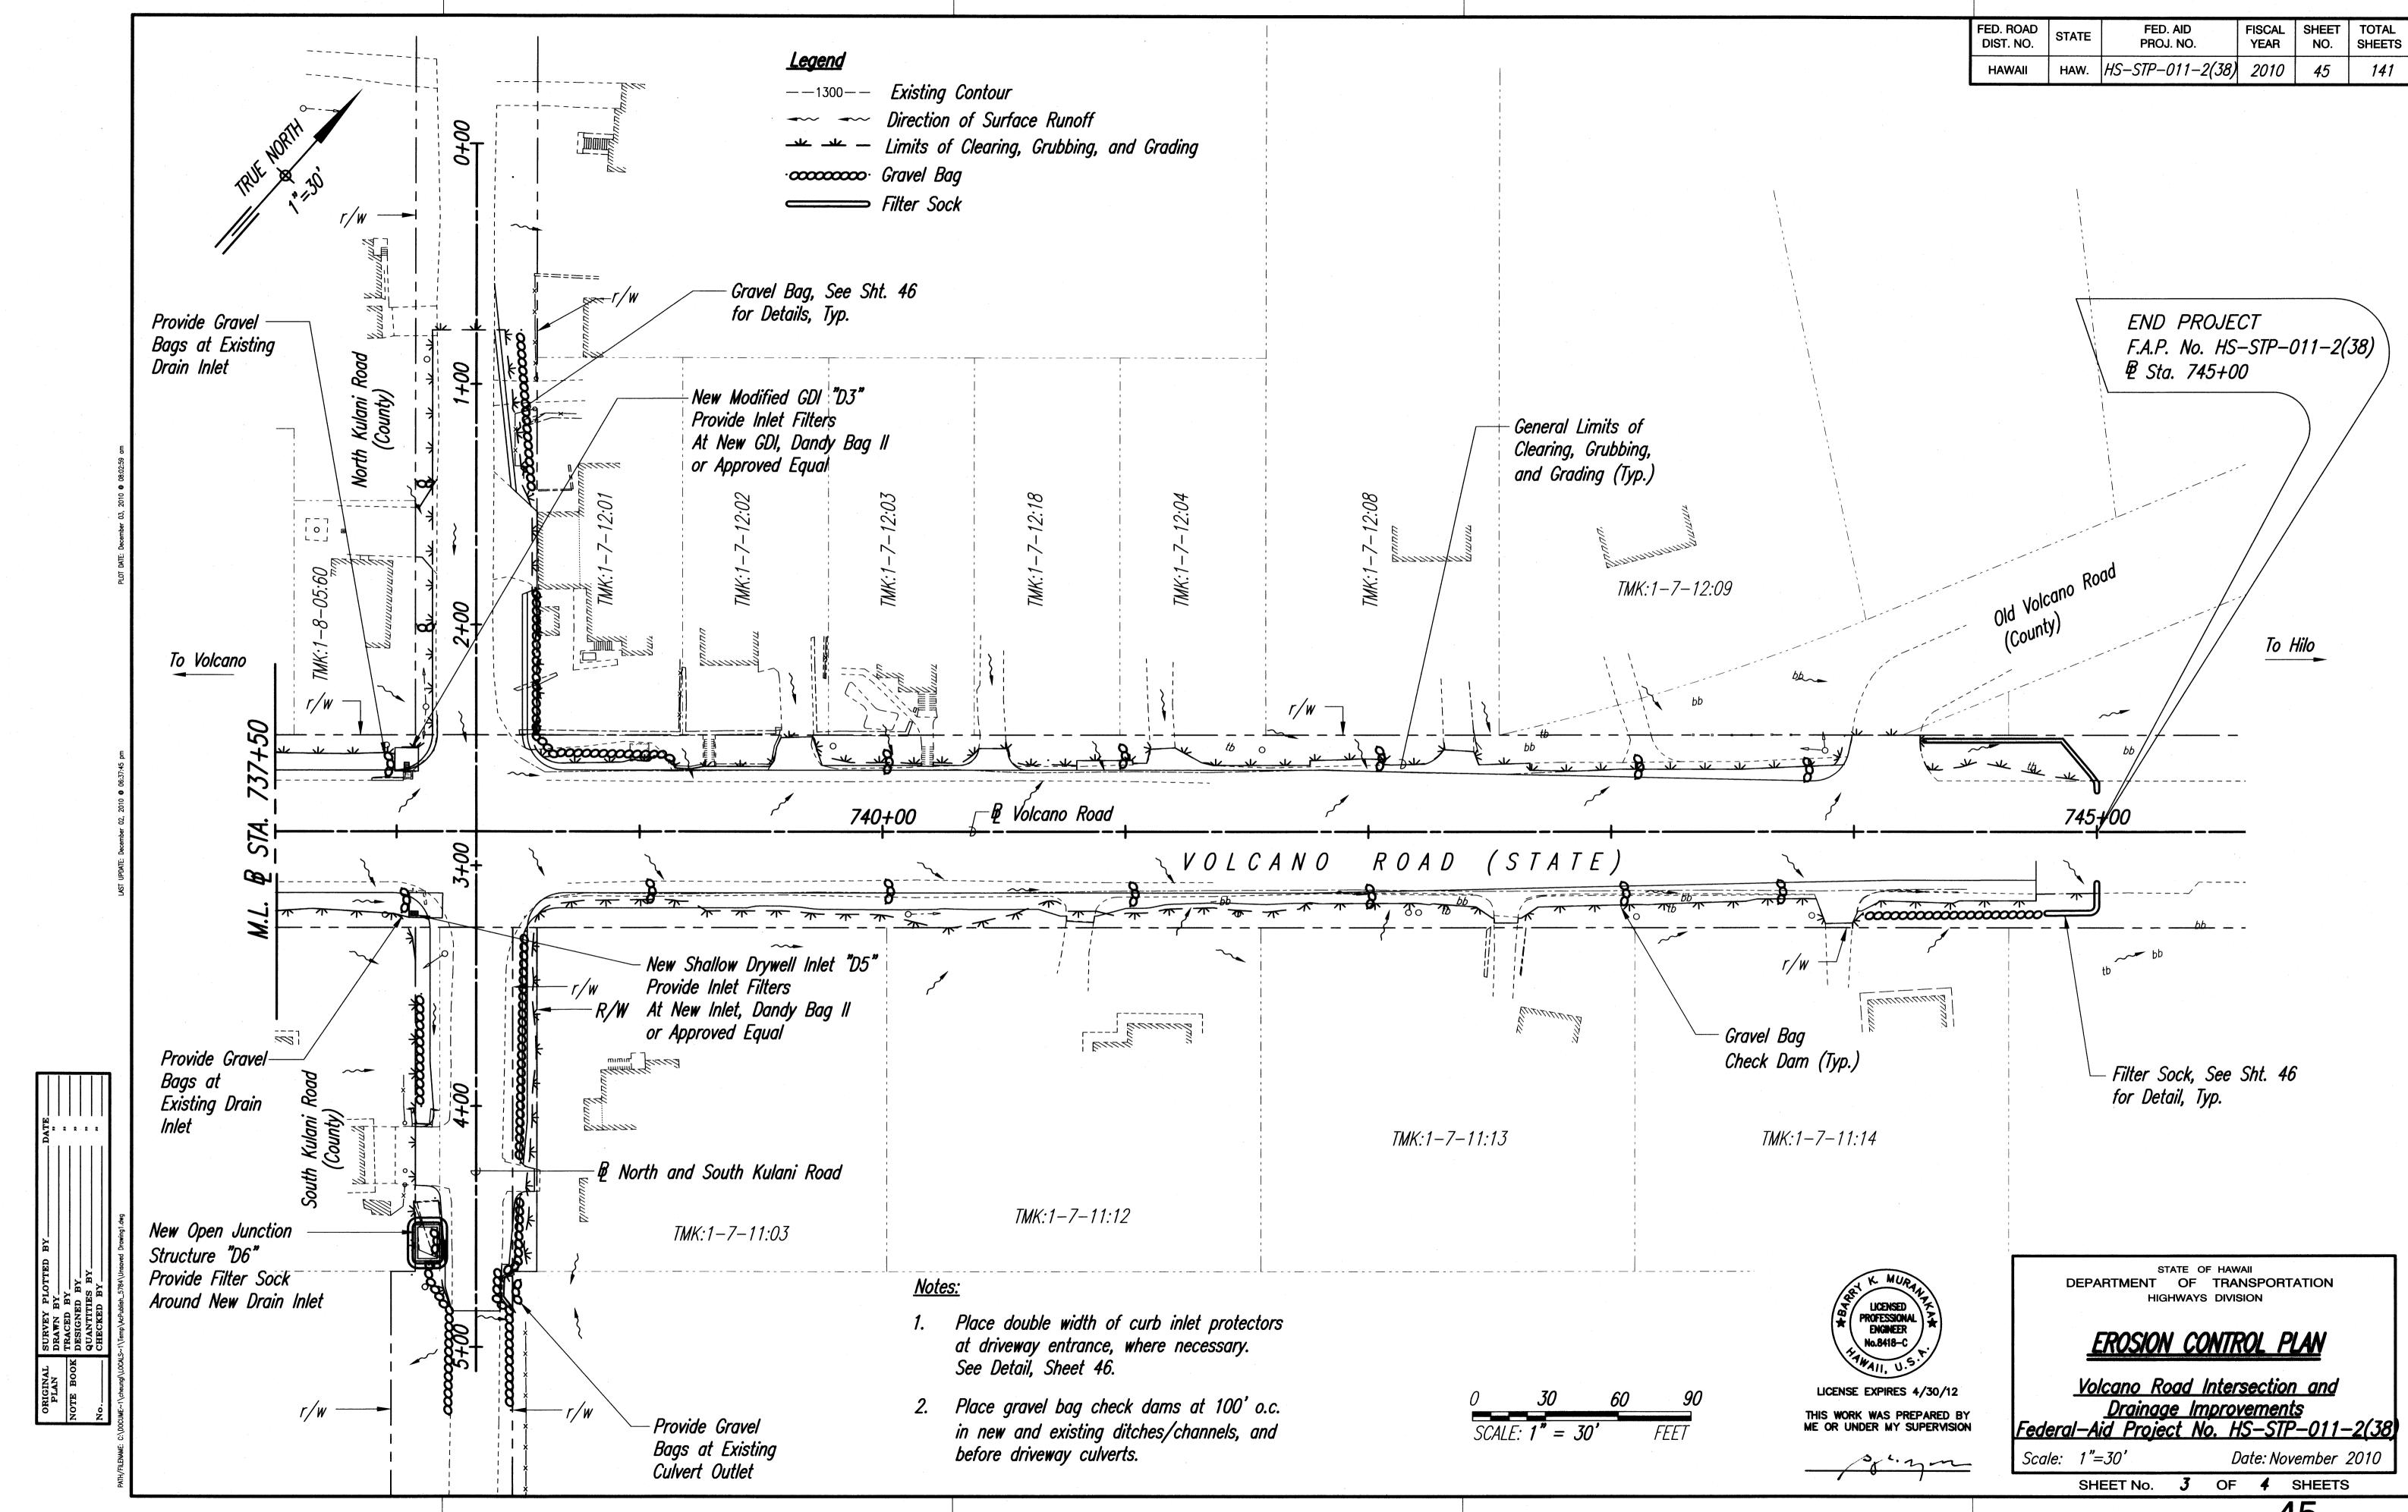

- Dandy Bag II is Manufactured by Dandy Producs, Inc., Grove City, Ohio.
- The Contractor Shall Remove Filters During Times of Above Normal Rainfall Events and Replace Them When Event Has Passed.
- The Contractor Shall Remove All Accumulated Sediment and Debris from Vicinity of Unit After Each Storm Event. The Sediment Bag Should be Checked After Each Storm Event and at Regular Intervals. If the Containment Area is More than 1/3 Full of Sediment, the Unit Must be Emptied.

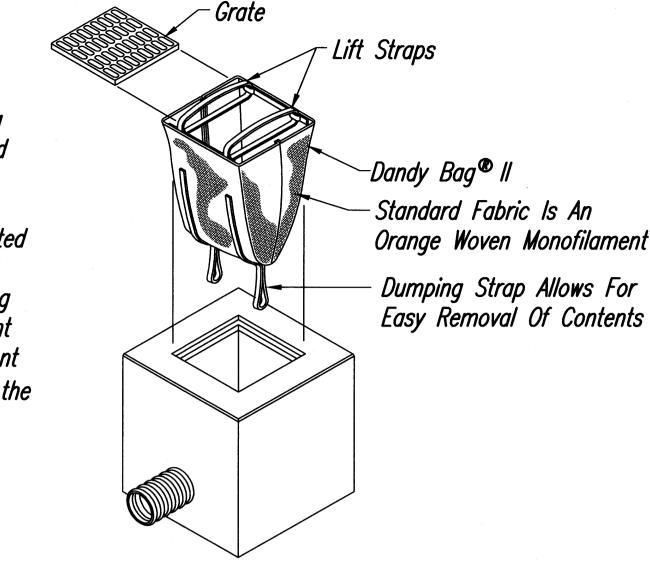


DANDY BAG II FOR CURB INLET Not To Scale

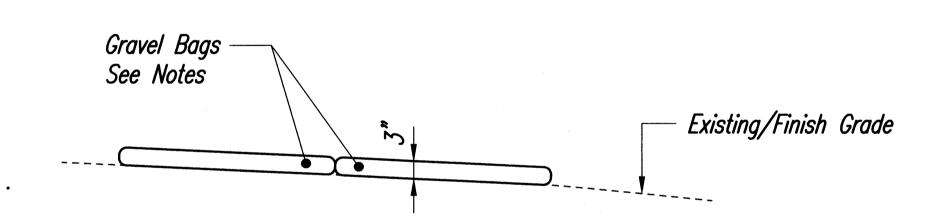

GRAVEL BAG TYPICAL DETAIL Not To Scale


Gravel Bag Berm Notes:

- Bag Material: Bags Should be Woven Polypropylene, Polyethylene or Polyamide Fabric or Burlap, Minimum Unit Weight of 4 Ounces/yd2, Mullen Burst Strength Exceeding 300 lb/in2 in Conformance with the Requirements in ASTM Designation D3786, and Ultraviolet Stability Exceeding 70% in Conformance with the Requirements in ASTM Designation D4355.
- 2. Bag Size: Each Gravel-Filled Bag Should Have a Length of 18 in., Width of 12 in., Thickness of 3 in., and Mass of Approximately 33 lbs. Bag Dimensions Are Nominal, and May Vary Based on Locally Available Materials.
- 3. Fill Material: Fill Material Should be 0.5 to 1 in. Class 2 Aggregate Base, Clean and Free from Clay, Organic Matter, and Other Deleterious Material, or Other Suitable Open-Graded, Non-Cohesive, Porous Gravel.
- 4. Turn the Ends of the Gravel Bag Barriers Up Slope to Prevent Runoff from Going Around the Berm.
- 5. Butt Ends of Bags Tightly.

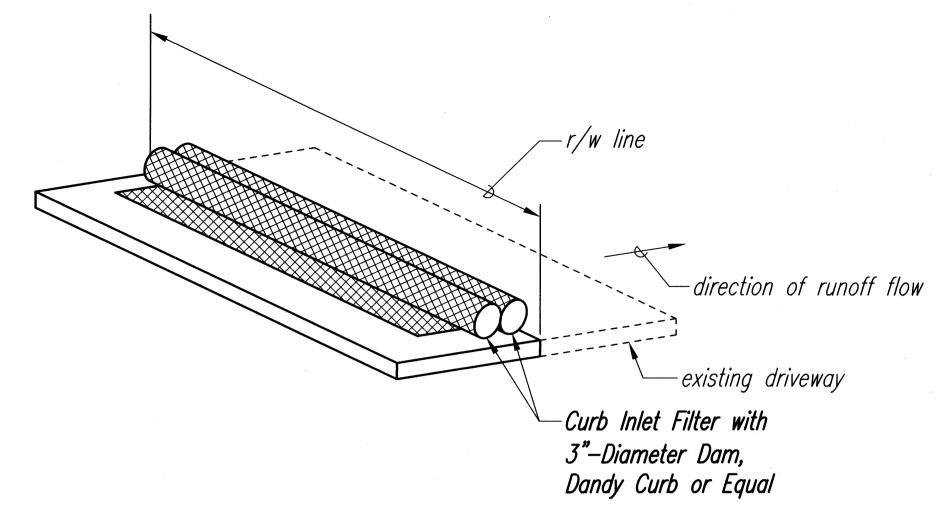


TYPICAL DRIVEWAY RUNOFF PROTECTION

Not To Scale

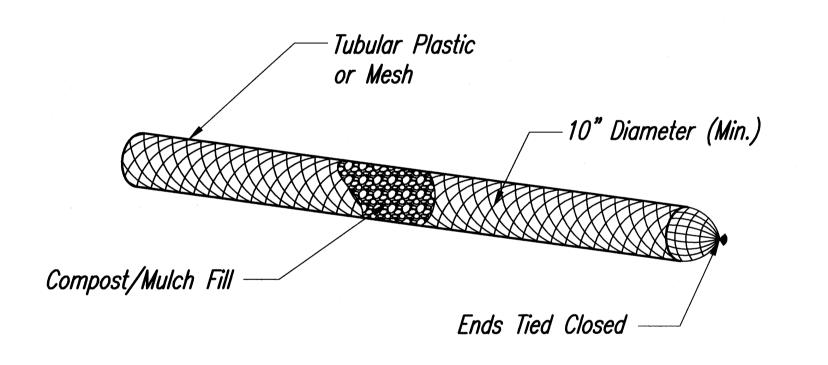

FILTER SOCK DETAIL Not To Scale

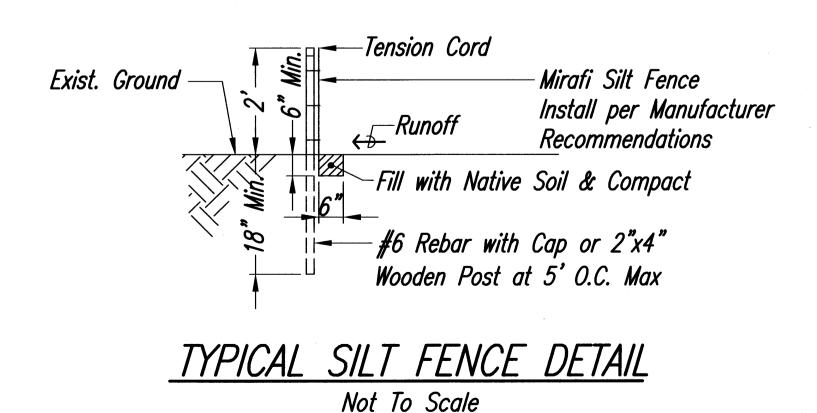

Compost Filter Sock Notes:

Installation:

Installation shall be done according to the Manufacturer's recommendations.

FED. ROAD

DIST. NO.

STATE

PROJ. NO.


HAW. HS-STP-011-2(38) 2010 46

FISCAL YEAR

- Assemble by tying a knot at one one of the mesh sock, filling the sock with compost, and knotting the other end of the sock. A pneumatic blower may be used to fill the sock with compost.
- For multi-sock use, place socks end-to-end and interlock the ends.
- Anchor filter socks to ground; stakes shall be installed per the Manufacturer's recommendations. Where staking is not possible, heavy concrete blocks shall be used behind the filter sock for stabilization during rainfall events.
- Turn ends of filter sock up slope to prevent flow around the ends.
- 2. Material for compost berm may be left at the site and used as a soil amendment.

3. Inspection & Maintenance:

- Contractor shall inspect the filter sock(s) weekly during dry periods, daily during periods of prolonged rainfall, and within 24 hours of any rainfall event of 0.5 inch or greater that occurs within a 24-hour
- The Contractor shall remove all accumulated sediment and debris from vicinity of filter sock(s) after each storm event. Remove sediment which has accumulated to within 1/3 of the berm height.

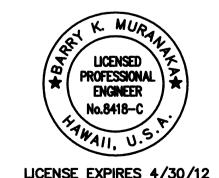

LICENSE EXPIRES 4/30/12

Volcano Road Intersection and Drainage Improvements

STATE OF HAWAII DEPARTMENT OF TRANSPORTATION


EROSION CONTROL DETAILS

Scale: Not To Scale

Federal-Aid Project No. HS-STP-011-2(38) Date: November 2010

SHEET No. 4

OF **4** SHEETS

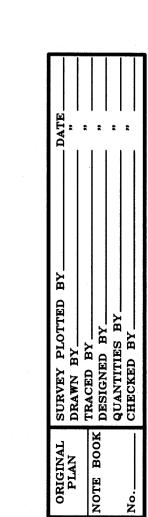

THIS WORK WAS PREPARED BY ME OR UNDER MY SUPERVISION Jog C. you