		SYMBOL		DESCRIPTION
TOP	Ø	EXISTING	NEW	DESCRIPTION
				Fluorescent Luminaire, Ceiling Mounted (Numeral In Circle Corresponds To Luminaire Schedule)
·			Ø	Luminaire, Ceiling Mounted (Numeral In Circle Cooresponds To
			Ø₁	Luminaire, Wall Mounted (Numeral In Circle Corresponds To Luminaire Schedule)
	46"		\$ ^a	Light Switch, Flush Wall Mounted, 1P20A, 120/277V, 1HP Max (Letter Indicates Luminaires Controlled)
***************************************	18"		→	Receptacle, Duplex, Grounding Type, 125V, NEMA Type 5-20R
	18"		+	Receptacle, Duplex, GFCI Type, 125V, NEMA Type 5-20R, Mounting Height +18" Or Unless Otherwise Noted [1]
6'-0"		e S	4	Panelboard
				Electrical Equipment
6'-0"		드거		Non-Fused Disconnect Switch, 2P30A Unless Otherwise Noted Voltage To Match Circuiting
			<u> </u>	Junction Box, Horizontally Mounted
	18"		<u></u>	Junction Box, Wall Mounted
				Equipment Termination With Flexible Conduit Whip
				Junction Box, Large, Horizontally Mounted
				Junction Box, Large, Wall Mounted
	18"		K	Telephone Outlet Box, Wall Mounted With Blank Device Plate
olaren er bedearminen mannen mannen			▲ <i>a</i>	Infared Motion Sensor With Photocell (Letter Indicates Luminaires Controlled). See Detail 2 on Sheet E-6 [1]
**************************************			+42"	Denotes 42" Above Finished Floor Or Grade
			WP	Weatherproof
			GFCI	Ground Fault Circuit Interrupter
			X	Denotes Demolition/Removal
			GND	Ground
		<i>eE</i>		Concealed Conduit Below Grade
		1		Concealed Conduit In Ceiling Or Walls, (Hashmarks Indicate 3—Wires Within, All Others Similar)
			/	Exposed Raceway, Provide Strap 8'-0" On Center Minimum
			A-1,3	Homerun Arrow To Panelboard. Letter Indicates Panelboard, Numbers Indicates Circuits
				Liquid-Tight Flexible Conduit
h-far-mar/dat+f-man-a-sant-mark-a-con-a-san		eoH	оН	Overhead Lines
			1	Duct Indicator, See Duct Schedule, Sheet E-2
			◇	Note Indicator
			$\frac{1}{E-2}$	Detail Indicator: Top Half Denotes Detail Number, Bottom Half Denotes Sheet Number

	LUMINAIRE SCHEDULE	
TYPE	DESCRIPTION	LAMPS
1	Fluorescent, Ceiling Mounted Wraparound, 4' Long, Steel Housing, Acrylic Prismatic Diffuser, 120V Electronic Ballast. Columbia #AWN-4-232 EB8120V Lithonia #LB 232 120 GEB Or Approved Equivalent	2–F32 T8 3000K
2	Fluorescent, Wall Pack Mounted At +9'-0", Cast Aluminum Housing, Dark Bronze Powder Coat Finish, UV Stabilized Polycarbonate Refractor, Cutoff Optics With Forward Throw Distribution, Wet Location, 120V Electronic Ballast. Quality Lighting #OLV-12 F PLC-13 120 Lithonia #TWAC 120V Or Approved Equivalent	1—13W Quad 3000K
3	Fluorescent, 8' Pendant Mounted, Alumimun Housing, One Piece Impact Resistant Acrylic Diffuser, Enclosed and Gasketed, Baked White Enamel Finish, Wet Location, 120V Electronic Ballast. Columbia #LU8-232-EB8120-WL-HUBK Lithonia #DMW-2-32-AR-120-GEB or Approved Equivalent	4–F32 T8 3000K
4	Incandescent, Floodlight, 4" Round Light Kit With Box, Cover And (2) Lampholders, Bronze, 120V Raco #5829-7 Or Approved Equivalent	2-75W PAR38
5	Metal Halide, Flood Light, Heavy Duty Die—cast Aluminum Housing, Enclosed and Gasketed With Aluminum Reflector and Tempered Glass Lens, Wet Location, 120V HPF Ballast GE #SBF—70—M—120—H—TSVDB Or Approved Equivalent	1-70W MH
6	Quatrz Halogen, Floodlight, Heavy Duty, Die—Cast Aluminum Housing, Enclosed And Gasketed, Tempered Glass Lens, Wet Location, 120V. GE # QF300DB Or Approved Equivalent	1–300W Quartz Halogen

Size (AIVG)	PANEL "EM"			120/240 Volts, 1 Phase, 3 Wire 100A Main Lugs NEMA 3R Enclosure						MIN AIC: 10,000 Mounting: Surface			
- 1	CKT	1 112		CKT BKR Pole AMP		 		AD (KVA)			4 //CL	CKT NO	Cizo
Mire	NO					Phase A		Phase B		Pole	USL		
12	1	Lights	1	20	0.8	1.0			20		Gas Pump	2	1.
12	3	Ice Machine	1	20			0.6	_		2	Switched Neutral Sp	pace 4	1.
12	5	Water Cooler	1	20	0.6			,,,,,,,,,,,,,,,,,,,,,,,,,,,,,,,,,,,,,,	_	1	PFB	6	_
_	7	Spare	1	20			1.0	1.0	20	/	Diesel Pump	8	1.
_	9	Spare	1	20	1.0					2	Switched Neutral Sp	pace 10	1.
_	11	Spare	1	20			1.0	-		1	PFB	12	<u>_</u>
_	13	PFB	1	_	_				_	1	PFB	14	
-	15	PFB	1	-			_	_	_	1	PFB	16	-
_	17	PFB .	1	_	-	_			-	1	PFB	18	_
-	19	PFB .	1	_			_		_	1	PFB	20	_
Connected Load/Phase Total Connected Load Demand Factor					3.4 3.6								
					7.	0	KVA						
					0.8				1				
		Total Demand Load			5.	.6	KVA=	23	Al	MPS			


	<u>P</u> /	ANEL "DP"	120/240 Volts, 1 Phase, 3 Wire 225A Main Lugs NEMA 3R Enclosure							MIN AIC: 10,000 Mounting: Surface			
Wire Size	CKT NO	1 1/5		CKT BKR Pole AMP		CONN LOA		,		BKR Pole	USE	CKT NO	Wire Size
6	1	Future Welder	2		3.0	7.5				2	Trailer Panel "A"	2	2
6	3			60			3.0	7.5	100			4	2
4	5	Compressor	2		4.8	3.0				2	Trailer Panel "B"	6	6
4	7			80		······································	4.8	3.0	60			8	6
12	9	Lights	1	20	1.0	3.5				2	Manual Transfer Switch	10	4
12	11	Lights	1	20		,,,,,,,,,,,,,,,,,,,,,,,,,,,,,,,,,,,,,	1.0	3.5	80			12	4
	13	Spare	1	20	1.0	0.5			20	1	Receptacles	14	12
-	15	Spare	1	20			1.0	0.5	20	1	Receptacles	16	12
	17	PFB	1	_	_	_			_	1	PFB	18	_
_	19	PFB	1	_			-	_	_	1	PFB	20	_
	Connected Load/Phase					24.3 24.3							
Total Connected Load Demand Factor					48.6 KVA]				
					0.6				1				
		Total Demand Load	29	9.1	KVA=	121	Al	MPS					

FED. ROAD DIST. NO. STATE FED. AID PROJ. NO. FISCAL SHEET TOTAL SHEETS

HAWAII HAW. HWY-H-03-04M 2005 ADD.27 32


GENERAL NOTES:


- 1. The Locations Of Existing Known Underground Utilities Shown On Plan Are From Existing Records And Are Approximations Only. Exercise Extreme Caution When Construction Crosses Or Is In Close Proximity To Existing Underground Utilities. Tone For All Existing Underground Utilities Prior To Excavation. Damages To Existing Underground Utilities Shall Be Repaired At No Cost To The State.
- 2. All Utility Company Equipment Shall Be In Accordance With The Respective Utility Companies.
- 3. Where Indicated, Remove Existing Electrical Apparatus And Associated Exposed Conduit And Wiring. Where Concealed Conduits Are Indicated To Be Demolished, Remove Wiring From Concealed Conduits And Abandon Conduits In Place.
- 4. Paint All New Exposed Junction Boxes, Conduits And Fittings To Match Finishes.

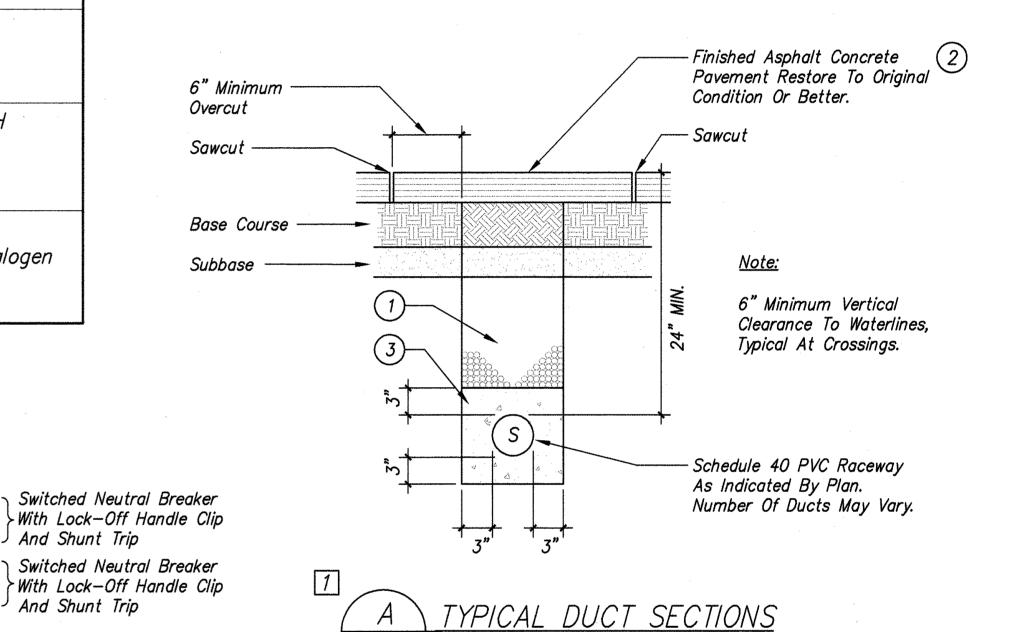


<u>NOTES:</u>


- 1) Type "A" Backfill Beach Sand, Earth, Or Earth And Gravel. If Earth And Gravel, The Maximum Rock Size Shall Be 1" And The Mixture Shall Not Contain More Than 50% By Volume Of Rock Particles.
- 2 Concrete Structure/Pavement Shall Be Equivalent Or Better Than Existing In Thickness And Quality.
- 3) Provide 3" Concrete Jacket Schedule 40 Under Roadway Conditions.

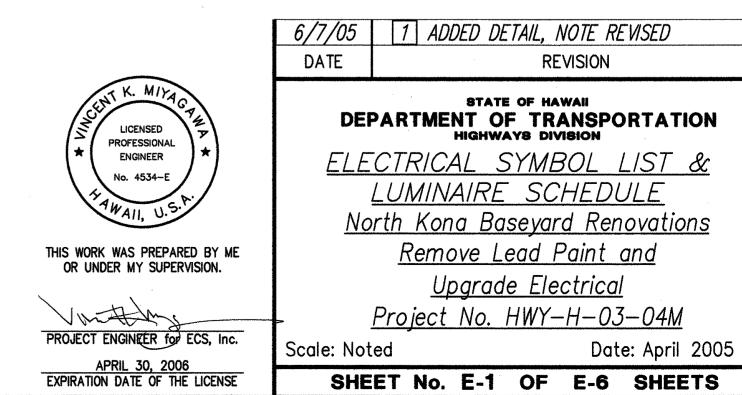


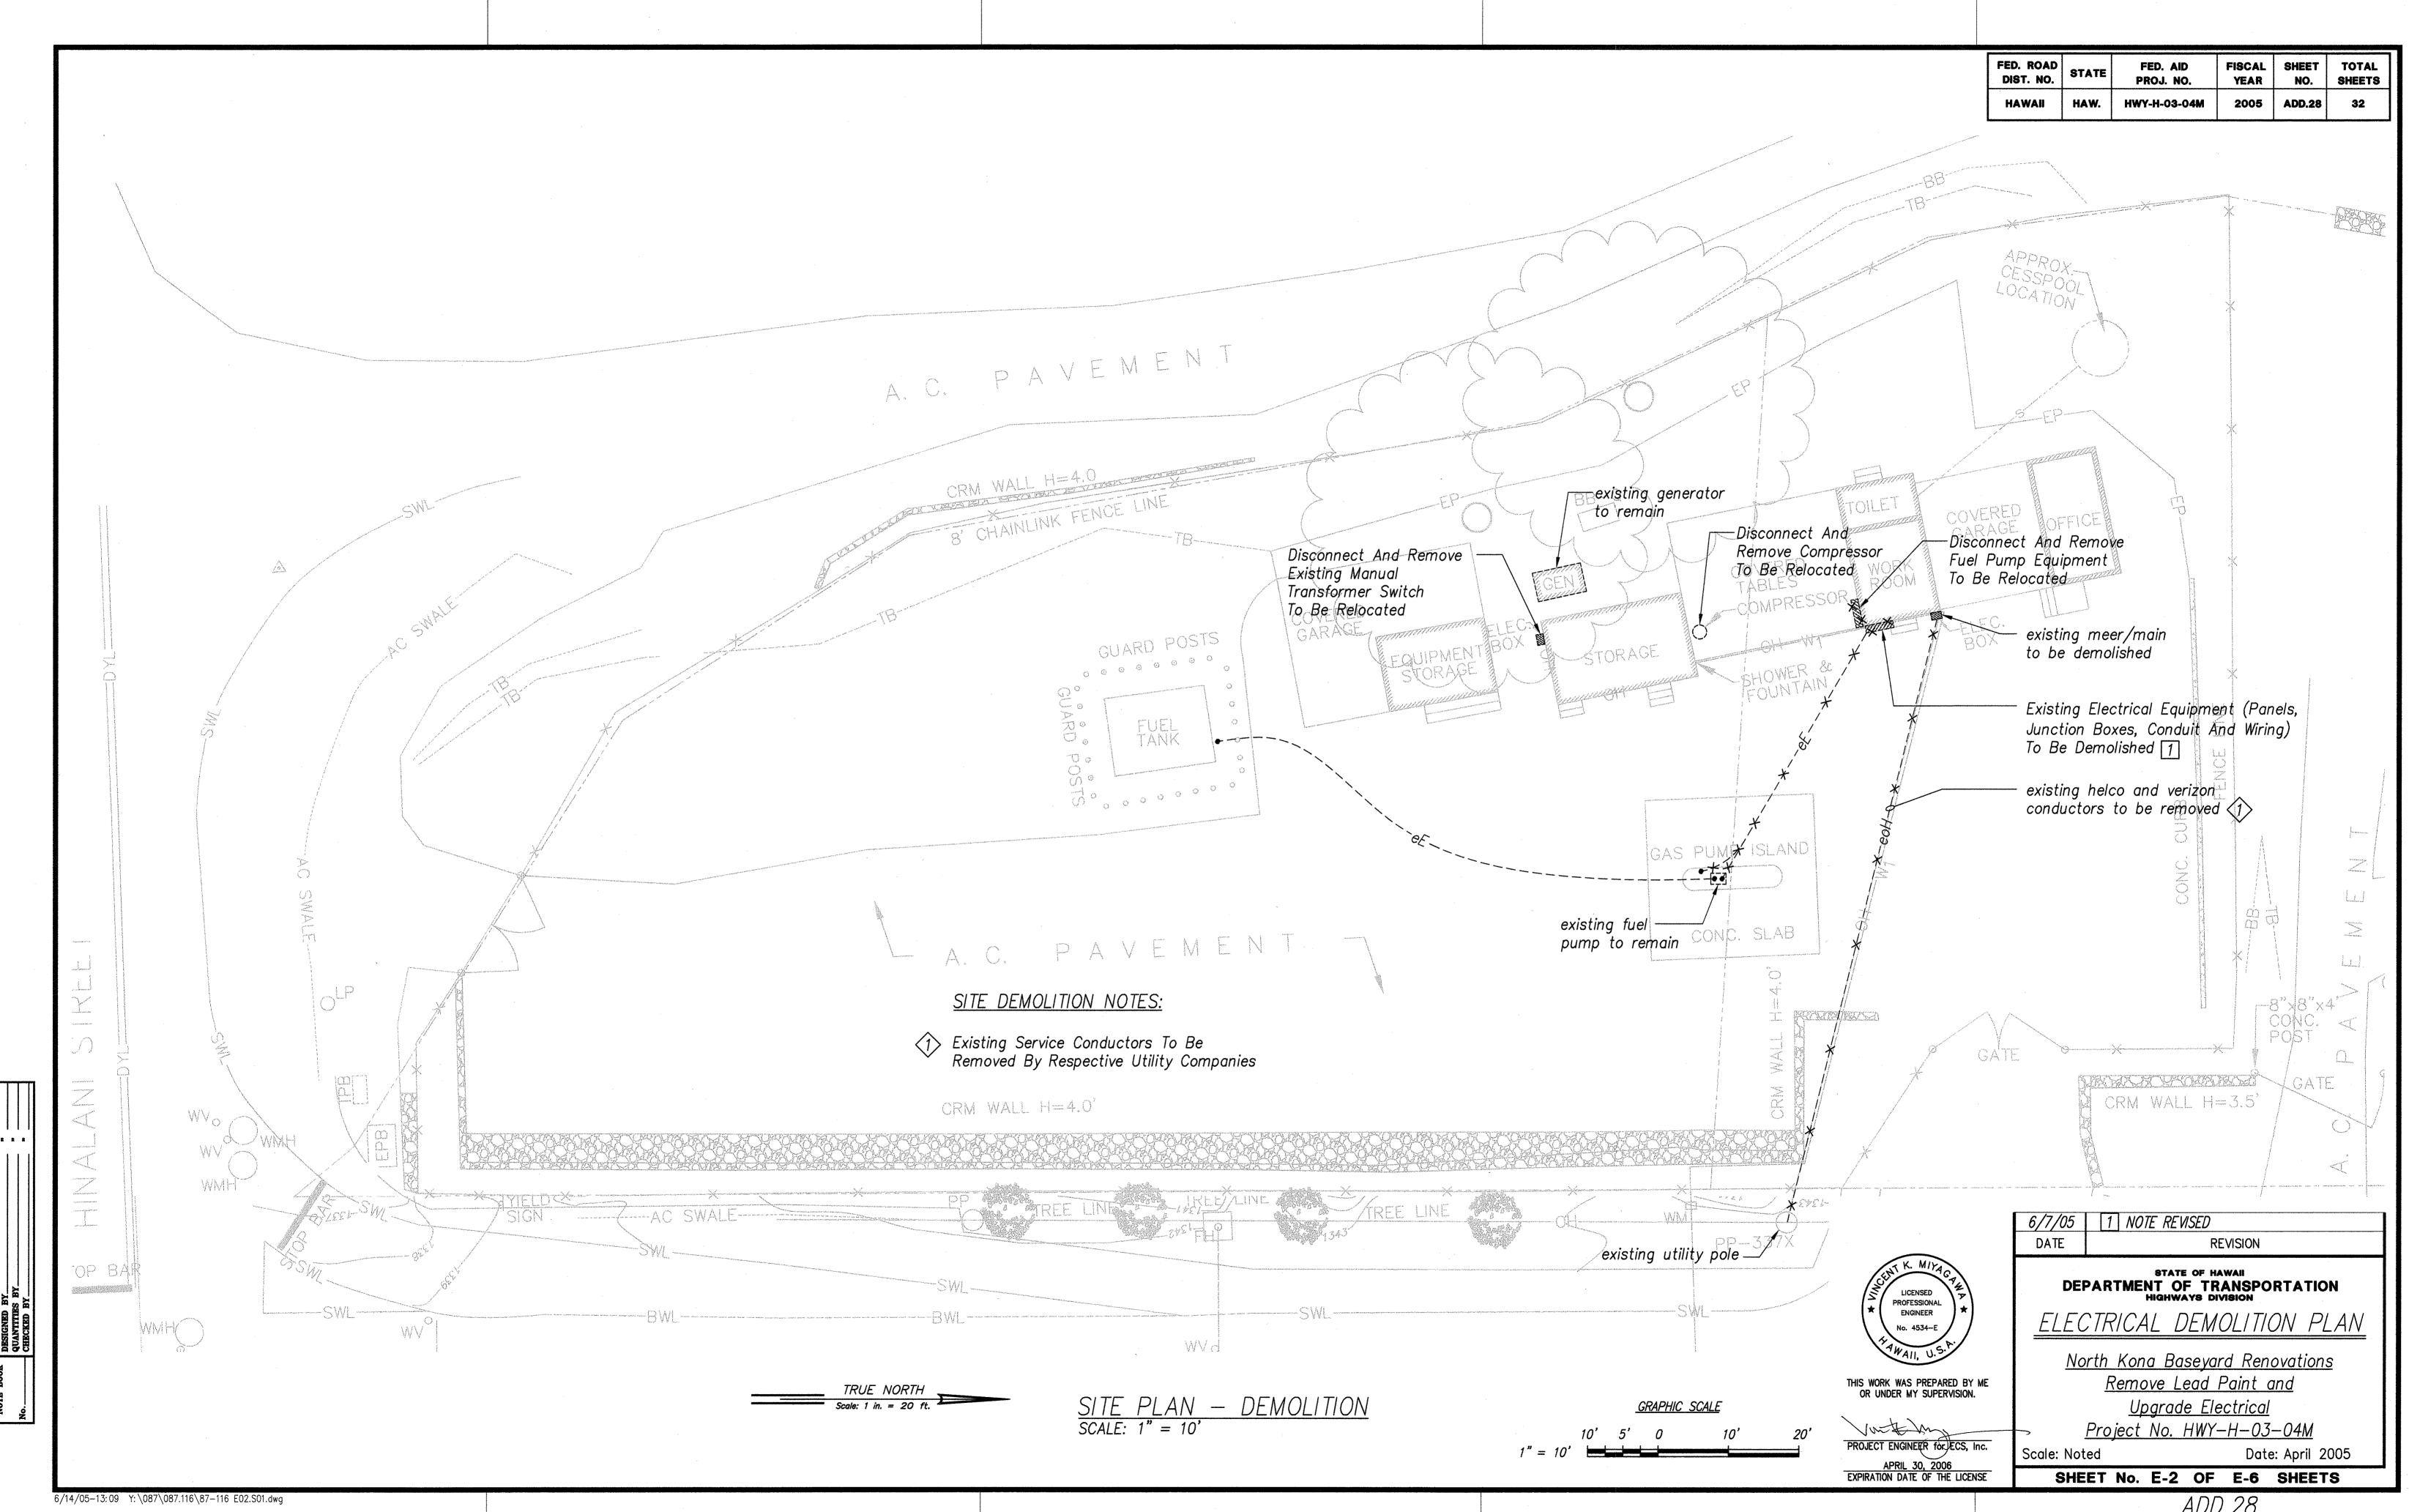


ADD.28

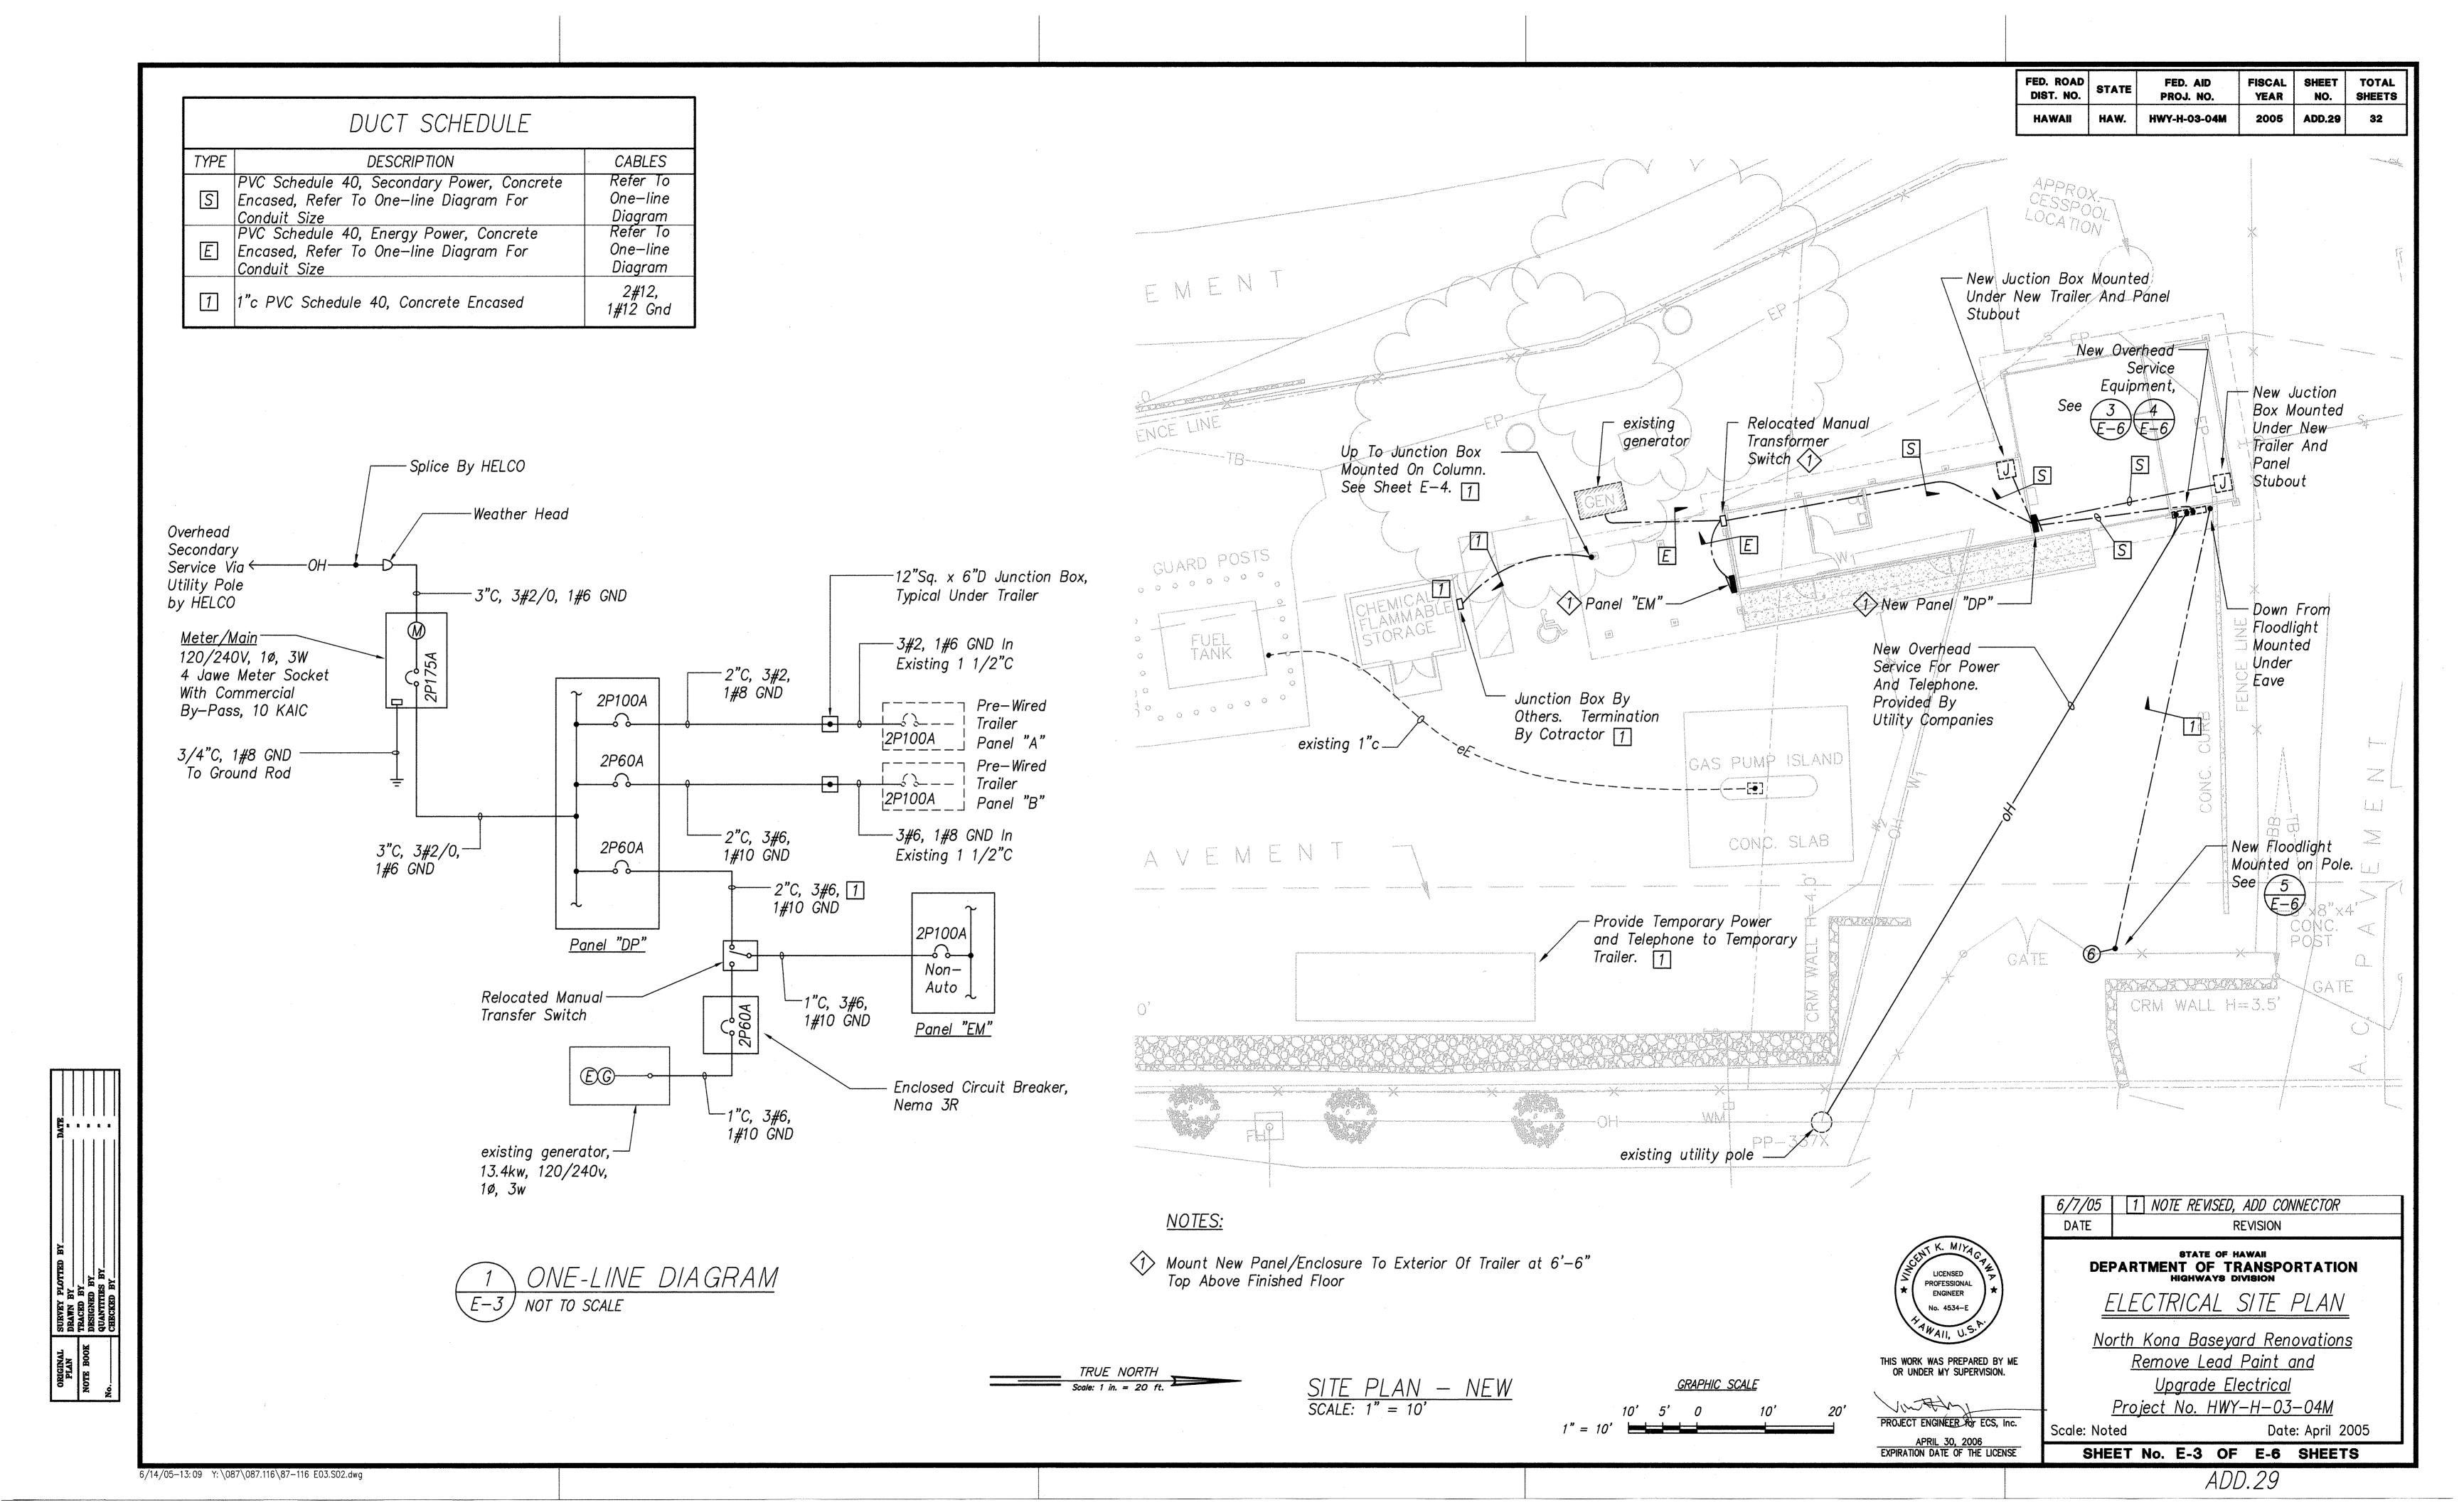

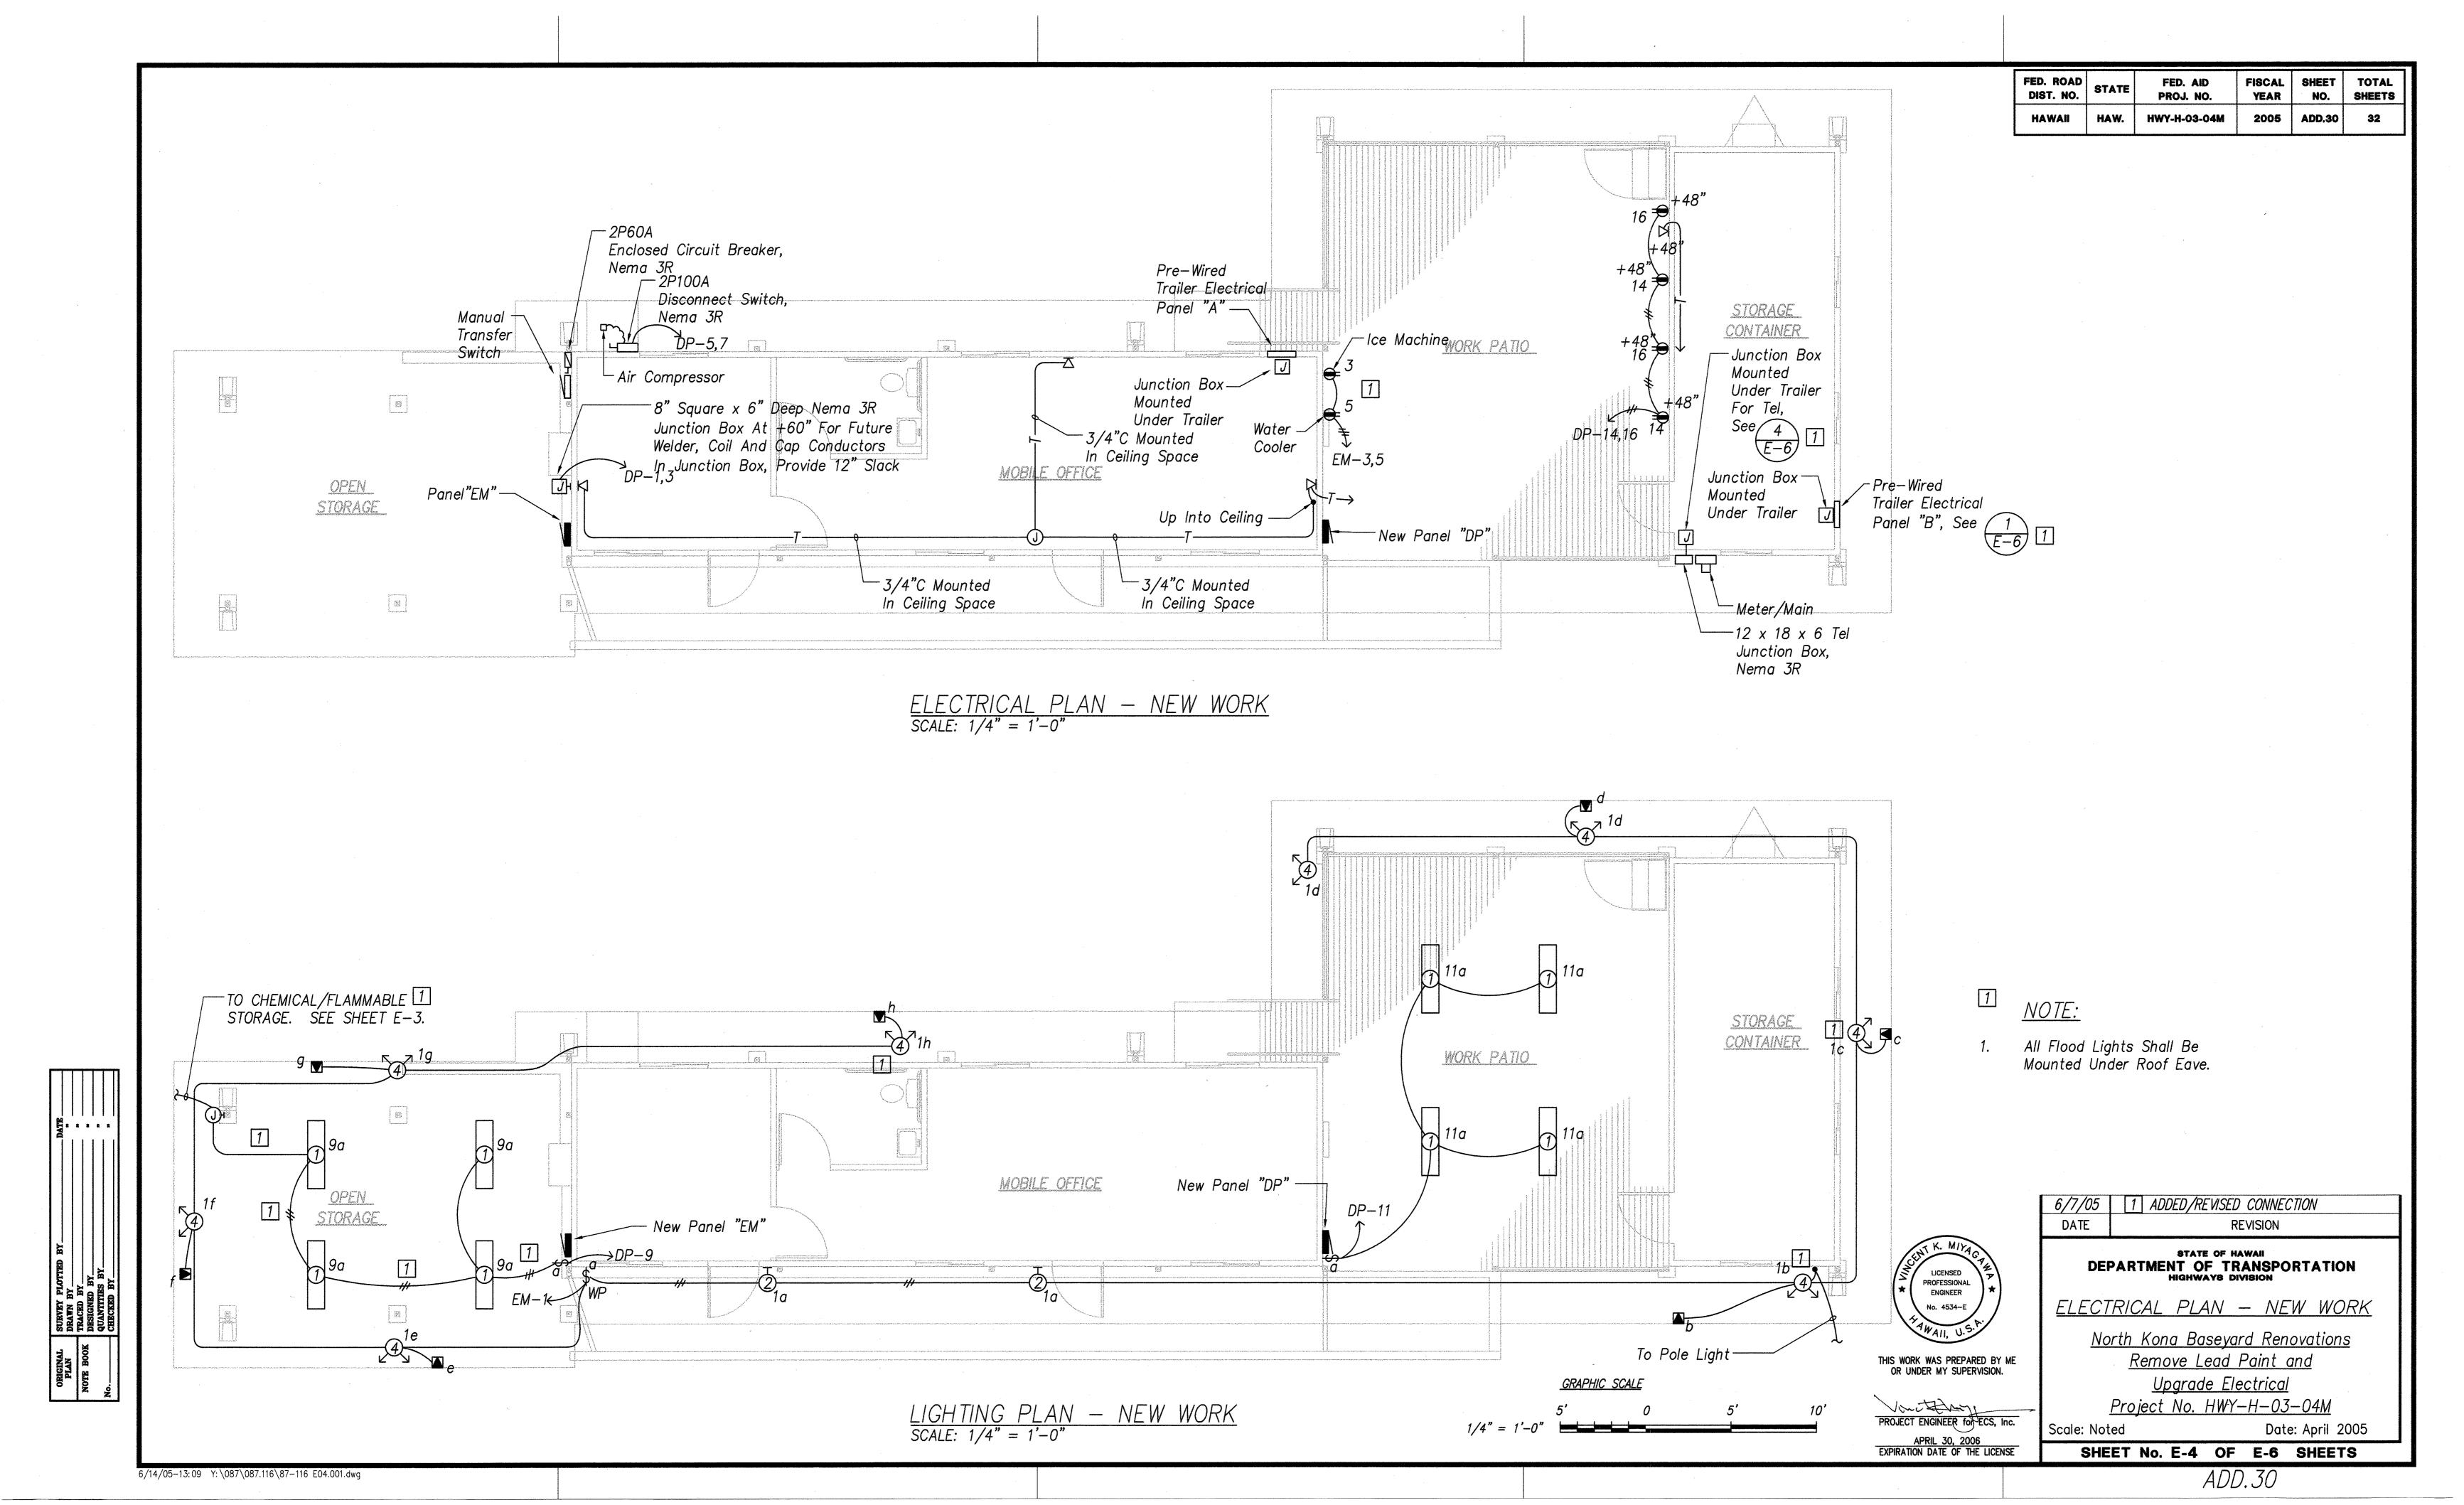

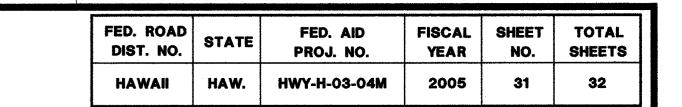

- Panel "EM"

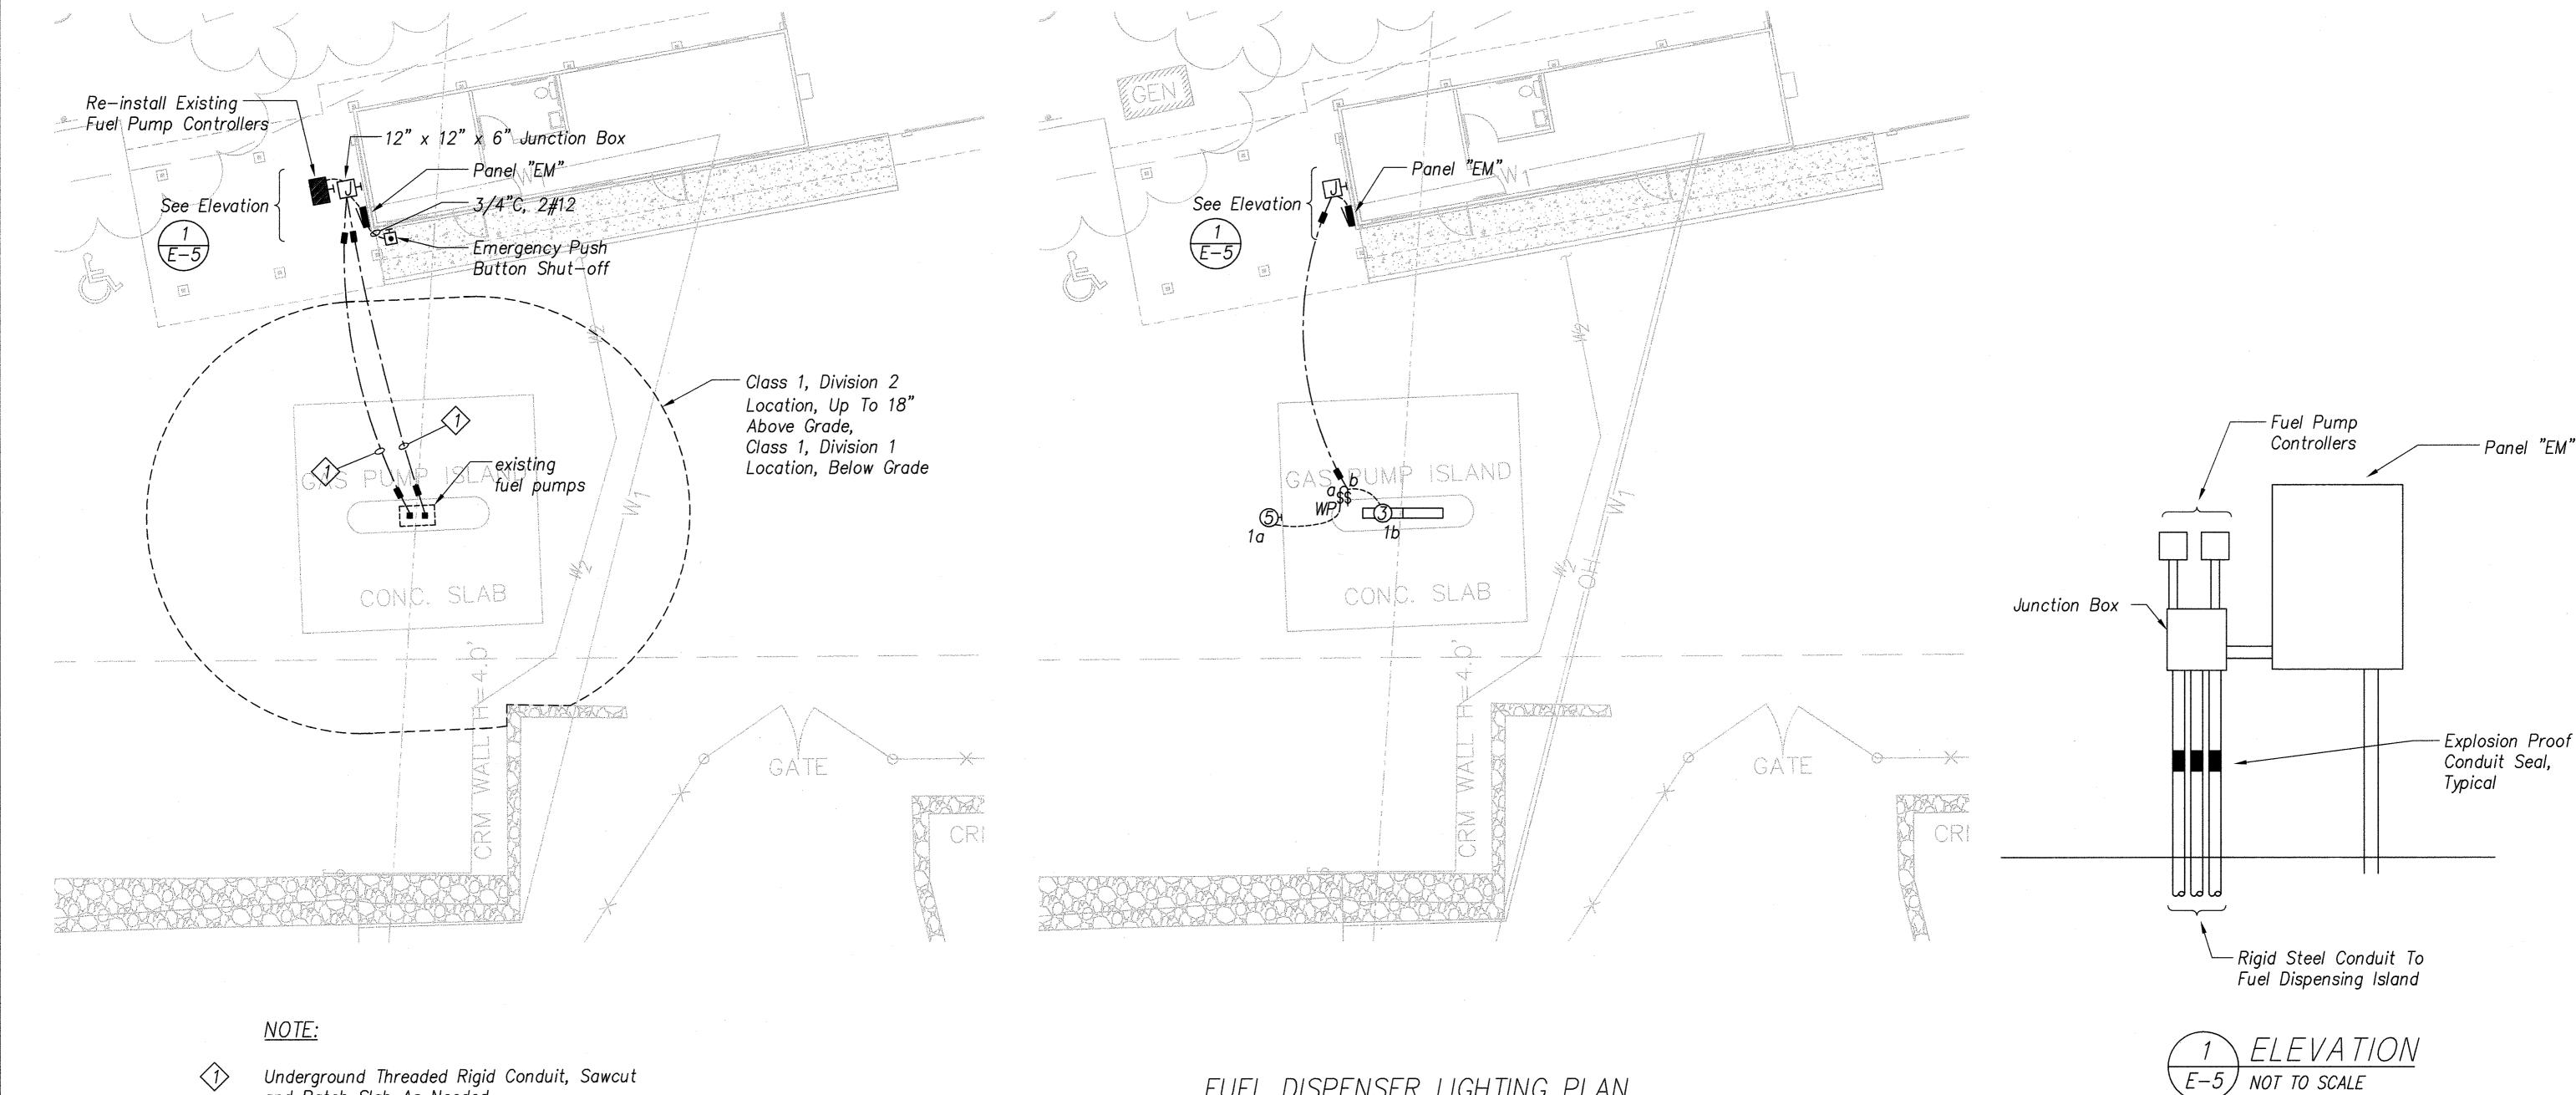



Underground Threaded Rigid Conduit, Sawcut and Patch Slab As Needed.

FUEL DISPENSER POWER PLAN SCALE: 1/8" = 1'-0"

FUEL DISPENSER LIGHTING PLAN SCALE: 1/8" = 1'-0"

GRAPHIC SCALE

1/8" = 1'-0"



THIS WORK WAS PREPARED BY ME OR UNDER MY SUPERVISION.

PROJECT ENGINEER for ECS, Inc.

APRIL 30, 2006

EXPIRATION DATE OF THE LICENSE

STATE OF HAWAII
DEPARTMENT OF TRANSPORTATION
HIGHWAYS DIVISION


FUEL DISPENSER ELECTRICAL PLANS North Kona Baseyard Renovations

Remove Lead Paint and <u>Upgrade Electrical</u>

Project No. HWY-H-03-04M


Scale: Noted Date: April 2005 SHEET No. E-5 OF E-6 SHEETS

FED. ROAD DIST. NO. FISCAL FED. AID SHEET TOTAL PROJ. NO. YEAR SHEETS HAW. HWY-H-03-04M 2005 HAWAII 32 32

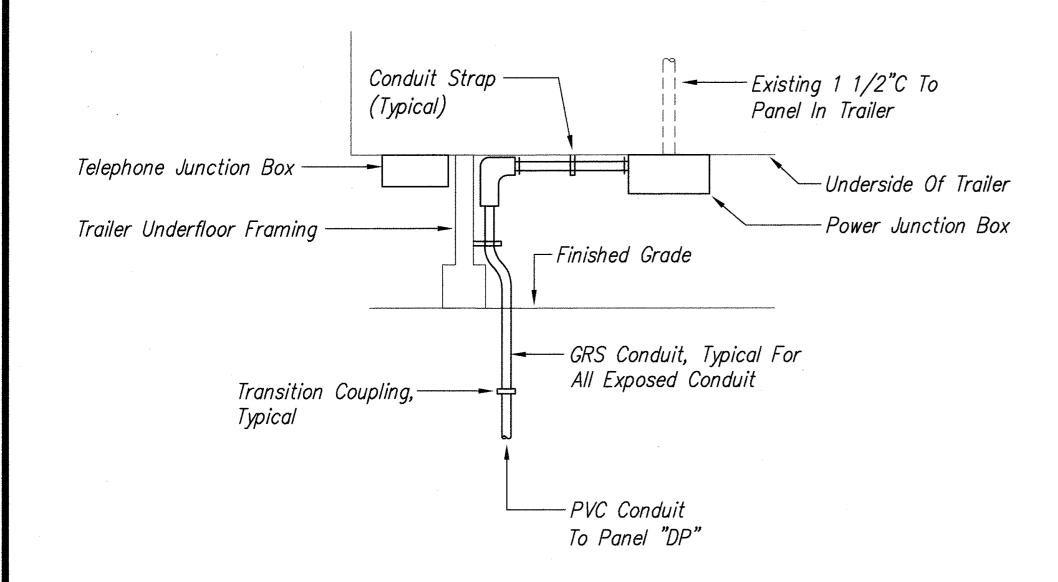



[E-6] NOT TO SCALE


TRAILER SERVICE CONNECTION

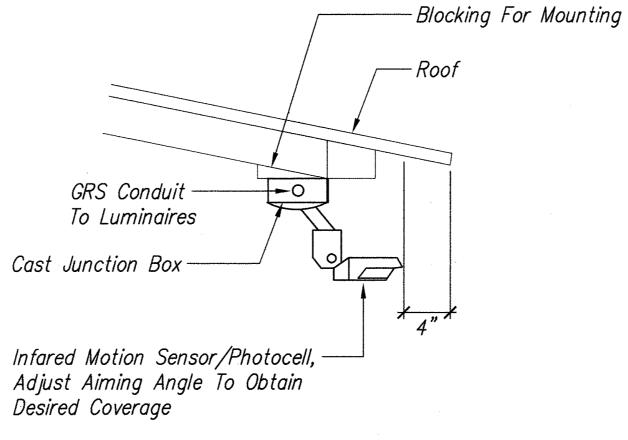



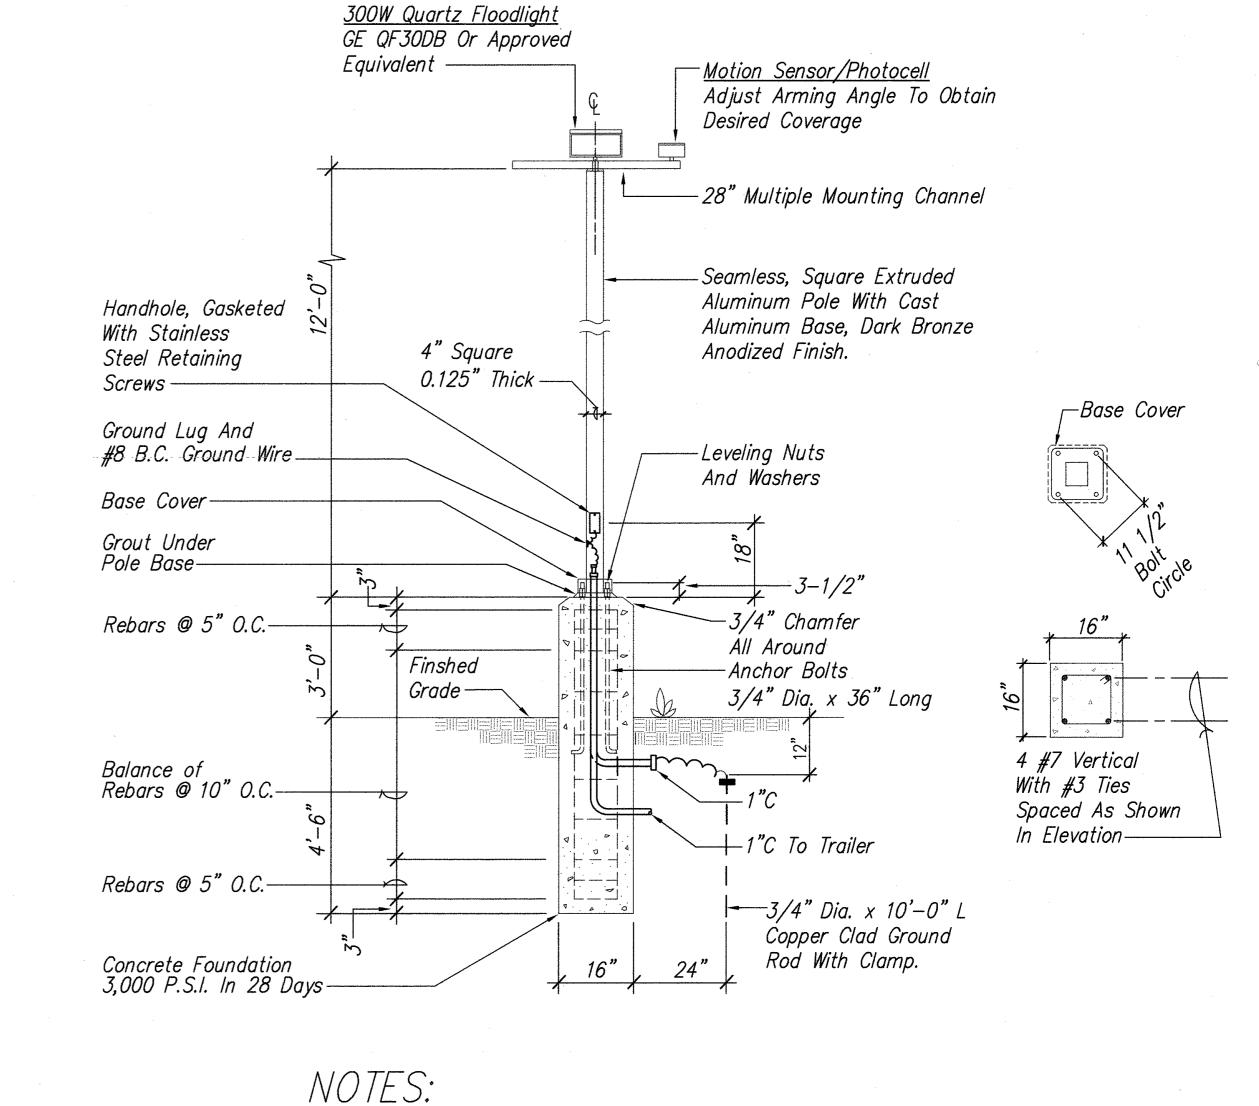

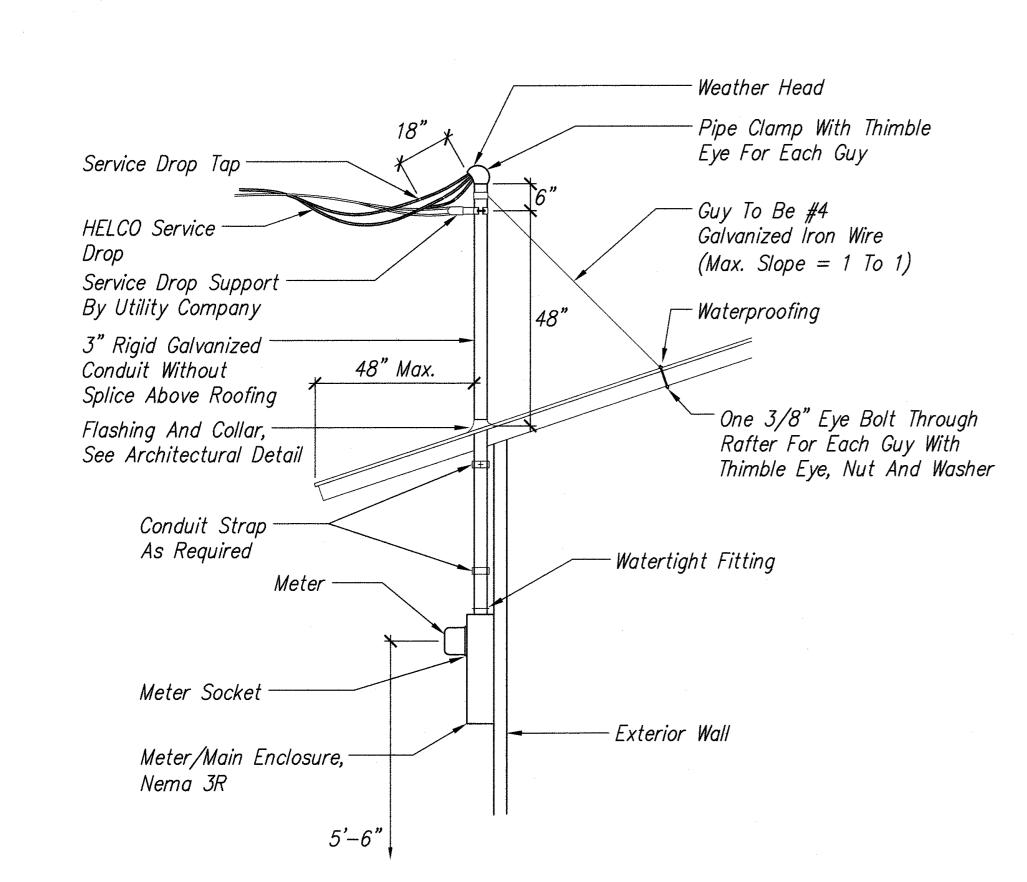

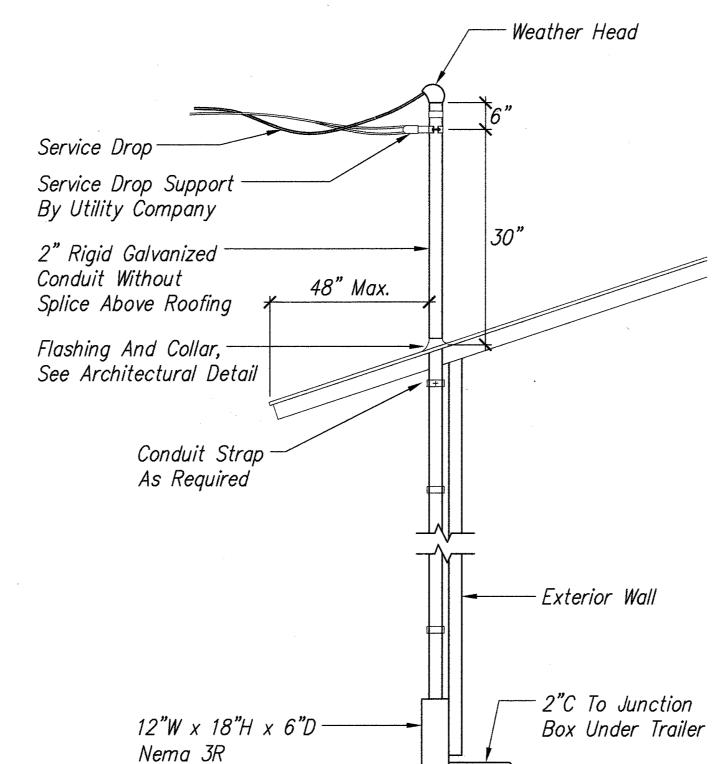

5 POLE MOUNTED FLOODLIGHT/SENSOR W/PEDESTAL DETAIL E-6) NOT TO SCALE

AREA LIGHT ASSEMBLY, INCLUDING POLE, LUMINAIRE AND

FOUNDAION SHALL WITHSTAND WINDS UP TO 108 MPH

GUSTING WITHOUT PERMANENT DEFORMATION.

OVERHEAD HELCO SERVICE DETAIL E-6) NOT TO SCALE

OVERHEAD TELEPHONE SERVICE DETAIL E-6) NOT TO SCALE

LICENSED PROFESSIONAL ENGINEER THIS WORK WAS PREPARED BY ME OR UNDER MY SUPERVISION.

PROJECT ENGINEER (for ECS, Inc.

MISCELLANEOUS DETAILS

North Kona Baseyard Renovations

Remove Lead Paint and <u>Upgrade Electrical</u> Project No. HWY-H-03-04M

STATE OF HAWAII
DEPARTMENT OF TRANSPORTATION
HIGHWAYS DIVISION

Scale: Noted Date: April 2005 SHEET No. E-6 OF E-6 SHEETS

APRIL 30, 2006

EXPIRATION DATE OF THE LICENSE

4/26/05-10:37 Y:\087\087.116\87-116 E06.003.dwg