




DEMOLITION NOTES

- 1. EXISTING PLANS DO NOT INDICATE COMPLETE EXISTING WIRING CONDITIONS. CONTRACTOR SHALL VERIFY EXISTING CONDITIONS PRIOR TO START OF WORK.
- 2. BEFORE ANY WIRING IS CUT, CONTRACTOR SHALL VERIFY USAGE OF WIRING TO BE CUT TO ASSURE THAT SERVICES REQUIRED ARE NOT DISCONTINUED. PROVIDE ADDITIONAL WIRING DEVICES AND OTHER ACCESSORIES TO ENSURE CONTINUITY OF SERVICE TO OTHER PARTS OF INSTALLATION TO REMAIN.
- 3. REMOVE ALL EXISTING WIRING NOT TO REMAIN IN SERVICE.
- 4. REMOVE ALL CONDUITS NO LONGER REQUIRED.
- 5. PHASE WORK TO ASSURE CONTINUITY OF ELECTRICAL, TELEPHONE AND SIGNAL SERVICES TO PARTS OF FACILITIES THAT WILL REMAIN IN USE.
- 6. REMOVE ALL EXISTING LIGHTING FIXTURES, RECEPTACLES AND SWITCHES INDICATED TO BE REMOVED OR NO LONGER REQUIRED. BLANK OUTLETS AND PLUG ALL HOLES IN BOXES AND CABINETS.
- 7. DELIVER ALL SALVAGEABLE MATERIAL AS DETERMINED BY ENGINEER AT NO ADDITIONAL COST TO OWNER. PACK MATERIAL IN BOXES. COIL ALL CABLES AND TIE.
- 8. RETURN ALL REMOVED LIGHT FIXTURES TO OWNER. DELIVER ITEMS AND STACK IN LOCATION AS DETERMINED BY ENGINEER.
- 9. DURING THE REMOVAL OF THE EXISTING PANEL, POWER OUTAGE TO THE PUMP STATION SHALL BE KEPT TO A MINIMUM. FUEL PUMP STATIONS SHALL BE TEMPORARILY CONNECTED TO OFFICE TRAILER PANEL.

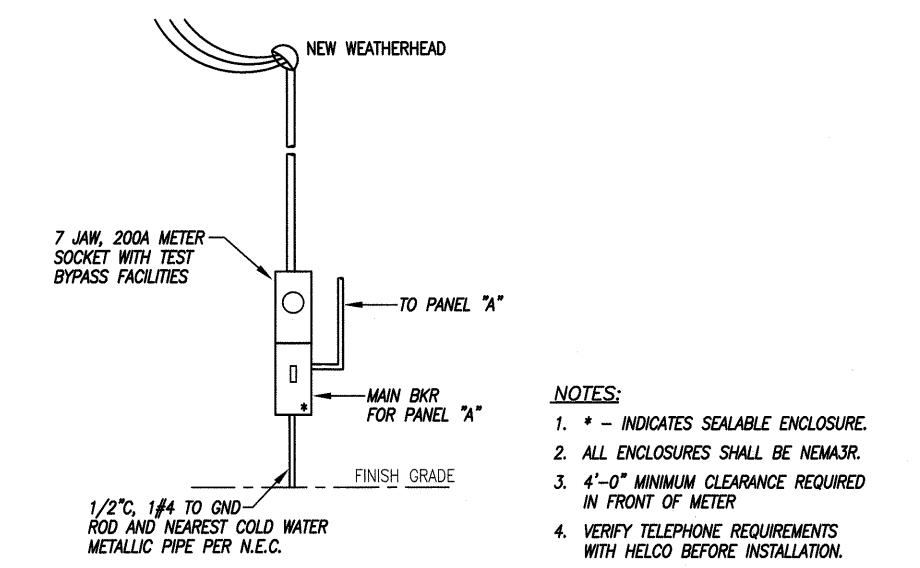


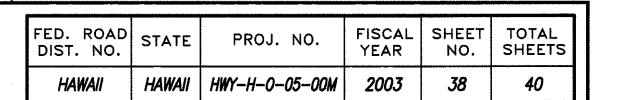




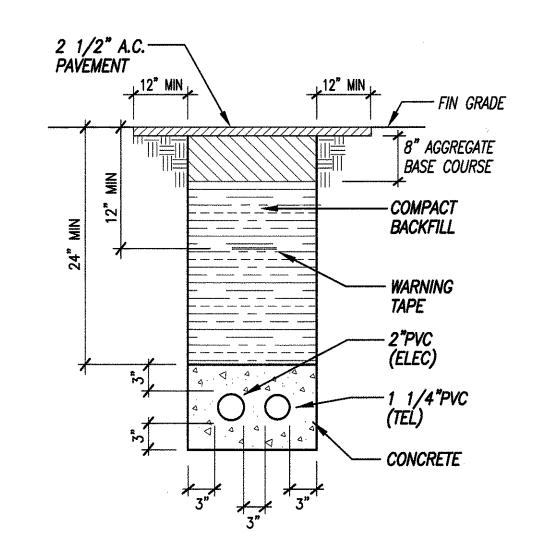




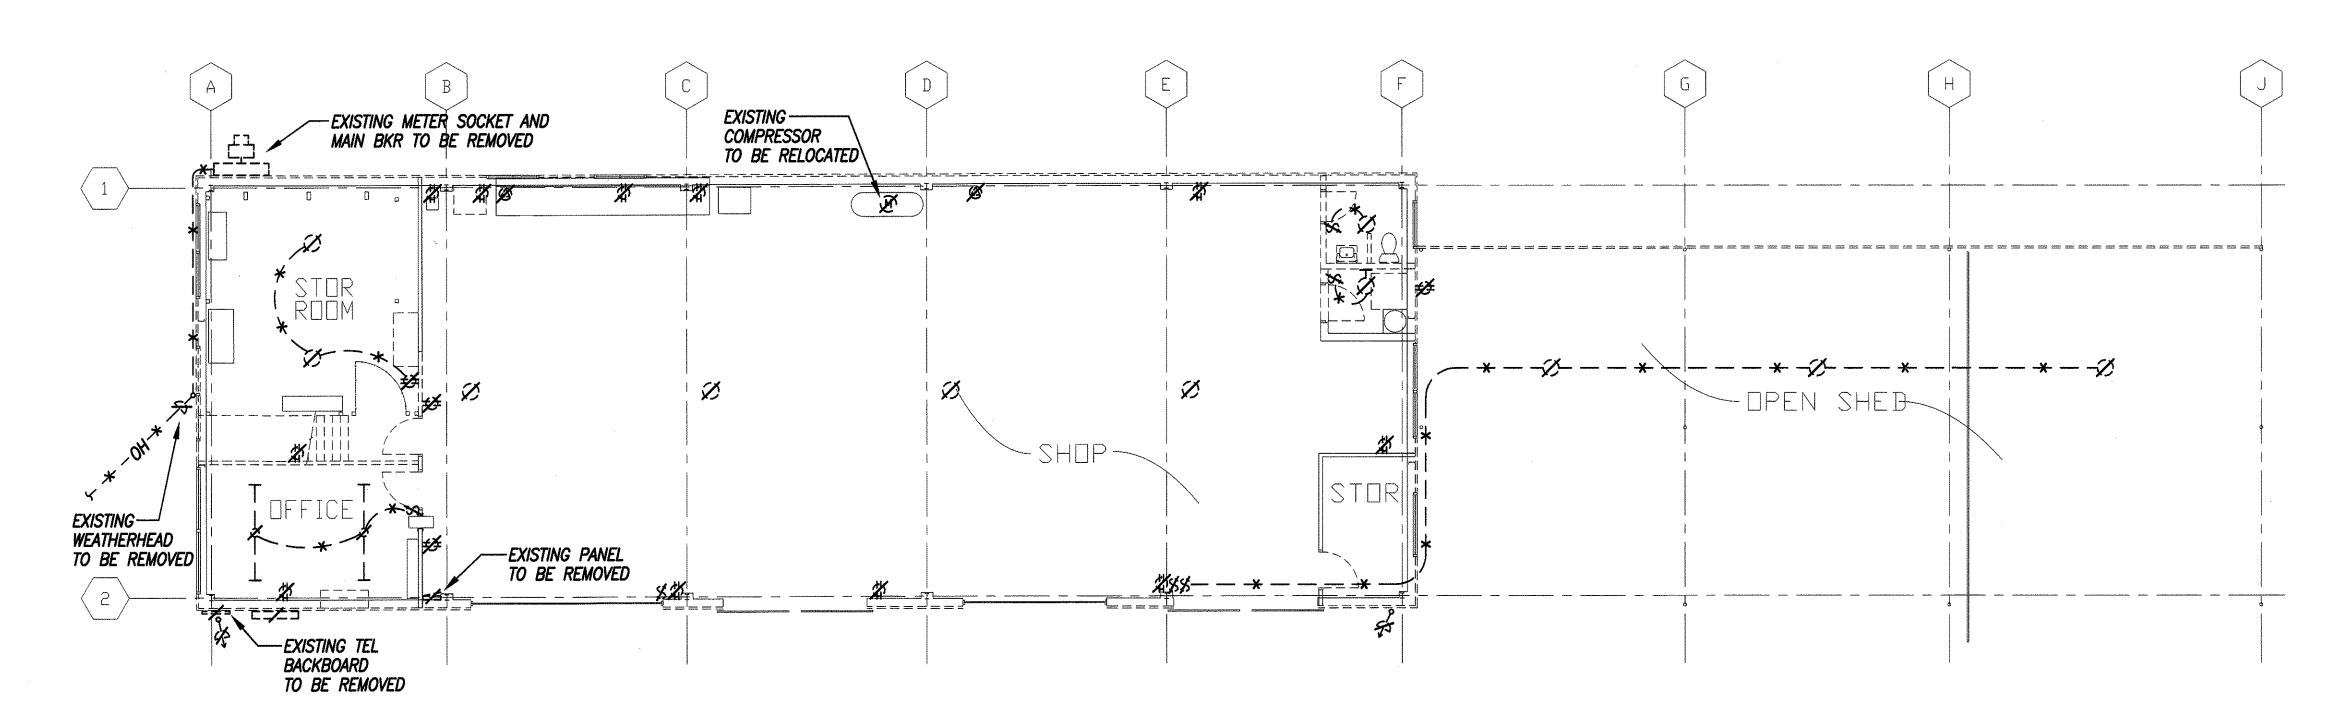

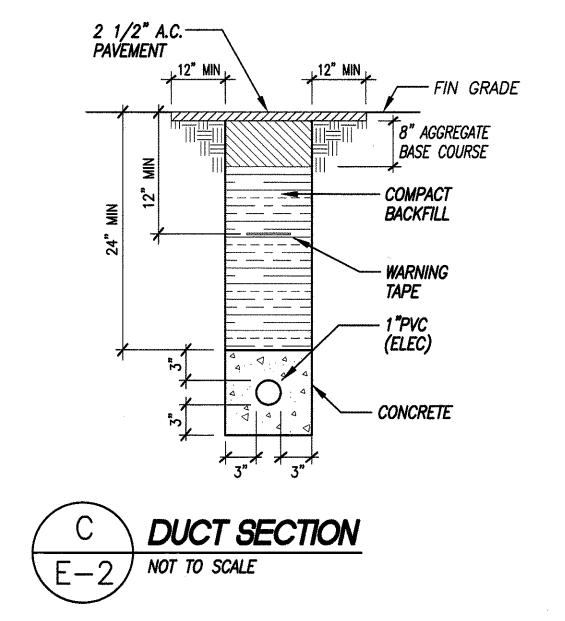



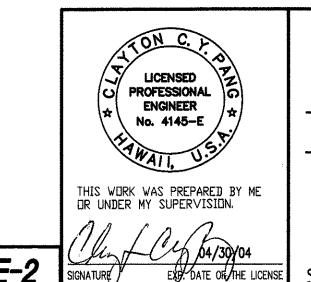

STATE OF HAWAII
DEPARTMENT OF TRANSPORTATION HIGHWAYS DIVISION


ELECTRICAL DEMOLITION PLAN & NOTES, DUCT SECTIONS, EQUIPMENT ELEVATION


> WAIMEA BASEYARD Project No. HWY-H-0-05-00M


Scale: As Noted


Date: February 2003

SHEET No. 2 OF 4 SHEETS

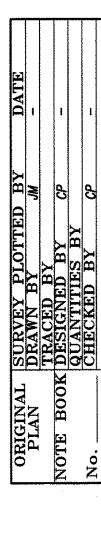

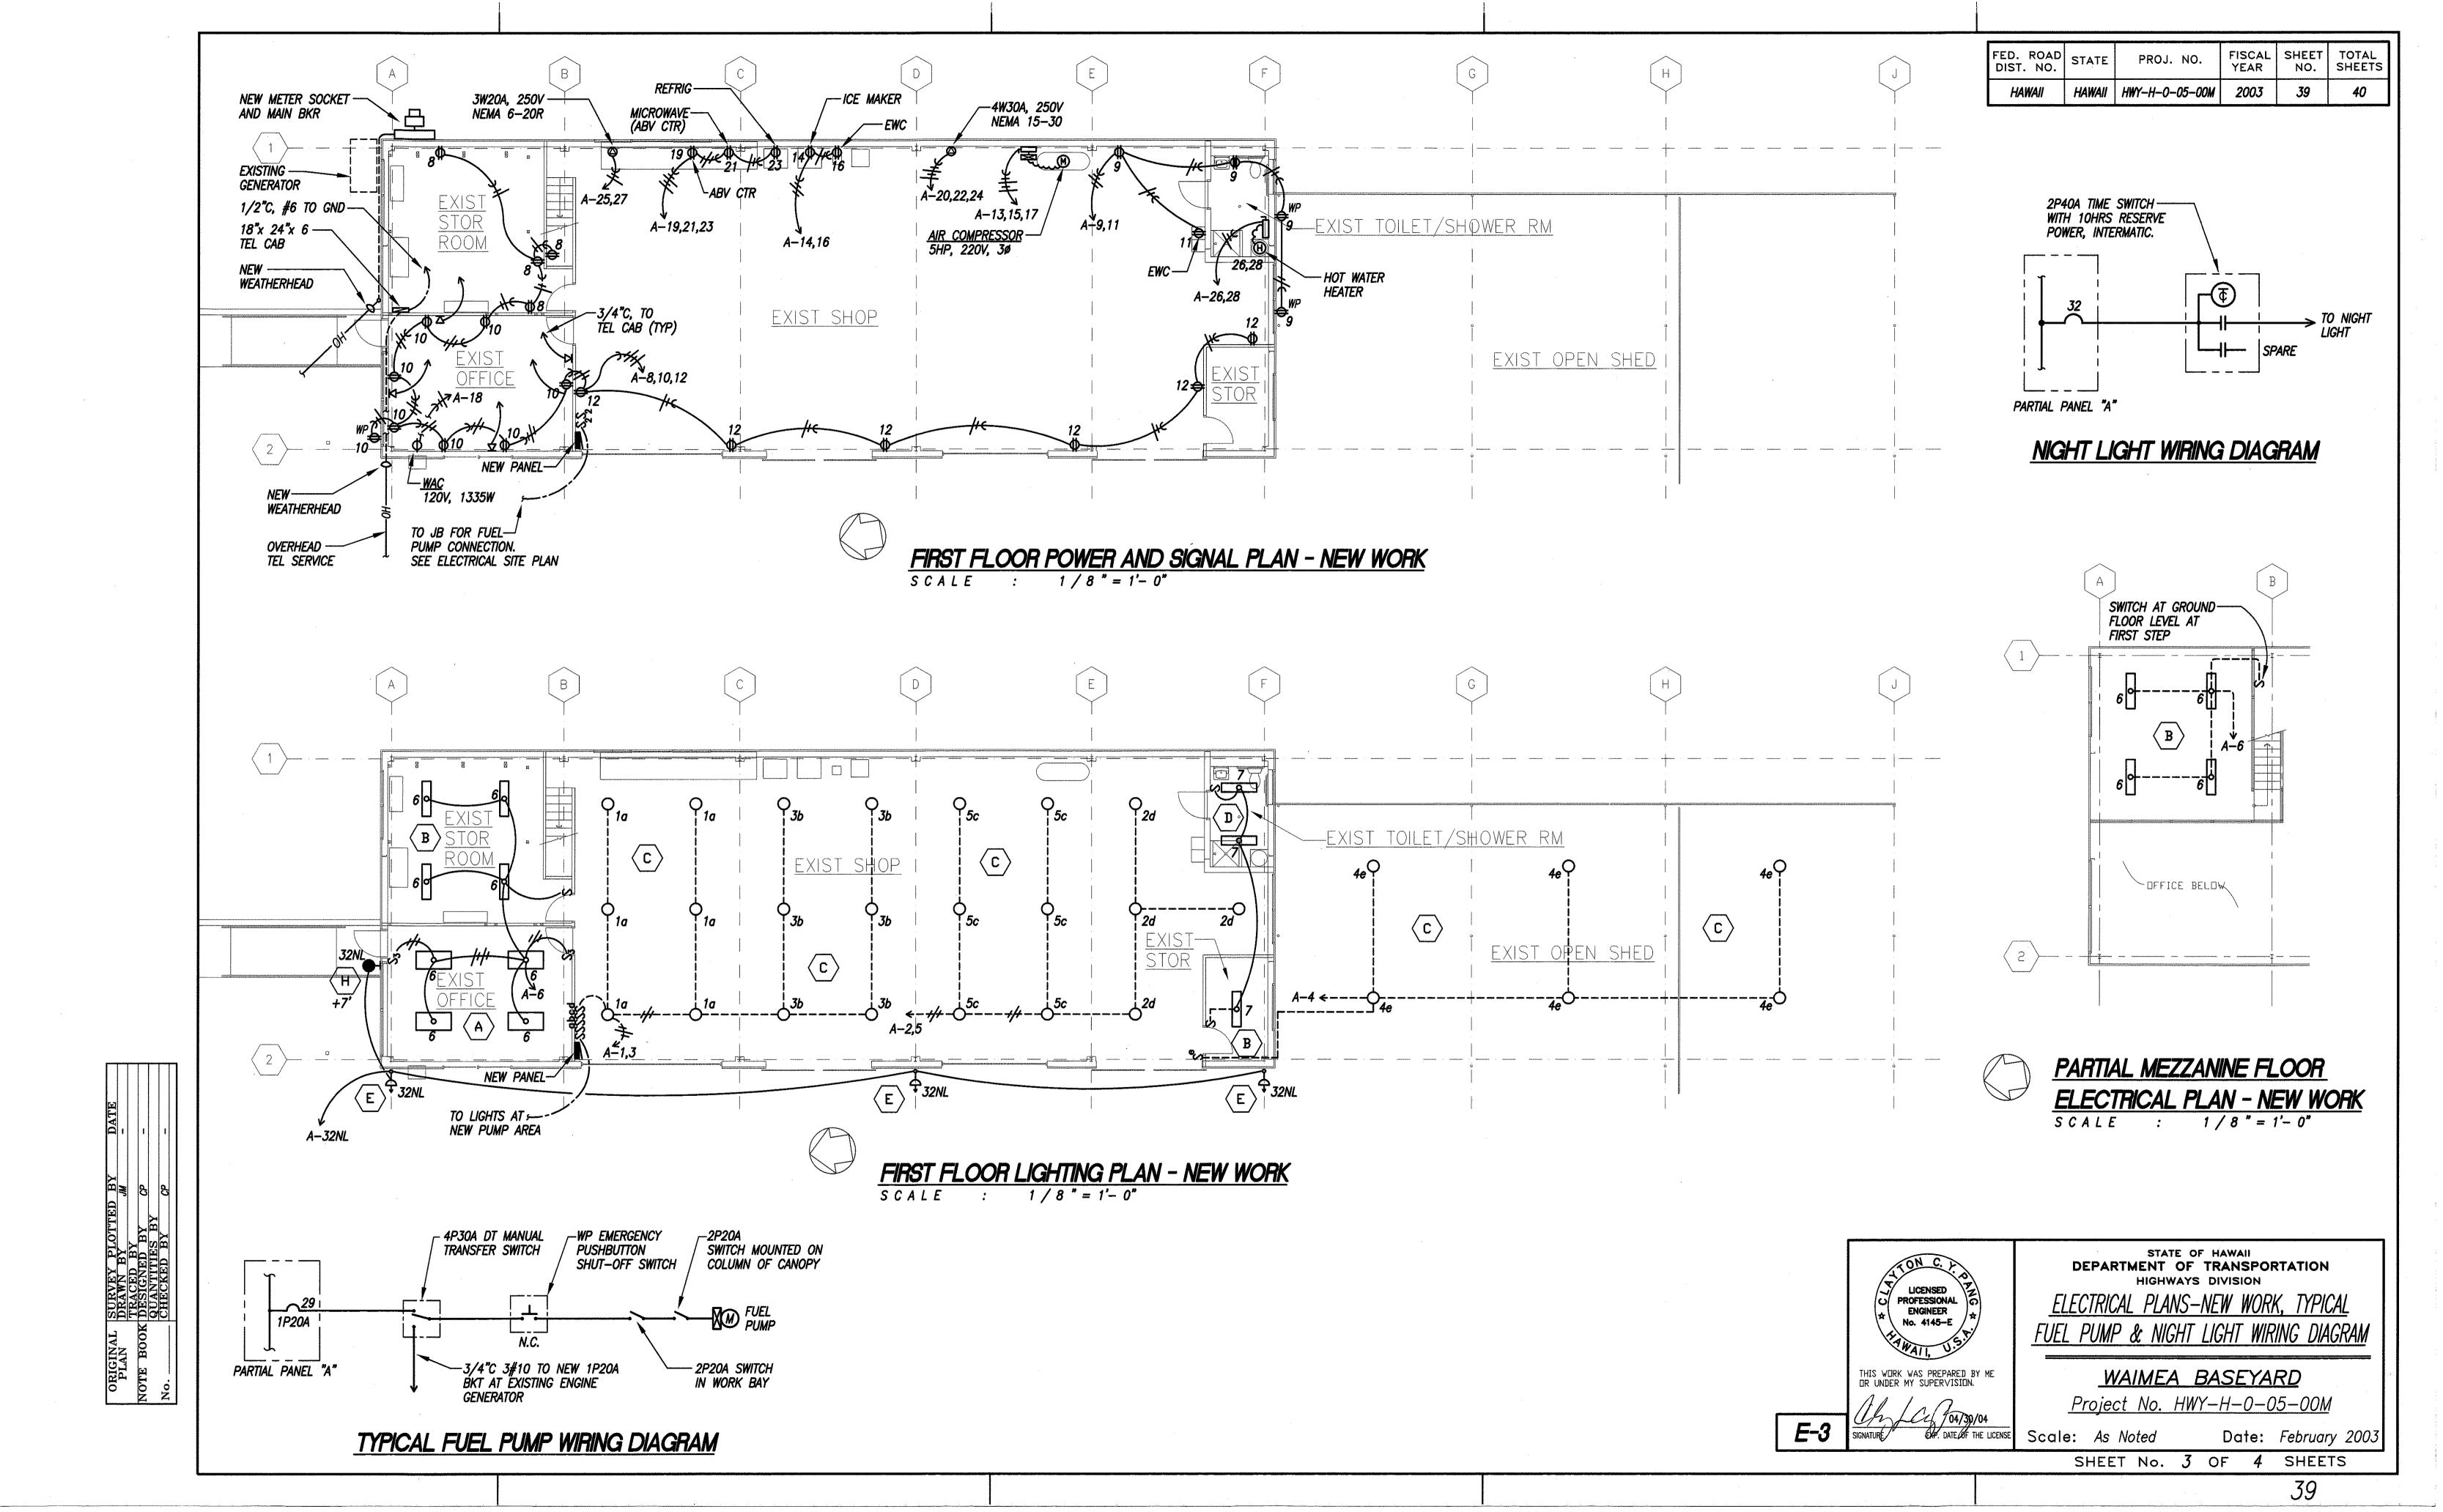

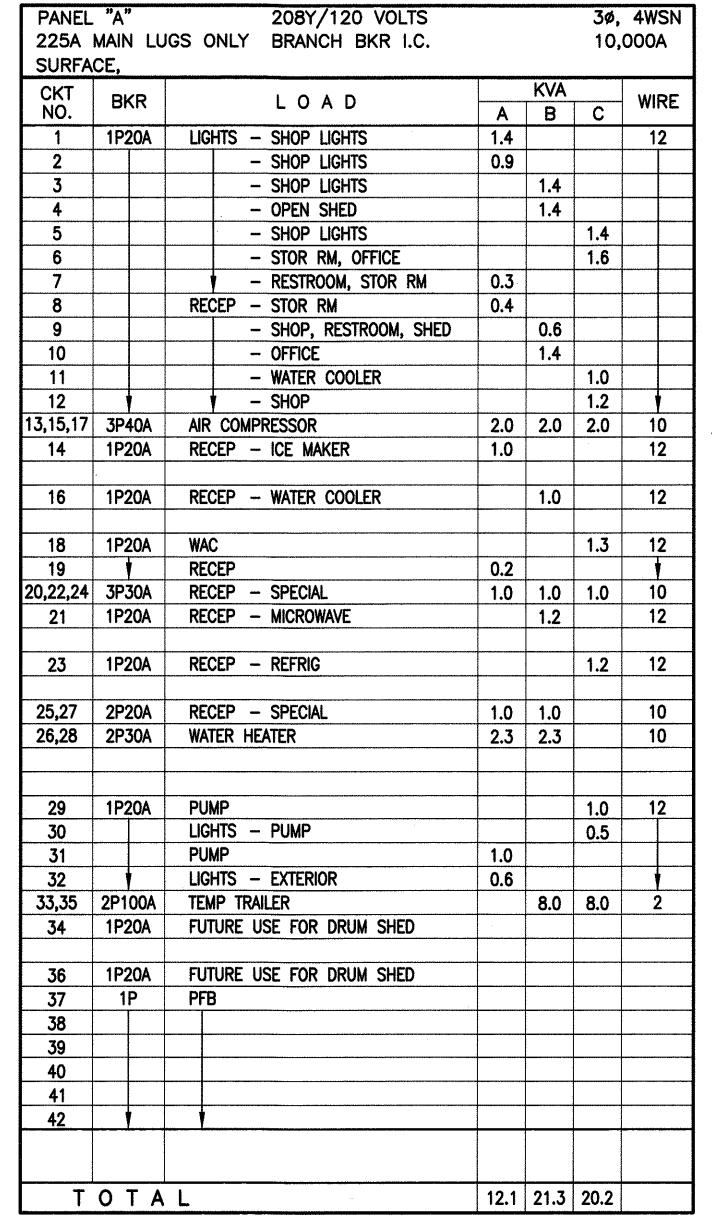

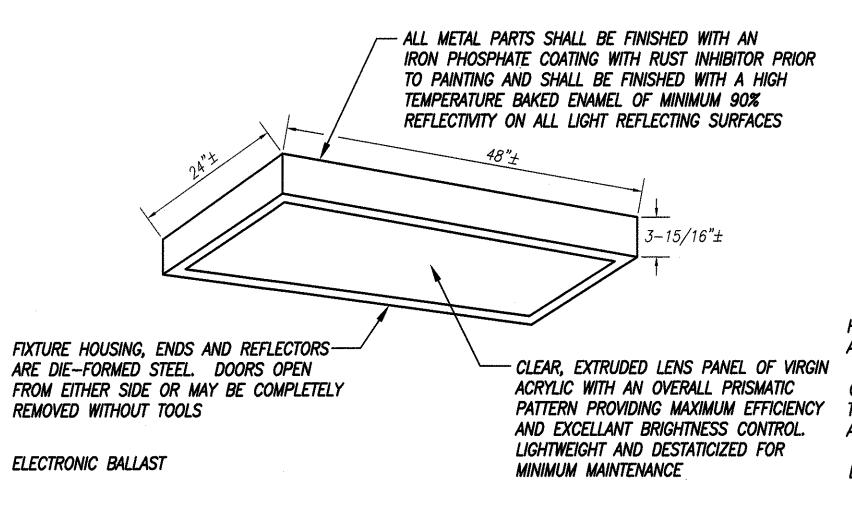

UU ±48" OR ±96 ±3-3/16" ¬ PROVIDE PLASTIC FLUORESCENT TUBE GUARD ON LAMPS GAUGE WIRE MESH GUARD HINGED TO CHASSIS

HIGH GLOSS BAKED WHITE ENAMEL FINISH ON 20 GAUGE COLD ROLL STEEL. PHOSPHETIZED AND FIVE STAGE PAINTING

CHASSIS TO BE FABRICATED AND PAINTED AFTER FABRICATION. ALL SURFACES AND EDGES TO BE PAINTED OR GALVANIZED. CHASSIS PREPAINTED PRIOR TO FABRICATION WILL NOT BE ALLOWED

BALLAST : ELECTRONIC TYPE, CLASS P, HPF, CBM/ETL CERTIFIED, .L. LISTED

±8-1/2"

±12" - LOW PROFILE, DIECAST COPPER-FREE ALUMINUM HOUSING -SPRING LATCHES ASSURE TIGHT SEAL HIGH PURITY, SPUN ALUMINUM REFLECTOR REFRACTOR: UV STABILIZED ACRYLIC REFRACTOR FOR SYMMETRICAL (TYPE V)

HAWAII HWY-H-O-05-00M

FISCAL SHEET TOTAL YEAR NO. SHEETS

40

2003

NO. SHEETS


RELIABLE. LONG-LIFE BALLAST, CLASS H INSULATED, -20°F STARTING (-40°F HPS). 60 Hz. HIGH POWER FACTOR BALLAST ISOLATED FROM THE OPTICAL CHAMBER FOR OPTIMUM PERFORMANCE AND LONG LIFE


FED. ROAD DIST. NO.

<u>LUMINAIRE TYPE B - 2-32W T8 FLUORESCENT LAMPS</u>

±22-1/4"

RECTANGULAR

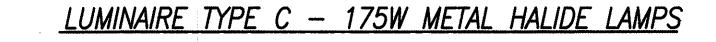

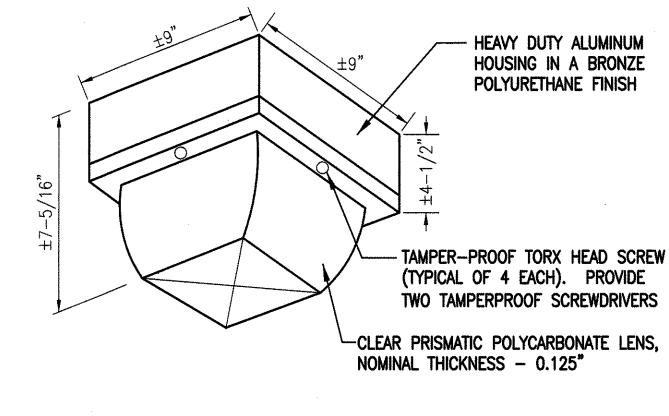

SHOCK ABSORBING, SPRING STEEL BRACKET

U.L. LISTED FOR DAMP/WET LOCATIONS

ALUMINUM REFLECTOR

BALLAST TO BE CBM/ETL, CLASS P, HIGH POWER FACTOR, SOUND RATING A. THREADED SEAL FITTINGS PROVIDED ON TOP AND BOTTOM, COVERED WITH PLASTIC CAPS.


LUMINAIRE TYPE A - 4-32W T8 FLUORESCENT LAMPS

HIGH IMPACT, 0.125" CLEAR ACRYLIC ENCLOSURE. ONE PIECE NEOPRENE GASKET. HIGH IMPACT PLASTIC BODY SUITABLE FOR WET LOCATIONS PER NEC. GASKET TO BE 0.125" CONTINUOUS COMPRESSIBLE NEOPRENE. INTERNAL METAL WIRING COMPARTMENT TREATED WITH 5-STAGE ZINC PHOSPHATE AND HOT-BONDED ENAMEL PAINT. REFLECTING SURFACES FINISHED WITH HIGH-REFLECTANCE WHITE ENAMEL. ELECTRONIC BALLAST.


FIXTURE SHALL BE SUITABLE FOR WET LOCATIONS.

NEMA HEAVY DUTY, RUGGED DIECAST ALUMINUM, TEMPERED GLASS LENS. U.L. LISTED FOR WET LOCATION. DARK BRONZE FINISH HOT DIPPED GALVANIZED STEEL YOKE TYPE MOUNTING

LUMINAIRE TYPE D - 2-32W T8 COOL WHITE FLUORESCENT LAMPS-52" LONG LUMINAIRE TYPE E - 180W LOW PRESSURE SODIUM LAMP LUMINAIRE TYPE F - 100W HIGH PRESSURE SODIUM LAMPS LUMINAIRE TYPE G - 4-32W T8 COOL WHITE FLUORESCENT LAMPS-100" LONG

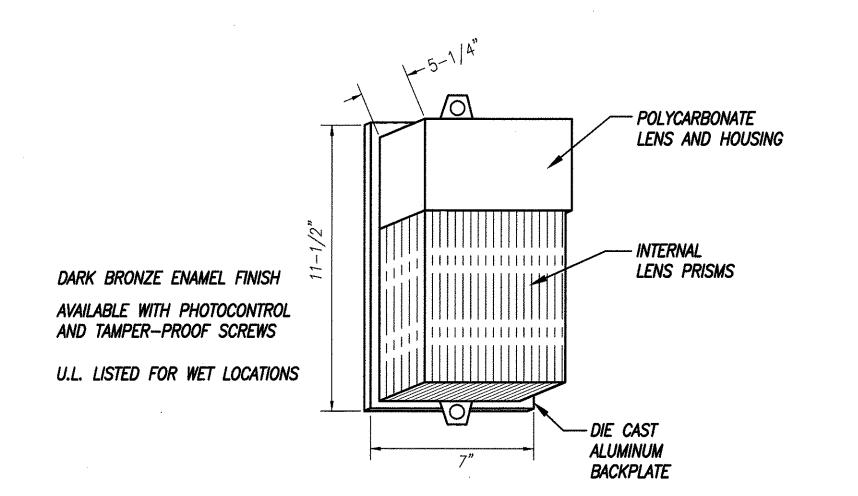

<u>LUMINAIRE TYPE H - 1-18W LOW PRESSURE SODIUM LAMP</u>

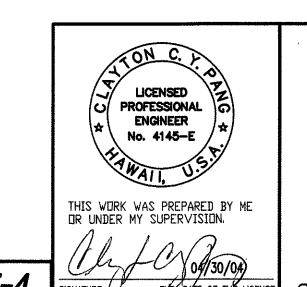

STATE OF HAWAII **DEPARTMENT OF TRANSPORTATION** HIGHWAYS DIVISION

LUMINAIRE DETAILS, PANEL SCHEDULE

WAIMEA BASEYARD Project No. HWY-H-0-05-00M

Scale: As Noted

Date: February 2003 SHEETS SHEET No. 4 OF

IAL SURVEY PLOTTED

DRAWN BY
TRACED BY
OOK DESIGNED BY
QUANTITIES BY
CHECKED BY